





# MOKA DRIVE-UP COFFEE SHOP

LA CROSSE, WISCONSIN

# **ISG PROJECT # 16-19260**

**SHEET INDEX** 



SHEET#



# **PROJECT GENERAL NOTES** ALL WORK SHALL CONFORM TO THE CONTRACT DOCUMENTS, WHICH INCLUDE, BUT ARE NOT LIMITED TO, THE OWNER - CONTRACTOR AGREEMENT, THE PROJECT MANUAL, (WHICH INCLUDES GENERAL AND SUPPLEMENTARY CONDITIONS AND SPECIFICATIONS), DRAWINGS OF ALL DISCIPLINES AND ALL ADDENDA, MODIFICATIONS AND CLARIFICATIONS ISSUED BY THE ARCHITECT FEMGINEER. MODIFICATIONS AND CARRIFLATIONS ISSUED BY THE ARCHITECT / ENGINEER. CONTRACT DOCUMENTS SHALL BE ISSUED TO ALL SUBCONTRACTORS BY THE GENERAL CONTRACTOR IN COMPLETE SETS IN ORDER TO ACHIEVE THE FULL EXTENT AND COMPLETE COORDINATION OF ALL WORK. CONTRACTOR IS RESPONSIBLE FOR COORDINATING AND CORRELATING QUANTITIES AND DIMENSIONS.

WRITTEN DIMENSIONS TAKE PRECEDENCE OVER SCALED DIMENSIONS. NOTIFY ARCHITECT/ENGINEER OF ANY DISCREPANCIES OR CONDITIONS REQUIRING INFORMATION OR CLARIFICATION BEFORE PROCEEDING WITH THE WORK.

FIELD VERIFY ALL EXISTING CONDITIONS AND DIMENSIONS, NOTIFY ARCHITECT ENGINEER OF ANY DISCREPANCIES OR CONDITIONS REQUIRING INFORMATION OF CLARIFICATION BEFORE PROCEEDING WITH THE WORK.

DETAILS SHOWN ARE INTENDED TO BE INDICATIVE OF THE PROFILES AND TYPE OF DETAILING REQUIRED THROUGHOUT THE WORK, DETAILS NOT SHOWN ARE SIMILAR IN CHARACTER TO DETAILS SHOWN, WHERE SPECIFIC DIMENSIONS, DETAILS OR DESIGN INTENT CANNOT BE DETERMINED, NOTIFY ARCHITECT / ENGINEER BEFORE PROCEEDING WITH THE WORK.

PROCEEDING WITH THE WORK.

ALL MANUFACTURED ARTICLES, MATERIALS AND EQUIPMENT SHALL BE APPLIED, INSTALLED, CONNECTED, ERECTED, CLEANED AND CONDITIONED ACCORDING TO MANUFACTURERS INSTRUCTIONS. IN CASE OF DISCREPANCIES BETWEEN MANUFACTURERS INSTRUCTIONS AND THE CONTRACT DOCUMENTS, NOTIFY ARCHITECT, PERGINEER BEFORE PROCEEDING WITH THE WORK.

ARCHITECT / ENGINEER BEFORE PROCEEDING WITH THE WORK.

LARGE-SCALE, LESS SPECIFIC DETAILS TAKE PRECEDENCE OVER

SMALLER-SCALE, LESS SPECIFIC DETAILS AND INFORMATION. MORE STRINGENT

REQUIREMENTS FOR CODE. PRODUCTS AND INSTALLATION TAKE PRECEDENCE

OVER LESS STRINGENT REQUIREMENTS. NOTIFY ARCHITECT/ENGINEER OF ANY

DISCREPANCIES OR CONDITIONS REQUIRING INFORMATION OR CLARIFICATION

BEFORE PROCEEDING WITH THE WORK.

PROVIDE CONTINUOUS SELANT AROUND ALL MATERIALS AT EXTERIOR WALL PENETRATIONS. REFER TO SPECIFICATIONS FOR APPROPRIATE SEALANT. ALL DISSIMILAR METALS SHALL BE EFFECTIVELY ISOLATED FROM EACH OTHER TO AVOID GALVANIC CORROSION. SEAL ALL OPENINGS IN WALLS, FLOORS, CEILINGS, AND ROOFS, AROUND DUCTS,

PIPES, VENTS, TRAPS, CONDUIT AND ALL OTHER PENETRATIONS WITH FIRESTOPPING AS SPECIFIED AND REQUIRED BY CODES.

PROVIDE TEMPORARY WALLS, ENCLOSURES, DUST SHIELDS AND WALK-OFF MATS AS REQUIRED TO SEPARATE DEMOLITION AND CONSTRUCTION FROM EXISTING BUILDING. PROVIDE BRACING AND SHORING AS REQUIRED TO PROTECT EXISTING

. PROVIDE BRACING AND SHORING AS REQUIRED TO PROTECT EXISTING STRUCTURE TO REMAIN, PROVIDE SECURE, AND WEATHERPROOF ENCLOSURE OF TEMPORARY OPENINGS IN EXTERIOR WALLS, PROTECT ALL BUILDING COMPONENTS FROM DAMAGE DURING DEMOLITION AND CONSTRUCTION.

RESTORE ALL EXISTING AREAS AFFECTED BY DEMOLITION AND RELATED NEW CONSTRUCTION TO THEIR ORIGINAL CONDITION, INCLUDING BUT NOT LIMITED TO WALLS, FLOORS, AND CEILINGS AND THEIR ASSOCIATED FINISHES.

PROVIDE SOLID WALL BACKING WITH METAL OR FIRE-RETARDANT WOOD BLOCKING BEHIND DOOR HARDWARE SUCH AS WALL STOPS, BUMPERS, HOLD OPENS, ETC.

T1.11 TITLE SHEET, SHEET INDEX, PROJECT GENERAL NOTES EXISTING SITE & REMOVALS PLAN C1.11 EXISTING SITE & REMOVALS PLAN
C2.11 SITE & UTILITY PLAN
C3.11 GRADING PLAN
C4.11 EROSION CONTROL PLAN
C4.12 EROSION CONTROL NOTES & DETAILS
C5.11 CIVIL DETAILS
C5.12 CIVIL DETAILS CIVIL DETAILS

CIVIL SPECIFICATIONS

LANDSCAPE PLAN

LANDSCAPE NOTE & DETAILS ARCHITECTURAL
A1.21 FLOOR PLAN, ROOF PLAN & PARTITION TYPES
A1.22 DUMPSTER ENCLOSURE PLAN
A2.11 EXTERIOR ELEVATIONS
A3.11 BUILDING SECTIONS



THIS DOCUMENT IS THE PROPERTY OF I & S GROUP, INC AND MAY NOT BE USED, COPIED OR DUPLICATED WITHOUT PRIOR WRITTEN CONSENT.

PROJECT

# **MOKA DRIVE-UP COFFEE SHOP**

REVISION SCHEDULE PROJECT NO

RAWN BY DESIGNED BY REVIEWED BY CLIENT PROJECT NO

TITLE SHEET, SHEET INDEX. **PROJECT GENERAL NOTES** 

T1.11

# **PROJECT INDEX:**

OWNER:

JOAN WILSON 513 MAIN STREET, SUITE C LA CROSSE, WI 54601

**PROJECT ADDRESS:** 


330 ADAMS STREET LA CROSSE, WI 54601


MANAGING OFFICE:


LA CROSSE OFFICE 201 MAIN STREET **SUITE 1020** LA CROSSE, WI 54601 PHONE: 608,789,2034 PROJECT MANAGER: KEVIN BILLS

EMAIL: kevin.bills@is-grp.com


ISG

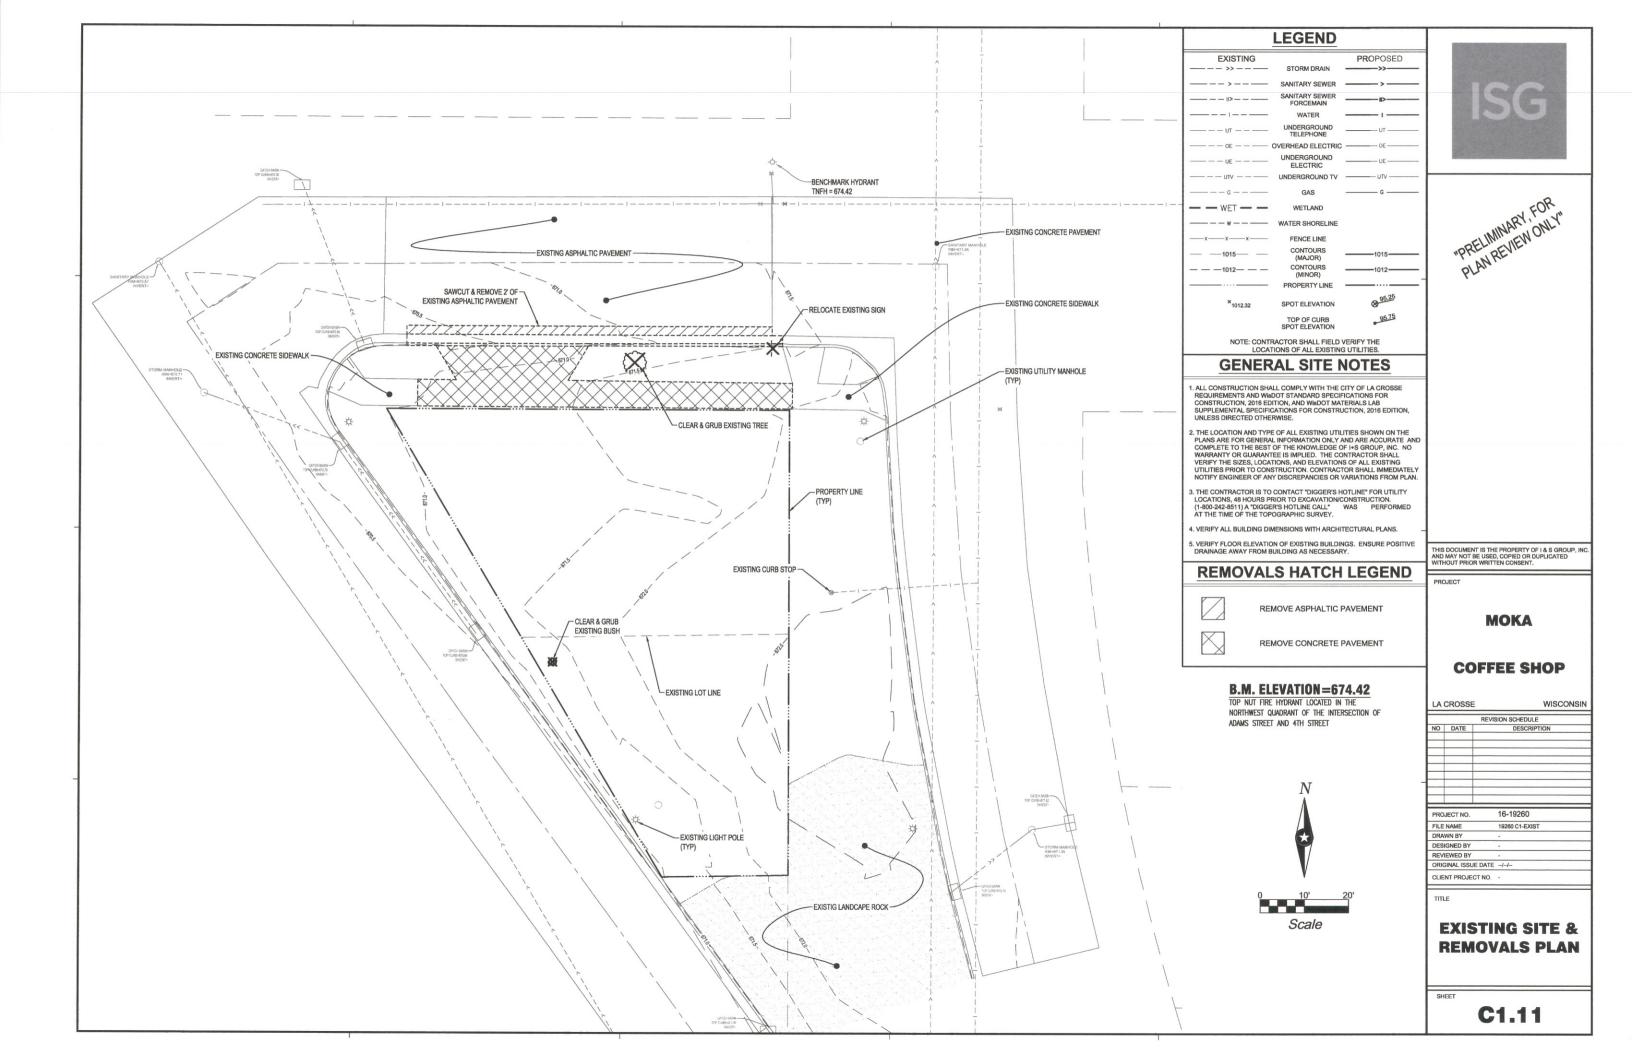


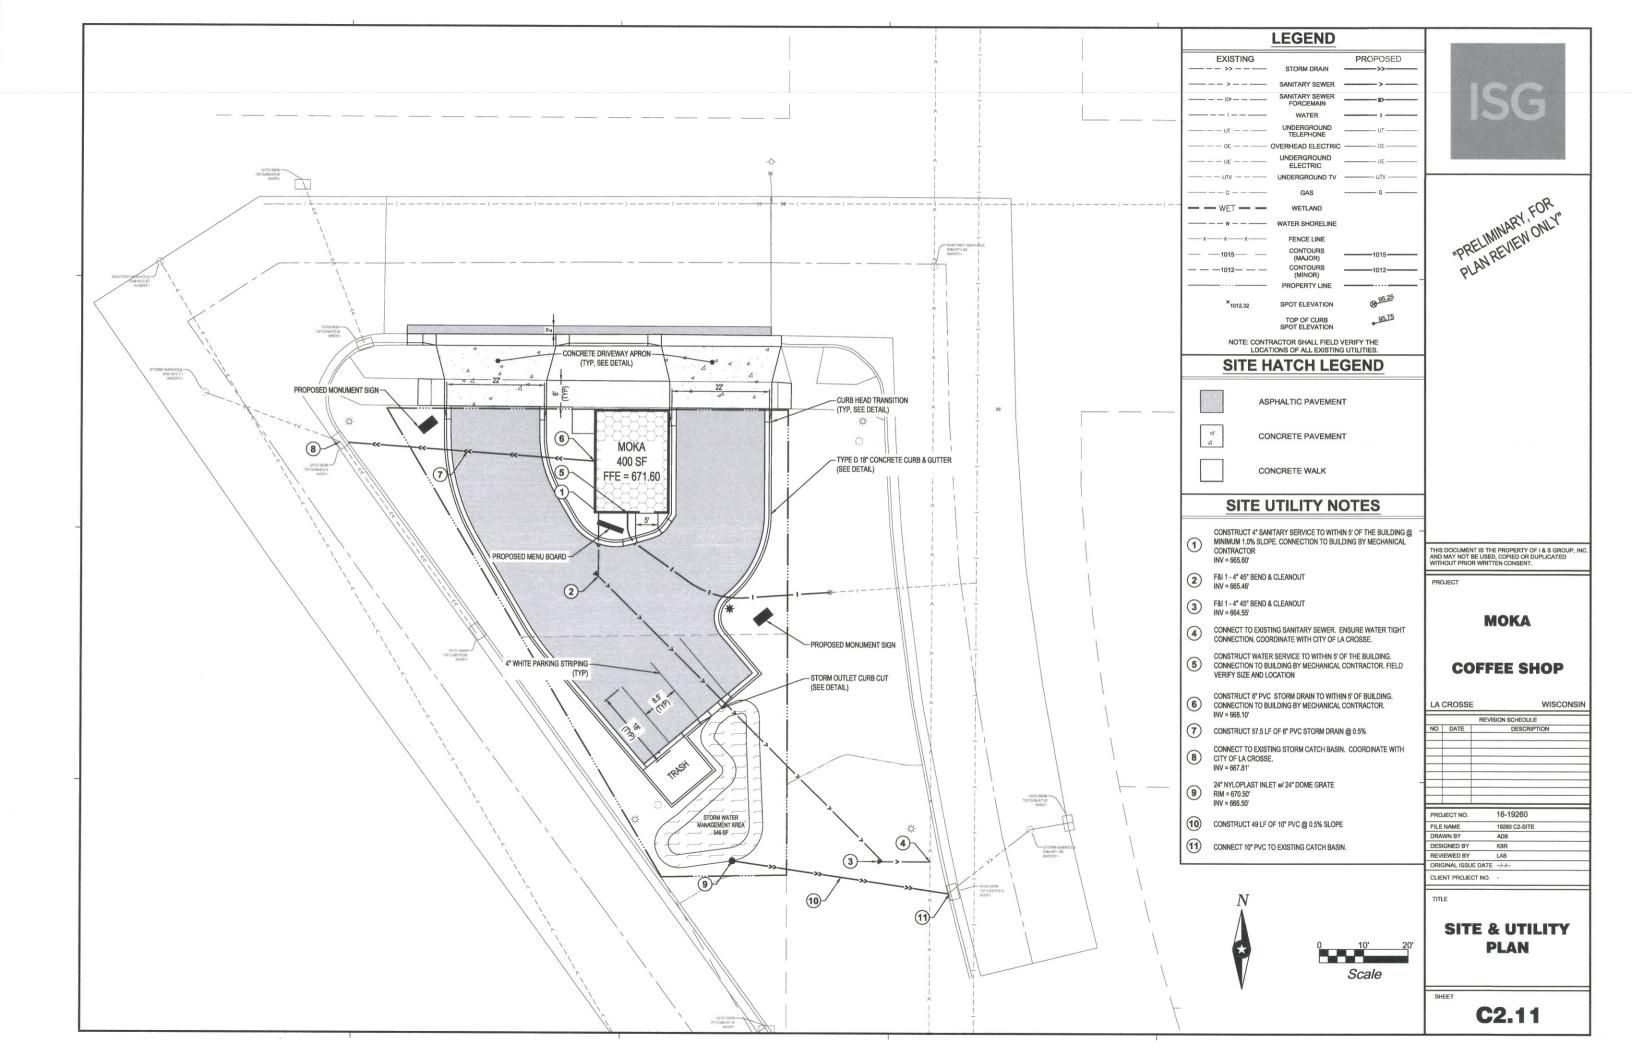

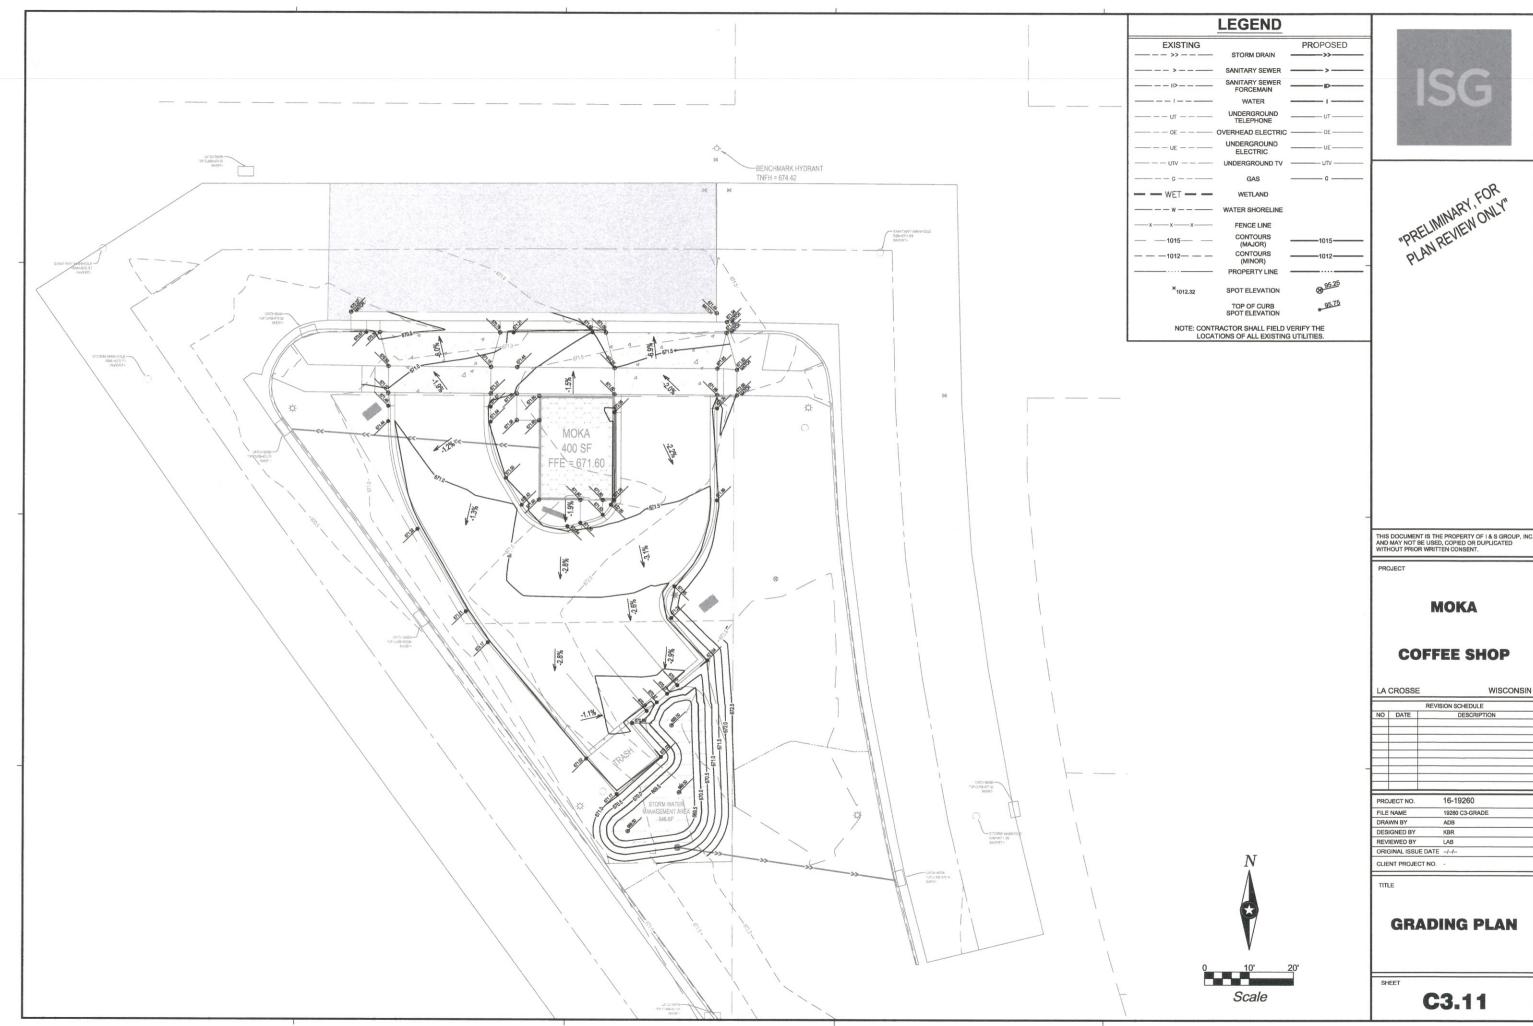

LA (	CROSSE	WISCONSIN
		REVISION SCHEDULE
NO	DATE	DESCRIPTION
$\dashv$	_	
-	-	
PRO.	JECT NO.	16-19260

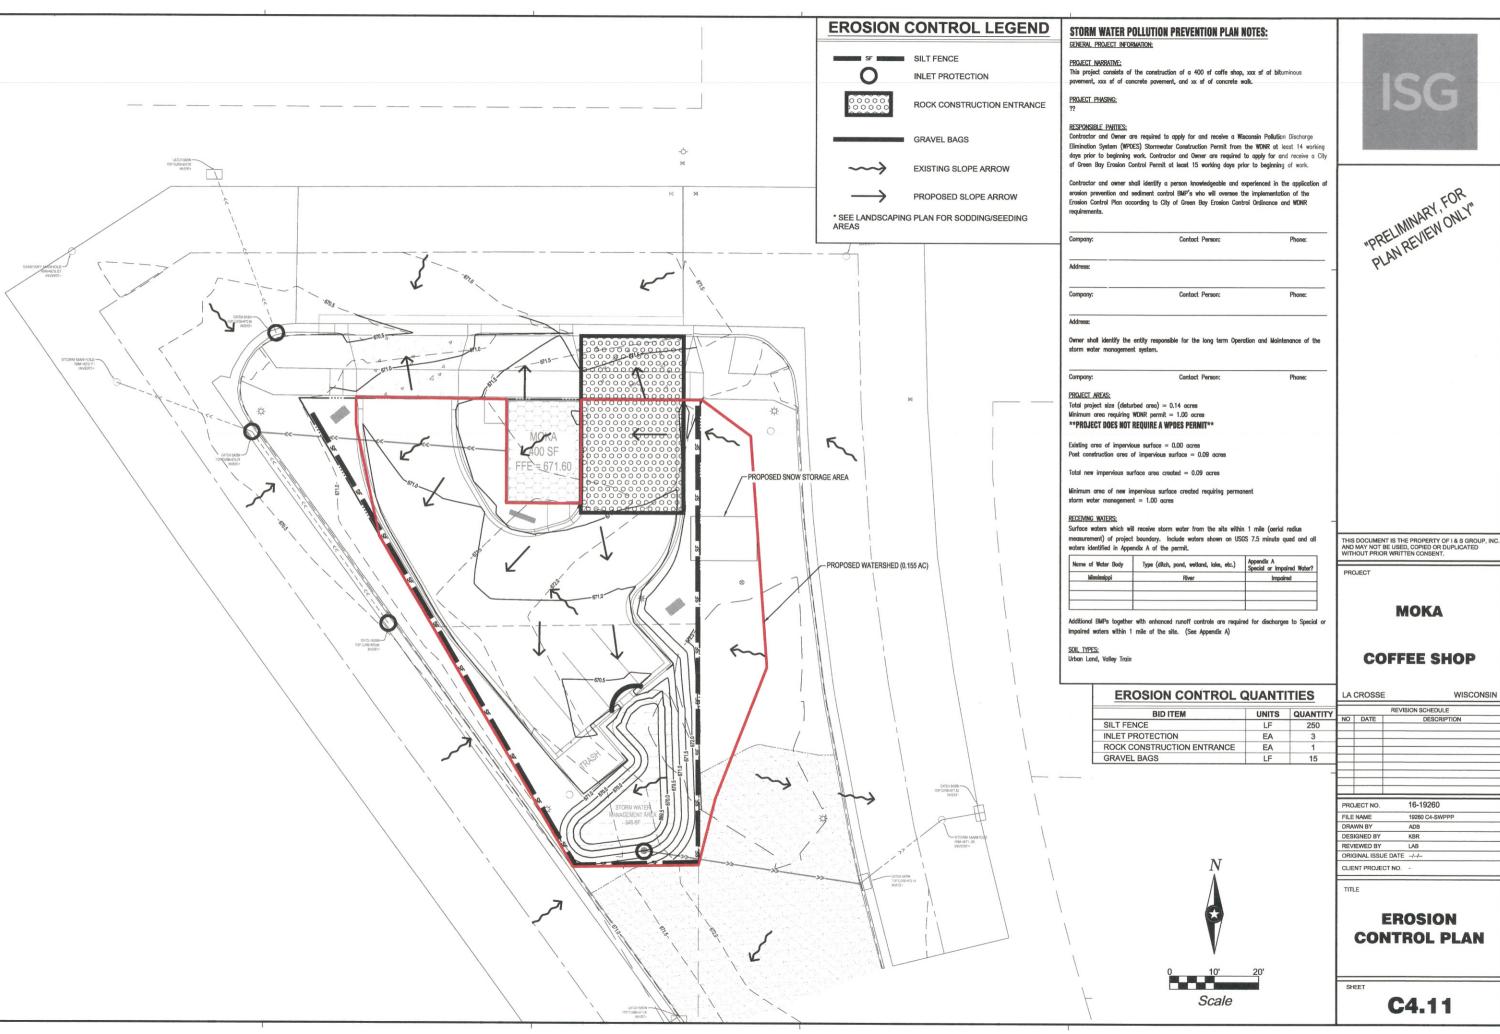

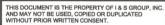

PROJECT

**MOKA** 

**COFFEE SHOP** 

LA CROSSE WISCONSIN

DESCRIPTION

PROJECT NO.	16-19260	
FILE NAME	19260 C4-SWPPP	
DRAWN BY	ADB	
DESIGNED BY	KBR	
REVIEWED BY	LAB	
ORIGINAL ISSUE DATE	-/-/-	
OLIFAIT DDO IFOT NO		

**EROSION CONTROL PLAN** 

C4.11

# **CONSTRUCTION ACTIVITY NOTES:**

### EROSION PREVENTION:

Construction of silt fence and all other erosion control measures shall be complete before other construction activity occurs. Use phased construction wherever practical and establish turf as soon

Turf establishment or temporary seeding or mulching of all exposed soil not being actively worked

Type of Slope	Time Area can Remain Open Without Being Actively Worked			
or Disturbance Area	Norm	al Water	Impaired	
Steeper than 3:1	14	days	7	days
10:1 to 3:1	14	days	7	days
Flatter 10:1	14	days	7	days
Ditches	1	day	1	day
Pipe Ends	1	day	1	day
Within 200 Feet of Surface Water	1	day	1	day

Temporary cover during construction is incidental.

Pipe outlets must be provided with temporary or permanent energy dissipation within 24 hours after connection to a surface water.

- All exposed soils shall be seeded or sodded at the earliest possible time to prevent/reduce erosion.
- A. Seeding shall be WisDOT seed mixture #40 in accordance with WisDOT Specification Section 630.
- B. Sodding shall be applied according to WisDOT Specification Section 631.
- C. Temporary mulching shall be applied at a rate of 2 tons/acre. Mulch shall be disc anchored

Additional erosion prevention measures may be found at the Wisconsin Department of Natural

### SEDIMENT CONTROL PRACTICES:

Construction of silt fence and all other erosion control measures shall be complete prior to land disturbing activities occur.

Inlet erosion protection shall be installed and maintained until turf or pavement has been established.

The contractor shall be responsible to control erosion from leaving the construction zone. All eroded material that leaves the construction zone shall be collected by the contractor and returned to the site at the contractor's expense.

Contractor shall maintain a 50-foot natural buffer or use redundant sediment controls near surface waters if a buffer is not feasible.

Contractor shall take the necessary steps to minimize soil compaction and preserve topsoil on site.

All streets must be swept within 24 hours when any tracking occurs.

Silt fence or other effective erosion control measures must be installed around the perimeter of any soil stockpiled, including temporary stockpiles, at this location or any other on the project site. Stockpiles cannot be placed in surface waters, including storm water conveyances such as curb and

Perimeter control shall be installed along the back of curb immediately following curb installation at all locations with positive drainage to parking lot and/or streets, and remaining until stabilization is achieved. This shall be accomplished through the use of sitt fence. (Biorolls, Rock logs, or other methods approved by the engineer prior to installation shall also be placed acceptable)

ROCK CONSTRUCTION ENTRANCE

# **CONSTRUCTION ACTIVITY NOTES:**

Dewater sediment-laden water to sedimentation basins if possible or use other RMP's to prevent erosion when discharging to surface waters. Use appropriate energy dissipation

Dewatering practices cannot cause nuisance conditions, erosion or in receiving channels or inundation of wetlands resulting in adverse impacts.

### POLLUTION PREVENTION:

All solid waste collected from the construction site must be disposed in accordance with all applicable regulations.

All hazardous materials (oil, gasoline, fuel, paint, etc) must be properly stored to prevent spills, leaks, or other discharge. Storage areas shall provide secondary containment and a hazardous materials spill kit. Equipment fueling and maintenance shall occur in a designated, contained area. Storage and disposal of hazardous waste must be in compliance with all applicable regulations. All runoff containing any hazardous material must be properly collected and disposed. No engine degreasing shall be allowed on site.

All sgnitary wastes must be collected from partiable units on site by a licensed sanitary waste management contractor. The units must be secured and shall be maintained on a regular basis as needed to prevent overfilling.

Fragmency Spill Plan - The Contractor is responsible for all construction personnel to be informed of the manufacturers' recommended spill cleanup methods, and the location of that information and cleanup supplies. The Contractor shall modify the SWPPP as required within seven calendar days of knowledge of the release to: provide a description of the release, the circumstances leading to the release, and the date of the release. Plans must identify measures to prevent the reoccurrence of such releases. If a spill occurs, the following steps

- 1. Observe the safety precautions associated with the spilled material. Stop the source of the spill, if you can do so safely. Call 911 if fire or public safety hazards are created.
- 2. Contain the spilled material. Dirt. sand. or any semi-impermeable material may be used to create a containment structure to prevent the material from flowing.
- 3. Report the spill to Wisconsin's Spill Hotline at (800) 943-0003.
- 4. Clean up the spilled material and dispose of the wastes properly.

The contractor is responsible for monitoring air pollution and ensuring it does not exceed levels set by local, state, or federal regulations. This includes dust created by work being performed on the site. Air pollution and dust control correction is considered incidental to the unit bid prices for which work is being performed. Additional dust control measures may

Concrete washout off site: All liquid and solid wastes generated by concrete washout must be contained and not have the opportunity to come in contact with the surface waters or ground water. This includes ditches, slopes to ditches, curb and gutter, storm sewer systems, and ponds. All excess water and concrete must leave the site within the concrete trucks. Liquid and solid wastes must be disposed of properly.

# INSPECTION AND MAINTENANCE:

The Permittees must routinely inspect the construction site once every seven (7) days during active construction and within 24 hours of a rainfall event greater than 0.5 inches in a 24

All inspections performed during construction must be recorded and records retained with the erosion plan in accordance with the Permit. Contractor is responsible for keeping a record of all rainfall data & erosion control maintenance until final establishment of turf.


Erosion control and other BMP's must be replaced, repaired, or supplemented when they reach 33% design load.

The Contractor must ensure final stabilization of the site. The Contractor must submit a Notice of Termination when the site has undergone final stabilization and all stormwater discharges associated with the construction site activities that require to have WPDES coverage have ceased

All temporary erosion control measures and BMP's must be removed as part of the final site


**GRAVEL BAG DETAIL** 

The storm water permit further defines final stabilization and its requirement

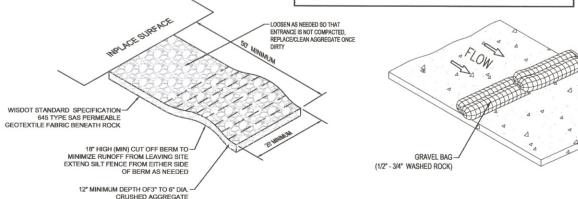

EC600

DEWATERING AND BASIN DRAINING

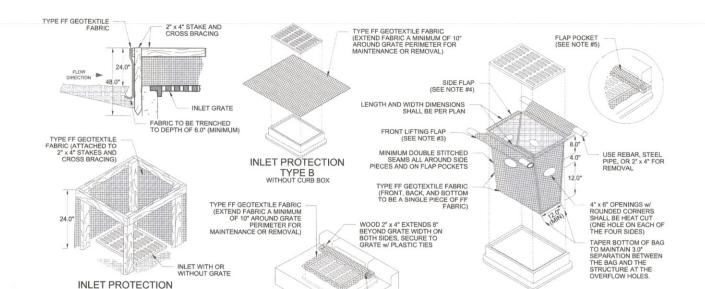

- 1. TAPER BOTTOM OF BAG TO MAINTAIN THREE INCHES OF CLEARANCE BETWEEN THE BAG AND THE STRUCTURE, MEASURED FROM THE BOTTOM OF THE OVERELOW OPENINGS TO THE STRUCTURE WALL
- 2 GEOTEYTII E EARRIC TYPE EE EOR EI ARS, TOR AND ROTTOM OF OUTSIDE OF FILTER BAG. FRONT, BACK, AND BOTTOM OF FILTER BAG. BEING ONE PIECE.
- 3. FRONT LIFTING FLAP IS TO BE USED WHEN REMOVING AND

GENERAL NOTES

TRENCH SHALL BE A MINIMUM OF 4" WIDE & 6" DEEP TO BURY AND ANCHOR THE GEOTEXTILE FABRIC, FOLD MATERIAL TO FIT TRENCH AND BACKFILL & COMPACT TRENCH WITH EXCAYATED

(2) WOOD POSTS SHALL BE A MINIMUM SIZE OF 11/4" X 11/4" OF DAK OR HICKORY

(3) CONSTRUCT SILT FENCE FROM A CONTINUOUS ROLL IF POSSBILE BY CUTTING LENGTHS TO AVOID JOHTS, IF A JOHT IS NECESSARY USE ONE OF THE FOLLOWING THO NETHODS AT INTST METHOD - OVERLAP THE EUP POSTS AND THIST, OR ROTATE, AT LEAST 180 DECREES, B) HOOK METHOD -- HOOK THE END OF EACH SILT FENCE LENGTH.

TYPE A

- 4. SIDE FLAPS SHALL BE A MAXIMUM OF TWO INCHES LONG. FOLD THE FABRIC OVER AND REINFORCE WITH MULTIPLE STITCHES
- 5 FLAP POCKETS SHALL BE LARGE ENOUGH TO ACCEPT WOOD 2" v 4" THE REBAR, STEEL PIPE, OR WOOD SHALL BE INSTALLED IN THE REAF FLAP AND SHALL NOT BLOCK THE TOP HALF OF THE CURB FACE

# MAINTENANCE NOTES:

INLET PROTECTION

TYPE C

WHEN REMOVING OR MAINTAINING INLET PROTECTION, CARE SHALL BE

FLAP POCKET

INLET PROTECTION

TYPF D

CAN BE INSTALLED IN INLETS WITH OR WITHOUT CURB BOXES

TWIST METHOD

HOOK METHOD JOINING TWO LENGTHS OF SILT FENCE ®

TAKEN SO THAT THE SEDIMENT TRAPPED IN THE FABRIC DOES NOT FALL INTO THE STRUCTURE. MATERIAL THAT HAS FALLEN INTO THE INLET SHALL BE IMMEDIATELY REMOVED.

TIEBACK BETWEEN FENCE

ANCHOR STAKE

SILT FENCE TIE BACK

TRENCH DETAIL

THIS DOCUM**ENT IS THE PROPERTY OF I & S GROUP, INC** AND MAY NOT BE USED, COPIED OR DUPLICATED WITHOUT PRIO**R WRITTEN CONSENT.** 

"PRELIMINARY, FOR PLAN REVIEW ONLY"

# PROJECT

# MOKA

# **COFFEE SHOP**

LA CROSSE WISCONSIN REVISION SCHEDULE DESCRIPTIO PROJECT NO. 16-19260 RAWN BY ESIGNED BY KBR REVIEWED BY LAB


TITLE

RIGINAL ISSUE DATE -/-/-


CLIENT PROJECT NO.


**EROSION CONTROL NOTES** 


C4.12

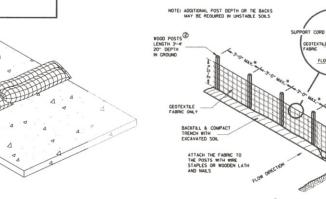


SILT FENCE

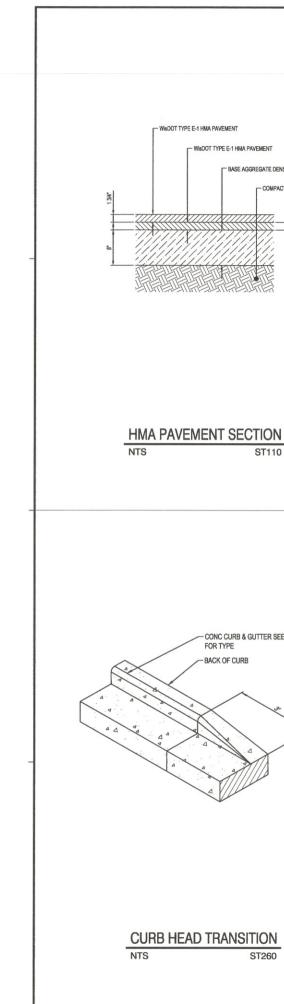

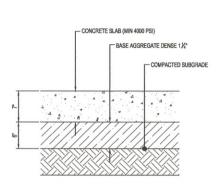

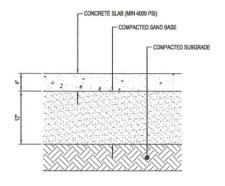

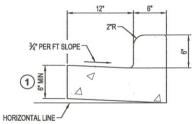

THE BOTTOM OF CURB AND GUTTER MAY BE CONSTRUCTED EITHER LEVEL OR PARALLEL TO THE SLOPE OF THE SUBGRADE OR BASE AGGRAGATE PROVIDED A 6\*

TYPE A 18" **CONCRETE CURB & GUTTER** 


CONCRETE PAVEMENT SECTION

**EDGE ANCHOR DETAIL** 


- CATEGORY 3 TURF REINFORCMENT MAT


CONCRETE WALK SECTION

GRANULAR BEDDING AND ENCASEMENT FOR WATERMAIN PIPES SHALL BE INCIDENTAL TO CONSTRUCTION

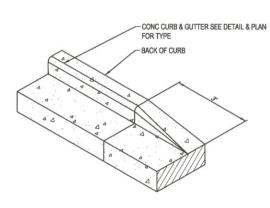

I BASE AGGREGATE DENSE 1½°

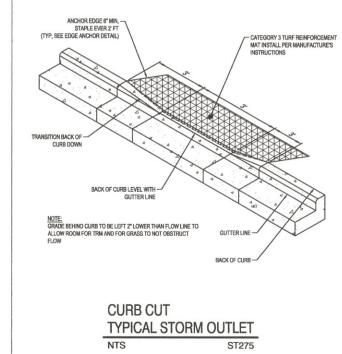

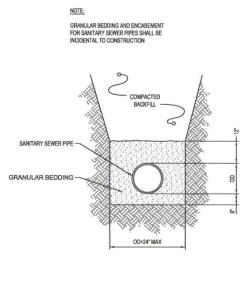

PIPE BEDDING

PIPE BEDDING FOR SANITARY SEWER FOR WATERMAIN NTS

THIS DOCUMENT IS THE PROPERTY OF I & S GROUP, INC AND MAY NOT BE USED, COPIED OR DUPLICATED WITHOUT PRIOR WRITTEN CONSENT.

PROJECT

**MOKA** 


**COFFEE SHOP** 


WISCONSIN LA CROSSE REVISION SCHEDULE 16-19260 PROJECT NO. DRAWN BY DESIGNED BY KBR REVIEWED BY LAB ORIGINAL ISSUE DATE -/-/-CLIENT PROJECT NO.

TITLE

**CIVIL DETAILS** 

C5.11

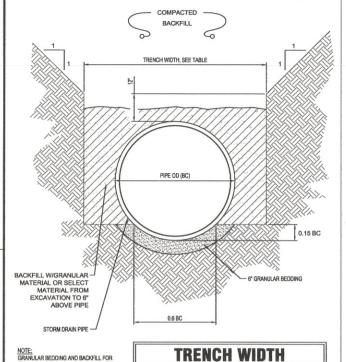

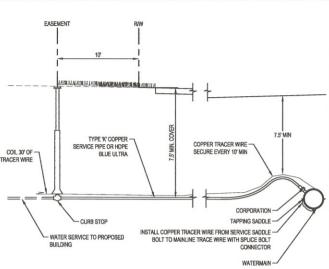


# TYPICAL WATER SERVICE WM500


### PIPE DIAM TRENCH WIDTH 36" OR LESS BC + 24" 42" TO 54" 1.5 x B C 60" OR OVER BC + 36\*

STORM DRAIN PIPES SHALL BE INCIDENTAL


# NON-CONCRETE STORM DRAIN PIPE BEDDING


NTS

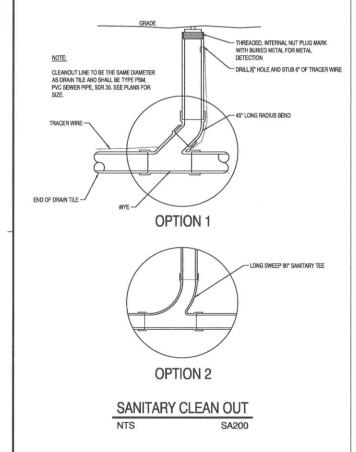

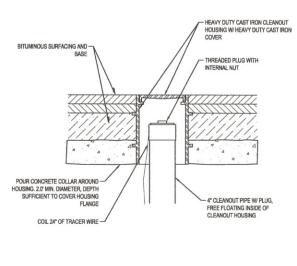

# **HEAVY DUTY** SANITARY CLEANOUT

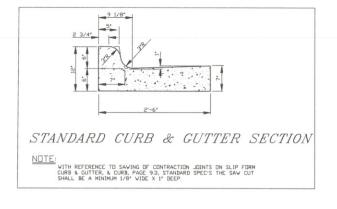

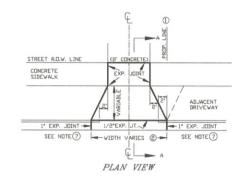



- DRIVE SECTION SHALL NOT OVERLAP PROPERTY LINE EXTENDED, EXCEPT WHERE PERMITTED BY THE ENGINEER, OR WHEN A JOINT DRIVEWAY AGREEMENT IS EXECUTED BY OWNERS OF ADJACENT PROPERTIES.

  MAX. DRIVEWAY WIDTH AT THE CURB AND SIDEWALK IS SET FORTH IN CITY ORDINANCE 5.03.

  THE BREAKOVER ANGLE (CAUSE OF CARS BOTTOMING) SECOMES CRITICAL WHEN THE ALGEBRAIC DIFFERENCE OF GRADES (GI, G2, & G3) EXCEEDS 11%.

- A REINFORCED DRIVE SECTION IS REQUIRED FOR CURB & GUTTER IN AREAS ZONED INDUSTRIAL OR COMMERCIAL.

  BACK OF CURB TO FRONT OF CONC. SIDEWALK MUST BE CONCRETE, BRICK OR ASPHALTIC BITUMINOUS.
- 6 MECHANICAL COMPACTION OF SUBSOIL IN LAYERS LESS THAN 12' TO ACHIEVE MINIMUM COMPACTION OF 95% OF MAXIMUM DENSITY FROM MODIFIED PROCTOR IS REQUIRED. (INCLUDING STREET SIDE AFTER FORMS ARE REMOVED)

  © EXPANSION JOINT IS REQUIRED AT BOTH ENDS OF DRIVEWAY WHEN ONLY DRIVEWAY IS INSTALLED OR REPLACED. WHEN ENTIRE BLOCK OF
- CURB & GUTTER IS INSTALLED THE EXPANSION JOINT AT DRIVEWAY ENDS MAY BE OMITTED.
- NOTE: TURNING OF 2' DIAMETER DRIVEWAY RETURNS IN LIEU OF DIMINISHING HEAD AS SHOWN IS PERMITTED IF DESIRED BY PROPERTY DWNER.

  INSTALLATION OF A DRIVEWAY BY REMOVING EXISTING CURB HEAD ONLY IS NOT ALLOWED. ENTIRE EXISTING C&G MUST BE REMOVED FOR NEW
  DRIVEWAYS. REMOVAL OF A MINIMUM 12' WIDTH OF BITUMINOUS TO INSTALL FRONT FORMS IS REQUIRED.

# STANDARD DRIVEWAY DETAIL

CITY OF LA CROSSE STANDARD DETAILS NTS



THIS DOCUMENT IS THE PROPERTY OF I & S GROUP, INC AND MAY NOT BE USED, COPIED OR DUPLICATED WITHOUT PRIOR WRITTEN CONSENT.

PROJECT

**MOKA** 

**COFFEE SHOP** 

LA CROSSE WISCONSIN REVISION SCHEDULE DESCRIPTION

PROJECT NO. 16-19260 RAWN BY DESIGNED BY KBR EVIEWED BY LAB RIGINAL ISSUE DATE -/-/-CLIENT PROJECT NO.

TITLE

**CIVIL DETAILS** 

C5.12

# SITE WORK SPECIFICATION

### 1 GENERAL:

- 1.1 SCOPE OF THE WORK Shall consist of the following:
  - A. Site Work, including excavation and grading, storm sewer, sanitary sewer services, water 2.6 services, base aggregate dense, HMA pavement, concrete driveways, curb and gutter, sidewalks, landscaping, and other incidental items.
- 1.2 SPECIFICATIONS WHICH APPLY Includes, but is not limited to the following:
  - A. State Building Code.
  - B. General Conditions, General Requirements, WisDOT "Standard Specifications", 2016 edition, City of La Crosse Standard Specifications, current edition, Wisconsin Plumbing Code, and these specifications.

# 2 SITE WORK:

- 2.1 GENERAL The scope of the work will include exeavation and grading of building pads, parking areas, and landscaped areas; construction of storm drains, sanitary sewer services and water services; installation of base aggregate dense, HMA pavement, private concrete driveways, concrete curb and gutter, concrete sidewalks, erosion control, landscaping, and other incidental items.
- 2.2 CLEARING AND GRUBBING All clearing and grubbing shall be considered incidental.
- 2.3 GRADING:

2.4

- A. Work Shall Include Stripping and removal of topsoil and unsuitable soils; installation of engineered fill; and regrading of site to indicated grades.
- B. The Contractor shall maintain drainage through the project area at all times. All materials, piping, pumping, equipment, and labor necessary to maintain drainage (dewatering) shall be considered incedental to the project, unless otherwise specified.
- C. Topsoil and unsuitable soils in the building area shall be excavated to the depths indicated in the Soils Report. The subgrade shall be examined by a soils engineer prior to placement of fill. The excavation shall be maintained free of water at all times.
- D. Topsoil in the areas under the proposed parking and display yard shall be excavated to a minimum depth of 1'-6". Areas found to have unsuitable soils within the upper 3' of subgrade shall be excavated to remove the unsuitable soils and the subgrade shall be prepared in accordance with WisDOT Sections 205 and 207 and as directed in the Soils Report.

  2.14
- The building area shall be filled to the bottom of the floor slab section using non-organic suitable onsite material. Fill shall be placed and compacted as directed in the Soils

  Report

  2.15
- F. Where required, the grade shall be raised to the bottom of the pavement section, using non-organic suitable orsite material. The orsite material shall be placed and compacted in 8" lifts. Compaction shall be by standard compaction methods, in accordance with WisDOT Section 207.3.6 and as indicated in the Soils Report.
- G. Salvaged material shall be used to fill grassed areas, as required, kaving room for 0°-6° minimum of topsoil in the landscaped areas. Unsuitable materials such as rocks, boulders, tree roots, etc. shall be removed from the backfill material and disposed of off site. All necessary fill material will be stockpiled orsite from watse material resulting from the subdivision road construction. The Contractor shall coordinate with the Owner and the road construction contractor regarding the location and schedule of fill material delivery.
- H. Topsoil shall be spread, to a minimum depth of 0'-6", over all areas to be sodded or landscaped and shall be graded to the contours shown on the plans, allowing room for any landscaping mulch. See Landscaping plan & specifications.
- I. All testing during fill placement shall be the responsibility of the contractor.

# SANITARY SEWER:

A. Work shall include construction of sanitary sewer services as specified in the City of La Crosse Standard Specifications: Construction of Sewers.

# WATER MAIN:

A. Work shall include installation of onsite fire hydrants and construction of water services as shown on the plans and as specified in the City of La Crosse Standard Specification: Water Main Construction.

### STORM DRAINS:

A. Work shall include construction of storm drain catch basins, manholes, and pipe as shown on plans and as specified in the City of La Crosse Standard Specification: Construction of Sewers.

### CONCRETE CURB & GUTTER:

A. Work shall include installation of curb foundation material and City of Lacrosse Standard Concrete Curb and Gutter as specified in the City of La Crosse Standard Specification: Concrete Curb & Gutter-Private & Alley Driveways & WisDOT type D 18" concrete curb & gutter.

### CONCRETE WALK:

A. Work shall include installation of sidewalk foundation material and Sidewalk as specified in the City of La Crosse Standard Specification: Sidewalks.

### CONCRETE DRIVEWAYS:

A. Work shall include placement of Base Aggregate and Concrete Paving as specified in the City of La Crosse Standard Specification: Concrete Curb & Gutter-Private & Alley Driveways.

### HMA Pavement

2.8

Working shall include preparation of subgrade, installation of base course, and
 Bituminous Concrete pavement as specified in the City of La Crosse Standard
 Specifications: Bituminous Concrete Pavine.

# SOIL CAPACITY:

A. Assumed soil bearing capacity – 4000 PSF,

EPOXY STRIPING, MARKINGS & SIGNAGE:

# A. Enoxy shall conform to WisDOT Section 646.

- B. The surface of the parking lot shall be clean and dry, and the air temperature shall be above 50 deg. F.
- C. H.C. Signs shall be installed where shown on plans and shall conform to the A.D.A.
- D. Traffic Control signs shall be installed where shown on plans and conform to the

# EROSION CONTROL:

A. See Storm Water Pollution Prevention Plans (SWPPP)

# LANDSCAPING:

A. See Landscape plans and details.



"PRELIMINARY, FOR PLAN REVIEW ONLY"

THIS DOCUMENT IS THE PROPERTY OF I & S GROUP, INC AND MAY NOT BE USED, COPIED OR DUPLICATED WITHOUT PRIOR WRITTEN CONSENT.

PROJECT

# **MOKA**

# **COFFEE SHOP**

LA CROSSE

WISCONSIN

	REVISION SCHEDULE						
NO	DATE	DESCRIPTION					
_							
_							


PROJECT NO.	16-19260	
FILE NAME	19260 C5-DETAILS	
DRAWN BY	ADB	
DESIGNED BY	KBR	
REVIEWED BY	LAB	
ORIGINAL ISSUE DATE	-1-1-	
OLUENT DESCRIPTION		

TITLE

# CIVIL SPECIFICATIONS

SHEET

C5.13

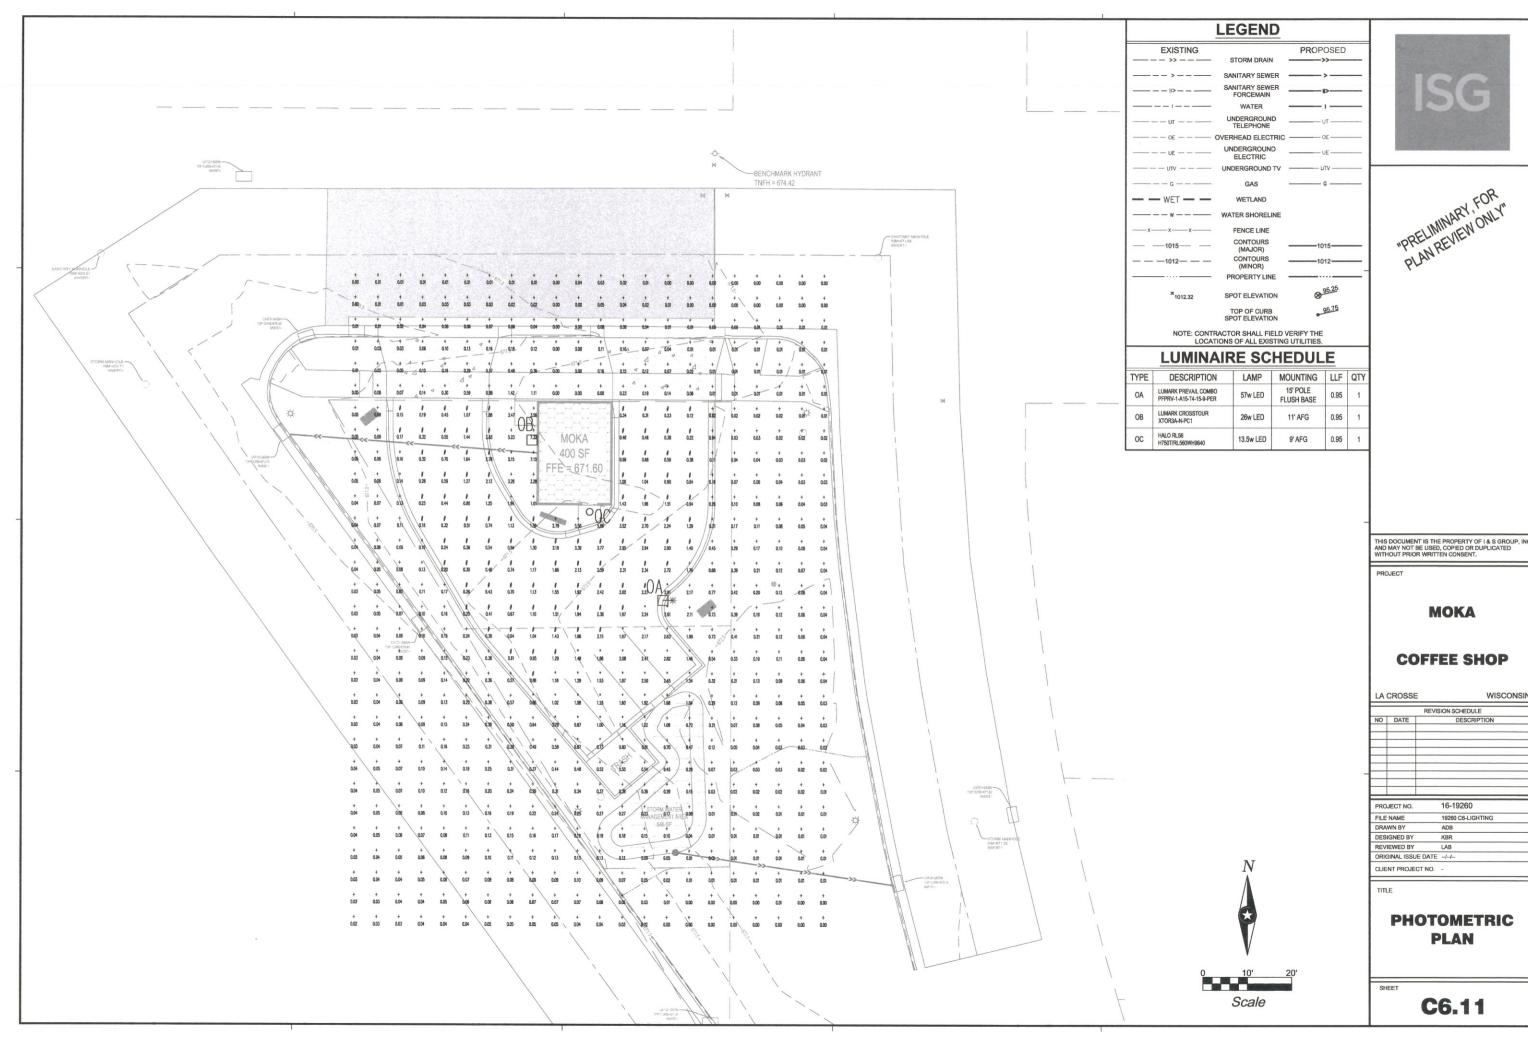





LA	CROSSE	WISCONSIN
		REVISION SCHEDULE
NO	DATE	DESCRIPTION
_	-	
_	-	
PRO	JECT NO.	16-19260
FILE	NAME	19260 C6-LIGHTING
DRA	WN BY	ADB

# **GENERAL PLANTING NOTES**

- COORDINATE LOCATION OF ALL LITHLITIES (LINES, DUCTS, CONDUITS, SLEEVES, FOOTINGS, ETC.) WITH LOCATIONS OF PROPOSED LANDSCAPE ELEMENTS (FENCE. FOOTINGS, TREE ROOTBALLS, ETC.). CONTRACTOR SHALL REPORT ANY DISCREPANCIES TO OWNER'S REPRESENTATIVE PRIOR TO CONTINUING
- 2. SAVE AND PROTECT ALL EXISTING TREES NOT NOTED TO BE REMOVED.
- REMOVE ALL CONSTRUCTION DEBRIS AND MATERIALS INJURIOUSTO PLANT GROWTH FROM PLANTING PITS AND BEDS PRIOR TO BACKFILLING WITH PLANTING MIX.
- 4 LAWN AREAS SHALL HAVE 6" MINIMUM DEPTH OF TOPSOIL TOPSOIL SHALL BE COMPACTED TO 85% MAXIMUM DENSITY AT OPTIMUM MOISTURE CONTENT
- 5. REFER TO PLANTING DETAILS PLAN FOR AMENDED SOIL DEPTH IN PLANTING BEDS AND SURROUNDING TREES. REFER TO SPECIFICATIONS FOR MIX TYPE
- 6. FIELD STAKE PLANTINGS ACCORDING TO PLAN. OWNER'S REPRESENTATIVE SHALL APPROVE ALL PLANT LOCATIONS PRIOR TO INSTALLATION, OWNER RESERVES THE RIGHT TO REVISE PLANTING LAYOUT AT TIME OF INSTALLATION.
- ALL PLANT MATERIALS SHALL BE TRUE TO THEIR SCIENTIFIC NAME AND SIZE AS INDICATED IN THE PLANT SCHEDULE.
- IF DISCREPANCIES EXIST BETWEEN THE NUMBER OF PLANTS DRAWN ON THE PLANTING PLAN AND THE NUMBER OF PLANTS IN THE SCHEDULE, THE PLANTING PLAN SHALL GOVERN.
- OWNER RESERVES THE RIGHT TO REVISE QUANTITIES TO SUIT BUDGET LIMITATIONS. CONTRACTOR'S UNIT BID PRICES SHALL PREVAIL FOR ANY CHANGES IN QUANTITIES.
- 10. ANY PROPOSED SUBSTITUTIONS OF PLANT SPECIES SHALL BE MADE WITH PLANTS OF EQUIVALENT OVERALL FORM, HEIGHT, BRANCHING HABIT, FLOWER, LEAF, COLOR, FRUIT AND CULTURE. AND ONLY AFTER WRITTEN APPROVAL OF THE OWNER'S REPRESENTATIVE AND OWNER.
- 11. ALL PLANT MATERIALS MUST CONFORM TO AMERICAN STANDARDS FOR NURSERY STOCK (A.N.S.I.), LATEST EDITION PUBLISHED BY THE AMERICAN ASSOCIATION OF NURSERYMEN, WASHINGTON D.C. LARGER SIZED PLANT MATERIALS OF THE SPECIES LISTED MAY BE USED IF THE STOCK CONFORMS TO A.N.S.I.
- 12. PROVIDE SHREDDED HARDWOOD MULCH, NATURAL COLOR, IN ALL PLANTING BEDS AND A MINIMUM 2' DIAMETER SURROUNDING ALL PROPOSED TREES TO A 3-INCH MINIMUM DEPTH. APPLY PRE-EMERGENT TO ALL PLANTING BEDS PRIOR TO MULCHING.
- 13. ALL PLANT MATERIAL SHALL BE GUARANTEED TO BE IN A LIVE AND HEALTHY GROWING CONDITION FOR ONE FULL GROWING SEASON (ONE YEAR) AFTER FINAL PROJECT ACCEPTANCE OR SHALL BE REPLACED FREE OF CHARGE WITH THE SAME GRADE AND SPECIES ALL TREES SHALL HAVE A STRONG CENTRAL LEADER.
- 14. PLANTING BED EDGING SHALL BE 1/8"x4" STEEL EDGING w/ 12" LANDSCAPE SPIKE IN ALL AREAS WHERE PLANTING BED MEETS LAWN AREAS.
- 15. ALL PLANTING BEDS SHALL HAVE SPADE DUG EDGES, EXCEPT WHERE NOTED OTHERWISE
- 16. CONTRACTOR IS RESPONSIBLE FOR ALL DAMAGE DUE TO OPERATIONS INSIDE AND OUTSIDE OF THE CONTRACT LIMIT LINE. ANY AREAS OUTSIDE THE LIMIT OF WORK THAT ARE DISTURBED SHALL BE RESTORED TO ITS ORIGINAL CONDITION AT NO ADDITIONAL COST TO THE OWNER.
- 17. ALL TURF AREAS DISTURBED BY CONSTRUCTION SHALL BE SODDED. SOD SECTIONS SHALL BE NO SMALLER THAN 24" X 36" STAKED IN PLACE WITH BIODEGRADABLE SOD STAKES WHEN SLOPE IS STEEPER THAN 5:1 OR WHEN CONDITIONS REQUIRE.
- 18. ALL PLANTING BEDS SHALL BE MULCHED WITH 3" DEPTH SHREDDED HARDWOOD MULCH. DO NOT USE ANY UNDERLAYMENTS SUCH AS LANDSCAPE FABRIC OR PLASTIC

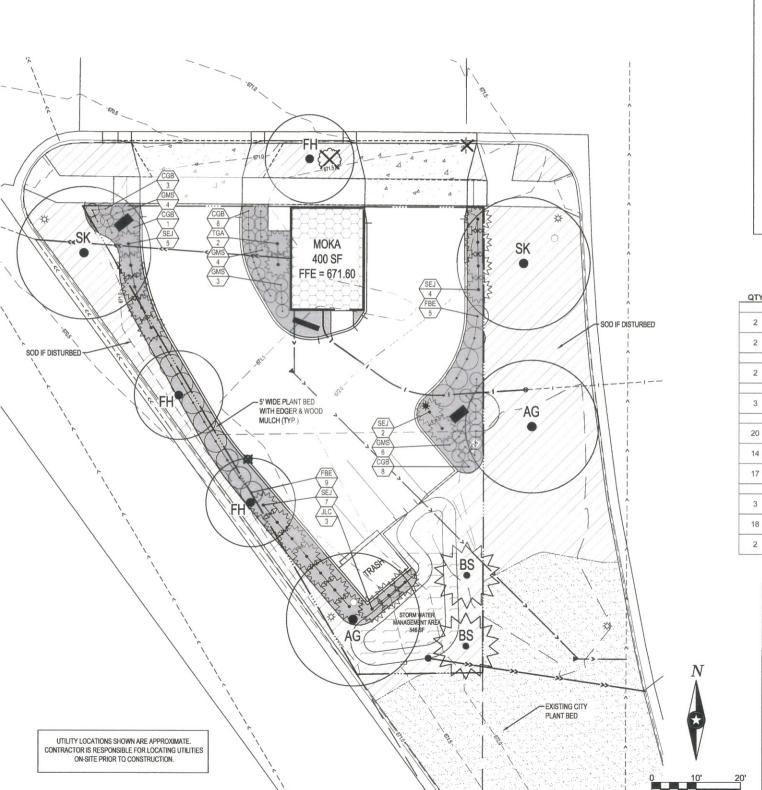

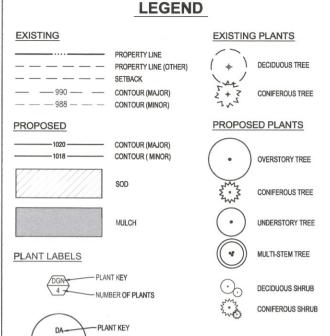

# **PLANT SCHEDULE**

QTY	KEY	COMMON NAME / Latin name	SIZE	ROOT	NOTE
		OVERSTORY TRI	EES		
2	AG	AUTUMN GOLD GINKO Gingko biloba 'Autumn Gold'	2" CAL.	B.B.	use only males
2	SK	SKYLINE HONEYLOCUST Gleditsia triacanthos inermis 'Skyline'	2" CAL.	B.B.	
		CONFEROUS TRI	EES	-	
2	BS	BLACK HILLS SPRUCE Picea glauca	6' HT.	B.B.	
		UNDERSTORY TR	EES		
3	FH	THORNLESS COCKSPUR HAWTHORN Crataegus crusgalli	2" CAL.	B.B.	
		DECIDUOUS SHR	UBS	-	
20	CGB	CHICAGOLAND GREEN BOXWOOD  Buxus 'Glencoe'	18" HT.	CONT.	5 gal. cont.
14	FBE	FIRE BALL EUONYMUS Euonymus alatus 'Select'	24" HT.	CONT.	5 gal. cont.
17	GMS	GOLDMOUND SPIREA Spiraea x bumalda 'goldmound'	16" HT.	CONT.	5 gal. cont.
		EVERGREEN SHR	UBS		
3	JLC	JAPANESE UPRIGHT YEW Taxus cuspidata 'Capitata'	24" HT.	CONT.	5 gal. cont.
18	SEJ	SEA GREEN JUNIPER Juniperus chinensis 'Sea Green'	18" HT.	CONT.	5 gal. cont.
2	TGA	TECHNY GLOBE ARBORVITAE Thuja occidentalis 'Techny Globe'	24" HT.	CONT.	5 gal. cont.

# **CITY LANDSCAPE REQUIREMENTS**

AS REQUIRED IN THE CITY OF LA CROSSE, WISCONSIN ZONING CODE.

Scale

- ONE TREE PLACED IN BOULEVARD PER 40 LF OF FRONTAGE
- 2 TREES & 8 SHRUBS PER 600 SF OF LANDSCAPE AREA 3' HT. HEDGE REQUIRED BETWEEN PARKING & STREET

SITE DATA: - 2170 SF OF LANDSCAPE AREA

7 TREES REQUIRED

(2170 / 600 x 2 = 7.24 OR 7 TREES) 29 SHRUBS REQUIRED

(2170 / 600 x 8 = 28.96 OR 29 SHRUBS)

TOTAL PLANTS SHOWN ON PLAN

9 TREES 74 SHRUBS



	NOT BE US			г
TUOHTIN	PRIOR WRI	TTEN CONS	SENT.	

PROJECT

**MOKA** 

**COFFEE SHOP** 

LA	CROSSE	WIS	CONSIN
		REVISION SCHEDULE	
NO	DATE	DESCRIPTION	
-	-		
	-		
	-		
		40 40000	
PRO	JECT NO.	16-19260	
FILE	NAME	IAME 19260 L1-LANDSCAPE	
DRA	WN BY	CWT	
DESIGNED BY		CWT	

TITLE

REVIEWED BY CWT

CLIENT PROJECT NO.

RIGINAL ISSUE DATE -/-/-

LANDSCAPE PLAN

L1.11

# TREE PLANTING NOTES

- 1 PRIOR TO DELIVERY TO THE SITE THE CONTRACTOR SHALL LOCATE THE BUTTRESS ROOTS OR TRUNK FLARE OF EACH TREE. IF FLARE IS LOCATED MORE THAN 2" DOWN FROM THE TOP OF THE ROOTBALL, THE TREE IS REJECTED AND
- 2. ONCE THE PROPERLY GROWN TREE IS DELIVERED TO THE SITE, MEASURE DISTANCE BETWEEN TOP OF THE BUTTRESS ROOTS AND THE BOTTOM OF THE ROOTBALL. SUBTRACT 2" TO DETERMINE DEPTH OF PLANTING PIT.
- 3. DIG PIT TO DEPTH DETERMINED ABOVE. PIT SHALL BE DISHED WITH SIDEWALLS AS SHOWN BELOW. SCARIFY WALLS AND BOTTOM OF PIT.
- 4. SET TREE IN PIT SO THAT THE FLARE IS ONE-TWO INCHES ABOVE SURROUNDING GRADE. IN ALL AREAS WITH HEAVY CLAY OR POORLY DRAINED SOILS (MOTTLING), CONTACT LANDSCAPE ARCHITECT. TREE MAY BE RELOCATED OR THE ROOTBALL FURTHER ELEVATED.
- 5. REMOVE ANY SOIL FROM TOP OF ROOTBALL TO EXPOSE TOP OF FLARE. THE LANDSCAPE ARCHITECT WILL NOT ACCEPT ANY TREE LINESS. THE FLARE IS VISIBLE.
- 6. BACKFILL PLANTING PIT TO WITHIN 12" OF GRADE AND THOROUGHLY WATER.
- 7. REMOVE BURLAP, WIRE, AND ALL ROPE FROM THE TOP 12" OF THE ROOTBALL
- 8. BACKFILL TO THE TOP OF THE ROOTBALL
- 9. DO NOT CREATE WATERING RING
- 10. CONTACT OWNER'S REPRESENTATIVE TO INSPECT PLANTING PRIOR TO PLACING ANY MULCH OVER

# **CONTAINER GROWN TREES**

- LOCATE BUTTRESS ROOTS (SEE NOTES ABOVE). REMOVE EXCESS SOIL FROM TOP OF ROOT BALL TO EXPOSE TRUNK FLARE. MEASURE DEPTH OF ROOTBALL TO DETERMINE DEPTH OF PLANTING PIT.
- TO ELIMINATE ENCIRCLING ROOTS, MAKE SEVERAL VERTICAL SLITS AROUND PERIMETER OF ROOT MASS. FROM TOP TO BOTTOM OF THE ROOTBALL. DEPTH OF SLITS INTO THE ROOTBALL SHALL BE AT LEAST 2".

# STAKING

GUY ASSEMBLY: 16" POLYPROPYLENE OR POLYETHYLENE (40 MIL) 1-1/2" WIDE STRIP- (TYP.) DOUBLE STRAND 14 GA WIRE & 3 STEEL STAKES OR SIGN POSTS @ 120 DEG. O.C. (SEE STAKING DIAGRAM).

CONTRACTOR SHALL STAKE TREES WITHIN THE GUARANTEE PERIOD.

COORDINATE STAKING TO INSURE UNIFORM ORIENTATION OF GUY LINES AND STAKES.




STAKING DIAGRAM

TREES WITH BE REJECTED FOR THE FOLLOWING REASONS:

-DAMAGED TRUNK -BURIED ROOT FLARES -ENCIRCLING TRANSPORT ROOTS -UNCONSOLIDATED ROOTBALL SOIL (DUE TO EXCESSIVE HANDLING)

# **TEMPORARY EROSION CONTROL** & STABILIZATION NOTE

TEMPORARY STABILIZATION MEASURES, INCLUDING EROSION CONTROL FENCE, INLET PROTECTION, ETC. MUST BE MAINTAINED UNTIL FINAL SEEDING AND STABILIZATION MEASURES ARE IN PLACE AND APPROVED BY THE OWNER'S REPRESENTATIVE. REFER TO CIVIL SHEETS FOR EROSION AND SEDIMENT CONTROL PLAN FOR ADDITIONAL INFORMATION.

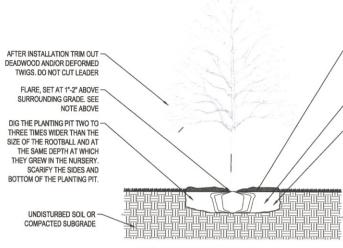

TREE PLANTING DETAIL

FROM TRUNK OF TREE, DO NOT PLACE MULCH UNTIL TREE HAS BEEN INSPECTED AND ACCEPTED BY THE OWNER'S REPRESENTATIVE. BACKFILL WITH 1/2 NATIVE SOILS AND

SHREDDED HARDWOOD MULCH - 3"


DEPTH X 3 FT DIAMETER. PULL AWAY

1/2 PLANTING SOIL. MIX THOROUGHLY PRIOR TO PLACEMENT.

- AFTER SETTING ROOT BALL IN PIT BACKFILL TO WITHIN 12" OF TOP OF ROOTBALL AND SATURATE WITH WATER.

- CUT AND REMOVE TO BACKFILL LINE ALL TWINE, WIRE AND/OR BURLAP.
- BACKFILL UNTIL PIT IS FULL, WATER

LANDSCAPE CONTRACTOR SHALL SCHEDULE AN INSPECTION BY THE OWNER'S REPRESENTATIVE 48 HOURS PRIOR TO PLACING MULCH AROUND THE TREE PLANTINGS.

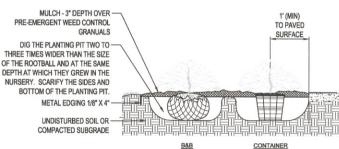

SHRUB PLANTING DETAIL NOT TO SCALE

- INSTALLATION NOTES:

  1. REMOVE CONTAINER (BY CUTTING IF NCCCESARY) IF ROOTS ARE GROWING IN A SPIRAL AROUND THE SOIL MASS, USE A SHARP KNIFE TO SCORE THE OUTSIDE OF SOIL MASS VERTICALLY, JUST DEEP ENOUGH TO CUT THE NET OF THE ROOTS, AND MAKE A CRISS-CROSS CUT ACROSS THE BOTTOM OF THE SOIL MASS.
- BACKFILL PLANTING BED WITH ORIGINAL SOIL. BREAK UP CLODS OF SOIL. IF SOILS ARE POOR (IE: HEAVY CLAYS, SAND, OR COMPACTED), BACKFILL CAN BE A MIXTURE OF 1/3 SOIL AMENDMENT WITH 2/3 ORIGINAL SOIL. DO NOT USE PEAT AS PART OF BACKFILL IN CLAY SOILS. REMOVE ALL ROCKS AND DEBRIS FROM
- THOROUGHLY WATER TO SETTLE THE PLANTS AND FILL VOIDS WITHIN TWO HOURS OF PLANTING. INSTALL MULCH WITHIN 48 HOURS OF WATERING.

-LAWN OR GROUNDCOVER -METAL LANDSCAPE EDGING 1/8" x 4" - WOOD OR ROCK MULCH UNDISTURBED SOIL OR COMPACTED SUBGRADE 12" STEEL STAKE

**EDGER DETAIL** NOT TO SCALE

THIS DOCUMENT IS THE PROPERTY OF I & S GROUP, INC AND MAY NOT BE USED, COPIED OR DUPLICATED WITHOUT PRIOR WRITTEN CONSENT.

PROJECT

**MOKA** 

**COFFEE SHOP** 

LA CROSSE WISCONSIN REVISION SCHEDULE DESCRIPTION


PROJECT NO. 16-19260 19260 L1-LANDSCAPE DRAWN BY DESIGNED BY CWT REVIEWED BY CWT RIGINAL ISSUE DATE -/-/ CLIENT PROJECT NO.

TITLE

LANDSCAPE **NOTES & DETAILS** 

SHEET


L1.12

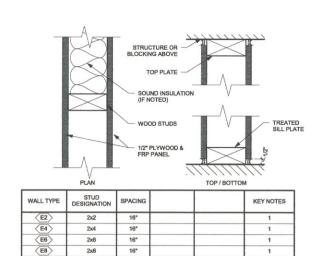

3 WALL TYPE E (WOOD STUD PARTITION)

1

A2.11

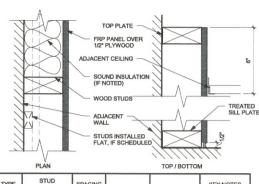

	LDAM		TOP	BOTTOM
WALL TYPE	STUD DESIGNATION	SPACING		KEY NOTES
(F1)	1x2 (FLAT)	16"		1
(F2)	2x2	16°		1
F4	2x4	16"		1
F6	2x6	16"		1
F8	2x8	16"		1
$\bigcirc$				1

(6) WALL TYPE F (WOOD STUD FURRING)

# INTERIOR PARTITION KEY NOTES:

# NOT ALL KEY NOTES APPLY TO PROJECT. VERIFY WITH SPECIFIC WALL TYPE.

- 1. INCLUDE FIBERGLASS SOUND INSULATION.
- 2. INCLUDE ACOUSTIC SEALANT AT WALL BASE AND TOP TERMINATION, BOTH SIDES OF WALL

# **GENERAL INTERIOR PARTITION NOTES:**

- IN ALL WET AREAS SUCH AS SHOWERS AND TUBS, INSTALL CEMENT-BASED BACKER BEHIND AREAS SCHEDULED TO RECEIVE TILE FINISH.
- ON ALL RESTROOM WALLS AND OTHER AREAS SCHEDULED TO RECEIVE FRP OR TILE FINISH, PROVIDE A MINIMUM OF MOISTURE-RESISTANT GYPSUM BOARD.
- ALL PARTITIONS CONTAINING PLUMBING OR HAVING AN EXTERIOR FACE SHALL BE INSULATED.
- WHERE GYPSUM BOARD EXTENDS TO UNDERSIDE OF STRUCTURE ABOVE, STOP GYPSUM BOARD  $1/2^{\circ}$  BELOW LINE OF STRUCTURE AND SEAL AS REQUIRED.
- REFERENCE FLOOR FINISH PLANS AND WALL FINISH PLANS FOR ADDITIONAL FINISHES NOT INDICATED ON PARTITION TYPES.
- REFER TO MECHANICAL AND ELECTRICAL DRAWINGS FOR LOCATIONS OF WALL PENETRATIONS. SEAL ALL OPENINGS WITH ACOUSTICAL SEALANT.
- PROVIDE WOOD OR STEEL BACKING FOR ALL WALL-MOUNTED FINISH CARPENTRY, ARCHITECTURAL WOODWORK, TOILET PARTITIONS, ACCESSORIES AND OTHER SIMILAR ITEMS.

# **KEYNOTE LEGEND**

- STAINLESS STEEL COUNTERTOP
- 1 STAINLESS STEEL COUNTERTOP
  3 PARTIAL HEIGHT WALL
  4 SERVICE WINDOW
  5 3 COMPARTMENT SINK W/ DRAIN BOARDS EACH END
  6 FULLY-ADHERD EPDM ROOF OVER POLYISO TAPERED INSUL
  OVER 5/8" PLYWOOD OVER WOOD JOIST FRAMING
  7 PREFINISHED METAL PARAPET CAP
  8 BACK-LIT WALL-MOUNTED SIGNAGE
  9 DASHED LINE INDICATES FACE OF WALL BELOW WALL CAP



PRELIMINARY NOT FOR CONSTRUCTION

# SHEET NOTES

THIS DOCUMENT IS THE PROPERTY OF I & S GROUP, INC AND MAY NOT BE USED, COPIED OR DUPLICATED WITHOUT PRIOR WRITTEN CONSENT.

PROJECT

# **MOKA DRIVE-UP COFFEE SHOP**

LA CROSSE WISCONSIN

REVISION SCHEDULE


PROJECT NO 16-19260 FILE NAME DESIGNED BY REVIEWED BY

ORIGINAL ISSUE DATE 7/1/16 CLIENT PROJECT NO.

**FLOOR PLAN, ROOF PLAN & PARTITION TYPES** 

A1.21




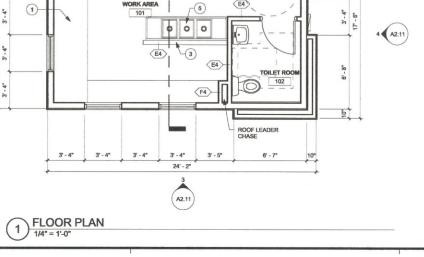


r4


E4


T1

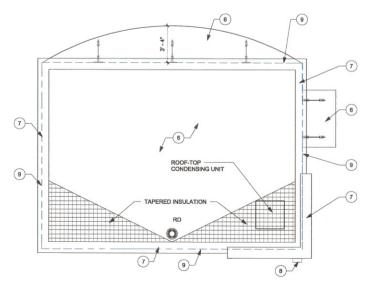

2 ROOF PLAN
1/4" = 1'-0"

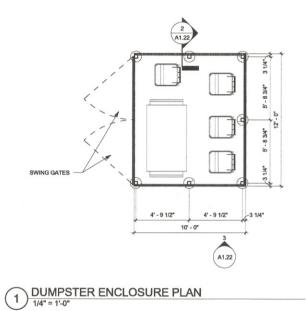

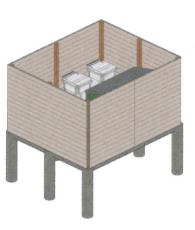

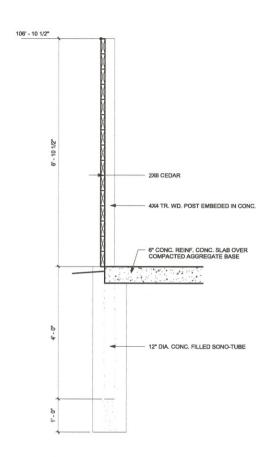

DUMPSTER ENCLOSURE SECTION
3/4" = 1"-0"



3 DUMPSTER ELEVATION



THIS DOCUMENT IS THE PROPERTY OF I & S GROUP, INC. AND MAY NOT BE USED, COPIED OR DUPLICATED WITHOUT PRIOR WRITTEN CONSENT.

PROJECT

# MOKA DRIVE-UP COFFEE SHOP

LA CROSSE WISCONSIN

REVISION SCHEDULE

NO DATE DESCRIPTION

PROJECT NO. 16-19260

FILE NAME

DRAWN BY

DESIGNED BY

REVIEWED BY

Checker

ORIGINAL ISSUE DATE 7/1/16

CLIENT PROJECT NO.

TITLE

DUMPSTER ENCLOSURE PLAN

SHEET

A1.22



1 EAST ELEVATION
1/4" = 1'-0"

WEST ELEVATION

1/4" = 1'-0"






(5) VIEW FROM SOUTH EAST



NORTH ELEVATION


1/4" = 1'-0"

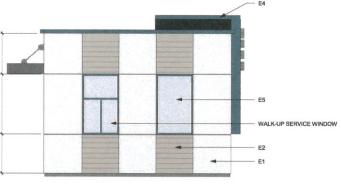

WALL-MOUNTED LIGHT FIXTURE ELECTRICAL SERVICE PANEL & METER 4 SOUTH ELEVATION
1/4" = 1'-0"



6 VIEW FROM NORTH EAST

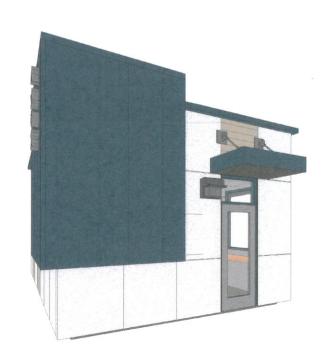

7 VIEW FROM SOUTH WEST

EXTERIOR FINISH SCHEDULE						
MARK	MATERIAL	MANUFACTURER	PRODUCT	SIZE	COLOR	COMMENTS
E1	FIBER CEMENT	NICHIHA	ILLUMINATION			
E2	WOOD - CEDAR	N/A		1X6		
E3	STANDING SEAM METAL	FIRESTONE	UC-3	24" PANELS		
E4	PREFINISHED METAL	FIRESTONE				
E5	STOREFRONT	TUBELITE	T14000	2" X 4 1/2"	ANODIZED ALUMINUM	



PRELIMINARY NOT FOR CONSTRUCTION

THIS DOCUMENT IS THE PROPERTY OF I & S GROUP, INC. AND MAY NOT BE USED, COPIED OR DUPLICATED WITHOUT PRIOR WRITTEN CONSENT.

PROJECT

# **MOKA DRIVE-UP COFFEE SHOP**

LA CROSSE WISCONSIN REVISION SCHEDULE
DESCRIPTION PROJECT NO. 16-19260

DRAWN BY DESIGNED BY REVIEWED BY ORIGINAL ISSUE DATE 7/1/16 CLIENT PROJECT NO.

TITLE

**EXTERIOR ELEVATIONS** 

A2.11

