New O'Reilly Auto Parts Store 712 George Street LA CROSSE, WI 54603

ABBREVIATIONS LEGEND

AGOVE FINISHED FLOAT
AGOUSTICAL AGOVERNAME
ACQUISTICAL AGOVERNAME
ALTERNATE
AND
ALTERNATE
AND
ALTERNATE
AND
BOTTOM OF FOOTHOR
BOUND
BOTTOM OF FOOTHOR
BOTTOM
BOTTOM RIGIA-TE HIGH CONTRACT HAND CO

SYMBOLS LEGEND

-SECTION NUMBER SECTION NUMBER
SECTION / ELEVATION MARK

DETAIL MARK -SHEET NUMBER

? DOOR MARK ? WINDOW MARK AUTO PARTS

O'REILLY AUTOMOTIVE STORES, INC. A MISSOURI CORPORATION (FORMERLY KNOWN AS O'REILLY AUTOMOTIVE, INC.) 233 SOUTH PATTERSON

ALL SUB-CONTRACTOR BIDS TO BE SUBMITTED TO

CONTACT OWNER'S DESIGNATED REPRESENTATIVE FOR ADDITIONAL PROJECT INFORMATION

ARCHITECT



417-862-2674 PHONE

PATRICK G. BLEES, ARCHITECT 800 WASHINGTON AVE. N. SUITE 208 MINNEAPOLIS, MN 55401-1148 Phone: (612) 547-1300 Fax: (612) 547-1301 EMAIL: ajohnson@cmarc

STRUCTURAL ENGINEER



ADVANCED STRUCTURAL TECHNOLOGIES Contact: PAUL STOLE, EXT 204

GENERAL NOTES

A. CONTRACT ADMINISTRATION (LIMITED SERVICE): THE ARCHITECT AND/OR ENGINEER OF RECORD INDICATED HEREIN ARE PROVIDING A LIMITED SERVICE AND NOT PROVIDING CONTRACT ADMINISTRATION SERVICES FOR THIS PROJECT WHICH IS THE RESPONSIBILITY OF OTHERS. THE ARCHITECT AND/OR ENGINEER ARE NOT RESPONSIBLE FOR FIELD ACTIVITIES ON THIS PROJECT WITHOUT DIRECT INSPECTION OF THE WORK IN PROGRESS. IF FIELD CONDITIONS ARE UNCOVERED THAT REQUIRE A CHANGE OR ADDITIONAL INFORMATION. THE ARCHITECT AND/OR ENGINEER DOES NOT DELEGATE AUTHORITY TO ANYONE ELSE FOR DETERMINING THE MEANING OF PLANS OR SPECIFICATIONS AS AUTHENTICATED HEREIN.

B. QUALITY STANDARDS AND BUILDING CODES: CONTRACTORS SHALL BE RESPONSIBLE FOR KNOWING THE QUALITY AND PUBLIC SAFETY REGULATIONS SET FORTH IN THE GOVERNING CODES AND OTHER APPLICABLE REGULATIONS OF LOCAL AND STATE AGENCIES HAVING JURISDICTION WHICH GOVERN EACH CONTRACTOR'S WORK.

C. EXISTING CONDITIONS: FIELD VERIFY EXISTING CONDITIONS BY DETAILED INSPECTION PRIOR TO SUBMITTING BID AND BEGINNING WORK. NOTIFY THE ARCHITECT AND/OR ENGINEER OF RECORD IF EXISTING CONDITIONS DEVIATE SUBSTANTIALLY FROM THOSE

MECH. / ELEC. ENGINEER



OWNER OR TENANT

SGE, INC. 3855 S JEFFERSON AVE SPRINGFIELD, MO 65807 Phone: (417) 882-2200 Fax: (417) 882-1188

Contact: TRENT STARK

CIVIL ENGINEER

ANDERSON ENGINEERING, INC.
2045 W WOODLAND, 100 DEPRINGTED LAND SERVICE AND SE

SPRINGFIELD, MO 65807 Contact: PAUL ENGEL

QUALITY CONTROL

1. REFER TO PROJECT MANUAL, SECTION 01 45 16 - QUALITY CONTROL PROCEDURES, FOR ADDITIONAL REQUIREMENTS.

2. REFER TO STRUCTURAL DRAWINGS FOR SCHEDULE OF SPECIAL INSPECTIONS, IF INDICATED. 3. WHERE REQUIRED. THE OWNER SHALL PROVIDE THE

SERVICES OF AN INDEPENDENT TESTING LABORATORY TO PERFORM TESTING AND SPECIAL INSPECTIONS INDICATED.

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PLUMBING DETAILS

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POWER SCHEDULE

VENSTAR SURVEYOR

SITE SIGNAGE PLAN

SITE SIGNAGE DETAILS

VENSTAR O'REILLY DETAILS

VENSTAR SURVEYOR - S.O.W.

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P2

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M2

E1

F2

VS1

VS2

VS3 SG1.1

SG1.2

CONSULTANTS:

ANDERSON ENGINEERING, INC. 2045 WEST WOODLAND SPRINGFIELD, MO 65619 PHONE: 417–866–2741 FAX: 417–866–2778

SGE, INC. 3855 S JEFFERSON AVE SPRINGFIELD, MO 65807 PHONE: 417–882–2200 FAX: 417–882–1188



PATRICK G. BLEES, ARCHITECT

10.14.16 DATE ISSUED

A-9014 REG. NO.

CREIIIY AUTO PARTS

SHEET TITLE: COVER SHEET

REVISIONS: PROJECT NO: 16115.014

SHEET 1 OF 2

	SCOPE	OF	W	OF	RK	SCHEDULE	
PROJECT MANUAL			ED BY CTOR	ED BY	ED 87	CONTACT INFOR	MATION
SECTION REF. NUMBER	ITEM OR WORK DESCRIPTION	FURNISHED BY CONTRACTOR	INSTALLED BY CONTRACTOR	FURNISHED B OWNER	INSTALLED	COMPANY & ADDRESS	POINT OF CONTACT, PHONE (P), FAX (F), OR EMAIL (E)
01 11 00	SUMMARY OF WORK (GENERAL BUILDING PERMIT, STATE DEPARTMENT OF TRANSPORTATION PERMITS STATE DEPARTMENT OF NATURAL RESOURCES PERMITS)			×		O'REILLY AUTOMOTIVE STORES, INC. 233 SOUTH PATTESON SPRINGFIELD, MO 65802	OWNER'S OR TENANT'S DESIGNATED PROJECT ADMINISTRATOR
01 11 00	SUMMARY OF WORK (ALL TRADE PERMITS, UTILITY IMPACT AND CONNECTION FEES, OR PERMITS AND FEES REQUIRED FOR PROJECT COMPLETION)	x					
01 45 16	QUALITY CONTROL PROCEDURES (TESTING & SPECIAL INSPECTIONS)		x	x		(TO BE DETERMINED)	OWNER'S OR TENANT'S DESIGNATED PROJECT ADMINISTRATOR
07 21 00	BUILDING INSULATION (PRE-ENGINEERED METAL BUILDING BATT)		x	x		GLOBAL BUILDING PRODUCTS (SILVERCOTE INSULATION) 1121 HERMAN STREET ELKHART, INDIANA 46516	JERRY MILLER P: 417.861.9513
07 46 00	SIDING (FIBER CEMENT BOARD)	x	x			(REFER TO NOTE NO. 1) NICHIHA USA, INC. 6659 PEACHTREE INDUSTRIAL BLVD. SUITE AA NORCROSS, GEORGIA 30092	MICHAEL RUSSO P: 770.805.9466
08 11 19	STEEL DOORS AND FRAMES (EXTERIOR SWING UNITS)		x	x		GLOBAL BUILDING PRODUCTS 1121 HERMAN STREET ELKHART, INDIANA 46516	ANDREW CARPENTER P: 574.296.6868
08 11 19	STEEL DOORS AND FRAMES (INTERIOR SWING UNITS)	x	x			(REFER TO NOTE NO. 1) LOCKNET 100 COURCHELLE DRIVE NICHOLASVILLE, KY 40356	PAM PEEL P: 800.887.4307, EXT: 133 F: 859.881.5499 construction@locknet.com
08 14 16	FLUSH WOOD DOORS (INTERIOR SWING UNITS)	x	x			(REFER TO NOTE NO. 1) LOCKNET 100 COURCHELLE DRIVE NICHOLASVILLE, KY 40356	PAM PEEL P: 800.887.4307, EXT: 133 F: 859.881.5499 construction@locknet.com
08 71 00	DOOR HARDWARE (EXTERIOR SWING UNITS)		x	x		GLOBAL BUILDING PRODUCTS 1121 HERMAN STREET ELKHART, INDIANA 46516	ANDREW CARPENTER P: 574.296.6868
08 71 00	DOOR HARDWARE (INTERIOR SWING UNITS)	х	x			(REFER TO NOTE NO. 1) LOCKNET 100 COURCHELLE DRIVE NICHOLASVILLE, KY 40356	PAM PEEL P: 800.887.4307, EXT: 133 F: 859.881.5499 E: construction@locknet.com
08 41 13	ALUMINUM ENTRANCES AND STOREFRONTS	x	x			(REFER TO NOTE NO. 1) COULTER & COMPANY 13711 E. 66TH STREET NORTH OWASSO, OK 74055	CARL OR TOMMY COULTER P: 918.272.4494 F: 918.272.7908 E: coulter-co@earthlink.net
08 44 12 08 44 13	GLAZED ALUMINUM CURTAIN WALLS	x	x			(REFER TO NOTE NO. 1) COULTER & COMPANY 13711 E. 68TH STREET NORTH OWASSO, OK 74055	CARL OR TOMMY COULTEF P: 918.272.4494 F: 918.272.7908 E: coulter-co@earthlink.net
09 90 00	PAINTING (INTERIOR PAINTED GRAPHICS)			x	x	O'REILLY AUTOMOTIVE STORES, INC. 233 SOUTH PATTESON SPRINGFIELD, MO 65802	OWNER'S OR TENANT'S DESIGNATED PROJECT ADMINISTRATOR
10 14 00	SIGNAGE (EXTERIOR PANEL SIGNAGE, ILLUMINATED PANEL SIGNAGE, POST AND PANEL/PYLON SIGNAGE, POST CONCRETE FOUNDATIONS)			x	x	O'REILLY AUTOMOTIVE STORES, INC. 233 SOUTH PATTESON SPRINGFIELD, MO 65802	OWNER'S OR TENANT'S DESIGNATED PROJECT ADMINISTRATOR
10 14 00	SIGNAGE (MONUMENT SIGN CONCRETE FOUNDATIONS AND MASONRY, ELECTRICAL ROUGH-IN SYSTEMS)	x	x				
10 28 13	TOILET ACCESSORIES (TISSUE PAPER DISPENSERS, SOAP DISPENSERS, PAPER TOWEL DISPENSERS)		x	x		O'REILLY AUTOMOTIVE STORES, INC. 233 SOUTH PATTESON SPRINGFIELD, MO 65802	OWNER'S OR TENANT'S DESIGNATED PROJECT ADMINISTRATOR
10 71 16	STORM PANELS	x	x			(REFER TO NOTE NO. 1) TOWN & COUNTRY INDUSTRIES 400 WEST MCNAB ROAD FORT LAUDERDALE, FLORIDA 33309	TOM JOHNSON P: 561.512.9702
11 16 16	SAFES		x	×		O'REILLY AUTOMOTIVE STORES, INC. 233 SOUTH PATTESON SPRINGFIELD, MO 65802	OWNER'S OR TENANT'S DESIGNATED PROJECT ADMINISTRATOR
12 57 00	INDUSTRIAL FURNITURE (RACKING AND SHELVING)			×	х	O'REILLY AUTOMOTIVE STORES, INC. 233 SOUTH PATTESON SPRINGFIELD, MO 65802	OWNER'S OR TENANT'S DESIGNATED PROJECT ADMINISTRATOR
13 34 18	PRE-ENGINEERED META BUILDING SYSTEMS		×	×		BUTLER MANUFACTURING, INC. 1540 GENESSEE STREET KANSAS CITY, MO 64102	SCOTT CARLETON P: 816.968.3472 F: 816.627.8964
13 34 10	מאון און היייניים איריים א					CHIEF BUILDINGS, INC. P.O. BOX 2078 1821 SOUTH NORTH ROAD GRAND ISLAND, NE 68802-2078	MICHAEL LOYD P: 308.390.6695
22 40 00	PLUMBING FIXTURES (ONLY WATER HEATERS, SHELF, & THERMAL EXPANSION TANK)		x	x		GRABAR ELECTRIC COMPANY, INC. 11885 LACKLAND ROAD ST. LOUIS, MO 83148	SANDI YOUNG P: 314.573.2082 SAM CAST P: 314.573.2081
23 74 00	ROOFTOP HEATING/COOLING UNITS		х	x		CARRIER CORPORATION NATIONAL ACCOUNTS 29 INDUSTRIAL PARK DRIVE BINGHAMTON, NY 13904	SARA TILTON P: 866.389.4658, EXT. 3429 PAUL WITZ P: 315.317.2481
25 00 00	INTEGRATED AUTOMATION (ENERGY MANAGEMENT SYSTEM - SOFTWARE, HARDWARE, CONDUIT, WIRING, EQUIPMENT)		x	x		VENSTAR, INC.	(TECHNICAL SUPPORT) P: 818.812.9812 P: 818.341.8760
						(REFER TO NOTE NO. 2) STOVER ELECTRIC	JAMES STOVER P: 805.581.0740
25 00 00	INTEGRATED AUTOMATION (ENERGY MANAGEMENT SYSTEM - INSTALLATION)	x	x			(REFER TO NOTE NO. 2) ZUBRAS ELECTRIC	SIMON ZUBRAS P: 214.319.6900

ENIS PACAVAR P: 978.395.1807

(REFER TO NOTE NO. 2) SYLVANIA LIGHTING SERVICES

26 24 13	ELECTRICAL EQUIPMENT (PANEL BOARDS, TRANSFORMERS, TRANSFER SWITCH KIT, AND DISCONNECTS)		x	x		GRABAR ELECTRIC COMPANY, INC. 11885 LACKLAND ROAD ST. LOUIS, MO 63146	P: 314.573.2082 SAM CAST P: 314.573.2081
26 50 00	LIGHTING (LIGHT FIXTURES, SENSORS)		x	x		GRABAR ELECTRIC COMPANY, INC. 11885 LACKLAND ROAD ST. LOUIS, MO 63146	SANDI YOUNG P: 314.573.2082 SAM CAST P: 314.573.2081
27 00 00	COMMUNICATIONS - VOICE AND DATA (ELECTRONIC SYSTEMS AND CONDUCTORS)			x	x	O'REILLY AUTOMOTIVE STORES, INC. 233 SOUTH PATTESON SPRINGFIELD, MO 65802	OWNER'S OR TENANT'S DESIGNATED PROJECT ADMINISTRATOR
27 00 00	COMMUNICATIONS - VOICE AND DATA (CONDUIT, BOXES)	x	×				
28 00 00	ELECTRONIC SAFETY AND SECURITY SYSTEM			x	x	O'REILLY AUTOMOTIVE STORES, INC. 233 SOUTH PATTESON SPRINGFIELD, MO 65802	OWNER'S OR TENANT'S DESIGNATED PROJECT ADMINISTRATOR
28 30 00	FIRE DETECTION, ALARM, AND MONITORING SYSTEMS (CONDUIT, WIRING, EQUIPMENT) REFER TO FIRE PROTECTION, MECHANICAL, AND ELECTRICAL DRAWINGS FOR ADDITIONAL REQUIREMENTS.			x	x	O'REILLY AUTOMOTIVE STORES, INC. 233 SOUTH PATTESON SPRINGFIELD, MO 65802	LEIGH SIDES P: 417.829.5712

GENERAL NOTES

- (A) REFER TO PROJECT MANUAL FOR ADDITIONAL REQUIREMENTS.
- C SCOPE OF WORK SCHEDULE MAY INCLUDE ITEMS NOT REQUIRED FO PROJECT SPECIFIC CONDITIONS.
- (D) CONTACT OWNER'S OR TENANT'S DESIGNATED PROJECT ADMINISTRATOR FOR QUESTIONS OR CLARIFICATIONS.

BIDDING INFORMATION: REFER TO OWNER'S WEB SITE: WWW.OREILLYPLANROOM.COM

ALL SUB-CONTRACTOR BIDS TO BE SUBMITTED TO INVITED GENERAL CONTRACTORS ONLY.

CONTACT OWNER'S DESIGNATED REPRESENTATIVE FOR ADDITIONAL PROJECT INFORMATION.

- (E) FOR LEASE SPACES, SEE SHEET MI FOR "MECHANICAL RESPONSIBILITY SCHEDULE" FOR ADDITIONAL SCOPE OF WORK.



PATRICK G. BLEES architecture • planning • interior design

PATRICK G. BLEES ARCHITECT, PLLC 800 WASHINGTON AVE. N. SUITE 208 MINNEAPOLIS, MN 55401 PHONE: (612) 547-1377 FAX: (612) 547-1301 CONTACT: TONY JOHNSON qiohnson@cmarch.com

CONSULTANTS:

ANDERSON ENGINEERING, INC. 2045 WEST WOODLAND SPRINGFIELD, MO 65619 PHONE: 417–866–2741 FAX: 417–866–2778

AST, INC. 7212 METRO BLVD. EDINA, MN 55439 PHONE: 952-854-9302 FAX: 952-854-9360

SGE, INC. 3855 S JEFFERSON AVE SPRINGFIELD, MO 65807 PHONE: 417-882-2200 FAX: 417-882-1188

SEAL:



PATRICK G. BLEES, ARCHITECT

10.14.16 DATE ISSUED A-9014 REG. NO.

Reilly AUTO PARTS

SHEET TITLE: SCOPE OF WORK SCHEDULE

REVIS	IONS:	
NO:	DATE:	BY:
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T		
PROJE	CT NO:	16115.0
DRAWN	BY:	

SHEET 2 OF 2

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CODE SUMMARY PLAN G1.1 SCALE: 1/8" = 1'-0"

(2

PROJECT DATA

PARKING GROSS AREA: 17.800 GSF BUILDING BUILDING GROSS AREA: 7 228 GSF

HAZARDOUS MATERIALS INVENTORY STATEMENT (HMIS)

(A) UPON REQUEST OWNER TO PROVIDE UNDER SEPERATE COVER, PROJECT HAZARDOUS MATERIALS INVENTORY STATEMENT (HMIS) FOR COMMODITY TYPES, HAZARD CLASS, AND QUANTITIES.

(B) OWNER RESPONSIBLE FOR MONITORING INVENTORY COMMODITY TYPES AND QUANTITIES TO NOT EXCEED CODE REQUIREMENTS.

BUILDING CODE

LA CROSSE COUNTY COUNTY

GOVERNING CODES AND ORDINANCES
BUILDING CODE: 2009 INTERNATIONAL

BUILDING CODE PLUMBING CODE 2009 INTERNATIONAL PLUMBING CODE MECHANICAL CODE: 2009 INTERNATIONAL MECHANICAL CODE ELECTRICAL CODE: 2011 NEC FIRE CODE: FNERGY CODE:

ACCESSIBILITY CODE: AMENDING ORDINANCE: WISCONSIN STATE **BUILDING CODE**

USE GROUP & CONSTRUCTION TYPE PRIMARY USE GROUP:
MIXED USE AND OCCUPANCY: M (MERCANTILE) NON-SEPERATED CONSTRUCTION TYPE:

NOT APPLIED AUTOMATIC SPRINKLER INCREASE: NOT PROVIDED

ALLOWABLE HEIGHT & BUILDING AREA NO. STORIES: 2 STORIES 12,500 SQ. FT.

ACTUAL HEIGHT & BUILDING AREA NO. OF STORIES: 1 STORY BUILDING HEIGHT: GROSS BUILDING AREA: 7,228 SQ. F.T

FIRE PROTECTION SYSTEMS
AUTOMATIC SPRINKLER SYSTEM: NOT REQUIRED REQUIRED NOT REQUIRED PORTABLE FIRE EXTINGUISHERS: FIRE ALARM SYSTEM: MONITORING: NOT REQUIRED

(REFER TO SCOPE OF WORK SHEET) AUTOMATIC FIRE DETECTION SYSTEM: NOT REQUIRED

STRUCTURAL DESIGN (REFER TO STRUCTURAL DRAWINGS) ROOF (1/4"12): 20 PSF 2. ROOF COLLATERAL LOADS ARCHITECTURAL / MECHANICAL: 2.5 PSF

PARTS AREA "A": 2.0 PSF 3. SNOW LOADS GROUND LOAD (Pg): MINIMUM ROOF SNOW LOAD (Pf): IMPORTANCE FACTOR (Is): 40 PSF 32 PSF

BASIC WIND SPEED (Vu): 90 MPH IMPORTANCE FACTOR (IW): 1.0

5. SEISMIC 0.063 0.034 0.067 0.054 IMPORTANCE FACTOR (Ie): SITE CLASS (GEOTECHNICAL REPORT): D **DESIGN CATEGORY:**

6. BUILDING LATERAL DEFLECTION LIMITS: MAX. ROOF SNOW OR LIVE LOAD DEFLECT.: SPAN/240
MAX. ROOF TOTAL LOAD DEFLECT.: SPAN/180 SPAN/180 MAX. METAL BUILDING LATERAL DEFLECT.: HEIGHT/150

COMMERCIAL ENERGY EFFICIENCY CODE COMPLIANCE WITH BUILDING ENERGY EFFICIENCY REQUIREMENTS BASED UPON ANSI/ASHRAE/IESNA 90.1 (PERFORMANCE METHOD)

CERTIFICATE OF COMPLIANCE AND CALCULATIONS TO BE PROVIDED UPON REQUEST UNDER SEPARATE COVER.

OCCUPANCY LOAD SUMMARY

				Ė
	ROOM OR AREA	AREA PER	OCCUPANTS	
	(REFER TO FLOOR PLAN)	OCCUPANT(S.F.) (QTY.)	Ė
	100 - PARTS AREA "A"	30	105	•
	101 - PARTS AREA "B"	300	3	
	102 - OFFICE	100	1	
	103 - RESTROOM	N/A	0	ŀ
-	104 - RESTROOM	N/A	0	F
	105 - PARTS AREA "C"	300	9	
	TOTAL OCCUPANCY		118	

GENERAL NOTES

 $\langle \overline{{\sf A}} \rangle$ REFER TO PROJECT MANUAL FOR ADDITIONAL REQUIREMENTS.

(B) REFER TO PLANS, SECTIONS, AND DETAILS FOR CONSTRUCTION OF FIRE RATED ASSEMBLIES, WHERE UNDERWRITERS LABORATORY (UL) TEST NUMBERS ARE REFERENCED, CONTRACTOR SHALL PROVIDE CONSTRUCTION MATERIALS, MEANS AND METHODS TO COMPLY WITH TESTED ASSEMBLY.

© REFER TO MECHANICAL AND ELECTRICAL DRAWINGS FOR ADDITIONAL REQUIREMENTS.

OWNER FURNISHED AND INSTALLED FURNISHINGS AND FIXTURES SHOWN FOR REFERENCE ONLY.

2011 NEC
2009 IECC

CONTRACTOR TO PROVIDE PORTABLE FIRE EXTINGUISHERS
DURING CONSTRUCTION AS REQUIRED TO PROTECT THE WORK
AREA AND EACH STORAGE UNIT AND JOB TRAILER PER THE FIRE
CODE.

(F) PERMANENT PORTABLE FIRE EXTINGUISHER TO BE MOUNTED AT 42* ABOVE FINISH FLOOR TO CENTERLINE OF EXTINGUISHER. FIRE EXTINGUISHERS SHALL BE UL LISTED WITH TYPE AND CAPACITY FOR HAZARD AND PROJECT CONDITIONS. REFER TO FLOOR PLAN

G EXIT DISCHARGE DOORS, PROVIDE TACTILE EXIT SIGNS STATING "EXIT" WITH BRAILLE LETTERING. SIGN AND MOUNTING TO COMPLY WITH ANSI A117.1. REFER TO FLOOR PLAN FOR LOCATIONS.

SYMBOLS LEGEND

PRIMARY USE GROUP: (MERCANTILE) CONSTRUCTION TYPE: (COMBUSTIBLE/PROTECTED)
ROOM SQUARE FOOTAGE: II-B

DESIGN OCCUPANT LOAD SERVED BY EXIT:
MAXIMUM ALLOWABLE CAPACITY (EXAMPLE: 36" /.2" = 180); OCCUPANT LOAD SERVED BY EXIT BUT NOT COUNTED IN TOTAL OCCUPANT LOAD:

(1) HOUR FIRE SEPARATION ASSEMBLY EXTENDS UP TO DECK, FIRE SEAL COMPLETELY: (2) HOUR FIRE SEPARATION ASSEMBLY EXTENDS UP TO DECK OR NIN. 30° ABOVE DECK, FIRE SEAL COMPLETELY:

ROOM OCCUPANT LOAD NOT COUNTED IN:

ROOM OCCUPANT LOAD AT 5 SQ. FT. NET PER PERSON ROOM OCCUPANT LOAD AT 7 SQ. FT. NET PER PERSON: ROOM OCCUPANT LOAD AT 15 SQ. FT. NET PER PERSON ROOM OCCUPANT LOAD AT 20 SQ. FT. NET PER PERSON: ROOM OCCUPANT LOAD AT 30 SQ. FT. GROSS PER PERSON

ROOM OCCUPANT LOAD AT 100 SQ. FT. GROSS PER PERSON: **65**

ROOM OCCUPANT LOAD AT 300 SQ. FT GROSS PER PERSON:

10 ROOM OCCUPANT LOAD AT 500 SQ. FT GROSS PER ROOM OCCUPANT LOAD AT 18" OF SEAT PER PERSO FIRE ALARM PULL STATION

FIRE AUDIBLE & VISUAL ALARM

s FIRE ALARM STROBE EMERGENCY EXIT LIGHTING

FLOOR/CEILING FIRE RATED ASSEMBLY ----- EXIT ACCESS TRAVEL DISTANCE (LENGTH IN FEET)

PLUMBING FIXTURE SUMMARY

GENERAL IPC TABLE 403.1 PRIMARY OCCUPANCY: (M) MERCANTILE TOTAL OCCUPANCY: OCCUPANCY LOAD CALCULATED PER SEX: 118 / 2 = 59 FEMALE: MALE:

PLUMBING FIXTURES
WATER CLOSETS (URINALS): 1 PER 500 59/500 = 1 PROVIDED FOR FEMALE: 59/500 = 1 REQUIRED FOR MALE: PROVIDED FOR MALE: 1 AND 1 URINAL

LAVATORIES: 1 PER 750 REQUIRED FOR FEMALE: 59/750 = 1 PROVIDED FOR FEMALE: 59/750 = 1 PROVIDED FOR MALE: DRINKING FOUNTAINS: 1 PFR 1 000 REQUIRED:

118/1000 = 1PROVIDED:

SERVICE SINK REQUIRED: SERVICE SINK PROVIDED:

G. BLEES

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SGE, INC. 3855 S JEFFERSON AVE SPRINGFIELD, MO 65807 PHONE: 417–882–2200 FAX: 417–882–1188

SEAL:



PATRICK G. BLEES, ARCHITECT

DATE ISSUED A-9014 REG. NO.

> 712 GEORGE STREET LA CROSSE, WI 54603 AUTO © Reilly:


SHEET TITLE: CODE SUMMARY PLAN

REVISIONS: PROJECT NO: 16115.014 DRAWN BY: KJO/BLC

G

SHEET 1 OF

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PRESENT OWNER

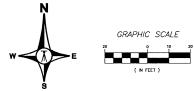PER TITLE COMMITMENT NO CO-1469.

prepared for:

AND MERIDIAN TITLE

of: 710 George Street - La Crosse, Wisconsin 640.46 640.46 640.90 64 ST _____STORM_SENER ____ST -540,73 524.93 640.87 j 636.27 - SOUTH LINE OF ST. CLOUD STREET

THIS SITE IS INCUIDED ON FLOOD INSURANCE RATE MAP-COMMUNITY PANEL NUMBER 55083C0253D. ACCORDING TO THIS MAP THE SUBJECT PROPERTY IS LOCATED IN FLOOD ZONE AE, WHICH IS DEFINED AS AN AREA DETERMINED TO BE INSIDE THE 100-YEAR ANNIAL CHANCE FLOODFLAIM. UTILITY COMPANY CONTACT INFO

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Randy Turtenwold, Director of Engineering
turtenwold edityoflorosse, org
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La Crosse, M 54601
CenturyLafik (Phone): (608) 786-5543
stevebiblado@enturytet.com
333 N. Front Street
PO Box 4600
La Crosse, M 54602
Wisconsent Street, 107
Eau Claim, M 54703
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FLOOD ZONE

Courter Communications (Cable):
Perry Mcdellan Beharts.com
perry mcdellan Beharts.com
perry mcdellan Beharts.com
(Anderson Beharts.c (715) 839-2574

ZONING

THIS SUBJECT PROPERTY IS LOCATED WITHIN THE CITY OF LA CROSSE CITY LIMITS AND IN THE FOLLOWING ZONING DISTRICT:

C2 - COMMERCIAL
SETBACKS: THERE ARE NO MINIMUM SETBACK REQUIREMENTS IN THE
C2 ZONING DISTRICT, HOMEVER ANY SITE PLAN THAT PROPOSES A
BUILDING WITHIN 6 FEET OF A PROPERTY LINE IS SUBJECT TO
REMEW BY THE FIRE DEPARTMENT.

SITE AREA

SOURCE BENCHMARK NGS BM (ON1332) ON US HWY 53 - NE CORNER OF BRIDGE OVER RAHLROAD TRACKS (0.6± MILES SW OF THE SITE) 677.95 (NAVD 88 DATUM)

SITE BENCHMARK

NOTES

1. THE CLOSEST FIRE HYDRANT TO THE SUBJECT PROPERTY IS APPROXIMATELY 64 FEET SW OF THE SW CORNER OF THE MAIN BUILDING ON THE SUBJECT PROPERTY.

1. THE CLOSEST FIRE HYDRANT TO THE SUBJECT PROPERTY IS APPROXIMATELY 64 FEET SW OF THE SW CORNER OF THE MAIN BUILDING ON THE SUBJECT PROPERTY.

2. THE PROPERTY OF THE SWEET IN THIS AREA APPEARS TO BE REINFORCED CONCRETE PIPE.

3. ALL OF THE FUELDE STORM SWEET IN THIS AREA APPEARS TO BE REINFORCED CONCRETE PIPE.

4. IT IS NOT CLEAR WHAT THE FUNCTION OF THE MAINHOLE IN THIS LOCATION IS. IT IS POSSIBLY AN ACCESS POINT TO AN UNDERFORMOUS DISTANCE TAINS. THE CURRENT OWNER SHOULD BE CONTINCTED TO DETERMINE IF THIS IS THE CASE.

5. THIS MAINHOLE APPEARS TO BE A PART OF THE DRAINAGE SYSTEM ON THE SUBJECT PROPERTY. THE TWO PIPE RUNNING NE AND SW OUT OF THIS MAINHOLE ARE 4* PIPE OF THIS HYDRONING THE LEVELY TONS OF SYSTEM. THE TWO PIPE RUNNING HE WITH THE PROPERTY OF THE SWEET PROPERTY. THE TWO PIPE RUNNING NE AND SW OUT OF THIS MAINHOLE ARE 4* PIPE OF THIS HYDRONING THE LEVELY TONS OF SYSTEM. THE THIS OF THE PARKING AND GRASS APEAS ARE SHOTIM AS BEST AS COULD BE LOCATED GIVEN THE FIELD CONDITIONS AT THE TIME OF THE PARKING AND GRASS APEAS ARE SHOTIM AS BEST AS COULD BE LOCATED GIVEN THE FIELD CONDITIONS AT THE TIME OF THE SURVEY AND BASED ON MAPS PROVIDED BY VARIOUS UITLITY COMPANIES.

1. HICHARY STATIONING STORM HEREON IS APPROXIMATE AND SHOULD NOT BE RELIED UPON FOR EXACT LOCATION. THE STATION LABELS ARE SHOWN IN METERS, AS SHOWN ON STATE RYW PROJECT S221—04—21 PLANS.

NOTE REGARDING UTILITIES


The location of underground utilities shown hereon are approximate and are based on field locations of visible structures, markings at the time of our survey, and compiling as—built information furnished by various utility companies and governmental agencies. The markings shown on the face of this survey are per Diggers fullithe Tidekt Number 2014(10041).

STATEMENT OF APPARENT ENCROACHMENTS

An overhead electric line crosses the NE corner of the subject property.

Two retaining walls run the length of the west side of the subject property. It is not clear whether the wall is owned by the Present Owner or if the wall is owned/mointained by the City of La Crosse. If it is owned by the Present Owner, it is not an encrocomment, but it does attend on to the parcele north and south of the subject property. If it is owned by the city, the wall and a small portion of the sidewalk are an encrocomment on the subject property as there is no essement covering these improvements.


There is a billboard that sits directly on the north property line that is not covered by an easement included in the exception documents.

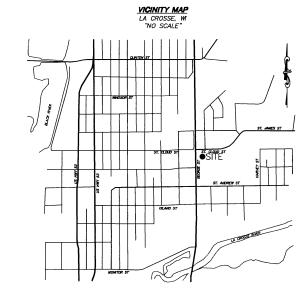

BEARING NOTE

CHICAGO TITLE INSURANCE COMPANY O'REILLY AUTOMOTIVE STORES, INC.

CERTIFICATE OF SURVEY

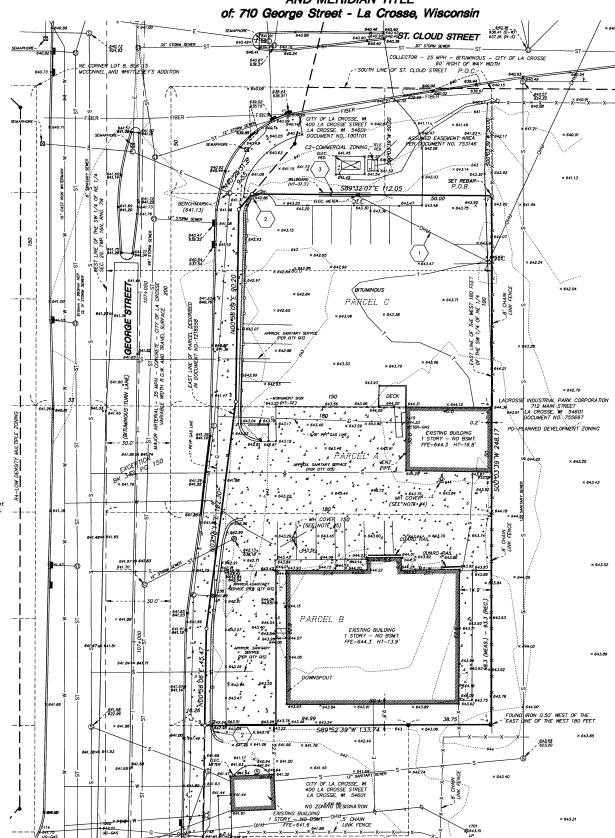

LEGAL DESCRIPTION OF PARENT PARCEL (PER TITLE COMMITMENT NO. CO-1469)

PARCEL A:
Part of the Southwest 1/4 of the Northeast 1/4 of Section 29, Town 16 North, Range 7 West, in the City of La Crosse, County of La Crosse, State of Wisconsin, described as follows: Beginning at a point on the East line of George Street 33 feet East and 150 feet South of the Northeast corner of Lat 8 in Block 15 of McConnell and Whittlesey's Addition to North La Crosse; thence East 180 feet, thence South 50 feet; thence West 180 feet to the East line of George Street, thence North along said East line 50 feet to the point of beginning. EXCEPTING therefrom those lands contained in Award of Damages recorded in Volume 342 of Records, Page 150.

The North 100 feet of the South 589.5 feet of the West 180 feet of the Southwest 1/4 of the Northeast 1/4 of Section 29, Town 16 North, Range 7 West, in the City of La Crosse, County of La Crosse, State of Misconsin. Solid property also described as follows: Part of the Southwest 1/4 of the Northheast 1/4 of Section 29, Town 16 North, Range 7 West, in the City of La Crosse, County of La Crosse, State of Wisconsine State of Wisconsine Commencing on the East line of George Street at its intersection with the North line of Hoger Street extended East; thereo Korth along said East line 25 feet to the point of beginning of this description; Thence continuing North along said East line 20 feet South of the South line of St. Cloud Street, thence East parallel with said South line of St. Cloud Street 150 feet; thence South parallel with said South line of St. Cloud Street 150 feet; thence South parallel with said East line of George Street 93.3 feet; thence Westerly 150 feet more or less; to the point of Despining.

PARCEL B:

Part of the Southwest 1/4 of the Northeast 1/4 of Section 29, Town 16 North, Range 7 West, in the City of La Crosse, County of La Crosse, State of Wisconsin, described as follows: Commencing on the East line of George Street at a point 50 feet South of the intersection of soid line and the extended South line of St. Claud Street; thence East 150 feet, thence South 100 feet, thence West 150 feet to the East line of George Street; thence North along said East line 100 feet to the point of beginning.

EXCEPTING therefrom those land contained in Award of Damages recorded as Document No. 1218558.

METES AND BOUNDS DESCRIPTION

That part of the Southwest Quarter of the Northeast Quarter of Section 29, Township 16N, Range 7W, La Crosse County, Misconshi, described as follows: Commencing at the intersection of the south right of way line of St. Cloud Street and the east Line of the West 16D feet of said Southwest Quarter of the Northeast Quarter, and encounter of the Northeast Quarter of the Northeast Quarter, a distance of 50,00 feet to the point of beginning of the parcel to be described: thence continuing South 00 degrees 03 minutes 39 seconds West, parallel with said wast line of the Southwest Quarter of the Northeast Quarter, a distance of 50,00 feet to the point of beginning of the parcel to be described: thence continuing South 00 degrees 03 minutes 39 seconds West, parallel with said west line, of the order of 248.17 feet; thence South 89 degrees 52 minutes 39 seconds East, a distance of 133.74 feet, more or less, to the easterly right of may line of Georges Street; thence North 00 degrees 57 minutes 09 seconds East, and sistance of 107.30 feet; thence continuing daing said easterly right of way line North 07 degrees 15 minutes 14 seconds East, a distance of 107.30 feet; thence continuing daing said easterly right of way line North 07 degrees 52 minutes 07 seconds East, and sistance or 107.30 feet; thence continuing daing said easterly right of way line North 07 degrees 52 minutes 07 seconds East, and sistance or 1107.30 feet; thence continuing daing said easterly right of may line North 07 degrees 52 minutes 07 seconds East, and sistance or 112.30 feet to the point of beginning in these terminating.

Said parcel contains 0.712 acres or 31,002 square feet.

Subject to any easements restrictions, or reservations of record, if any

NOTES CORRESPONDING TO TITLE INSURANCE COMPANY SCHEDULE B - SECTION II EXCEPTIONS COMMITMENT NUMBER: CO-1469 COMMITMENT DATE: February 21, 2014

11. Limited Highway Easement granted to the City of La Crosse, recorded September 25, 1961 in Volume 338 of Records, Page 642.

COMMENT: This document does not affect the subject property. The area described lies within the right of way of George Street described in Doc. No. 1218558 12. Easements contained in Award of Damages recorded as Document No. 923478 and in Award of Damages and recorded as Document No. 924118.

COMMENT: These documents do not affect the subject property. The area described lies within the right of way of George Street described in Doc. No. 1218558.

COMMENT: This document affects the subject property, however it is not clear where the east right of way line of George Street was located at the time the covenant was established so the 27" setback line is not shown on this survey. According to Tim Ackila with the City of La Crosse, MI, this covenant is likely no larger needed and O'Reilly Authorotive has the option to request that the covenant be terminated.

4. Covenants, Conditions and Restrictions contained in Easement for Ingress and Egress recorded as Document No. 1170506.

COMMENT: This document does affect the subject property in that it establishes an access easement, for the benefit of the subject property, to St. Cloud Street, however, the description included in this document contains errors. Therefore, the easement show hereon is 50 feet wide and connects the north line of the subject property with the south line of St. Cloud Street, which is the assumed intent of the description.

15. Permanent limited easement and temporary limited easement contained in Award of Damages recorded as Document No. 1218558.

COMMENT: This document affects the subject property. The easterly right of way line of George Street is shown based on the dimensions shown on this document and the found right of way monuments.

LEGEND

0	DENDIES SET DRILL HOLE WITH PK NAIL UNLESS DIHERWISE NOTED
•	DENOTES FOUND IRON MONUMENT
S	DENOTES SANITARY MANHOLE
	DENOTES STORM SEWER CATCH BASIN
o	DENOTES STORM SEWER MANHOLE
M	DENOTES WATER VALVE
← \$	DENOTES POWER POLE AND GUY WIRE
훈	DENOTES LIGHT POLE
፟	DENOTES GAS VALVE
®	DENOTES MONITORING WELL
ST	DENOTES UNDERGROUND STORM SEWER
s	DENOTES UNDERGROUND SANITARY SEWER
	DENOTES UNDERGROUND WATER MAIN
	DENOTES UNDERGROUND GAS LINE
E	DENOTES UNDERGROUND ELECTRIC LINE
FIBER	DENOTES UNDERGROUND FIBER OPTIC LINE
OH U	DENOTES OVERHEAD ELECTRIC, PHONE, CABLE
× 999.9	DENOTES EXISTING GROUND ELEVATION
× 999.9	DENOTES EXISTING GUTTER LINE ELEVATION
203	DENOTES OVERHEAD UTILITY HEIGHT

DENOTES SET DRILL HOLF WITH PK NAIL LINLESS OTHERWISE NOTE

SURVEYOR'S CERTIFICATION

To O'Reilly Automotive Stores, Inc., Chicago Title Insurance Company, and Meridian Title: This is to certify that this map or plat and the survey on which it is based were made in accordance with the 2011 Minimum Standard Detail Requirements for ALTA/ACSM land Title Surveys, jointly established and adopted by ALTA and NSPS. The field work was completed on March 13, 2014.

Kve J. Roddy, W RLS 2907

REVISIONS




200 THIRD AVENUE NE, SUITE 100 CAMBRIDGE, MN 55008 (763)689-4042 PH. (763)689-6681 FAX

LAND SURVEYORS CIVIL ENGINEERS

PLANNERS SV1

PROJECT PHASE 1 SPECIAL NOTE:

EXISTING STORE, EXISTING STORE PARKING LOT, & SOUTHWEST EXISTING DRIVEWAY TO REMAIN IN OPERATION DURING DEMOLITION OF SHED AND CONSTRUCTION OF NEW

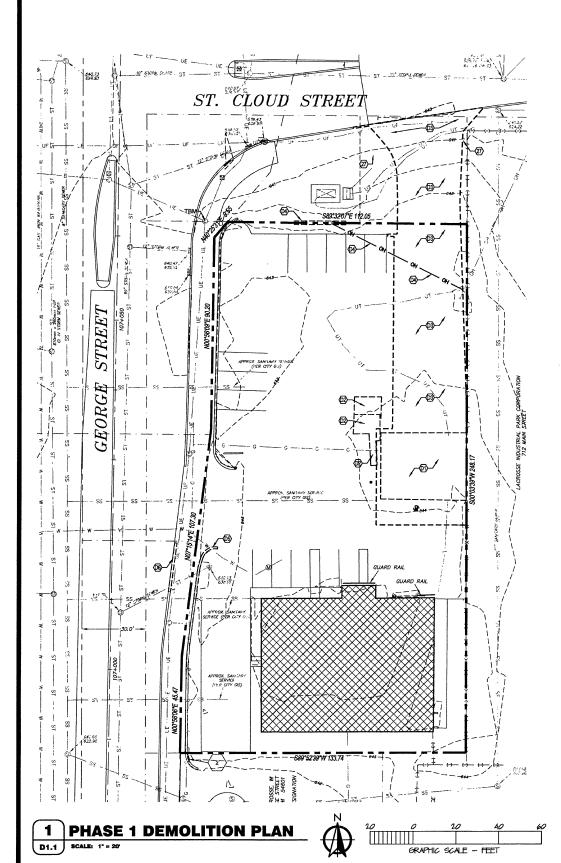

GENERAL NOTES:


- A. REFER TO PROJECT MANUAL FOR ADDITIONAL REQUIREMENTS.
- B. SITE CONDITIONS BASED UPON SURVEY SUBMITTED BY OWNER. FIELD VERIFY EXISTING CONDITIONS BY DETAILED SITE INSPECTION PRIOR TO SUBMITTING BID AND BEGINNING CONSTRUCTION.
- C. REMOVE ALL EXISTING SITE CONSTRUCTION AND DELETERIOUS MATERIALS UNLESS OTHERWISE NOTED.
- D. REFER TO SITE UTILITIES PLAN FOR DEMOLITION OF EXISTING UTILITIES.

KEY NOTES:

- EXISTING BUILDING:
 REMOVE EXISTING BUILDING.
- EXISTING DECK:
 REMOVE EXISTING DECK.
- EXISTING PAVEMENT: ALL EXISTING PAVEMENT NEEDS TO BE REMOVED IN THE AREA WHERE NEW CONSTRUCTION WILL BE PERFORMED.
- (D4) EXISTING SIGN:
 REMOVE EXISTING SIGN AND OVERHEAD POWERLINE TO SIGN.
- EXISTING RETAINING WALL:

 REMOVE EXISTING RETAINING WALL AND FILL WITH GRAVEL TO KEEP SITE
- EXISTING CURB:

 REMOVE EXISTING CURB AND REGRADE TO KEEP DRIVEWAY ACCESSIBLE.

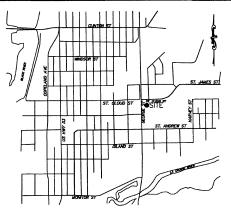



10180-16

CONSULTANTS:

PATRICK

PATRICK G. BLEES, ARCHITECT 800 WASHINGTON AVE. N. SUITE 208 MINNEAPOLIS, MN 55401 PHONE: (612) 547-1377 FAX: (612) 547-1301 CONTACT: TONY JOHNSON globhson@ragtch.com

ANDERSON ENGINEERING, INC. 2045 WEST WOODLAND SPRINGFIELD, MO 65619 PHONE: 417–866–2741 FAX: 417–866–2778

SGE, INC. 3855 S JEFFERSON AVE SPRINGFIELD, MO 65807 PHONE: 417-882-2200 FAX: 417-882-1188

SEAL:



PAUL ENGEL, CIVIL ENGINEER

11/11/16 DATE ISSUED 64877 REG. NO.



SHEET TITLE: PHASE 1 DEMOLITION PLAN

REVIS	REVISIONS:						
NO:	DATE:	BY:					
DDO IE	CT NO.	16115 014					

REFER TO SURVEY FOR EXISTING CONDITION SYMBOLS LEGEND

SYMBOLS LEGEND EXISTING ITEMS TO BE REMOVED

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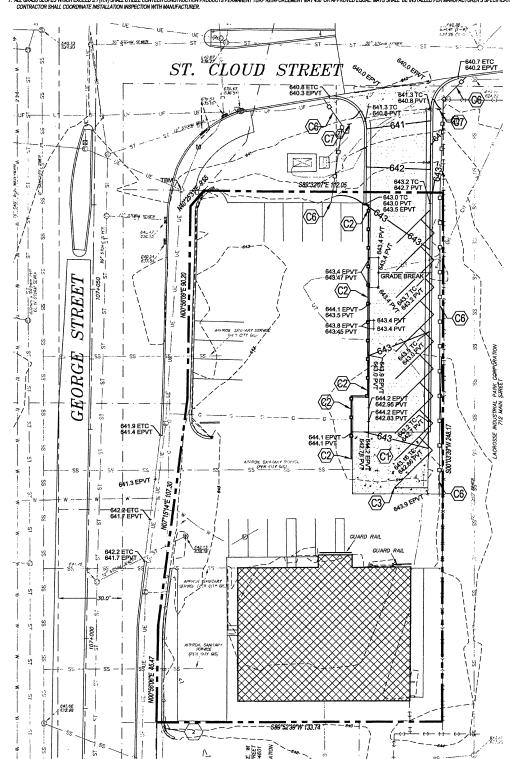
EROSION CONTROL & MAINTENANCE PLAN NOTES:

- I. RETAIN CATBLE WIND BLOWN MATERIALS ON STIE BY STORING ALL TRASH AND BUILDING MATERIAL WASTE IN PROCEED SIEPS UNTIL PROPER DISPOSAL AT OF-SITE FACILITIES. C. HICK ADJACENT AREAS DALY AND PICK UP CONSTRUCTION WASTE MATERIALS AND DEBRIS THAT HAVE BLOWN OR INASHED OF SITE.

 2. PERMINENTLY STABILEZ ALL SURFACE SHEAR WITHIN MAD AJACIENT TO THIS SITE THAT IS DISTURBED BY VEHICLES, GRADING AND OTHER CONSTRUCTION FOR THE PROPOSED FACILITY. STABILIZATION IS OBTAINED WHEN THE DISTURBED SURFACE IS COMPRED WITH STRUCTURES, SHAWNA AND OF REPERMINAL VEGETATION HAVING A UNIFORM COVERAGE DENSITY OF AT LEAST TWS. STABILIZATION OF ALD ISTURBED AREAS REQUIRES BEFORE TERMINATING MAINTENANCE AND REMOVAL OF EROSION CONTROL MEASURES. AND AND THAT THE CONSTRUCTION SHALL INSPECT POLLUTION CONTROL MEASURES AT LEAST ONCE EVERY? DAYS AND WITHIN 24 HOURS AFTER A STORM EVENT OF 1/2 INCH OR GREATER. DIAMAGED MEASURES THAT PROVE TO BE INSFFECTIVE SHALL BE REPLACED WITH MORE EFFECTIVE MEASURES OR ADDITIONAL MEASURES WITHIN SEVEN DAYS. REPEATED FAILURE OF A CONTROL MEASURE RECOURSE SISTALLATION OF A DIOTROL MEASURES SHALL AND ONE SUITABLE DEVICE TO PREVENT DISCHARGE OF POLLUTANTS FROM THE CONSTRUCTION SITE.

 4. INSTALLATION OF ADDITIONAL EROSON CONTROL MEASURES WITHIN SEVEN DAYS. REPEATED FAILURE OF A CONTROL MEASURE RECOURSE SISTALLATION OF ADDITIONAL PROVINCE OF THE PROPERTY OF THE CONTROL MEASURES AND ADDITIONAL PROVINCE OF THE PROPERTY OF THE CONTROL MEASURE SHALL AND ONE OF THE PROPERTY OF THE CONTROL MEASURES OR ADDITIONAL PROVINCE OF THE PROPERTY OF THE CONTROL MEASURES OR ADDITIONAL PROVINCE OF THE PROPERTY OF THE CONTROL MEASURES AND ADDITIONAL PROPERTY OF THE CONTROL MEASURES OR ADDITIONAL PROPERTY OF THE PROPERTY OF T

C1.1A SCALE: 1' = 20'



PROJECT PHASE 1 SPECIAL NOTE:

EXISTING STORE, EXISTING STORE PARKING LOT, & SOUTHWEST EXISTING DRIVEWAY TO REMAIN IN OPERATION DURING CONSTRUCTION OF NEW NORTH ACCESS.

SITE EXCAVATION **REQUIREMENTS:**

A GEOTECHNICAL ANALYSIS HAS BEEN PERFORMED ON THIS SITE. REFER TO PROJECT MANUAL
 FOLLOW GEOTECHNICAL ANALYSIS RECOMMENDATION FOR SITE EXCAVATION.

FLOOD ZONE:

ACCORDING TO FLOOD INSURANCE RATE MAP-COMMUNITY PANEL NUMBER 55063C0253D, THE SUBJECT PROPERTY IS LOCATED IN PLOOD ZONE AE, WHICH IS DEFINED AS AN AREA DETERMINED TO BE INSIDE THE 100-YEAR ANNUAL

VICINITY MAP



G. BLEES

PATRICK G. BLEES, ARCHITECT 800 WASHINGTON AVE. N. SUITE 208 MINNEAPOLIS, MN 554-01 PHONE: (612) 547-1377 FAX: (612) 547-1301 CONTACT: TONY JOHNSON globhson@march.com

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AST, INC. 7212 METRO BLVD. EDINA, MN 55439 PHONE: 952-854-9302 FAX: 952-854-9360

SGE, INC. 3855 S JEFFERSON AVE SPRINGFIELD, MO 65807 PHONE: 417-882-2200 FAX: 417-882-1188

SEAL:



PAUL ENGEL, CIVIL ENGINEER

11/11/16 DATE ISSUED

64877 REG. NO.

> **AUTO PARTS** © Reilly

SHEET TITLE: PHASE 1 SITE GRADING

REVISIONS: NO: DATE: PROJECT NO: 16115.014


DRAWN BY:

KEY NOTES:

INSTALL TEMPORARY ASPHALT PAVEMENT AT MOICATED AREA ON PLANS TO PROVIDE PROCEED FOR GRADING FOR TRAFFIC THROUGHOUT CONSTRUCTION OF PHASE 13. REPULGED WITH PERMANENT PAVEMENT PRIOR TO BEGINNING PHASE 3, REFER TO DETAIL 3CI

- (3) INSTALL TEMPORARY PAVEMENT MARKINGS AT 45° TO DRIVE.
- (C4) NOT USED. (C5) NOT USED.
- LIMITS OF TEMPORARY EROSION CONTROL FENCE: REFER TO DETAIL 3/C1.2.
- (CT) INSTALL "DO NOT ENTER" SIGN.

NOTE: PRIOR TO BEGINNING ANY SITE WORK & ORDERING LITH ITY & DRAINAGE CONNECTIONS TO EXISTING SYSTEMS BY POT HOLING AND SHALL NOTIFY ENGINEER OF NEEDED CHANGES: FAILURE TO DO SO WILL RESULT IN THE CONTRACTOR BEING RESPONSIBLE FOR ALL REVISION COSTS AND DELAYS.

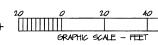

FIFI D VERIFY SANITARY SEWER CONNECTION INVERT PRIOR TO ESTABLISHING FINAL FINISH FLOOR ELEVATION. REFER TO SITE UTILITIES PLAN.

CONTRACTOR SHALL FIELD VERIFY PROPOSED GRADES MATCH EXISTING PAVEMENT AT DRIVEWAY ENTRANCES. CONTRACTOR SHALL NOTIFY ENGINEER IF DISCREPANCY




	SURFACE FLOW ARROW	-	TEMPORARY BENCHMARK: ELECTRIC MANHOLE RIM NEAR PROPERTY ELEVATION=641,13 (NAVD 88 DA	
	TEMPORARY EROSION CONTROL FENCE		EXISTING SIDEWALK FLOW LINE TOP OF BERM EMERGENCY OVERFLOW	FL TOP EOF
	PROPOSED NEW GRADE LINES	*643,061	EXISTING GRADE EXISTING PAVEMENT	PVT GD CONC ETC EGD EPVT ESW
643	EXISTING GRADE LINES		NEW SPOT ELEVATIONS LIST GRADE SIDEWALK TOP OF WALL TOP OF CURB	ABBREVIATION NONE SW TW TC

SYMBOLS LEGEND

REFER TO SURVEY (SV1) FOR EXISTING CONDITION SYMBOLS LEGEND AND SITE CONTROL

PROJECT PHASE 1 SPECIAL NOTE:

EXISTING STORE, EXISTING STORE PARKING LOT, & SOUTHWEST EXISTING DRIVEWAY TO REMAIN IN OPERATION DURING CONSTRUCTION OF NEW NORTH ACCESS.

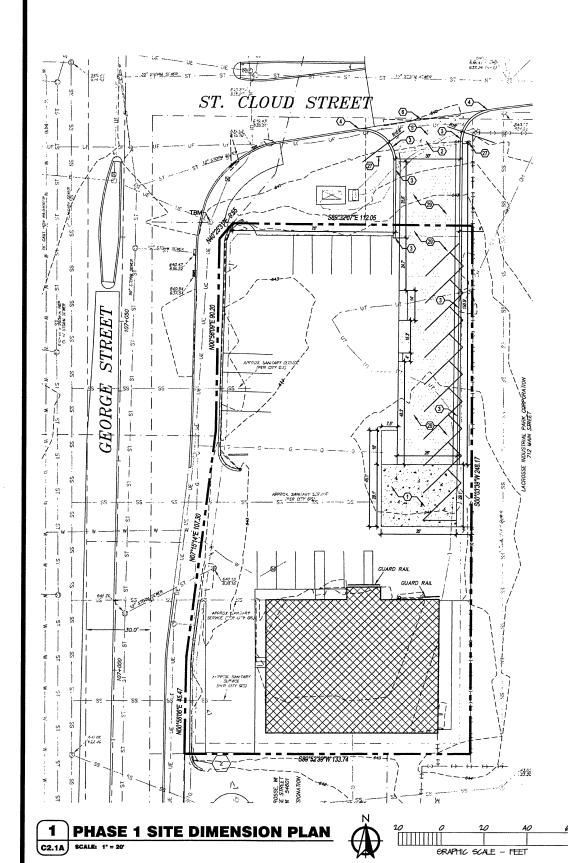

SITE EXCAVATION REQUIREMENTS:

FLOOD ZONE:


ACCORDING TO FLOOD INSURANCE RATE MAP-COMMUNITY PANEL NUMBER 5508502530, THE SUBJECT PROPERTY IS LOCATED IN FLOOD ZONE AE, WHICH IS DEFINED AS AN AREA DETERMINED TO BE INSIDE THE 100-YEAR ANNUAL CHANCE FLOODFLUIN.

GENERAL NOTES:

- B. ALL SITE DIMENSIONS TO THE GUTTER LINE OF CURB, CONCRETE OR PROPERTY LINE UNLESS OTHERWISE NOTED, CONTRACTOR TO FIELD VERIFY EXISTING CONDITIONS BY DETAILED INSPECTION PRIOR TO SUBMITTING BID AND STARTING CONSTRUCTION.
- C. COORDINATE WORK WITH OTHER SITE RELATED
- D. REFER TO STRUCTURAL PLANS FOR DEVELOPMENT OF SIDEWALKS ADJACENT TO FOUNDATIONS.
- E PRIOR TO INSTALLATION, GENERAL CONTRACTOR TO CONFIRM THAT LIGHT POLES, LANDSCAPING AND UTLITIES DO NOT CONFLICT WITH SIGN LOCATION SHOWN. IF ANY POTENTIAL CONFLICT IS DISCOVERED, GENERAL CONTRACTOR IS TO CONTACT OR

KEY NOTES:

- TEMPORARY ASPHULT PAVING:
 TEMPORARY ASPHULT PAVING AT INDICATED AREA ON PLANS TO PROVIDE PROPER GRADING FOR INFARCT HIROLOGICUIT CONSTRUCTION OF PHASE: 4.2. REPLACED WITH PERMANENT PAVEMENT PRIOR TO BEGINNING PHASE 3. REFER TO DETAIL SIGN.
- (2) CONCRETE PAVING (HEAVY DUTY):
 CONCRETE PAVING (HEAVY DUTY) AT DRIVE APRONS AND REFUSE AREA.
 REFER TO DETAIL 2/C2.2.
- (3) CONCRETE CURB: CONCRETE CURB, REFER TO DETAIL 3/C2.2.
- (4) ROW CONCRETE CURB:
 CONCRETE CURB IN RIGHT-OF-WAY TO MATCH EXISTING PER CITY AND / OR STATE DESIGN STANDARDS.
- CONCRETE DRIVE APRONE
 CONCRETE DRIVE APRON (HEAVY DUTY) TO BE INSTALLED
 PER CITY AND / OR STATE DESIGN STANDARDS. IF NO
 STANDARDS PROVIDE CONCRETE CONSTRUCTION PER
 DETAIL 2022.
- (6) LIMITS OF NEW PAVENENT:
 LIMITS OF NEW PAVING, MATCH EXISTING PAVEMENT TRANSITION ELEVATIONS.
- DO NOT ENTER SIGN TO BE USED WHILE TEMPORARY

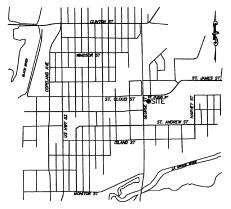

VICINITY MAP

ENGINEERING
EMPLOYEE OWNED
S. SURVEYORS. LADORATORIES DIRLING
SERVINGTELD, MISSOURI 68607. PHONE (477) 866-274
LOCAR SERVINGT. 10180-16 WB-110-7

PATRICK G. BLEES, ARCHITECT 800 WASHINGTON AVE. N. SUITE 208 MINNEAPOLIS, MN 55401 PHONE: (612) 547-1377 FAX: (612) 547-1301 CONTACT: TONY JOHNSON globhson@magrb.com

AST, INC. 7212 METRO BLVD. EDINA, MN 55439 PHONE: 952-854-9302 FAX: 952-854-9360

ANDERSON ENGINEERING, INC.

CONSULTANTS:

PATRICK

SGE, INC. 3855 S JEFFERSON AVE SPRINGFIELD, MO 65807 PHONE: 417-882-2200 FAX: 417-882-1188

SEAL:



PAUL ENGEL, CIVIL ENGINEER

11/11/16 DATE ISSUED 64877 REG. NO.



SHEET TITLE: PHASE 1 SITE DIMENSION PLAN

REVISIONS: NO: DATE: PROJECT NO: 16115.014

DRAWN BY:

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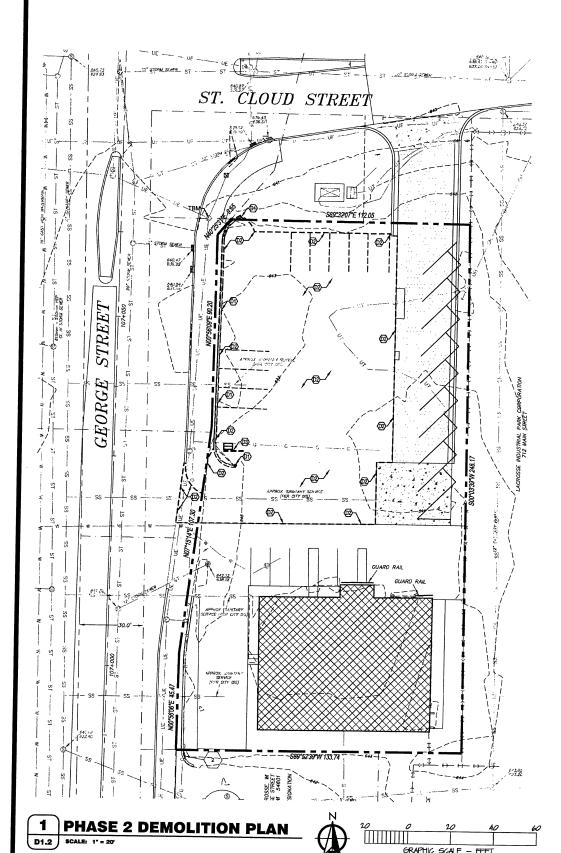


FXISTING BUILDING

SYMBOLS LEGEND

PROJECT PHASE 2 SPECIAL NOTE:

EXISTING STORE, NEW NORTHEAST DRIVEWAY & EXISTING SOUTHWEST DRIVEWAY TO REMAIN IN OPERATION DURING CONSTRUCTION OF NEW BUILDING.




GENERAL NOTES:

- A. REFER TO PROJECT MANUAL FOR ADDITIONAL REQUIREMENTS.
- B. SITE CONDITIONS BASED UPON SURVEY SUBMITTED BY OWNER. FIELD VERIFY EXISTING CONDITIONS BY DETAILED SITE INSPECTION PRIOR TO SUBMITTING BID AND BEGINNING CONSTRUCTION.
- C. REMOVE ALL EXISTING SITE CONSTRUCTION AND DELETERIOUS MATERIALS UNLESS OTHERWISE NOTED.
- D. REFER TO SITE UTILITIES PLAN FOR DEMOLITION OF EXISTING

KEY NOTES:

- D1) EXISTING BLOCK WALL:
 REMOVE EXISTING BLOCK WALL.
- EXISTING PAVEMENT:
 ALL EXISTING PAVEMENT NEEDS TO BE REMOVED IN THE AREA WHERE NEW
- EXISTING TELEPHONE:

 EXISTING TELEPHONE LINE TO BE RELOCATED TO CONTINUE TO SERVE BUSINESS DURING DEMOLITION OF SHED AND CONSTRUCTION OF NEW BUILDING.
- (DB) EXISTING CURB:
 REMOVE EXISTING CURB AND REGRADE TO KEEP DRIVEWAY ACCESSIB

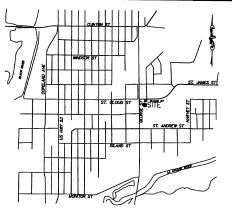

ENGINEERING
EMPLOYEE OWNED
S. SURVEYORS - LABORATORIES, DIRLLING
SERINGFIELD MISSOURI 68507, PHODE 177
FOR STRUCKEL PER 64477
FOR STRUCKE

ANDERSON ENGINEERING, INC. 2045 WEST WOODLAND SPRINGFIELD, MO 65619 PHONE: 417–866–2741 FAX: 417–866–2778 AST, INC. 7212 METRO BLVD. EDINA, MN 55439 PHONE: 952-854-9302 FAX: 952-854-9360

SGE, INC. 3855 S JEFFERSON AVE SPRINGFIELD, MO 65807 PHONE: 417-882-2200 FAX: 417-882-1188

CONSULTANTS:

SEAL:



PAUL ENGEL, CIVIL ENGINEER

11/11/16
DATE ISSUED 64877 REG. NO.

(C) Reilly

SHEET TITLE: PHASE 2 DEMOLITION PLAN

REVISIONS:

SYMBOLS LEGEND

REFER TO SURVEY FOR EXISTING CONDITION SYMBOLS LEGEND

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VICINITY MAP LA CROSSE, WI "NO SCALE"

EROSION CONTROL & MAINTENANCE PLAN NOTES:

- RETAIN FLOATABLE WIND BLOWN MATERIALS ON SITE BY STORING ALL TRASH AND BUILDING MATERIAL WASTE IN ENCLOSURES UNTIL PROPER DISPOSAL AT OFF-SITE FACILITIES. CHECK ADJACENT AREAS DAILY AND PICK UP CONSTRUCTION WASTE
- METRIALS AND DERRIS TRAT HAVE EVAN OR REASON OF STEE.

 METRIALS AND DERRIS TRAT HAVE EVAN OR REASON OF STEE.

 PERMANENTLY STABILIZE ALL SURFACE AREA WITHIN MAD ADJACENT TO THIS STEE THAT IS DISCREDE BY VEHICLE OF AT LEAST TOWN. A STABILIZATION OF ALL DISTURBED AREA IS REQUIRED BEFORE TERMINATION GMAINTENANCE AND REBOON OF AT LEAST TOWN. STABILIZATION OF ALL DISTURBED AREA IS REQUIRED BEFORE TERMINATION GMAINTENANCE AND REBOON OF THE CONTROL VEGETATION HAVING A UNIFORM COVERAGE DENOTY OF AT LEAST TOWN. STABILIZATION OF ALL DISTURBED AREA IS REQUIRED BEFORE TERMINATION GMAINTENANCE AND REBOON OF THE CONTROL VEGETATION HAVING AUDITENANCE AND REBOON OF THE CONTROL VEGETATION HAVING AUDITENANCE AND REBOON OF THE CONTROL VEGETATION HAVING AUDITENANCE AND REBOON OF THE CONTROL VEGETATION HAVE AND REBOON OF THE CONTROL VEGETATION HAVING AUDITENANCE AND REBOON OF THE CONTROL VEGETATION HAVING AUDITENANCE AND REBOON OF THE CONTROL VEGETATION HAVING AUDITENANCE OF THE CONTROL VEGETATION HAVE AND REBOON OF THE CONTROL VEGETATION HAVING AUDITENANCE OF THE CONTROL VEGETATION HAVE AND REBOON OF THE CONTROL VEGETATION HAVE AND RESOURCE DEFORE TERMINATION GAMEN AND REBOON OF THE CONTROL VEGETATION HAVE AND RESOURCE DEFORE TERMINATION OF THE CONTROL VEGETATION HAVE AND RESOURCE DEFORE TERMINATION OF THE CONTROL VEGETATION HAVE AND RESOURCE DEFORE TERMINATION OF THE CONTROL VEGETATION HAVE AND RESOURCE DEFORE TERMINATION OF THE CONTROL VEGETATION HAVE AND RESOURCE DEFORE TERMINATION OF THE CONTROL VEGETATION HAVE AND RESOURCE DEFORE TE

- COVERED WITH STRUCTURES, PAINE AND OR PERENNIAL RESERTATION HAWNE A UNIFORM COVERAGE DENSITY OF AT LEAST TOW. STABLIZATION OF ALL DISTURBED AREA IS REQUIRED BEFORE TERMINATING MAINTENANCE AND REMOVAL OF EROSION CONTROL MEASURES.


 3. CONTRACTORS SHALL IMSPECT POLITION CONTROL MEASURES AT LEAST ONCE EVERY T DAYS AND WITHIN 2H HOURS AFTER A STORM EVENT OF 12 INCH OR GREATER. DAMAGED MEASURES THAT PROVE TO BE INEFFECTIVE SHALL BE REPLACED WITH MORE PEFECTIVE MEASURES ROUTHOUN MEASURES THAT INSURED AND STABLED ON A POPE SUITABLE DEVICE TO PREVENT DISCHARGE OF POLILITATIS FROM THE CONSTRUCTION SITE.

 4. INSTALLATION OF ADDITIONAL EROSION CONTROL MEASURES MAY BE REQUIRED BY THE CITY OR STATE CONTRACTOR TO VERIFY REQUIREMENTS PRIOR TO BECOMINION ANY WORK ON PROJECT SITE.


 5. CARE SHALL BE TAKEN TO MINIMIZE THE ENCRACIMENT OF SEDIMENT INTO ALL STORM DRAIN APPURTENANCES, PUBLIC STREETS, AND ONTO PRIVATE PROPERTY UNTIL IMPERVIOUS MATERIAL (ROADIPARKING AREA SURFACE) IS APPLIED OR UNTIL PROPOSED LANDSCOPE HIS BETTE ESTRELISED.

 6. REFER TO 3CL 2 FOR SILT FENCE CONSTRUCTION.

 7. ALL GRASS SLOPES WINDER EXCELLED ST HAY SHALL UTILIZE CONTECCH CONSTRUCTION PRODUCTS PERMANENT TURF REINFORCEMENT MAT 450 OR APPROVED EQUAL MATS SHALL BE INSTALLED PER MANUFACTURER'S SPECIFICATIONS AND STANDARDS. CONTRACTORS WITH CONTRACTOR EXCELLED AS HAY SHALL DEVIAL TO THE MANUFACTURER'S SPECIFICATIONS AND STANDARDS.

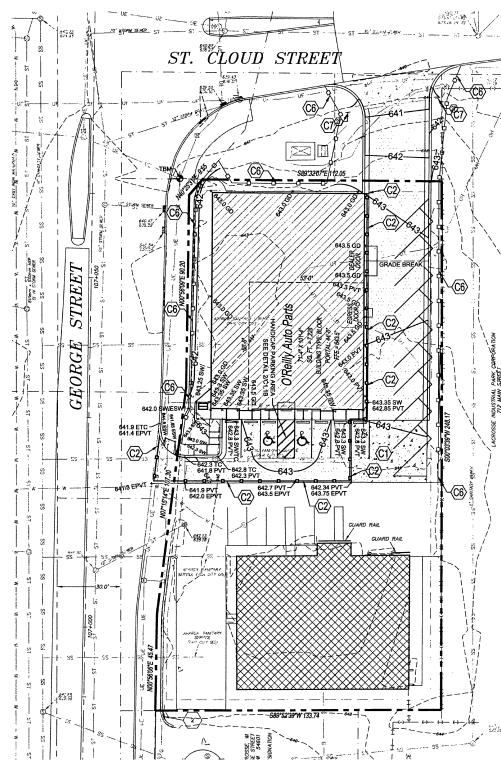

1 PHASE 2 SITE GRADING PLAN C1.1B SCALE: 1' = 20'

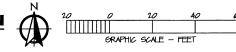

PROJECT PHASE 2 SPECIAL NOTE:


EXISTING STORE. NEW NORTHEAST DRIVEWAY & EXISTING SOUTHWEST DRIVEWAY TO REMAIN IN OPERATION DURING CONSTRUCTION OF NEW BUILDING. ONCE PHASE 2 CONSTRUCTION IS COMPLETE AND NEW BUILDING IS OPEN, REMOVE TEMPORARY PAVEMENT INDICATED BY KEYNOTE C1 AND APPLY PERMANENT PAVEMENT PER DETAIL 3/C1.1B DURING HOURS WHEN STORE IS CLOSED FOR BUSINESS.,

SITE EXCAVATION REQUIREMENTS:

- A GEOTECHNICAL ANALYSIS HAS BEEN PERFORMED ON THIS SITE REFER TO PROJECT MANUAL.
 FOLLOW GEOTECHNICAL ANALYSIS RECOMMENDATION FOR SITE EXCAVATOR.

FLOOD ZONE:

ACCORDING TO FLOOD INSURANCE RATE MAP-COMMUNITY PANEL NUMBER 55063C0253D, THE SUBJECT PROPERTY IS LOCATED IN FLOOD ZONE AE, WHICH IS DEFINED AS AN AREA DETERMINED TO BE INSIDE THE 100-YEAR ANNUAL

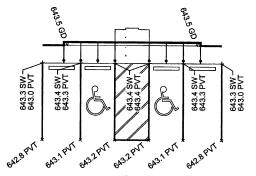

HANDICAP PARKING DETAIL C1.1B SCALE: 1" = 10'


KEY NOTES:

- INSTALL TEMPORARY ASPHALT PAVEMENT AT INDICATED AREA ON PLANS TO PROVIDE PROPER GRADING FOR TRAFFIC THROUGHOUT CONSTRUCTOR OF TRAFFIC THROUGHOUT CONSTRUCTOR OF THE PAVEMENT PRIOR TO BEGINNING PHASE 3, REFER TO PAVEMENT PRIOR TO BEGINNING PHASE 3, REFER TO
- (C2) INSTALL CAUTION FENCE ALONG PAVEMENT CUT.
- (C3) NOT USED.
- (CA) NOT USED.
- C5 NOT USED.
- C6 LIMITS OF TEMPORARY EROSION CONTROL FENCE:
- (C7) INSTALL "DO NOT ENTER" SIGN

NOTE: PRIOR TO BEGINNING ANY SITE WORK & ORDERING OF MATERIALS, CONTRACTOR SHALL FIELD VERIFY ALL LITH ITY & DRAINAGE CONNECTIONS TO EXISTING SYSTEMS BY POT HOLING AND SHALL NOTIFY ENGINEER OF NEEDED CHANGES: FAILURE TO DO SO WILL RESULT IN THE CONTRACTOR BEING RESPONSIBLE FOR ALL REVISION COSTS AND DELAYS.

FIELD VERIFY SANITARY SEWER CONNECTION INVERT PRIOR TO ESTABLISHING FINAL FINISH FLOOR ELEVATION. REFER TO SITE UTILITIES PLAN.

SPECIAL NOTE: CONTRACTOR SHALL FIELD VERIFY PROPOSED GRADES MATCH EXISTING PAVEMENT AT DRIVEWAY ENTRANCES CONTRACTOR SHALL NOTIFY ENGINEER IF DISCREPANC

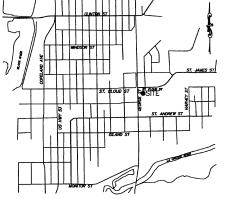



10180-16

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SEAL:



PAUL ENGEL, CIVIL ENGINEER

11/11/16 DATE ISSUED 64877 REG. NO.

> O GEORGE STREET CROSSE, WI 54603 AUTO © Reilly:

SHEET TITLE: PHASE 2 SITE GRADING PLAN

PROJECT NO:

DRAWN BY:

SYMBOLS LEGEND

3 REPLACEMENT OF TEMPORARY PAVEMENT

REFER TO SURVEY (SV1) FOR EXISTING CONDITION SYMBOLS LEGEND AND SITE CONTROL --643---EXISTING GRADE LINES ABBREVIATION
NONE
SW
TW
TC
PVT
GD
CONC
ETC
EGD
EPVT
ESW
FL
TOP
EOF **— 643** — PROPOSED NEW GRADE LINES NEW POLE SIGN LOCATION NEW CONCRETE PAVING BLOCK TEMPORARY EROSION CONTROL FENCE __ ELECTRIC MANHOLE RIM NEAR NW CORNER OF SUBJECT

SURFACE FLOW ARROW


C1.1B SCALE: 1' = 20'

LEVATION=641.13 (NAVID 88 DATUM)

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PROJECT PHASE 2 SPECIAL NOTE:

EXISTING STORE, NEW NORTHEAST DRIVEWAY & EXISTING SOUTHWEST DRIVEWAY TO REMAIN IN OPERATION DURING CONSTRUCTION OF NEW BUILDING.

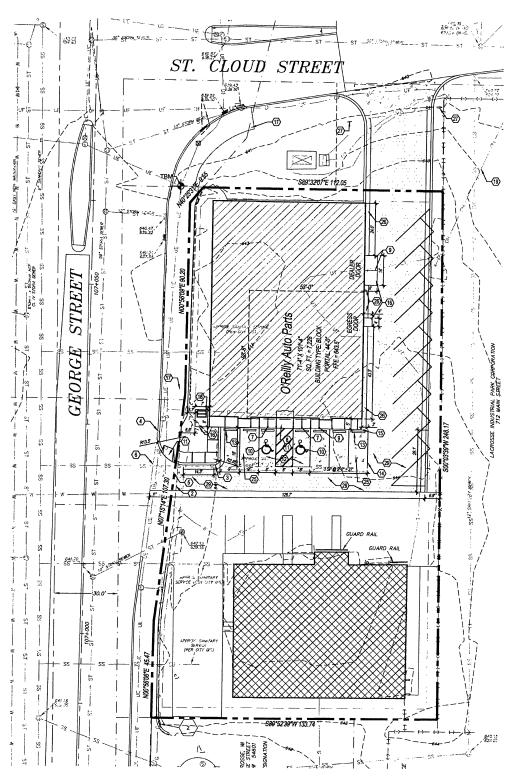

SITE EXCAVATION **REQUIREMENTS:**

- A GEOTECHNICAL ANALYSIS HAS BEEN PERFORMED ON THIS SITE. REFER TO PROJECT MANUAL.
 FOLLOW GEOTECHNICAL ANALYSIS RECOMMENDATION FOR SITE.

FLOOD ZONE:

ACCORDING TO FLOOD INSUFFANCE RATE MAP-COMMUNITY PANEL NUMBER 5505502530, THE SUBJECT PROPERTY IS LOCATED IN FLOOD ZONE AE, WHICH IS DEFINED AS AM AREA DETERMINED TO BE INSIDE THE 100-YEAR ANNUAL CHANCE FLOODFLAIN.

GENERAL NOTES:

- A. REFER TO PROJECT MANUAL FOR ADDITIONAL REQUIREMENTS.
- B. ALL SITE DIMENSIONS TO THE GUTTER LINE OF CURB, CONCRETE OR PROPERTY LINE UNLESS OTHERWISE NOTED, CONTRACTOR TO FIELD VERIFY EXISTING CONDITIONS BY DETAILED INSPECTION PRIOR TO SUBMITTING BID AND STARTING CONSTRUCTION.
- D. REFER TO STRUCTURAL PLANS FOR DEVELOPMENT OF SIDEWALKS ADJACENT TO FOUNDATIONS.
- E. PRIOR TO INSTALLATION, GENERAL CONTRACTOR TO CONFIRM THAT LIGHT POLES, LANDSCAPING AND UTILITIES DO NOT CONFLICT WITH SIGN LOCATION SHOWN. IF ANY POTENTIAL CONFLICT IS DISCOVERED, GENERAL CONTRACTOR REIO CONTRACTOR REI

KEY NOTES:

- 1 NOT USED
- CONCRETE PAVING (HEAVY DUTY):
 CONCRETE PAVING (HEAVY DUTY) AT DRIVE APRONS AND REFUSE
- (3) CONCRETE CURB: CONCRETE CURB, REFER TO DETAIL 3/C2.2.
- (4) ROW CONCRETE CURB:
 CONCRETE CURB IN RIGHT-OF-WAY TO MATCH EXISTING PER CITY AND / OR STATE DESIGN STANDARDS.
- CONCRETE DRIVE APROM TO BE INSTALLED PER CITY AND / OR STATE DESIGN STANDARDS. IF NO STANDARDS PROVIDE CONCRETE CONSTRUCTION PER DETAIL 20/22.2.
- (8) LIMITS OF NEW PAVEMENT:
 LIMITS OF NEW PAVING. MATCH EXISTING PAVEMENT TRANSITION ELEVATIONS.
- ACCESSIBLE PARKING SIGN:
 ACCESSIBLE PARKING SIGN, REFER TO DETAIL 8/C2.2.
- (8) DETECTABLE WARNING SURFACE:
 DETECTABLE WARNING SURFACE, REFER TO DETAIL 9/C2.2.
- STEEL BOLLARD:
 STEEL BOLLARD, REFER TO DETAIL 7/C2.2. PROVIDE (2)
 STEEL BOLLARD, REFER TO DETAIL 7/C2.2. PROVIDE (2)
 OF REFUSE CONTAINER AREA, (2) AT SECTIONAL
 OVERHEAD FREIGHT DOOR, AND (8) AT FRONT ENTRY,
 REFER TO STRUCTURAL DRAWINGS FOR LAYOUT OF
 BOLLARDS ADJACENT TO BUILDING PERIMETER.
- (10) ACCESSIBLE PARKING SYMBOL:
 ACCESSIBLE PARKING SYMBOL PAVEMENT STRIPING,
 REFER TO DETAIL 6/C2.2.
- ACCESSIBLE CONCRETE CURB RAMP:
 ACCESSIBLE CONCRETE CURB RAMP TO BE INSTALLED
 PER CITY AND / OR STATE DESIGN STANDARDS. IF NO
 STANDARDS PROVIDE CONCRETE CONSTRUCTION PER
 DETAIL. 10(C.2.2. 11

ACCESSIBLE PARKING SPACE:
ACCESSIBLE PARKING SPACE WITH ACCESS AISLE (ADA

- AULESSIBLE PARKING SPACE WITH ACCESS SISLE (ADA COMPLIANT) TO SLOPE 25' MAXIMUM IN ALL DIRECTIONS. PROVIDE PAVEMENT MARKINGS TO MATCH STRIPING COLOR UNLESS OTHERWISE REQUIRED TO COMPLY WITH GOVERNING ACCESSIBILITY DEGLI ILLITONS
- CONCRETE BUMPER BLOCK:
 CONCRETE BUMPER BLOCK (8" W X 5" H X 6"-0" LONG)
 ANCHORED TO PAVING WITH (2)1"-6" LONG #4 REBAR.
- PAVEMENT STRIPING:
 4* WIDE PAVEMENT STRIPING AS SHOWN USING HIGHWAY MARKING PAINT YELLOW (2 COATS).
- CONCRETE SIDEWALK CURB:
 CONCRETE SIDEWALK CURB, REFER TO DETAIL 4/C2.2.
 REFER TO STRUCTURAL DRAWNINGS FOR LAYOUT OF
 CONTROL AND EXPANSION JOINTS ADJACENT TO
 BUILDING PERIMETER.

- CONCRETE SIDEWALK/DOOR LANDING; CONCRETE SIDEWALK OR DOOR LANDING, REFER TO DETAIL 5/C22 AND STRUCTURAL DRAWINGS. LANDING MAY BE POURED MONOLITHIC WITH PAYING IF CONCRETE PAYING IS PROVIDED. CONNECT WITH EXG SIDEWALK CONSTRUCTION WHERE SHOWN.
- (17) EXG SIDEWALK: EXG SIDEWALK, PATCH/REPAIR/REPLACE AS NEEDED.
- BIKE RACK:
 BIKE RACK PER CITY REQUIREMENTS.
- (19) EXISTING OVERHEAD UTILITIES: EXG OVERHEAD UTILITY LINE & POLES TO REMAIN.
- 20 NOT USED
- 21 NOT USED
- 22 NOT USED
- 23 NOT USED 24 NOT USED
- (25) CONCRETE PAVEMENT (STANDARD DUTY):
 CONCRETE PAVEMENT (STANDARD DUTY) AT PARKING AREAS, REFER TO DETAIL 1/C2.2.
- CONCRETE PAVING APRON:
 CONCRETE PAVING APRON TO BE PROVIDED WHERE ASPHALT PAVEMENT USED. REFER TO DETAIL 11/C2.2
- DO NOT ENTER SIGN:
 DO NOT ENTER SIGN TO BE USED WHILE TEMPORARY PARKING IS IN USE.
- 28 NOT USED:
- ASPHALT PAVING (STANDARD DUTY): ASPHALT PAVING (STANDARD DUTY) AT DRIVE AREAS AND FIRE LANES.





VICINITY MAP LA CROSSE, WI "NO SCALE" 10 ANDERSON ENGINEERING IMPLOYEE OWNED Σmg

10180-16

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PATRICK

G. BLEES

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SEAL:



PAUL ENGEL, CIVIL ENGINEER

11/11/16 DATE ISSUED 64877 REG. NO.



SHEET TITLE: PHASE 2 SITE DIMENSION

PLAN

SYMBOLS LEGEND

EXISTING BUILDING

NEW BUILDING CONSTRUCTION


NEW CONCRETE PAVEMENT

NEW CONCRETE PAVING BLOCK

REVISIONS: NO: DATE: PROJECT NO: 16115.014 DRAWN BY:


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PROJECT PHASE 3 SPECIAL NOTE:

NEW STORE, NEW NORTHEAST DRIVEWAY & NEW PORTION OF SOUTHWEST DRIVEWAY TO REMAIN IN OPERATION DURING DEMOLITION OF OLD BUILDING AND PARKING LOT AND CONSTRUCTION OF NEW PARKING LOT.

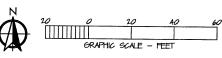


GENERAL NOTES:

- A. REFER TO PROJECT MANUAL FOR ADDITIONAL REQUIREMENTS.
- B. SITE CONDITIONS BASED UPON SURVEY SUBMITTED BY OWNER. FIELD VERRY EXISTING CONDITIONS BY DETAILED SITE INSPECTION PRIOR TO SUBMITTING BID AND BEGINNING CONSTRUCTION.
- C. REMOVE ALL EXISTING SITE CONSTRUCTION AND DELETERIOUS MATERIALS UNLESS OTHERWISE NOTED.
- D. REFER TO SITE UTILITIES PLAN FOR DEMOLITION OF EXISTING UTILITIES.

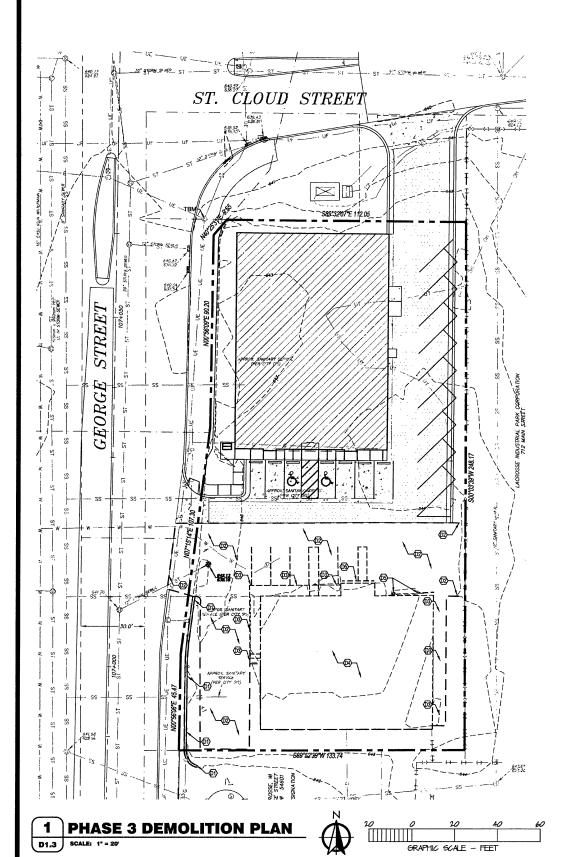KEY NOTES:

- EXISTING BLOCK WALL:
 REMOVE EXISTING BLOCK WALL
- EXISTING PAVEMENT: ALL EXISTING PAVEMENT NEEDS TO BE REMOVED IN THE AREA WHERE NEW CONSTRUCTION WILL BE PERFORMED.
- (D4) EXISTING BUILDING:
 REMOVE EXISTING BUILDING AND ALL UTILITIES TO BUILDING.
- (DS) EXISTING GUARD RAIL AND GUARDPOSTS;
 REMOVE EXISTING CURB AND REGRADE TO KEEP DRIVEWAY ACCESSIBLE.

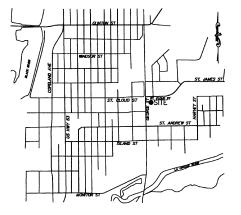





10180-16 cm: WB-110-713



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SEAL:



PAUL ENGEL. CIVIL ENGINEER

11/11/16 DATE ISSUED 64877 REG. NO.

> **AUTO PARTS** (C) Reilly ...

SHEET TITLE: PHASE 3 DEMOLITION PLAN

REVIS	REVISIONS:						
NO:	DATE:	BY:					
200 E	OT NO.	46115.01					

DRAWN BY:

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SYMBOLS LEGEND REFER TO SURVEY FOR EXISTING CONDITION SYMBOLS LEGEND EXISTING ITEMS TO BE REMOVED

EROSION CONTROL & MAINTENANCE PLAN NOTES:

- 1. RETAIN FLOATABLE WIND BLOWN MATERIALS ON SITE BY STORING ALL TRASH AND BUILDING MATERIAL WASTE IN ENCLOSURES UNTIL PROPER DISPOSAL AT OFF-SITE FACILITIES. CHECK ADJACENT AREAS DAILY AND PICK UP CONSTRUCTION WASTE MATERIALS AND DERBIS THAT HAVE BY OWN OR WASHET) OFF SITE
- CUNING MEASURES.

 3. CONTRACTORS SHALL INSPECT POLLUTION CONTROL MEASURES AT LEAST ONCE EVERY 7 DAYS AND WITHIN 24 HOURS AFTER A STORM EVENT OF 1/2 INCH OR GREATER. DAMAGED MEASURES THAT PROVE TO BE INEFFECTIVE SHALL BE REPLACED WITH MORE EFFECTIVE MEASURES OR ADDITIONAL MEASURES WITHIN SEVEN DAYS. REPEATED FAILURE OF A CONTROL MEASURE REQUIRES INSTALLATION OF A MORE SUITABLE DEVICE TO PREVENT DISCHARGE OF POLLUTANTS FROM THE CONSTRUCTION SITE.


 4. INSTALLATION OF ADDITIONAL EROSION CONTROL MEASURES MAY BE REQUIRED BY THE CITY OR STATE. CONTRACTOR TO VERIFY REQUIREMENTS PRIOR TO BEGINNING ANY WORK ON PROJECT SITE.
- 4. INSTITUTION OF PUDIT TANDE, ENCOUNT OF THE OUT TOWN TO RECORDED IT THE CUST OWN TO PUBLIC OWN TO PUBLIC ANY TOWN, CHE PROCESS THE CHECK OF THE OWN TOWN TO PUBLIC STREETS, AND ONTO PRIVATE PROPERTY UNTIL IMPERVIOUS MATERIAL, ROADPARKING AREA SURFACE) IS APPLIED OR UNTIL PROPOSED LANGUAGE HAS DEED STANDARD.

 6. REPERT TO SOLE FOR SULF TENDE CONSTRUCTION

 6. REPERT TO SOLE FOR SULF TENDE CONSTRUCTION

 7. ALL GRASS SLOPES WHICH EXCELD 31 (HIV) SHALL UTILIZE CONTECT CONSTRUCTION PRODUCTS PERMANENT TURF REINFORCEMENT MAT 450 OR APPROVED EQUAL MATS SHALL BE INSTALLED PER MANUFACTURERS SPECIFICATIONS AND STANDARDS.

 CONTRACTORS SHALL CORDINAND INSTITUTION RESPONDENT HITM HANDFACTURERS.

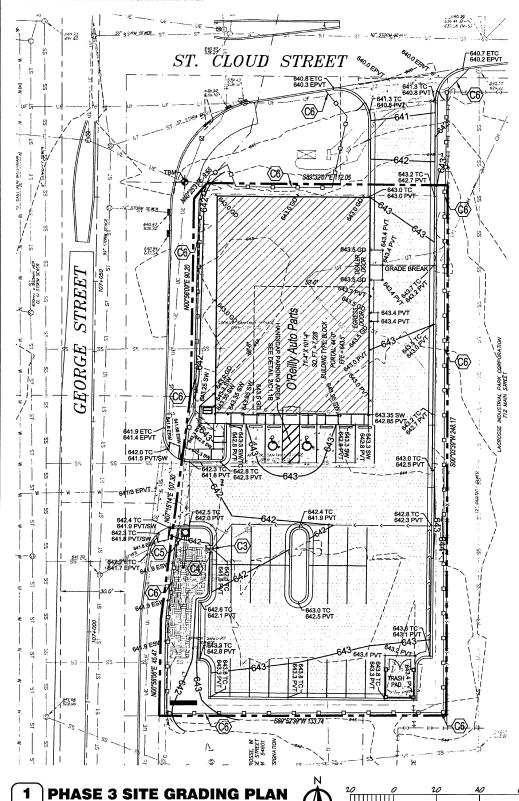

PROJECT PHASE 3 SPECIAL NOTE:

NEW STORE. NEW NORTHEAST DRIVEWAY & NEW PORTION OF SOUTHWEST DRIVEWAY TO REMAIN IN OPERATION DURING DEMOLITION OF OLD BUILDING AND PARKING LOT AND CONSTRUCTION OF NEW PARKING LOT. CONSTRUCTION IS FINISHED, REMOVE TEMPORARY STRIPING AMD "DO NOT ENTER" SIGNS.

SITE EXCAVATION REQUIREMENTS:

- A GEOTECHNICAL ANALYSIS HAS BEEN PERFORMED ON THIS SITE. REFER TO PROJECT MANUAL
 FOLLOW GEOTECHNICAL ANALYSIS RECOMMENDATION FOR SITE EXCAVATION.

FLOOD ZONE:

ACCORDING TO FLOOD INSURANCE RATE MAP-COMMUNITY PANEL NUMBER 55063C0253D, THE SUBJECT PROPERTY IS LOCATED IN FLOOD ZONE AE, WHICH IS DEFINED AS AN AREA DETERMINED TO BE INSIDE THE 100-YEAR ANNUAL CHANCE FLOODPLAIN.

PIPES NOTES:

- PIPE MATERIALS SHALL BE IN ACCORDANCE WITH AND AS APPROVED BY THE CITY OR APPLICABLE AUTHORITY, PVC PIPE MAY BE USED AS ALLOWED BY LOCAL
- GUIDELINES.
 2. ALL PIPE IS TO BE INSTALLED PER THE MANUFACTURER'S REQUIREMENTS AND MEET COVER REQUIREMENTS PER THE MANUFACTURER.

KEY NOTES:

- INSTALL 4' X 4' MANHOLE. CONNECT TO EXISTING STORMPIPE AND STORMPIPE C7.

NOTE: PRIOR TO BEGINNING ANY SITE WORK & ORDERING OF MATERIALS, CONTRACTOR SHALL FIELD VERIFY ALL UTILITY & DRAINAGE CONNECTIONS TO EXISTING SYSTEMS BY POT HOLING AND SHALL NOTIFY ENGINEER OF NEEDED CHANGES: FAILURE TO DO SO WILL RESULT IN THE CONTRACTOR BEING RESPONSIBLE FOR ALL REVISION COSTS AND DELAYS.

FIELD VERIFY SANITARY SEWER CONNECTION INVERT PRIOR TO ESTABLISHING FINAL FINISH FLOOR ELEVATION. REFER TO SITE UTILITIES PLAN.

MATCH EXISTING PAVEMENT AT DRIVEWAY ENTRANCES. CONTRACTOR SHALL NOTIFY ENGINEER IF DISCREPANCY OCCURS.



SEE PLAN FOR RIPRAP PAD WIDTH AND LENGTH

SECTION AT CURB CUT

SYMBOLS LEGEND

REFER TO SURVEY (SV1) FOR EXISTING CONDITION SYMBOLS LEGEND AND SITE CONTROL.

PILM SPOT ELEVATIONS
LIST
GRADE
GRADE
TOP OF WALL
TOP OF WALL
TOP OF CURB
TOP OF CURB
TOP OF CURB
EXISTING TOP OF CURB
EXISTING TOP OF CURB
EXISTING FRADE
EXISTING SIDEWALK
FLOW LINE
TOP OF BERM
TOP OF BERM

ELECTRIC MANHOLE RIM NEAR NW CORNER OF SUBJECT PROPERTY

CURB CUT WITH RIPRAP PAD

C1.1C SCALE: NOT TO SCALE

EXISTING GRADE LINES

NEW BUILDING CONSTRUCTION

PROPOSED NEW GRADE LINES

NEW CONCRETE PAVING BLOCK

TEMPORARY EROSION CONTROL FENCE

--643--

---- 643 ----

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ANDERSON ENGINEERING, INC. 2045 WEST WOODLAND SPRINGFIELD, MO 65619 PHONE: 417–866–2741 FAX: 417–866–2778 AST, INC. 7212 METRO BLVD. EDINA, MN 55439 PHONE: 952-854-9302 FAX: 952-854-9360

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SEAL:



PAUL ENGEL, CIVIL ENGINEER

11/11/16 DATE ISSUED 64877 REG. NO.



SHEET TITLE: PHASE 3 SITE GRADING PLAN

REVISIONS: DATE:

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(C1) NOT USED

- C2 NOT USED
- (C3) INSTALL 3' CURB CUT WITH RIPRAP PAD. REFER TO DETAIL 2/C1.1C
- (A) INSTALL BIOFILTRATION SYSTEM.
 REFER TO DETAIL 2/C1.2.
- STORMPIPE AND STORMS.


 RIM = 642.0' INV = 638.1'

 REFER TO DETAIL 4/C1.2.
- (G) LIMITS OF TEMPORARY EROSION CONTROL FENCE: REFER TO DETAIL 3/C1.2.
- (CT) INSTALL 4'90 OVERFLOW STRUCTURE AND UNDERDRAIN. REFER TO DETAIL 2/C1.2.

SPECIAL NOTE: CONTRACTOR SHALL FIELD VERIFY PROPOSED GRADES

PROJECT PHASE 3 SPECIAL NOTE:

NEW STORE, NEW NORTHEAST DRIVEWAY & NEW PORTION OF SOUTHWEST DRIVEWAY TO REMAIN IN OPERATION DURING DEMOLITION OF OLD BUILDING AND PARKING LOT AND CONSTRUCTION OF NEW PARKING LOT.

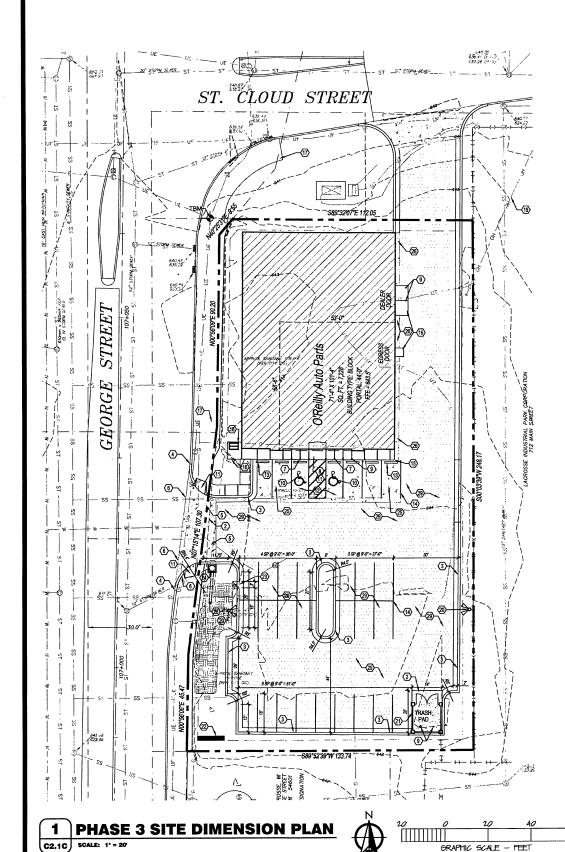

KEY NOTES:

- 1 NOT USED:
- (2) CONCRETE PAVING (HEAVY DUTY):
 CONCRETE PAVING (HEAVY DUTY) AT DRIVE APRONS AND REFUSE AREA. REFER TO DETAIL 2/C2.2.
- (3) CONCRETE CURB: CONCRETE CURB, REFER TO DETAIL 3/C2.2.
- ROW CONCRETE CURB:
 CONCRETE CURB IN RIGHT-OF-WAY TO MATCH EXISTING

- CONCRETE DRIVE APRONT OD BE INSTALLED PER CITY AND / OR STATE DESIGN STANDARDS. IF NO STANDARDS PROVIDE CONCRETE CONSTRUCTION PER DETAIL 2/C2.2.
- (6) LIMITS OF NEW PAVEMENT:
 LIMITS OF NEW PAVING, MATCH EXISTING PAVEMENT TRANSITION ELEVATIONS.
- 7) ACCESSIBLE PARKING SIGN:
 ACCESSIBLE PARKING SIGN, REFER TO DETAIL 8/C2.2.
- (8) DETECTABLE WARNING SURFACE:
 DETECTABLE WARNING SURFACE, REFER TO DETAIL 9/C2.2.

- STER BOLLARD:
 STEEL BOLLARD, REFER TO DETAIL 7/C2.2, PROVIDE (2)
 AT REFUSE CONTAINER AREA, (2) AT SECTIONAL
 OVERHEAD FREIGHT DOOR, AND (8) AT FRONT ENTRY.
 REFER TO STRUCTURAL DRAWINGS FOR LAYOUT OF
 BOLLARDS ADJACENT TO BUILDING PERIMETER.
- (10) ACCESSIBLE PARKING SYMBOL:
 ACCESSIBLE PARKING SYMBOL PAVEMENT STRIPING,
 REFER TO DETAIL 6/C2.2.

ACCESSIBLE CONCRETE CURB RAMP:
ACCESSIBLE CONCRETE CURB RAMP TO BE INSTALLED PER CITY AND / OR STATE DESIGN STANDARDS. IF NO STANDARDS PROVIDE CONCRETE CONSTRUCTION PER DETAIL 10/C2.2.

- ACCESSIBLE PARKING SPACE:
 ACCESSIBLE PARKING SPACE WITH ACCESS AISLE (ADA COMPILANT) TO SLOPE 2% MAXIMUM IN ALL DIRECTIONS. PROVIDE PAVEMENT MARKINGS TO MATCH STRIPING COLOR UNLESS OF HERWISE REQUIRED TO COMIFY WITH GOVERNING ACCESSIBILITY REGULATION.
- (13) CONCRETE BUMPER BLOCK:
 CONCRETE BUMPER BLOCK (8" W X 5" H X 6"-0" LONG)

14) PAVEMENT STRIPING:
4* WIDE PAVEMENT STRIPING AS SHOWN USING HIGHWAY MARKING PAINT - YELLOW (2 COATS).

CONCRETE SIDEMALK CURB:
CONCRETE SIDEMALK CURB, REFER TO DETAIL 4/C2.2.
REFER TO STRUCTURAL DRAWINGS FOR LAYOUT OF
CONTROL AND EXPANSION JOINTS ADJACENT TO
BUILDING PERIMETER.

- CONCRETE SIDEWALK DOOR LANDING:
 CONCRETE SIDEWALK OR DOOR LANDING, REFER TO
 DETAIL SC22 AND STRUCTURAL DRAWINGS. LANDING
 MAY BE POURED MONOLITHIC WITH PAVING IF
 CONCRETE PAVING IS PROVIDED. CONNECT WITH EXG
 SIDEWALK CONSTRUCTION WHERE SHOWN.
- (17) EXG SIDEWALK: EXG SIDEWALK. PATCH/REPAIR/REPLACE AS NEEDED.
- BIKE RACK PER CITY REQUIREMENTS.
- (19) EXISTING OVERHEAD UTILITIES: EXG OVERHEAD UTILITY LINE & POLES TO REMAIN.
- (20) PARKING LOT LIGHTING:
 PARKING LOT LIGHTING, REFER TO SITE UTILITY PLAN FOR TYPE AND CONSTRUCTION.
- (21) REFUSE ENCLOSURE, REFER TO 1/C2.3.


- STE SIGN, REFER TO SHEET SG1.2 FOR TYPE AND CONSTRUCTION. SIGN OWNER FURNISHED AND INSTALLED (REFER TO SCOPE OF WORK SCHEDULE). REFER TO SITE UTILITY PLAN FOR ADDITIONAL DECUMED REFER TO STE UTILITY PLAN FOR ADDITIONAL DECUMED REFER TO
- 23) CURB CUT: REFER TO PLAN SHEET C1.1C FOR CURB CUT SPECIFICATIONS.

STORMMATER MANHOLE:
4'X4' MANHOLE. REFER TO PLAN SHEET C1.1C FOR MANHOLE SPECIFICATIONS.

CONCRETE PAVEMENT (STANDARD DUTY): CONCRETE PAVEMENT (STANDARD DUTY) AT STOREFRONT PARKING AREA, REFER TO DETAIL 1/C2.2.

CONCRETE PAVING APRON: CONCRETE PAVING APRON TO BE PROVIDED WHERE ASPHALT PAVEMENT USED. REFER TO DETAIL 11/C2.2.

- 27) NOT USED:
- BIOFILTRATION SYSTEM: STORMWATER BIOFILTRATION SYSTEM TO BE INSTALLED. REFER TO PLAN SHEET C1.2 FOR DESIGN.
- ASPHALT PAVING (STANDARD DUTY):
 ASPHALT PAVING (STANDARD DUTY) AT DRIVE AREAS AND FIRE LANES
 DEFEND TO DETAIL ADDRAY

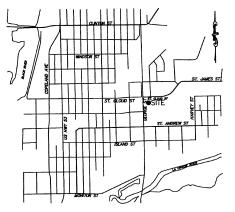

VICINITY MAP



SYMBOLS LEGEND

REFER TO SURVEY FOR EXISTING CONDITION SYMBOLS LEGEND

NEW BUILDING CONSTRUCTION

NEW ASPHALT PAVEMENT

NEW CONCRETE PAVING BLOCK

NEW LIGHT POLE LOCATION

NEW FENCE CONSTRUCTION

AGINEERING LOYEE OWNED 10180-16 WB-110-7

CONSULTANTS:

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SGE, INC. 3855 S JEFFERSON AVE SPRINGFIELD, MO 65807 PHONE: 417–882–2200 FAX: 417–882–1188

SEAL:



PAUL ENGEL, CIVIL ENGINEER

11/11/16 DATE ISSUED REG. NO.



SHEET TITLE: PHASE 3 SITE DIMENSION PLAN

PROJECT NO: DRAWN BY:

SITE EXCAVATION **REQUIREMENTS:**

- A GEOTECHNICAL ANALYSIS HAS BEEN PERFORMED ON THIS SITE. REFER TO PROJECT MANUAL.
 FOLLOW GEOTECHNICAL ANALYSIS RECOMMENDATION FOR SITE EXCAVATION.

FLOOD ZONE:

ACCORDING TO FLOOD INSURANCE RATE MAP-COMMUNITY PANEL NUMBER 5506502530. THE SUBJECT PROPERTY IS LOCATED IN FLOOD ZONE AE, WHICH IS DEFINED AS AN AREA DETERMINED TO BE INSIDE THE 100-YEAR ANNUAL CHANCE FLOODPLAIN.


GENERAL NOTES:

- C. COORDINATE WORK WITH OTHER SITE RELATED DEVELOPMENT DRAWINGS.
- D. REFER TO STRUCTURAL PLANS FOR DEVELOPMENT OF SIDEWALKS ADJACENT TO FOUNDATIONS.
- E. PRIOR TO INSTALLATION, GENERAL CONTRACTOR TO COMFIRM THAT LIGHT POLES, LANDSCAPING AND UTILITIES DO NOT CONFLICT WITH SIGN LOCATION SHOWN. IF ANY POTENTIAL COMPLICT IS DISCOVERED GENERAL CONTRACTOR IS TO CONTACT O

EROSION CONTROL & MAINTENANCE PLAN NOTES:

- 1. RETAIN FLOATABLE WIND BLOWN MATERIALS ON SITE BY STORING ALL TRASH AND BUILDING MATERIAL WASTE IN ENCLOSURES UNTIL PROPER DISPOSAL AT OFF-SITE FACILITIES. CHECK ADJACENT AREAS DAILY AND PICK UP CONSTRUCTION WASTE MATERIALS AND DEBUS THAT HAVE BLOWN OR WASHED OFF-SITE.
- INVINITIES AND LICENSI THE INVESTIGATION OF REPORT OF THE PROPOSED FACILITY. STABILIZATION IS OBTAINED WHEN THE DISTURBED BY VEHICLES, GRADING AND OTHER CONSTRUCTION FOR THE PROPOSED FACILITY. STABILIZATION IS OBTAINED WHEN THE DISTURBED SURFACE IS COVERED WITH STRUCTURES, PAVING AND OR PERENNIAL VEGETATION HAVING A UNIFORM COVERAGE DENSITY OF AT LEAST 70%. STABILIZATION OF ALL DISTURBED AREA IS REQUIRED BEFORE TERMINATING MAINTENANCE AND REMOVAL OF EROSIO
- CONTINUE MERGORICO.

 2. CONTRACTINGS SHALL INSPECT POLITION CONTROL MEASURES AT LEAST ONCE EVERY 7 DAYS AND WITHIN 24 HOURS AFTER A STORM EVENT OF 1/2 INCH OR CREATER. DAMAGED MEASURES THAT PROVE TO RE INFEFECTIVE SHALL RE BEPLACED.
- I. INSTALLATION OF ADDITIONAL EROSION CONTROL MEASURES MAY BE REQUIRED BY THE CITY OR STATE. CONTRACTOR TO VERIFY REQUIREMENTS PRIOR TO BEGINNING ANY WORK ON PROJECT SITE.

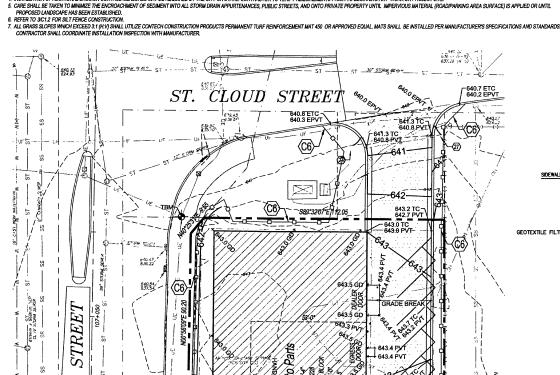

STORM WATER RUNOFF SUMMARY:

SCS TYPE II, 24-HR STORM

DO NOT EXCEED EXISTING

CONDITIONS SO NO DETENTION IS

DEPTH 1YR 2YR 5YR 10 YR 25 YR
INCHES 2.59 2.99 3.72 4.41 5.49

TOTAL PROPERTY AREA = 0.71 ACRES
TOTAL DISTURBED AREA = 0.71 ACRES < 1.0 ACRES THEREFORE NO DNR SUBMITTAL IS REQUIRED.
METHOD USED = SCS, HYDROLOGIC SOIL, GROUP A (INFILITATION RATE = 3.6 IN/HR)


1. ON-SITE AREA & RUNOFF COEFFICIENTS: 3. PRECIPITATION DATA.
DESIGN PROJECT AREA = 0.71 ACRES
SCS_TYPE IL 24-HR STORM

PRE-DEVELOPMENT EXISTING GRASS LOT PERVIOUS AREA = 0.07 ACRES (CN = 30) IMPERVIOUS AREA 0.64 ACRES (CN = 98) COMPOSITE CURVE NUMBER, CN = 91

COMPOSITE CURVE NUMBER, CN = 91
POST-DEVELOPMENT
DEVELOPED GRASS GOOD CONDITION
PERVIOUS AREA = 0.13 ACRES CN = 90
NEW ROOF, CONCRETE & NEW PAUNG:
IMPERVIOUS AREA = 0.58 ACRES CN = 9
COMPOSITE CURVE NUMBER, CN = 88 THE DEVELOPED 1, 2, 5, 10 AND 25-YR STORM EVENT DISCHARGES

PRE-DEVELOPMENT Tc= 5 MIN POST-DEVELOPMENT

THE 1, 2, 5, 10 AND 25-YR STORM
EVENTS WILL BE RESTRICTED
BELOW EXISTING CONDITIONS PER
CITY OF LACROSSE REQUIREMENTS.

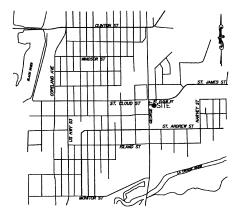

RSON REING 山田₹ ANDE GINEE **Σ** 10180-16

PATRICK

G. BLEES

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PAUL J. ENGEL 38234-006

PAUL ENGEL, CIVIL ENGINEER

11/11/16

64877

10 GEORGE STREET CROSSE, WI 54603

~ ₹

STORMWATER MANAGEMENT

DATE ISSUED

= AUTO PARTS

(

SHEET TITLE:

REVISIONS:

PROJECT NO:

DATE:

PLAN

SEAL:

CONSULTANTS:

FLOOD ZONE:

ACCORDING TO FLOOD INSURANCE RATE MAP-COMMUNITY PANEL NUMBER 500830253D, THE SUBJECT PROPERTY IS LOCATED IN FLOOD ZONE AE, WHICH IS DEFINED AS AN AREA DETERMINED TO BE INSIDE THE 100-YEAR ANNUAL CHANCE FLOODPLAIN.

PIPES NOTES:

- PIPE MATERIALS SHALL BE IN ACCORDANCE WITH AND AS APPROVED BY THE CITY
 OR APPLICABLE AUTHORITY. PVC PIPE MAY BE USED AS ALLOWED BY LOCAL
- GUIDELINES.
 2. ALL PIPE IS TO BE INSTALLED PER THE MANUFACTURER'S REQUIREMENTS AND MEET COVER REQUIREMENTS PER THE MANUFACTURER.

-8" NYLOPLAST OVERFLOW STRUCTURE -6" PONDING DEPTH SIDEWALK EL=641.90' /2:1 SLOPE 2:1 SLOPE PONDING SURFACE EL=641.6 GEOTEXTILE FILTER FABRIC. PEA GRAVE WASHED SAND 4" PVC (SCH 40) UNDER DRAIN WRAPPED IN GEO-FABRIC WITH TWO ROWS OF \$\frac{1}{2}" HOLES DRILLED AT BOTTOM QUARTER POINTS 2" O.C. GEOTEXTILE LINER WITH 40 OPENINGS PER INCH.

JIES: SOIL MEDIA IS NOT TO BE ADDED TO BIORETENTION AREA UNTIL SITE IS STABILIZED. MATERIALS PER WISCONSIN DNR STANDARDS.


BIOFILTRATION TYPICAL SECTION C1.2 SCALE: NOT TO SCALE

KEY NOTES:


- (C1) NOT USED
- (C2) NOT USED

GRAPHIC SCALE - FEET

- (C3) INSTALL 3' CURB CUT WITH RIPRAP PAD. REFER TO DETAIL 2/C1.1C
- INSTALL BIOFILTRATION SYSTEM.
 REFER TO DETAIL 2IC1.2.
- INSTALL 4" X 4" MANHOLE. CONNECT TO EXISTING
 STORMPIPE AND STORMPIPE CT.
 RIM = 642.0" INV = 638.1"
 REFER TO DETAIL 4/C1.2.
- (T) INSTALL 4'Ø OVERFLOW STRUCTURE AND UNDERDRAIN. REFER TO DETAIL 2/C1.2.

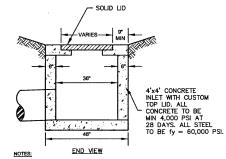

4 4' X 4' MANHOLE SCALE: NOT TO SCALE

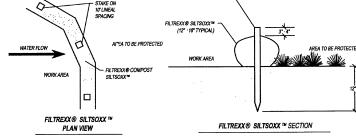

2"x2" WOODEN STAK

- 1. ALL MATERIAL TO MEET FILTREXX® SPECIFICATIONS OR APPROVED EQUAL.
 2. SILTSOXX™ COMPOSTIJISOIL/ROCK/SEED FILL TO MEET APPLICATION REQUIREMENTS.
 3. SILTSOXX™ DEPICTED IS FOR MINIMUM SLOPES. GREATER SLOPES MAY REQUIRE LARGER SOCKS PER THE
- MANUFACTURER SPECIFICATIONS.


COMPOST MATERIAL TO BE DISPERSED ON SITE, AS DETERMINED BY ENGINEER.

3 FILTREXX SILTSOXX™ C1.2 SCALE: NOT TO SCALE



NOTE: PRIOR TO REGINNING ANY SITE WORK & ORDERING OF MATERIALS, CONTRACTOR SHALL FIELD VERIFY ALL JTILITY & DRAINAGE CONNECTIONS TO EXISTING SYSTEMS Y POT HOLING AND SHALL NOTIFY ENGINEER OF NEEDED CHANGES: FAILURE TO DO SO WILL RESULT IN THE CONTRACTOR BEING RESPONSIBLE FOR ALL REVISION COSTS AND DELAYS. .




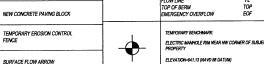


ABBREVIATION NONE

16115.014

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1 STORMWATER MANAGEMENT PLAN

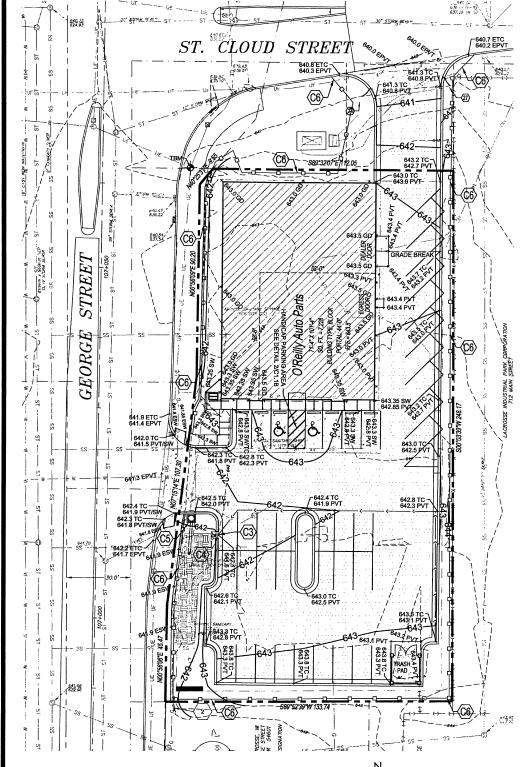

C2.2 SCALE: N.T.S.

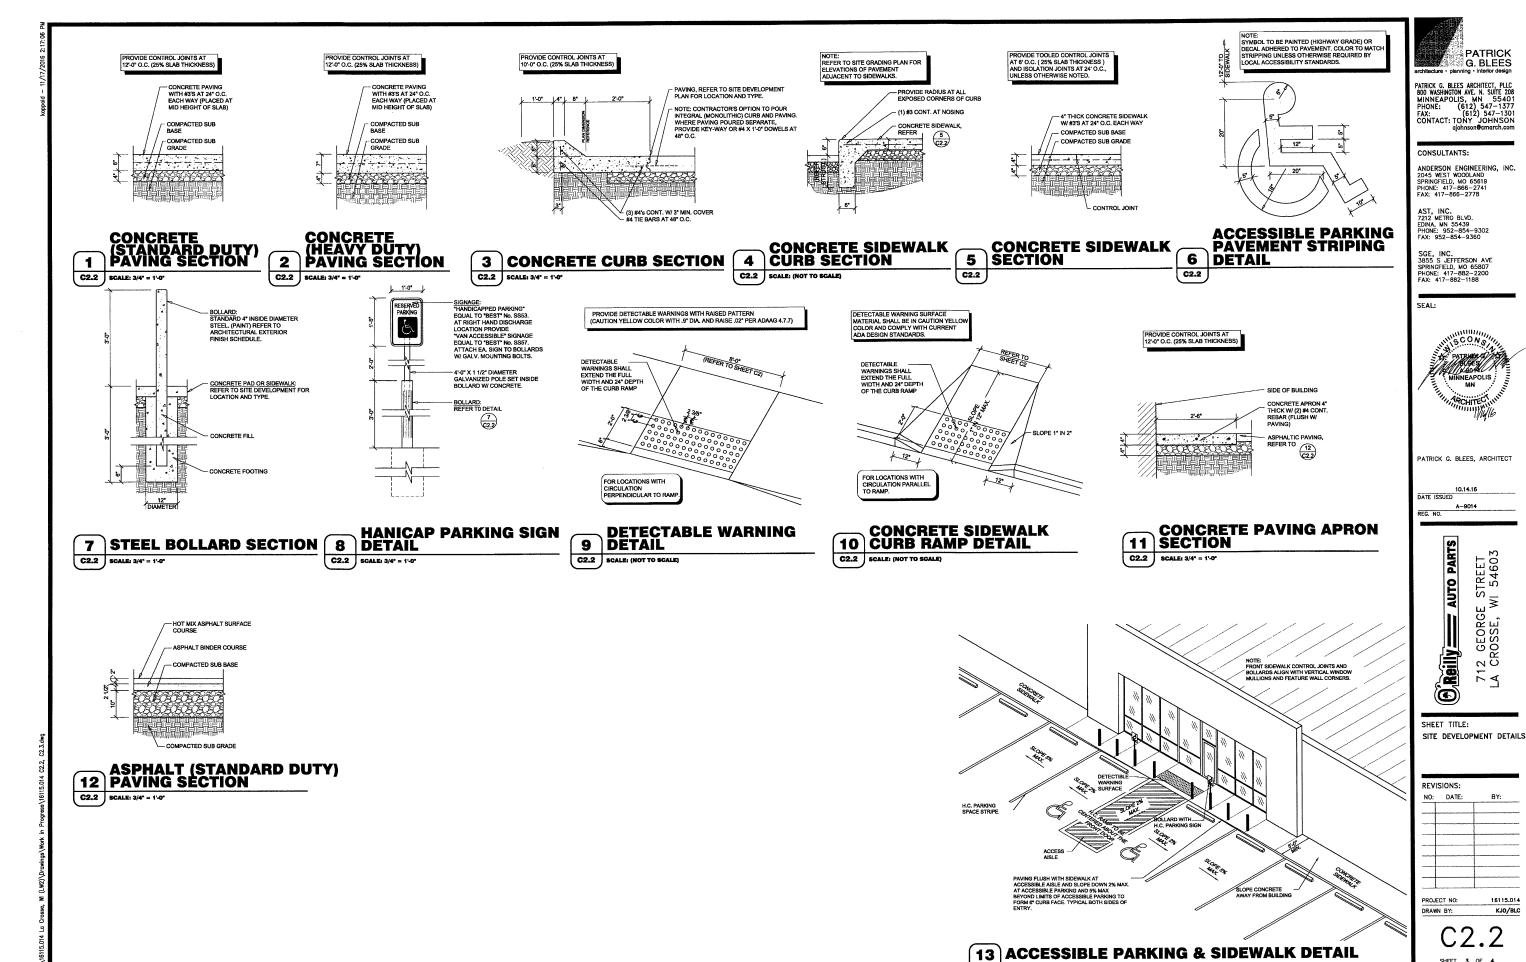16115.014

KJO/BLC

12 GEORGE STREET CROSSE, WI 54603

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1 MASONRY SCREEN FENCE REFUSE ENCLOSURE PLAN

C2.3 | SCALE: 3/4" = 1'-0"

9 5/8"] 7 5/8" ARCHITECTURAL PRECAST CONCRETE UNIT CAP WITH BACKER ROD AND SEALANT AT BUTT JOINTS. DRIP EDGE CAST INTO CAP (TYP.) FLEXIBLE FLASHING, CONTINUOUS *3 DOWEL X 6" AT 32" O.C. EXTENDING 1 1/2" MIN. INTO PRECAST AND BOND BEAM, MORTAR IN PLACE. - 8" SPLIT FACE CONCRETE MASONRY UNIT (CMU) BOND BEAM UNIT UPSIDE DOWN. - 8" SPLIT FACE CONCRETE MASONRY UNIT (CMU) IN STACK BOND WITH HORIZONTAL REINFORCEMENT AT 16" O.C., GROUT ALL CELLS FULL, LAWN OR PAVEMENT, REFER TO SITE PLAN. 1/2" ISOLATION JOINT WITH ASPHALTIC FILLER AND SEALER. CONCRETE PAVEMENT, REFER TO SITE PLAN FOR TYPE. T.O. SLAB EL. (VAR.) (REF. CIVIL)

2 SCREEN FENCE SECTION

• 4 -

(SEE STRUCTURAL)

B.O. FOOTING

GATE FRAME: STEEL TUBE 2"x 2"x 1/4" WITH WELDED JOINTS. -POLYMER COMPOSITE 2 X 4'8 HORIZONTAL ON STEEL FRAME ATTACHED WITH 1/4" GALV. CARRIAGE BOLTS AT 12" O.C.. 3/4" DIA. STEEL ROD HINGE PIN (FIELD GREASE) 7 (2) LOOSE FLAT WASHERS WITH GREASE AT TOP AND BOTTOM -5/16" X 3" STEEL PLATE HINGE PIN ASTRAGAL: STEEL ANGLE 2" X 3" -3/4" I.D. SCHEDULE 80 PIPE X 1" LONG WELDED TO HINGE PIN ROD. HEAVY DUTY SLIDE BOLT LATCH EQUAL TO STANLEY "SP1271". - CAIN BOLTS: 3/4" DIA. BENT ROD 4" X 3"-4" LONG WITH 3" LONG STEEL PIPE ROD GUIDES AND 1/4" BENT PLATE ROD CATCH WITH 1/4" ATTACHMENT PLATE. GATE FRAME ASSEMBLY (IN FOREGROUND) - TENSION STRAP: 1/4" X 2" STEEL BAR WELDED TO BACK OF FRAME. -CONCRETE PAD, REFER SITE DEVELOPMENT FOR TYPE AND LOCATION. CONCRETE PAD, REFER SITE DEVELOPMENT FOR TYPE AND LOCATION. ALL FIXED ASSEMBLIES TO BE FILLET WELDED. FRONT ELEVATION HINGE POST: TUBE STEEL 4" x 4" x 1/4" WITH 1/4" CAP PLATE POST ELEVATION -1/4" BENT PLATE ROD GUIDE 3" LONG STEEL PIPE ROD GUIDES WITH 1/4" ATTACHMENT PLATE. -CAIN BOLTS: 3/4" DIA. BENT ROD 4" X 3'-4" LONG 3/4" I.D. SCHEDULE 80 PIPE HINGE 5/16" STEEL PLATE SLEEVE PLAN SECTION HINGE ELEVATION

SCREEN FENCE GATE DETAILS

C2.3 SCALE: 3/4" = 1'-0"

GENERAL NOTES

(A) REFER TO PROJECT MANUAL FOR ADDITIONAL REQUIREMENTS.

(B) DIMENSIONS ARE TO ROUGH FACE OF CONCRETE, MASONRY, FRAMING, OR CENTER LINE OF STRUCTURE UNLESS OTHERWISE INDICATED.

© REFER TO CIVIL AND STRUCTURAL DRAWINGS FOR ADDITIONAL REQUIREMENTS.

(D) REFER TO ARCHITECTURAL EXTERIOR FINISH SCHEDULE FOR MATERIAL TYPES, COLORS, AND FINISHES. UNLESS OTHERWISE INDICATED PROVIDE FINISHES AS FOLLOWS:

1. ALL MASONRY SURFACES TO MATCH TEXTURES AND COLORS OF BUILDING. EXPOSED MASONRY INSIDE ENCLOSURE TO BE PRIMED AND PAINTED (2) COATS OF COLOR TO MATCH ENCLOSURE EXTERIOR MASONRY.

3, ALL NON-GALVANIZED METAL PARTS TO BE PRIMED AND PAINTED (2) COATS SHERWIN WILLIAMS SW6468 "HUNT CLUB".

4. POLYMER COMPOSITE MATERIAL COLOR TO BE EQUAL TO "TREX" SELECT SERIES "PEBBLE GREY". FINAL COLOR TO BE SELECTED BY OWNER FROM MANUFACTURER'S STANDARD SAMPLES.

G. BLEES

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SGE, INC. 3855 S JEFFERSON AVE SPRINGFIELD, MO 65807 PHONE: 417-882-2200 FAX: 417-882-1188

SEAL:



ATRICK G. BLEES, ARCHITECT

1 10.14.16 DATE ISSUED A-9014 REG. NO.

> Reilly AUTO PARTS 712 GEORGE STREET LA CROSSE, WI 54603


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SITE DEVELOPMENT DETAILS

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DRAWN	BY:	KJO						

SHEET 4 OF 4

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LANDSCAPE PLAN

1

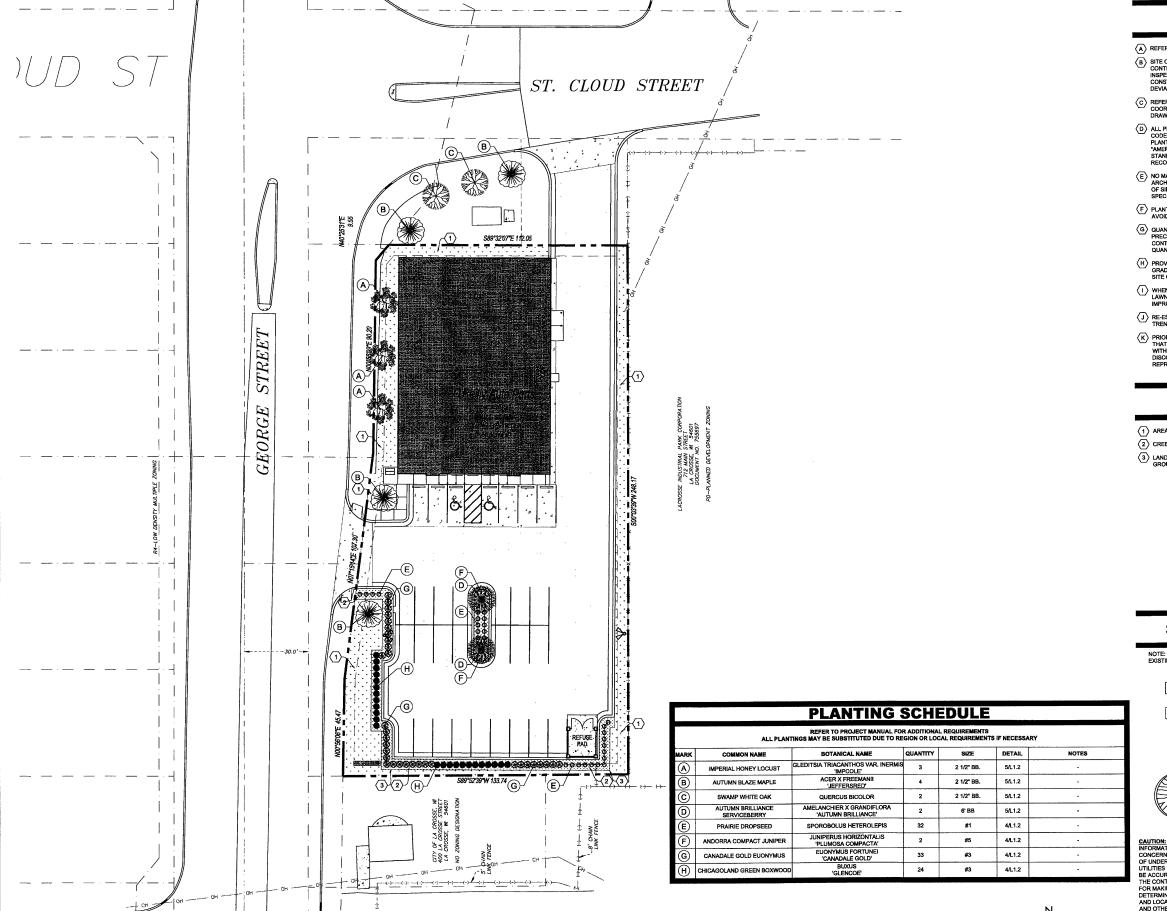L1.1 SCALE: 1" = 20'-0"

GENERAL NOTES

- $\langle \overline{\mathbf{A}} \rangle$ REFER TO PROJECT MANUAL FOR ADDITIONAL REQUIREMENTS.
- B SITE CONDITIONS BASED UPON SURVEY PROVIDED BY OWNER. CONTRACTOR TO FIELD VERIFY EXISTING CONDITIONS BY DETAILED INSPECTION PRIOR TO SUBMITTING BID AND BEGINNING CONSTRUCTION, NOTIFY ARCHITECT IF EXISTING CONDITIONS DEV
- (C) REFER TO CIVIL DRAWINGS FOR ADDITIONAL REQUIREMENTS. COORDINATE WORK WITH OTHER SITE RELATED DEVELOPMENT DRAWINGS.
- (D) ALL PLANTING TYPES SHALL COMPLY WITH LOCAL GOVERNING CODES AND REGULATIONS. CONFORM TO REQUIREMENTS OF PLANT LIST AND TO THE AMERICAN ASSOCIATION OF NURSERYMF AMERICAN STANDARD OF NURSERY STOCK* AND "HORTICULTURAL STANDARDS" AS TO SPECIES, AGE, SIZE, AND PLANTING RECOMMENDATIONS.
- (E) NO MATERIAL SUBSTITUTIONS SHALL BE MADE WITHOUT THE ARCHITECT'S PRIOR WRITTEN APPROVAL ALTERNATE MATERIALS OF SIMILAR SIZE AND CHARACTER MAY BE CONSIDERED IF SPECIFIED PLANT MATERIALS CANNOT BE OBTAINED.
- (F) PLANT LOCATIONS ARE APPROXIMATE. ADJUST AS NECESSARY TO AVOID CONFLICTS.
- G QUANTITIES OF MATERIALS SHOWN ON LANDSCAPING PLAN TAKE PRECEDENCE OVER QUANTITIES SHOWN ON PLANTING SCHEDULE. CONTRACTOR SHALL BE RESPONSIBLE FOR VERIFYING ALL QUANTITIES ON LANDSCAPING PLAN.
- (H) PROVIDE 4" TOPSOIL AT ALL SOD, SEED AND PLANTING AREAS.
 GRADE SHALL BE ADJUSTED FOR SOD THICKNESS. REFER TO CIVIL
 SITE GRADING PLAN FOR SLOPE REQUIREMENTS.
- (I) WHEN CLAY SOIL IS ENCOUNTERED IN THE ESTABLISHED OF THE LAWN OR THE INSTALLATION OF PLANT MATERIAL IT SHALL BE IMPROVED IN ACCORDANCE WITH STANDARD TRADE PRACTICE.
- (J) RE-ESTABLISH TURF IN AREAS DISTURBED BY GRADING OR UTILITY TRENCHING IN THE RIGHT-OF-WAY.
- K PRIOR TO INSTALLATION, GENERAL CONTRACTOR TO CONFIRM THAT LIGHT POLES, LANDSCAPING AND UTILITIES DO NOT CONFLICT WITH SIGN LOCATION SHOWN. IF ANY POTENTIAL CONFLICT IS DISCOVERED, GENERAL CONTRACTOR IS TO CONTACT OWNERS REPRESENTATIVE BEFORE PROCEDING WITH THE WORK.

KEY NOTES

- 1 AREA OF SOD, REFER TO DETAIL 1/L1.2.
- 2 CREEK GRAVEL, REFER TO DETAIL 2/L1.2.
- (3) LANDSCAPE EDGING, REFER TO DETAIL 2/L1.2. PROVIDE AT ALL GROUND COVER TYPE TRANSITIONS.

SYMBOLS LEGEND

NOTE: REFER TO SURVEY SHEET FOR SYMBOLS LEGEND OF EXISTING CONDITIONS.

NEW AREA OF LANDSCAPE GRAVEL

NEW AREA OF SOD SHRUB PLANTING



LINDER STORY TREE



UTILITIES IS NOT GUARANTEED TC BE ACCURATE OR ALL INCLUSIVE. THE CONTRACTOR IS RESPONSIBLE FOR MAKING HIS OWN DETERMINATION AS TO THE TYPE AND LOCATION OF UNDERGROUNI. AND OTHER UTILITIES AS MAY BE INCESSARY TO AVOID DAMAGE THERETO.

Know what's below Call before you dig. G. BLEES

PATRICK G. BLEES ARCHITECT, PLLC 800 WASHINGTON AVE. N. SUITE 208 MINNEAPOLIS, MN 55401 PHONE: (612) 547-1377 FAX: (612) 547-1301 CONTACT: TONY JOHNSON ajohnson@cmarch.com

CONSULTANTS:

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SGE, INC. 3855 S JEFFERSON AVE SPRINGFIELD, MO 65807 PHONE: 417-882-2200 FAX: 417-882-1188

SEAL:



PATRICK G. BLEES, ARCHITECT

10.14.16 DATE ISSUED

A-9014 REG. NO.

= AUTO PARTS 712 GEORGE STREET LA CROSSE, WI 54603 (C) Reilly:


SHEET TITLE: LANDSCAPE PLAN

REVISIONS: NO: DATE: PROJECT NO: 16115.014 DRAWN BY: KJO

SHEET 1 OF 3

1 SOD DETAIL

L1.2 | SCALE: 3/4" = 1'-0"

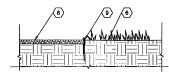

L1.2 SCALE: 3/4" = 1'-0"

2 LANDSCAPE GRAVEL DETAIL

3 NOT USED.

GENERAL NOTES

- (A) REFER TO PROJECT MANUAL AND SCOPE OF WORK SCHEDULE FOR ADDITIONAL REQUIREMENTS.
- (B) REFER TO LANDSCAPE PLAN FOR PLANTING TYPES AND LOCATIONS.
 - © COORDINATE WORK WITH OTHER SITE RELATED DEVELOPMENT DRAWINGS.

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4 SMALL SHRUB DETAIL

- (2) SET TREE LEVEL AND PLUM, STRAIGHTEN AFTER SETTLEMENT IF NEEDED.
- (3) ENCASE WIRE AROUND TRUNK IN BLACK RUBBER, MOVE UP ABOVE EQUAL TO 1/2 TO 1/3 OF THE HEIGHT OF TREE.
- (4) SET TREE WITH TOP 1/3 OF ROOT ABOVE FINISH GRADE.
- 5 NOT USED.
- (7) REFER TO SITE GRADING PLAN FOR SLOPE, PLACE THREE PINS EVERY 2-0*, SPACING EQUALLY, SOD SHALL BE COMPOSED OF TWO VARIETIES MINIMUM OF FESCUE GRASS.
- 9 4" BLACK POLY VINYL EDGING
- 10 NOT USED.

- 20 2" X 4" STAKE OR METAL FENCE POST
- 21 1" X 4" X 10" WHITE WOOD FLAG

KEY NOTES

- 1 PLANTING, REFER TO PLANTING SCHEDULE FOR TYPES

- 6 LAWN
- (8) 3" DEEP, 5/8" CREEK GRAVEL OVER BLACK 4 MIL. VISQUEEN VAPOR BARRIER.

- (11) COMPACTED PLANTING
- (12) SUB GRADE
- (13) TWO STRANDS OF WIRE
- (15) 2" X 2" X 10" WOOD STAKES BURY BELOW FINISH GRADE
- (16) PREPARED PLANTING MIXTURE.
- TREES 6"-0" IN HEIGHT OR LESS SHALL BE STAKED
- (18) EXTENTS OF PLANTING BERM TO HOLD WATER

PATRICK

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PATRICK G. BLEES, ARCHITECT

DATE ISSUED A-9014 REG. NO.


> CREILY AUTO PARTS 712 GEORGE STREET LA CROSSE, WI 54603

SHEET TITLE:


LANDSCAPING DETAILS

REVISIONS: NO: DATE: PROJECT NO: 16115.014

DRAWN BY:

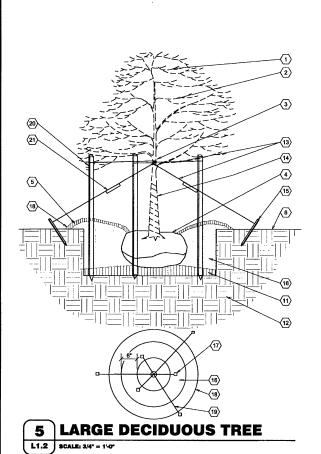

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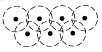


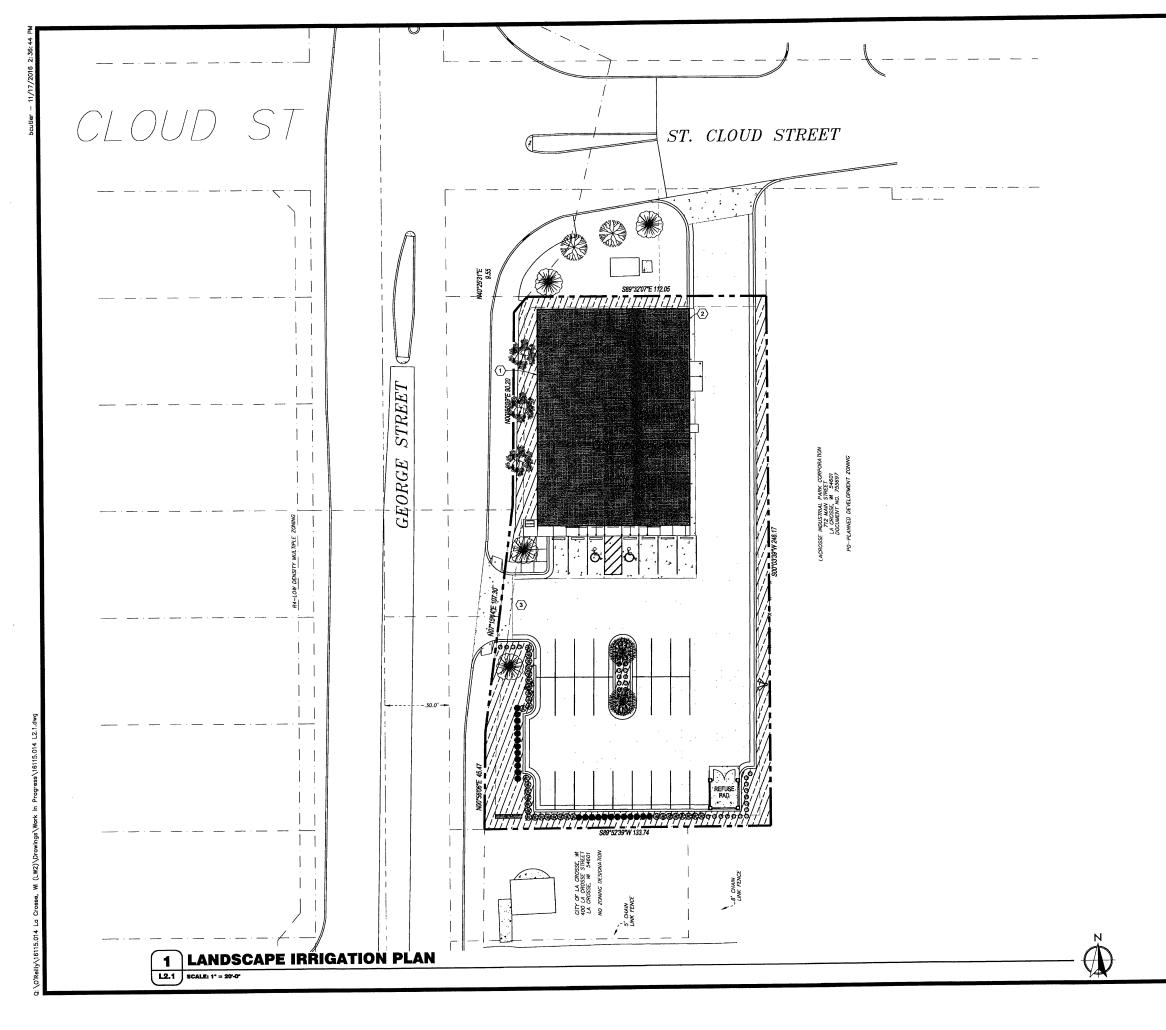GENERAL NOTES

- $\langle \overline{\mathbf{A}} \rangle$ REFER TO PROJECT MANUAL FOR ADDITIONAL REQUIREMENTS.
- (B) REFER TO CIVIL AND SITE UTILITY DRAWINGS FOR ADDITIONAL REQUIREMENTS. COORDINATE WORK WITH OTHER SITE RELATED DEVELOPMENT DRAWINGS.
- (C) PRIOR TO INSTALLATION, GENERAL CONTRACTOR TO CONFIRM THAT LIGHT POLES, LANDSCAPING AND UTILITIES DO NOT CONFLICT WITH SIGN LOCATION SHOWN. IF ANY POTENTIAL CONFLICT IS DISCOVERED, GENERAL CONTRACTOR IS TO CONTACT OWNER'S REPRESENTATIVE BEFORE PROCEEDING WITH THE WORK.
- (D) IRRIGATION SYSTEM TO BE DESIGNED BY CONTRACTOR FOR SHOWN COVERAGE AREAS INDICATED. CONTRACTOR SHALL BE RESPONSIBLE FOR PROVIDING A COMPLETE AND OPERABLE IRRIGATION SYSTEM IN ACCORDANCE WITH GOVERNING CODES ORDINANCES, AND AUTHORITIES HAVING JURISDICTION. SUBMIT SHOP DRAWINGS FOR REVIEW AND APPROVAL AS SPECIFIED.
- (E) VERIFY MINIMUM STATIC WATER PRESSURE IS AVAILABLE AT THE PROJECT SITE PRIOR TO DESIGN AND BEGINNING CONSTRUCTION.
- (F) COORDINATE IRRIGATION SYSTEM WITH LANDSCAPING AND PLANTING, REFER TO LANDSCAPE PLAN, WHEN TRENCHING AVOID TREE ROOT BALLS AND INSTALL HEADS AT APPROPRIATE LOCATIONS.
- (G) ADJUST ALL NOZZLES TO AVOID OVERTHROW ON SIDEWALKS, PAVING, WALLS, ROADWAYS, AND BEYOND PROPERTY LINES, UNIESS OTHERWISE INDICATED. THROTTLE ALL IRRIGATION CONTROL VALVES AS REQUIRED TO PREVENT FORGATION ARC AND RADIUS OF REQUIRED SPRINKLERS AS NEEDED.
- $\begin{picture}(t){ll} \hline H\end{picture} SET CONTROLLER RUN TIMES TO MATCH PLANT WATER NEEDS AND SOIL CONDITIONS.$
- (I) INSTALL RISERS 18" FROM WALLS AND A MINIMUM OF 12" FROM ANY SIDEWALK OR ROAD.
- (J) TOP OF SPRAY AND ROTOR HEADS SHALL BE SET AT TOP OF SOD OR TOP OF MULCH LAYERS.
- L PROVIDE RAIN SENSOR AND ANTI-FREEZE ASSEMBLY ON IRRIGATION SYSTEM.
- THE CONTRACTOR IS FULLY RESPONSIBLE FOR THE WORK UNTIL OWNER GIVES FINAL ACCEPTANCE.
- $\langle {\sf N} \rangle$ ALL CIRCUIT PIPE IS TO BE CLASS 160 PVC OR HIGHER GRADE.
- ALL MAIN FITTINGS SHALL BE REINFORCED WITH 2000 PSI POURED CONCRETE THRUST BLOCKS.

COVERAGE REQUIREMENTS

IRRIGATION HEAD SHALL BE PLACED TO PROVIDE 100% OVERLAP HEAD-TO-HEAD COVERAGE.



KEY NOTES

- 1) APPROXIMATE LOCATION OF LAWN IRRIGATION METER WITH BACK FLOW PREVENTION PER CITY REQUIREMENTS. REFER TO SITE UTILITIES PLAN
- $\fbox{2}$ irrigation controller location inside of Building. Provide freeze sensor and rain sensor on outside of Building.
- 4* DIAMETER SCHEDULE 40 PVC SLEEVES UNDER PAVEMENT FOR ROUTING OF IRRIGATION SYSTEM. PROVIDE END CAPS AND PULL

SYMBOLS LEGEND

NOTE: REFER TO SURVEY SHEET FOR SYMBOLS LEGEND OF

4444

· O

SHRUB PLANTING



INFORMATION ON THIS DRAWING CONCERNING TYPE AND LOCATION OF UNDERGROUND AND OTHER UTILITIES IS NOT GUARANTEED TO BE ACCURATE OR ALL INCLUSIVE. THE CONTRACTOR IS RESPONSIBLE FOR MAKING HIS OWN DETERMINATION AS TO THE TYPE AND LOCATION OF UNDERGROUND AND OTHER UTILITIES AS MAY BE DECESSARY TO AVOID DAMAGE THERETO.

Know what's below Call before you dig.



∯ G. BLEES

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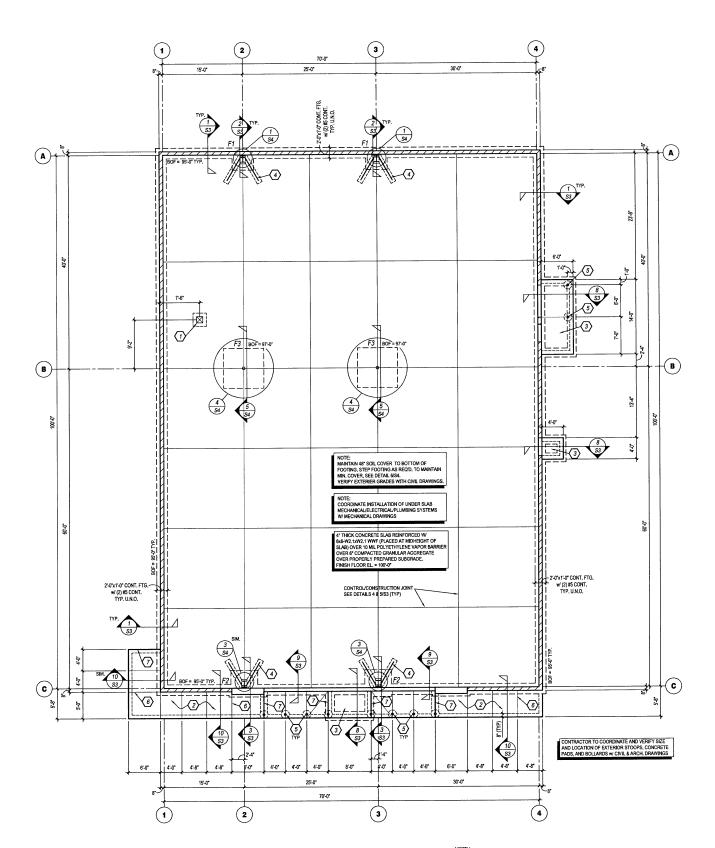
10.14.16 DATE ISSUED REG. NO.

> **AUTO PARTS** 712 GEORGE STREET LA CROSSE, WI 54603 **GReilly**

SHEET TITLE: LANDSCAPE IRRIGATION PLAN

REVISIONS: NO: DATE: 16115.014 PROJECT NO: DRAWN BY: KJO/BLC

IGHT PATRICK G. BLEES ARCHITECT, PLLC 2016



FOUNDATION PLAN SCALE: 1/8" = 1'-0"



	SPLICE TABLE 1 (UNILESS NOTED OTHERWISE)						
	LAP SPLIC	ES (in.) ²	EMBE	EMBED LENGTH (in.)			
BAR SIZE	"TOP BARS" 3 Class B	OTHERS Class B	"TOP BARS" ³ Id	OTHERS Id	ноокs Idh		
#3	17	13	13	10	6		
#4	23	18	18	14	8		
#5	28	22	22	17	10		
#6	34	26	26	20	12		
#7	55	43	43	33	14		
#8	70	54	54	41	16		


- 1) SPLICE TABLE IS BASED ON THE FOLLOWING A. CONCRETE to ± 3000 psi B. GRADE 60 REBAR
- C. 1 1/2" MINIMUM COVER, 1 1/2" MINIMUM CLEARANCE BETWEEN BARS
- 2) LAP LENGTHS SHOWN ARE FOR CLASS B TENSION SPLICES PER ACI 318-05,
- CHAPTER 12.

 3) TOP BARS' ARE DEFINED AS HORIZONTAL REINFORCEMENT PLACED SO THAT MORE THAN 12' OF CONCRETE IS CAST BELOW THE REINFORCEMENT IN THAT MEMBER.

 4) STANDARD 90' HOOKS:

 A ADDUS 4 BAR DIAMETERS FOR #3 THRU #8 REBARS

 B. LENGTH = 12 BAR DIAMETERS

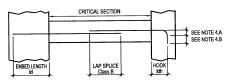

DESIGN CRITERIA IS BASED UPON THE WISCONSIN ADMINISTRATIVE CODE. CHAPTER SPS 362, EFF 9-1-11 (IBC 2009 w/ STATE AMENDMENTS)

- 1. LIVE LOADS: ROOF: 20 psf 2. SNOW LOADS:
- Pg = 40 psf Pf = 32 psf
- 3. WIND LOADS:

 BASIC WIND SPEED: 90 mph
 lw = 1.0
- EXPOSURE *B* GCp = ±0.18
- 4. SEISMIC: I_E=1.0 SEISMIC USE GROUP I SS = 0.063, S₁=0.067 Sds = 0.034, Sd₁=0.054 SITE CLASS 'D' (ASSUMED) SEISMIC DESIGN CATEGORY 'A' ORDINARY STEEL MOMENT FRAMES 5. LOAD COMBINATIONS: LOAD COMBINATIONS SHALL BE PER 2009 INTERNATIONAL BUILDING CODE 6. DEFLECTION LIMITS:
- 6. DEFLECTION LIMITS: PER 2009 INTERNATIONAL BUILDING CODE

- FLOOR SAFE: OWNER FURNISHED, CONTRACTOR INSTALLED, PROVIDE 18"x18"
 BLOCKOUT (SEE SECTION 7/53), FINAL INSTALLATION OF SAFE TO BE AFTER COMPLETION OF OFFICE GYP, BOARD WORK, COORDINATE LOCATION w/ ARCH.

- EQUIPMENT PAD: PROVIDE 5" THICK CONCRETE REINFORCED WITH
 SEA-W2.1XW2.1 WWY: (PLACED AT MIDHEIGHT OF SLAB) OVER 6" COMPACTED
 GRANULAR AGGREGATE BASE ON PROPERTY PERPARED SUBGRADE, PROVIDE
 CONTROL AND ISOLATION JOINTS AS INDICATED. SEE CIVIL DRAWINGS FOR TOP OF CONCRETE SPOT ELEVATIONS.

FOUNDATION EXCAVATION NOTES:

- 1. A GEOTECHNICAL ANALYSIS HAS BEEN PERFORMED ON THIS SITE. SEE PROJECT MANUAL FOR GEOTECHNICAL INFORMATION. ALL RECOMMENDATIONS STATED IN THE GEOTECHNICAL REPORT SHOULD BE FOLLOWED.

 PRIOR TO CONSTRUCTION, ALL EXISTING BESEMENT FOUNDATIONS, FILL, AND DEBRIS MUST BE REMOVED ENTRELY FROM THE SITE. NEW FOUNDATIONS SHOULD BEAR ON THE SITE. HINDISTURBED CLAY SOILS OR ON NEW, WELL COMPACTED FILL SLABS SHOULD BEAR ON A MINIMUM OF 24 INCHES OF LOW PLASTICITY, ENGINEERED FILL SEE GEOTECHNICAL EXPORT FOR SPECIFIC REQUIREMENTS REGARDING EXCAVATION AND PREPARATION OF SUBGRADE A GEOTECHNICAL ENGINEER SHOULD BE PRESENT TO DIRECT THE REMOVAL OF UNSUTTABLE SOILS AND TO ETERMINE THE ADEQUACY OF THE BEARNING SUBFACE PRIOR TO PLACEMENT OF REINFORCHMENT AND CONCRETE.
- SURFACE PRIOR TO PLACEMENT OF REINFORCEMENT AND CONCRETE.

 IN THE EVENT THAT UNISTABLE SOIL OR UNCOMPACTED FILL IS FOUND BELOW
 ELEVATIONS OF SLAB AND FOOTINGS, IT SHALL BE REMOVED AND REPLACED
 WITH SELECT STRUCTURAL FILL. SELECT STRUCTURAR FILL SHALL ASO BE
 USED TO BRING FLOOR SLABS TO PROPER ELEVATION WHERE REQUIRED,
 ORGANICS, DEETS AND ROCKS OREATER THAN 3" IN DIAMETER SHALL BE
 EXCLUDED FROM STRUCTURAL FILL LIFTS.
- SELECT STRUCTURAL FILL SHOULD BE PLACED IN NO GREATER THAN 8" LIFTS
 AND COMPACTED AS SPECIFIED IN THE GEOTECHNICAL REPORT.

GEOTECHNICAL CRITERIA USED FOR FOUNDATION DESIGN

SOIL BEARING VALUES FOR CONTINUOUS FOOTINGS = 1500 ps SOIL BEARING VALUES FOR ISOLATED FOOTINGS = 1500 psf.

KEYNOTES:

- 2) SIDEWALK: PROVIDE 4" THICK CONGRETE REINFORCED WITH 6x6-W2.1xW2.1 WHY FPLACED AT MIDHEIGHT OF SLAB) OVER 8" COMPACTED GRANUPACTED GRANUPACTED GRANUPACTED GRANUPACTED GRANUPACTED GRANUPACTED GRANUPACTED GRANUPACTED SHORT OF STORY OF CONGRETE SPOT ELEVATIONS.
- CONCRETE SPOT ELEVATIONS.

 3 DOOR PAD: PROVIDE 4' THICK CONCRETE REINFORCED WITH 6x6-W2.1xW2.1
 WWF (PLACED AT MIDHEIGHT OF SLAB) OVER 6' COMPACTED GRANULAR
 AGGREGATE BASE ON PROPERLY PREPARED SUBGRADE. PROVIDE CONTROL
 AND ISOLATION JOINTS AS INDICATED. SEE CIVIL DRAWINGS FOR TOP OF
 CONCRETE SPOT ELEVATIONS.
- 4 SLAB HAIRPIN. SEE DETAIL 11/S3.
- 5) STEEL BOLLARD: SEE SITE DEVELOPMENT PLANS AND DETAILS. (WHERE APPLICABLE, ALIGN WITH CENTERLINE OF STOREFRONT MULLIONS.)
- SIDE WALK CONTROL JOINT, SEE SECTION 4/S3.
- SIDE WALK ISOLATION JOINT. SEE SECTION 6/S3.

REFER TO THE GEOTECHNICAL REPORT MR165321 BY TERRACON CONSULTANTS, INC. DATED SEPT. 23, 2016

	FOUNDATION SCHEDULE										
ARK	FOOTING SIZE	FOOTING		BOTT. OF FOOTING	PIER SIZE	PIE REINF	ORCING	TOP OF PIER	NOTES	REFER	MARK
AINN	(WxLxT)	LONG. TRANS. ELEVATION		SIZE	VERT. ⁽⁷⁾	TIES ⁽⁶⁾	ELEVATION				
F1	4'-0"x4'-0"x1'-0"	(5) #4's	(5) #4's	95'-0"	1'-0"x1'-8"	(8) #6's	#3 @ 12"oc	100'-0"	1,2,3,4,5,6	2/53	F1
F2	5'-0"x5'-0"x1'-0"	(5) #5's E	ACH WAY	95'-0"	1'-0"x1'-8"	(8) #6's	#3 @ 12"oc	100'-0"	1,2,3,4,5,6	3/S3	F2
F3	7'-6"x7'-6"x2'-0"		ACH WAY	97'-0"	N/A	N/A	N/A	N/A	1,2,4,5	5/S4	F3

NOTES: 1. ALL ANCHOR BOLTS SHALL BE SIZE, QUANTITY AND SPACING AS SPECIFIED BY PRE-ENGINEERED METAL BUILDING MANUFACTURER, MAINTAIN 3* MINIMUM CONCRETE COVER AROUND BOLTS. TIES SHALL WRAP AROUND ANCHOR BOLTS. 2. COLUMN BASE PLATE TO REST ON TOP OF SLAB. PROVIDE LEVEL BEARING SURFACE FOR EVEN CONTACT. 3. COLUMN FOOTING REINFORCEMENT TO BE INTEGRAL WITH EVOLUDATION WALL REINFORCEMENT. 4. PROVIDE ANCHOR BOLT TEMPLATE AT COLUMNS. 5. ALL SPREAD FOOTINGS ARE TO BE CENTERED BENEATH COLUMNS UNLESS NOTED OTHERWISE. 6. PROVIDE 3 ADDITIONAL TIES @ 3*co. @ ANCHOR BOLTS. 7. PIER VERTS. TO HAVE STANDARD HOOK @ FOOTING.

NO: DATE:

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11-11-16 DATE ISSUED

Reilly AUTO PARTS

SHEET TITLE:

REVISIONS:

FOUNDATION PLAN


REG. NO.

30821

SEAL:

PROJECT NO: WI 1043 A. MAGER P. STOLE

SHEET 1 OF 5

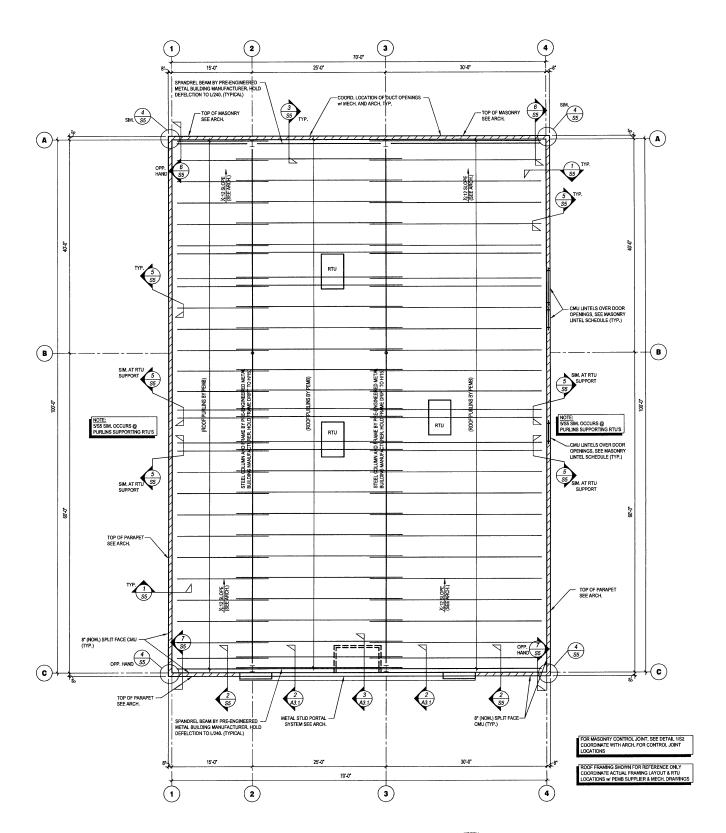

CMU WALL NOTES (REFER TO PROJECT SPECIFICATIONS FOR ADDITIONAL INFORMATION

- A. ALL CMU SHALL BE 2/CELL BLOCK. CELLS WHICH CONTAIN REINFORCING STEEL SHALL BE FILLED SOLID WITH GROUT, INCLUDING BOND BEAM AND LINTELS.

 8. VERTICAL CELLS TO BE FILLED SHALL HAVE VERTICAL ALIGNMENT SUFFICIENT TO MAINTAIN A CLEAR, UNDSSTRUCTED, CONTINUOUS VERTICAL CELL NOT LESS THAN 7.2° IM PLAN DIMENSIONS.

 C. UNLESS NOTED OTHERWISE, FOUNDATION DOWELS SHALL HAVE STANDARD HOOK INTO FOUNDATION CONCRETE EXTEND 48 DIMENSIONS INTO THE ANSONITY WALL OR PRATITION, LAPS OR SPLICES SHALL BE 2° OR 40 DIAMETERS, WHICHEVER IS GREATER. THERE SHALL BE A POUNDATION DOWNEL FOR EACH VERTICAL REINFORCING BAR. UNIONATION TO EMBED INTO CAP BOND BEAM.

 E. AN ADDITIONAL VERTICAL BAY WITH FOUNDATION DOWNEL, SAME SIZE AND LENGTH AS THE DESIGNATED WALL REINFORCING BARS, SHALL BE AT THE SESSION OF WALLS.

 1. AT INTERSECTION OF WALLS.

 1. AT INTERSECTION OF WALLS.


 2. ON EACH SIDE OF CONTROL, JOINTS.

 5. BOND BEAMS AT TOP OF CMU WALLS SHALL BE CONTINUOUS ALL INTERMEDIATE BOND BEAMS, FANY, SHALL BE CONTINUOUS EXCEPT WHITER INTERSECTION OF OPENINGS.


 5. PROVIDE HORIZONTAL BOND BEAMS W. 2. 414 MIN. ® TOP OF FTG, THE COURSE ABOVE THE FLOOR LINE AND Ø 4-07GL. UP THE WALL. PROVIDE STANDARD HOOKS OF WETERLA REINFORCING @ HOSD OF WALL AND SIDES OF OPENINGS OR CONTROL, JOINTS.

 H. CONCRETE MASONRY UNITS SHALL CONFORM TO THE PROVISIONS OF THE CURRENT BUILDING CODE, UNLESS NOTED OTHERWISE. SEE DESIGN CRITERIA FOR BUILDING GOOD ENDINGS OF OPENINGS.



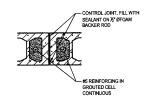

MASONRY CONTROL 1) **JOINT DETAIL** S2 SCALE: NONE

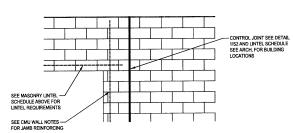

MASONRY CONTROL JOINT DETAIL S2 SCALE: NONE

FRAMING PLAN SCALE: 1/8" = 1'-0"



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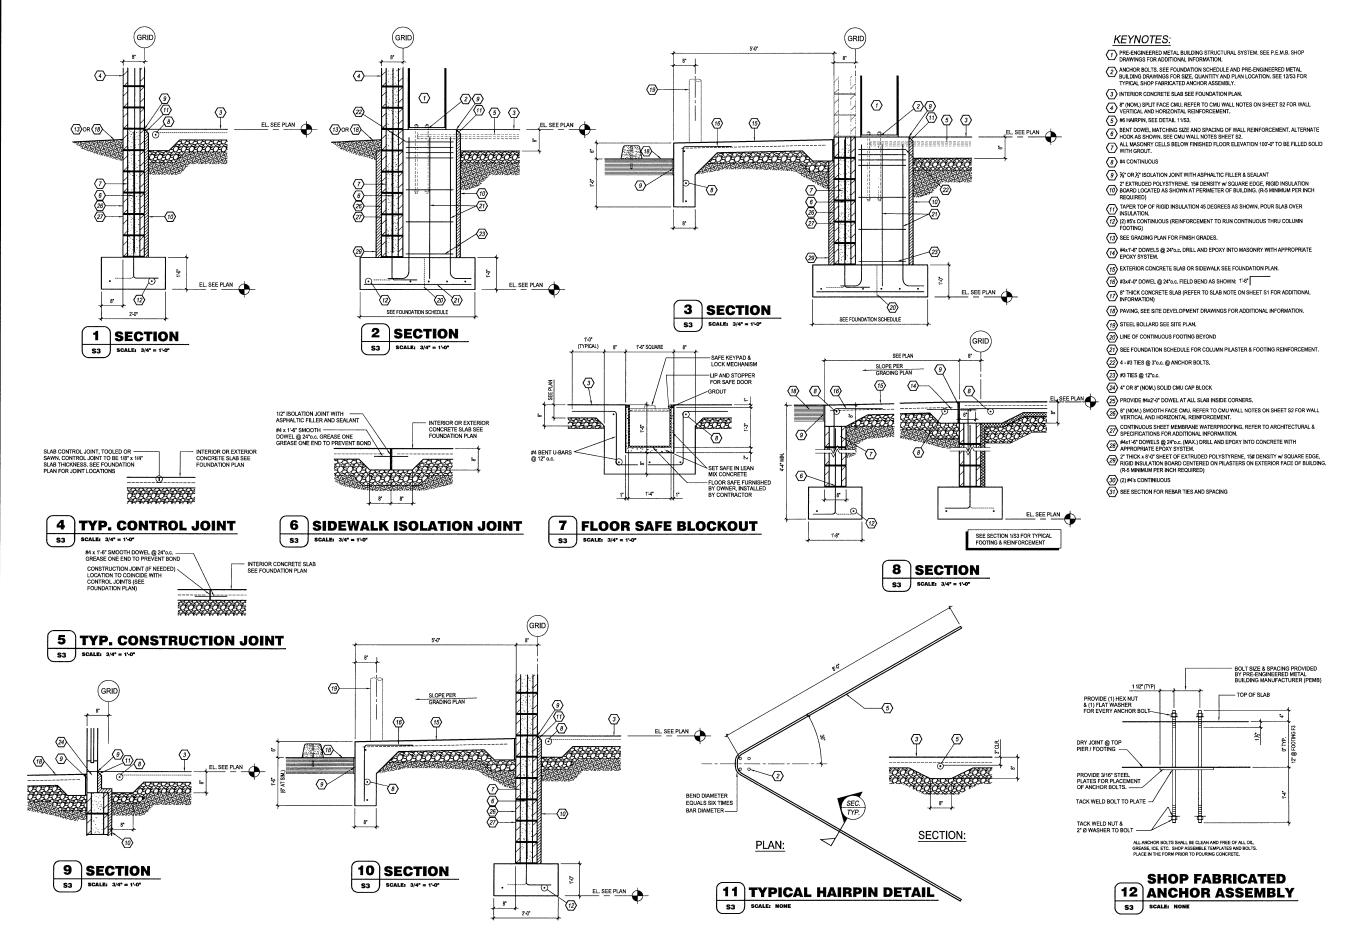
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SHEET TITLE: FRAMING PLAN

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CHECKED BY: P. STOLE

\$2 of 5





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11-11-16 DATE ISSUED 30821 REG. NO.


Reilly AUTO PARTS
710 GEORGE STREET
LACROSSE, WI 54603

SHEET TITLE: FOUNDATION DETAILS


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PROJECT NO: WI 1043
DRAWN BY: A. MAGER
CHECKED BY: P. STOLE

\$3 SHEET 3 OF 5

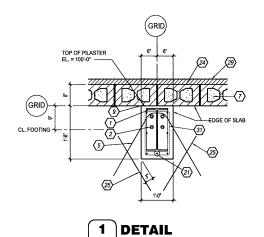



S4 SCALE: 3/4" = 1'-0"

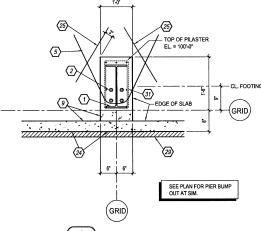


2 NOT USED S4 SCALE: 3/4" = 1'-0"



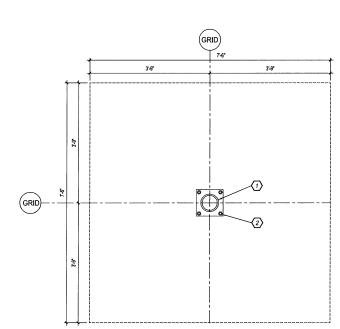

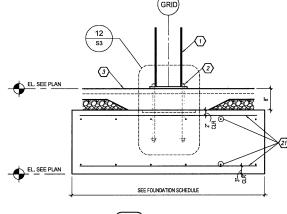

5 DETAIL S4 SCALE: 3/4" = 1'-0"

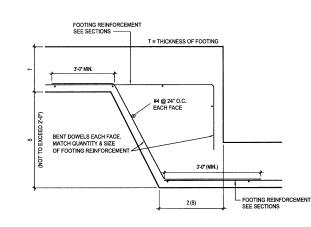

6 TYP. STEPPED FOOTING S4 SCALE: NONE (IF REQUIRED BY FIELD CONDITIONS)

KEYNOTES:

- 7) PRE-ENGINEERED METAL BUILDING STRUCTURAL SYSTEM, SEE P.E.M.B. SHOP DRAWINGS FOR ADDITIONAL INFORMATION.
- ANCHOR BOLTS, SEE FOUNDATION SCHEDULE AND PRE-ENGINEERED METAL.
 BUILDING DRAWINGS FOR SIZE, QUANTITY AND PLAN LOCATION, SEE 12/53 FOR
 TYPICAL SHOP FABRICATED ANCHOR ASSEMBLY.
- (3) INTERIOR CONCRETE SLAB SEE FOUNDATION PLAN.
- 8" (NOM.) SPLIT FACE CMU. REFER TO CMU WALL NOTES ON SHEET S2 FOR WALL VERTICAL AND HORIZONTAL REINFORCEMENT.
- (5) #6 HAIRPIN, SEE DETAIL 11/S3.
- BENT DOWEL MATCHING SIZE AND SPACING OF WALL REINFORCEMENT. ALTERNATE HOCK AS SHOWN, SEE CMU WALL NOTES SHEET S2.
 ALL MASONRY CELLS BELOW FINISHED FLOOR ELEVATION 100-0* TO BE FILLED SOLID WITH GROUT.
- 8 #4 CONTINUOUS
- (9) ¾° OR ½° ISOLATION JOINT WITH ASPHALTIC FILLER & SEALANT
- 2 2 EXTRUDED POLYSTYRENE. 158 DENSITY W SQUARE EDGE, RIGID INSULATION SOURCE COCATED AS SHOWN AT PERIMETER OF BUILDING, (R-5 MINIMUM PER INCH REQUIRED)
- TAPER TOP OF RIGID INSULATION 45 DEGREES AS SHOWN, POUR SLAB OVER INSULATION.
- Insulation.
 (12) (2) #5's Continuous (REINFORCEMENT TO RUN CONTINUOUS THRU COLUMN FOOTING)
- (13) SEE GRADING PLAN FOR FINISH GRADES.
- #4x1'-6" DOWELS @ 16"o.c. DRILL AND EPOXY INTO MASONRY WITH APPROPRIATE EPOXY SYSTEM.
- (15) EXTERIOR CONCRETE SLAB OR SIDEWALK SEE FOUNDATION PLAN.
- (16) #3x4'-0" DOWEL @ 24"o.c. FIELD BEND AS SHOWN: 1"-6"
- 8" THICK CONCRETE SLAB (REFER TO SLAB NOTE ON SHEET S1 FOR ADDITIONAL INFORMATION)
- $\begin{picture}(60,0)\put(0,0){\line(0,0){18}}\put(0,0){\line(0,0){18}$
- (19) STEEL BOLLARD SEE SITE PLAN.
- 20 LINE OF CONTINUOUS FOOTING BEYOND
- 21) SEE FOUNDATION SCHEDULE FOR COLUMN PILASTER & FOOTING REINFORCEMENT.
- (22) 4 #3 TIES @ 3*o.c. @ ANCHOR BOLTS.
- 23 #3 TIES @ 12°o.c.
- 24 4" OR 8" (NOM.) SOLID CMU CAP BLOCK
- 25 PROVIDE #4x2'-0" DOWEL AT ALL SLAB INSIDE CORNERS.
- 8° (NOM.) SMOOTH FACE CMU, REFER TO CMU WALL NOTES ON SHEET S2 FOR WALL VERTICAL AND HORIZONTAL REINFORCEMENT.
- CONTINUOUS SHEET MEMBRANE WATERPROOFING, REFER TO ARCHITECTURAL & SPECIFICATIONS FOR ADDITIONAL INFORMATION.

- (30) (2) #4's CONTINUOUS

 (31) SEE SECTION FOR REBAR TIES AND SPACING



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SEAL:



11-11-18 Date Issued Reilly AUTO PARTS 710 GEORGE STREET LACROSSE, WI 54603

SHEET TITLE: FOUNDATION DETAILS


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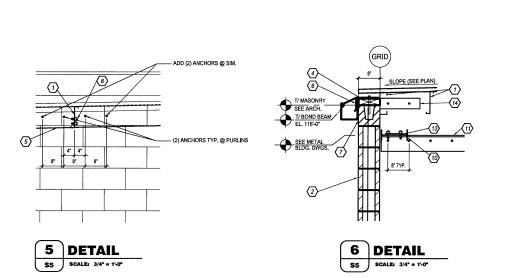
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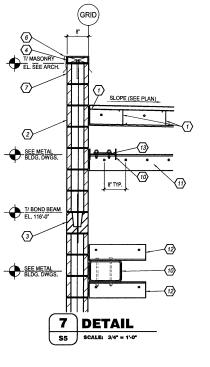
WI 1043 PROJECT NO: DRAWN BY: A. MAGER P. STOLE CHECKED BY:

> **S4** SHEET 4 OF 5







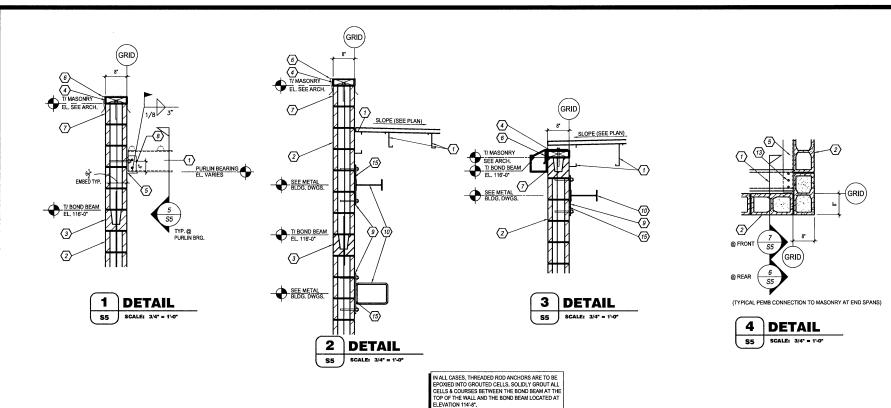

KEYNOTES:

- PRE-ENGINEERED METAL BUILDING STRUCTURAL SYSTEM, SEE P.E.M.B. SHOP DRAWINGS FOR ADDITIONAL INFORMATION.
- (2) 8° (NOM.) SPLIT FACE CMU. REFER TO CMU WALL NOTES ON SHEET S2 FOR WALL VERTICAL AND HORIZONTAL REINFRCEMENT
- (3) CONTINUOUS 8" (NOM.) SPLIT FACE LINTEL BLOCK OR BOND BEAM w/ (2) #4 CONT.
- (4) CONTINUOUS TREATED 2x NAILER WITH 1/2" Ø GALVANIZED ANCHOR BOLTS @ 32"o.c.
- (5) CONTINUOUS L 6"x6"x½" LEDGER ANGLE. STOP ANGLE ½" SHORT EACH SIDE OF MASONRY CONTROL JOINTS. ANCHOR TO WALL BY DRILLING ½" "2x6"-6" DEEP HOLES INTO MASONRY FOR ½" 2x6"-4½" ALL-THREAD RODS (AS SHOWN IN DETAIL 5:55) IN FULLY GROUTED CELLS. FEOVY IN PLACE REFER TO EPOXY IN STALLATION NOTES. ANCHOR ALSO TO BE LOCATED WITHIN 6" OF ANGLE ENDS.
- 6 REFER TO ARCH. FOR ALL ROOF FLASHING REQUIREMENTS
- (7) CONTINUOUS 8" (NOM.) SMOOTH FACE LINTEL BLOCK OR BOND BEAM w/ (1) #5 CONT.
- $\langle \overline{\it 8} \rangle$ connection clip and bolts by pre-engineered metal building supplier
- WELD PLATE BY METAL BUILDING SUPPLIER. SPACE @ 48°0.c. MAX. @ FRONT WALL & 32°0.c.MAX. @ REAR WALL LOCATE PLATE 6° FROM EACH SIDE WALL.
 -ANCHOR TO WALL BY DRILLING "/" ("Φ.Φ"-Φ"/") DEEP HOLES INTO MASONRY FOR (2)

 "/" ("Φ.Φ"-Δ"/") ALL-THERAD ROO IN FULLY GROUTED CELLS. E-POVY IN PLACE. REFER TO EPOXY INSTALLATION NOTES. SHIM PLATES AS REQ'D. BY CONTRACTOR.
- PRE-ENGINEERED METAL BUILDING WIND BEAM AND BRACING, SEE P.E.M.B. SHOP DRAWINGS, FIELD DRILL HOLES IN WIND BEAM TO MATCH CLIP LOCATIONS.
- (11) L 6"x4"x½" BY PEMB SUPPLIER. ANCHOR TO WALL BY DRILLING "%"0%0"-5".** DEEP HOLE INTO MASONRY FOR 4 "x"0%0"-3½". ALL-THREAD RODS IN FULLY GROUTED CELLS. EPOXY IN PLACE. REFER TO EPOXY INSTALLATION NOTES.
- (12) L 6%4% BY PEMB SUPPLIER. ANCHOR TO WALL BY DRILLING 1/6760/6 3/2 DEEP HOLE INTO MASONRY FOR 2 3/2640-43/2 ALL-THREAD RODS IN FULLY GROUTED CELLS. EPOXY IN PLACE. REFER TO EPOXY INSTALLATION NOTES.
- (13) BOLTS BY PRE-ENGINEERED METAL BUILDING SUPPLIER
- (14) ½ BENT PLATE BY PEMB SUPPLIER. ANCHOR TO WALL BY DRILLING ½ 0x0・6 ½ DEEP HOLE INTO MASONRY FOR 2 ½ 0x0・4½ ALL-THREAD RODS IN FULLY GROUTED CELLS. EPOXY IN PLACE, REFER TO EPOXY INSTALLATION NOTES.
- 15) SHIM PLATES AS REQ'D. FOR CONNECTION BY CONTRACTOR

SIMPSON AT-XP EPOXY ANCHORAGE INTO MASONRY

- DRILL PROPER SIZE HOLE INTO FILLED CELL FOR THE DESIGNATED BAR AS SHOWN ON THE PLANS, CLEAN OUT HOLE WITH OIL—FREE COMPRESSED AIR, COMPLETE PREPARATION WITH USE OF A INJON BRUSH (DO NOT USE A WIRE BRUSH), BLOW OUT DUST OR FRAGMENTS.
- PRIOR TO INJECTION, DISCHARGE AND DISPOSE OF APPROXIMATELY ONE FLUID OUNCE OF EPOXY, EPOXY MUST BE UNIFORM IN COLOR. INSERT NOZZLE INTO THE BOTTOM OF THE HOLE AND FILL ONE HALF THE HOLE IN DEPTH.
- MARK SIDE OF REINFORCEMENT DOWEL OR ANCHOR PRIOR TO PLACEMENT TO INSURE THE ROD IS PLACED TO THE REQUIRED DEPTH.
- INSERT SELECTED ROD SLOWLY BY HAND INTO THE BOTTOM OF THE HOLE USING A SLOW TWISTING MOTION.
- LOAD ONLY AFTER RECOMMENDED CURE TIME. (SEE MANUFACTURER'S RECOMMENDATIONS).
- ANCHOR INSTALLATION TO HAVE FULL TIME SPECIAL INSPECTION.



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SEAL:



11-11-16 Date Issued 30821



SHEET TITLE: ROOF DETAILS

REVISIONS:							
NO:	DATE:	BY:					
		<u> </u>					
ROJE	CT NO:	WI 1043					

DRAWN BY: A. M/
CHECKED BY: P. 5

S.5.

5/8" TYPE 'X' GYPSUM BOARD.

S21

3 5/8" | 5/8" STUDS TO 12'-0" A.F.F.

S41

5/8" TYPE 'X' GYPSUM BOARD INTERIOR SIDE TO 12'-0" A.F.F.

13 5/8" | 5/8" STUDS TO ROOF FRAMING

3-5/8" COLD FORM METAL STUDS (REFER STRUCTURAL DRAWINGS).

EACH SIDE. PARTS AREA "A" TO 12'-6" A. F. F.. PARTS AREA "B" AND "C" TO BOTTOM OF ROOF FRAMING.

S43

S44

GENERAL NOTES

 $\langle \overline{\mathbf{A}} \rangle$ REFER TO PROJECT MANUAL FOR ADDITIONAL REQUIREMENTS.

(B) ALL DIMENSIONS TO ROUGH FACE OF ROUGH FRAMING, CONCRETE, MASONRY OR CENTERLINE OF STRUCTURE, UNLESS OTHERWISE NOTED. COLD FORM METAL STUD INTERIOR PARTITION DIMENSIONS 3-5/8" UNLESS OTHERWISE INDICATED AND NOT SHOWN FOR

© REFER TO EXTERIOR AND INTERIOR FINISH SCHEDULES FOR ADDITIONAL REQUIREMENTS.

(D) REFER TO PRE-ENGINEERED METAL BUILDING SHOP DRAWINGS FOR ADDITIONAL REQUIREMENTS. NOTIFY ARCHITECT IF FINAL DESIGN CONDITIONS DEVIATE SUBSTANTIALLY FROM THOSE INDICATED HEREIN.

KEY NOTES

(1) CONCEALED STEEL COLUMN, REFER TO PRE-ENGINEERED METAL BUILDING SHOP DRAWINGS. PROVIDE SHEET METAL COVER WITH NO EXPOSED HORIZONTAL SEAMS. FINISH TO MATCHING WINDOW

(2) EXPOSED STEEL COLUMN, REFER TO PRE-ENGINEERED METAL BUILDING SHOP DRAWINGS, (PAINT).

(3) OWNER FURNISHED AND CONTRACTOR INSTALLED FLOOR SAFE. SIZE AND TYPE TO BE VERIFIED BY OWNER. FOR FLOOR RECESSED TYPE REFER TO STRUCTURAL DRAWINGS FOR ADDITIONAL REQUIREMENTS. DO NOT INSTALL UNIT UNTIL AFTER OFFICE INTERIOR FINISH WORK HAS BEEN COMPLETED.

4) PORTABLE FIRE EXTINGUISHER SURFACE MOUNTED AT 42" A.F.F. TO CENTERLINE OF EXTINGUISHER. FIRE EXTINGUISHERS SHALL BE UL LISTED, ABC TYPE, WITH 10 LBS. CAPACITY.

(5) SHOWROOM CORNER WALL BOX OUT. INSTALL 5/8" FIRE TREATED PLYWOOD BACKING TO BACK SIDE OF STUD INTERIOR FLANGE ON EACH EXPOSED WALL FACE FROM 8"-9" TO 10"-0" A.F.F. FOR INSTALLATION OF SECURITY MIRRORS. REFER TO 4/4/4.2 (TYPICAL).

(6) TACTILE EXIT SIGN AT EXIT DISCHARGE DOOR STATING "EXIT" WITH BRAILLE LETTERING. SIGN TYPE TO COMPLY WITH ANSI A117.1 AND MOUNTED AT 60" A.F.F. TO CENTERLINE.

 $\fbox{7}$ ROOFTOP ACCESS LADDER. COORDINATE EXACT LOCATION WITH PEMB MANUFACTURER.

SPECIAL NOTE:
REFER TO PRE-ENGINEERED METAL BUILDING SHOP DRAWINGS
FOR LOCATIONS OF INDEPENDENT STRUCTURAL VERTICAL
LATERAL BRACING SYSTEMS AND NOTIFY OWNERS
REPRESENTATIVE AND ARCHITECT IF BRACING OCCURS ADJACENT
TO RESTROOM PERMIETER WALLS, ENTIRE RESTROOM LAYOUT TO
SHIFT BY AWAY FROM BRACING WALL(S) TO CONCEAL STRUCTURE.

INTERIOR WALL & CEILING NOTES

<u>1. GENERAL:</u> A. REFER TO FINISH SCHEDULES FOR ADDITIONAL WALL FINISH MATERIAL

B. REFER TO WALL SECTIONS AND DETAILS FOR ADDITIONAL CONDITIONS.

2. FRAMING: A. PROVIDE FIRE TREATED 2X BLOCKING AS REQUIRED FOR INSTALLATION

B. PROVIDE DIAGONAL WALL BRACING (3" X 18 GA. FLAT STRIP) AT CORNER FACES OF FREE STANDING PARTITION SYSTEMS. C. WHERE WALL FRAMING EXTENDS TO BOTTOM OF ROOF DECK OR STRUCTURE, PROVIDE DEFLECTION CHANNELS AT TOP TRACK FOR 1 1/2" MINIMUM DEFLECTION.

D. REFER TO STRUCTURAL DRAWINGS FOR STRUCTURAL STUD REQUIREMENTS.

E. REFER TO WINDOW AND DOOR HEAD, JAMB AND SILL DETAILS FOR ADDITIONAL FRAMING REQUIREMENTS.

F. PROVIDE HORIZONTAL STUD BRIDGING AT 4'-0" O.C. VERTICAL.

3. GYPSUM AND BACKING BOARD:
A. EXPANSIONICONTROL JOINTS
IN CELLINGS EXCEEDING 2500 SQ. FT. IN AREA AND IN PARTITION WALL
LENGTHS EXCEEDING 36 FEET. DO NOT EXCEED A DISTANCE OF 50 FEET
IN ANY DIRECTION BETWEEN CEILING JOINTS. INSTALL CONTROL JOINTS
WHERE FRAMING OR FURRING CHANGES DI

B. PROVIDE MOISTURE RESISTANT TYPE "X" GYPSUM BOARD AT ALL WET LOCATIONS (RESTROOMS, WET WALLS, AND JANITOR'S SINK AREAS).

C. PROVIDE "J" MOLDING, REGLETS, OR CORNER BEAD AT GYPSUM BOARD PERIMETER CONDITIONS TRANSITIONING TO DISSIMILAR EXPOSED FINISH MATERIALS.

4. INSULATION: A. INSULATION SHALL HAVE A FLAME SPREAD RATING OF 0-25 AND A SMOKE DEVELOPMENT RATING OF 0-450.

B. PROVIDE SEALANT ON BOTH SIDES OF STUD BOTTOM TRACKS AT ACOUSTICAL INSULATED WALL LOCATIONS.

5. FIRE STOPPING: A. PROVIDE FIRE STOPPING AND FIRE SEALANT MATERIALS AS REQUIRED AT ALL. FIRE RATED ASSEMBLY TRANSITIONS, PENETRATIONS, AND PERIMETER CONDITIONS. RATING TO BE EQUAL TO RATED ASSEMBLY.

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SEAL:



PATRICK G. BLEES, ARCHITECT

DATE ISSUED A-9014 REG NO

> 712 GEORGE STREET LA CROSSE, WI 54603 AUTO (CReilly

SHEET TITLE: FLOOR PLAN

REVISIONS: 16115.014 PROJECT NO: DRAWN BY:

SHEET 1 OF 10

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GENERAL NOTES

(A) REFER TO PROJECT MANUAL FOR ADDITIONAL REQUIREMENTS.

(B) FIXTURES AND EQUIPMENT SHOWN FOR REFERENCE ONLY AND ARE OWNER FURNISHED AND INSTALLED.

© DIMENSIONS TO ROUGH FACE OF ROUGH FRAMING OR FACE OF FIXTURE UNLESS OTHERWISE NOTED.

(D) PROVIDE SUSPENDED CEILING SEISMIC BRACING, REFER TO DETAIL 9/A4.2.

(E) ALL FINISH SUBSTITUTION REQUEST REQUIRE OWNER PRIOR APPROVAL.

INTERIOR FINISH TYPES

FLOORS
F-1:
TYPE: POLISHED CONCRETE FINISH
MFG: (REFER TO PROJECT MANUAL - SECTION 03 35 43)
COLOR: NATURAL CONCRETE, CLEAR

F-2: TYPE: LIQUID DENSIFIER TREATED CONCRETE FINISH MFG: (REFER TO PROJECT MANUAL - SECTION 03 30 00) COLOR: NATURAL CONCRETE, CLEAR

B-1: TYPE: RESILIENT BASE MFG: EQUAL TO VPI SIZE: 4" COVE COLOR: JET, #01

WALLS
W-1:
TYPE: PAINT
MFG: SHERWIN WILLIAMS
SERIES: FLAT LATEX
COLOR: SW6126 "NAVAJO WHITE"

W-3: TYPE: PAINT MFG: SHERWIN WILLIAMS SERIES: SEMI GLOSS LATEX COLOR: SW6468 "HUNT CLUB"

W-4: TYPE: SANITARY WALL AND CEILING PANEL SYSTEM MFG: (REFER PROJECT MANUAL) COLOR: WHITE

C-1:
TYPE: ACOUSTICAL TILE CEILING
SIZE: 24" X 48" X 58"; SOUARE EDGE
MFG: ARMSTRONG SPECIFIED
SERIES: 1729 "FINE FISSURED"
COLOR: WHITE
GRID SERIES: "PRELUDE" 15/16" EXPOSED TEE SYSTEM
GRID COLOR: WHITE

C-2: TYPE: PAINT MFG: SHERWIN WILLIAMS SERIES: FLAT LATEX COLOR: SW6126 "NAVAJO WHITE"

C-3: TYPE: PAINT MFG: SHERWIN WILLIAMS SERIES: SEMI GLOSS LATEX COLOR: SW6126 "NAVAJO WHITE"

C-4: TYPE: EXPOSED INSULATION VAPOR BARRIER (WHITE) AND EXPOSED STEEL FRAMING SYSTEM (FACTORY PRIMED)

DOORS AND FRAMES
D-1 (INTERIOR WOOD DOORS):
TYPE: STAIN
SPECIES: CLISTOM GRADE ROTARY SLICED NATURAL BIRCH
FINISH: FACTORY FINISHED
COLOR: EQUAL TO "GRAHAM" #300, MEDIUM BROWN

D-2 (INTERIOR HOLLOW METAL FRAMES)
TYPE: PAINT
MFG: SHERWIN WILLIAMS
SERIES: SEMI GLOSS ENAMEL
COLOR: SW6488 "HUNT CLUB"

D-3 (EXTERIOR DOORS & FRAMES):

TYPE: PAINT
FINISH: REFER TO EXTERIOR FINISH SCHEDULE
COLOR: REFER TO EXTERIOR FINISH SCHEDULE

INTERIOR FINISH SCHEDULE

NO.	ROOM OR SPACE	FLOC	FLOORING		WALLS				LING	DOORS		NOTES
NO.	ROOM OR SPACE	TYPE	BASE	NORTH	EAST	SOUTH	WEST	TYPE	HEIGHT	DOOR	FRAME	
100	PARTS AREA (A)	F-1	B-1	W-1	W-1	W-1	W-1	C-1	11'-6"	D-3	D-3	2, 4, 5
101	PARTS AREA (B)	F-2	N/A	W-3	W-2	W-2	W-2	C-4	VARIES	-	-	1, 2, 3
102	OFFICE	F-2	B-1	W-2	W-2	W-2	W-2	C-2	8'-6"	D-1	D-2	
103	REST ROOM	F-2	B-1	W-4	W-4	W-4	₩4	C-3	8'-6"	D-1	D-2	
104	REST ROOM	F-2	B-1	W-4	W-4	W-4	W-4	C-3	8'-6"	D-1	D-2	
105	PARTS AREA (C)	F-2	N/A	W-2	W-2	W-2	W-2/W-3	C-4	VARIES	D-3	D-3	1, 2

INTERIOR FINISH SCHEDULE NOTES:

1. PAINT EXTERIOR OF (102) OFFICE, (103) RESTROOM, AND (104) RESTROOM WITH W-3 AND PROVIDE BASE B-1. WHERE MULTIPLE WALL FINISH TYPES BY ROOM OR SPACE PLAN ORIENTATION ONLY AND IS NOT INTENDED AS WAINSCOT PATTERNING OF FINISHES ON A SINGLE WALL PLANE.

3. PROVIDE PIECES OF 2' LENGTH BASE FOR INSTALLATION AT ENDS OF PARTS AREA "B" FIXTURES FACING PARTS AREA "A".

4. REFER TO ELECTRICAL DRAWINGS FOR GRID LAYOUT.

5. PAINT EXPOSED STEEL COLUMNS TO MATCH W-3 AND PROVIDE BASE B-1 AROUND PERIMETER.

SYMBOLS LEGEND



F-1: POLISHED CONCRETE:

F-2: LIQUID DENSIFIER TREATED CONCRETE

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SEAL:



PATRICK G. BLEES, ARCHITECT

10.14.16 DATE ISSUED A-9014 REG. NO.

> 712 GEORGE STREET LA CROSSE, WI 54603 AUTO © Reilly

SHEET TITLE: INTERIOR FINISH PLAN

REVISIONS:

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PROJECT NO: 16115.014 DRAWN BY:

SHEET 2 OF 10 COPYRIGHT PATRICK G. BLEES ARCHITECT, PLLC 2016

4 LEFT EXTERIOR ELEVATION

A2.1 SCALE: 1/8" = 1'-0"

EXTERIOR FINISH SCHEDULE

EXTERIOR INSULATION AND FINISH SYSTEM (EIFS) KEY NOTE NO. 1:

KEY NOTE NO. 1:

MFG: DRYVIT SPECIFIED. EQUAL BY STO OR BASF (NO SUBSTITUTES)
SERIES: OUTSULATION PLUS MD
TEXTURE: SANDBLAST
COLOR: DRYVIT 'ORAPO11030S' STRATOTONE HIGH PERFORMANCE
COLOR STRADARD: SHERWIN WILLIAMS 'POSITIVE RED" SW6871
(SHER-CRYL) GLOSS

UNIT MASONRY
KEY NOTE NO. 2A:
TYPE: CONCRETE MASONRY UNIT (CMU)
MFG: (REPERT TO PROJECT MANUAL)
SIZE: 8*X6*X16* (NOM.)
TEXTURE: SPUT FACE
COURSING: RUNNING BOND
FINISH: FELD PAINT (ACCENT COLOR)
COLOR: SHERWIN WILLIAMS "SOFTER TAN" SW6141 (SEMI-GLOSS)
COATS:
(1) COAT SW "PREPRITE" BLOCK FILLER B25W25 (NO LESS THAN 8 MILS)
AND (2) COATS SW "CONFLEX XL" SMOOTH ELASTOMERIC A5-400 (NO LESS
THAN 5.7 MILS EACH COAT)

COATS (COLD WEATHER APPLICATIONS):
(1) COAT SW "LOXON BLOCK SURFACER" (NO LESS THAN 8 MILS) AND (2)
COATS SW "LITRACRETE" SOLVENT BORNE SMOOTH B46 (NO LESS THAN 8
MILS EACH COAT OR 16 MILS TOTAL)

KEY NOTE NO. 2B:
TYPE: CONCRETE MASONRY UNIT (CMU)
MFG: (REFER TO PROJECT MANUAL)
SIZE: 87387316* (NO)
EXTURE: 87387316* (NO)
EXTURE: SPLIT FACE
COURSING: RUNNING BOND

FINISH: FIELD PAINT (FIELD COLOR)
COLOR: SHERWIN WILLIAMS "LATTE" SW6108 (SEMI-GLOSS)

COATS:

(1) COAT SW "PREPRITE" BLOCK FILLER B25W25 (NO LESS THAN 8 MILS)
AND (2) COATS SW "CONFLEX XL" SMOOTH ELASTOMERIC A5-400 (NO LESS THAN 5.7 MILS EACH COAT)

COATS (COLD WEATHER APPLICATIONS):
(1) COAT SW "LOXON BLOCK SURFACER" (NO LESS THAN 8 MILS) AND (2)
COATS SW "LUTRACRETE" SOLVENT BORNE SMOOTH B46 (NO LESS THAN 8 MILS EACH COAT OR 16 MILS TOTAL)

FLASHING AND SHEET METAL KEY NOTE NO. 3: TYPE: STANDING SEAM ROOFING SYSTEM MFG: (REFER TO PRE-ENGINEERED METAL BUILDING SHOP DRAWINGS) COLOR: GALVALUME

KEY NOTE NO. 4: TYPE: CAP FLASHING AT MASONRY MFG: (REFER TO PRE-ENGINEERED METAL BUILDING SHOP DRAWINGS) FINISH: PREFINISHED COLOR: EQUAL TO BUTLER BUILDING "COOL BIRCH WHITE"

MEY NOTE NO. 5:

TYPE: CAP FLASHING AT EXTERIOR INSULATION FINISH SYSTEM (EIFS)

MFG: (REFER TO PRE-ENGINEERED METAL BUILDING SHOP DAWINGS)
FINISH: FACTORY PRIMED AND FIELD PAINT

COLOR: SHERWIN WILLIAMS "POSITIVE RED" SW6871 (SHER-CRYL) GLOSS
WITH SHERWIN WILLIAMS THREE COMPONENT (B65T105 / B65V105 /
B65C105) CLEAR URETHANE

KEY NOTE NO. 6:
TYPE: GUTTER AND DOWNSPOUTS
MFG: (REFER TO PRE-ENGINEERED METAL BUILDING SHOP DRAWINGS)

FINISH: PREFINISHED COLOR: EQUAL TO BUTLER BUILDING "COOL BIRCH WHITE"

DOORS AND WINDOWS
IKEY NOTE NO. 12:
TYPE: STEEL DOORS AND FRAMES (DOORS NO. 2 AND NO. 7)
MFG: (OWNER FURNISHED / CONTRACTOR INSTALLED)
FINISH: FACTORY PRIMED AND FIELD PAINTED
COLOR: SHERWIN WILLIAMS "LATTE" SWINE(08 (SEMI-GLOSS)

KEY NOTE NO. 12:
TYPE: SECTIONAL OVERHEAD DOOR (DOOR NO. 3)
MFG: (REFER TO PROJECT MANUAL)
FINISH: FACTORY PINIED AND FIELD PAINT
COLOR: SHERWIN WILLIAMS "SOFTER TAN" SW6141 (SEMI-GLOSS)

KEY NOTE NO. 13:
TYPE: (REFER TO WINDOW SCHEDULE)
MFG: EFCO, KAWNEER, OR OLD CASTLE (VISTA WALL). (NO SUBSTITUTES)
COLOR: EFCO "IV", KAWNEER "DARK IVY", VISTA WALL "INTERSTATE

(16)

PAINTING
KEY MOTE NO. 15:
TYPE: STEEL BOLLARDS (REFER TO CIVIL DRAWINGS)
FINISH: FIELD PRIME AND PAINT
COLOR: SHERWIN WILLIAMS *HUNT CLUB' SW6468 (SEMI-GLOSS)

GENERAL NOTES

- $\langle \overline{\mathbf{A}} \rangle$ REFER TO PROJECT MANUAL FOR ADDITIONAL REQUIREMENTS.
- $\left\langle \overline{B} \right\rangle$ REFER TO CIVIL DRAWINGS FOR ADDITIONAL REQUIREMENTS.
- © REFER TO PLUMBING, MECHANICAL, AND ELECTRICAL DRAWINGS FOR SYSTEM TYPES AND ADDITIONAL REQUIREMENTS.
- $\begin{picture}(b) \end{picture}$ REFER TO EXTERIOR FINISH SCHEDULE FOR MATERIAL TYPES.
- (E) REFER TO PRE-ENGINEERED METAL BUILDING SHOP DRAWINGS FOR ADDITIONAL REQUIREMENTS.
- (F) REFER TO SCOPE OF WORK SCHEDULE FOR ADDITIONAL REQUIREMENTS.

KEY NOTES

- (1) EXTERIOR INSULATION AND FINISH SYSTEM (EIFS).
- (ZA) CONCRETE MASONRY UNIT (CMU) EXTERIOR WALL CONSTRUCTION (ACCENT COLOR), REFER TO PLANS, SECTIONS, AND DETAILS FOR ADDITIONAL REQUIREMENTS.
- (2B) CONCRETE MASONRY UNIT (CMU) EXTERIOR WALL CONSTRUCTION (FIELD COLOR), REFER TO PLANS, SECTIONS, AND DETAILS FOR ADDITIONAL REQUIREMENTS.
- PRE-ENGINEERED METAL BUILDING SHEET METAL ROOFING
- 4 PRE-ENGINEERED METAL BUILDING SHEET METAL FLASHING (AT MASONRY)
- (5) PRE-ENGINEERED METAL BUILDING SHEET METAL FLASHING (AT EIFS)
- $\stackrel{\textstyle \frown}{$ PRE-ENGINEERED METAL BUILDING SHEET METAL GUTTER AND DOWNSPOUT SYSTEM.
- $\langle \overline{7} \rangle$ CONCRETE MASONRY UNIT (CMU) CORNER FINISHED JAMB UNIT.
- (8) LINE OF ROOF BEYOND WITH 1/4":12" SLOPE MINIMUM.
- (9) SURFACE MOUNTED SIGN OWNER FURNISHED AND INSTALLED. PROVIDE BACKING FOR MOUNTING AND ROUGH-IN ELECTRICAL. COORDINATE REQUIREMENTS WITH OWNER, REFER TO SHEET
- (10) BUILDING ADDRESS NUMBERS IN 6" HIGH HELVETICA WHITE VINYL ADHERED TO EXTERIOR FACE OF GLAZING.
- (11) (NOT USED).
- (12) EXTERIOR DOOR AND FRAME SYSTEM. REFER TO FLOOR PLAN AND DOOR SCHEDULE FOR TYPES.
- (13) EXTERIOR WINDOW SYSTEM. REFER TO FLOOR PLAN AND WINDOW SCHEDULE FOR TYPES.
- (14) APPROXIMATE LINE OF FOUNDATION, REFER TO STRUCTURAL DRAWINGS.
- $\langle \overline{\mbox{15}} \rangle$ STEEL BOLLARDS, REFER TO CIVIL AND STRUCTURAL DRAWINGS.
- (16) HOSE BIB, REFER TO PLUMBING DRAWINGS.
- (17) LIGHT FIXTURE, REFER TO ELECTRICAL DRAWINGS.
- (NOT USED).
- (20) MECHANICAL WALL PENETRATIONS, REFER TO MECHANICAL DRAWINGS. PROVIDE FRAMING, FLASHING, AND SEALANT AS
- (21) PLUMBING ROOF VENT, REFER TO PLUMBING DRAWINGS AND DETAIL 1/A6.1.
- $\langle \overline{22} \rangle$ CONCRETE SPLASH BLOCK INSTALL AT EACH DOWNSPOUT.
- (23) MASONRY CONTROL JOINT, REFER TO STRUCTURAL DRAWINGS. PROVIDE SEALANT OVER 1/2* DIAMETER FOAM BACKER ROD.
- (24) RUSTICATION JOINT, REFER TO DETAIL 6/A3.2.

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SEAL:



ATRICK G. BLEES, ARCHITECT

10.14.16 DATE ISSUED A-9014 REG. NO.


> Z AUTO PARTS 2 GEORGE STREET CROSSE, WI 54603 **GReilly**

SHEET TITLE: EXTERIOR ELEVATIONS

REVISIONS:									
NO:	DATE:	BY:							
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PROJE	CT NO:	16115.014							
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A2.

SHEET 3 OF 10 OPYRIGHT PATRICK G. BLEES ARCHITECT, PLLC 2010

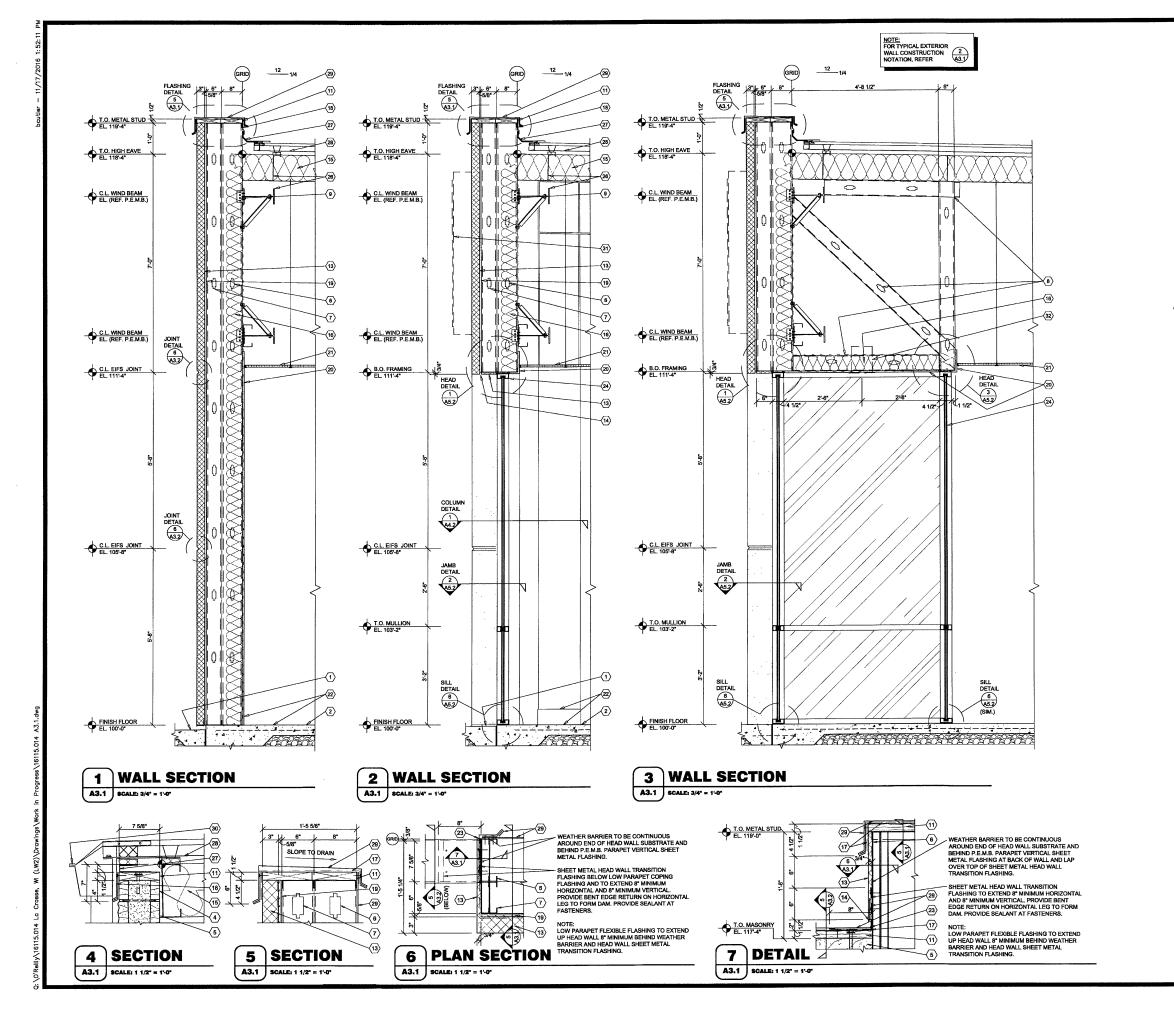

GENERAL NOTES

- (A) REFER TO PROJECT MANUAL AND SCOPE OF WORK SCHEDULE FOR
- (B) REFER TO CIVIL, STRUCTURAL, MECHANICAL, ELECTRICAL, PLUMBING AND PRE-ENGINEERED METAL BUILDING (P.E.M.B.) SHOP DRAWINGS
- © REFER TO INTERIOR AND EXTERIOR FINISH SCHEDULES FOR MATERIAL TYPES, COLORS AND FINISHES.
- (D) DIMENSIONS ARE TO FACE OF CONCRETE, MASONRY, FRAMING, OR CENTER LINE OF STRUCTURE UNLESS OTHERWISE INDICATED.

KEY NOTES

- FINISH LAWN, PAVEMENT OR SIDEWALK, SLOPE TO DRAIN AWAY FROM BUILDING. REFER TO CIVIL DRAWINGS.
- $\fbox{2}$ CONCRETE FLOOR SLAB. REFER TO STRUCTURAL DRAWINGS.
- SPLIT FACE CONCRETE MASONRY UNIT (CMU), (7 5/8" X 7 5/8" X 15 5/8")
 NR RUNNING BODN WITH HORIZONTAL REINFORCEMENT AT 16" O.C.
 REFER TO STRUCTURAL DRAWINGS FOR VERTICAL REINFORCEMENT
 REQUIREMENTS. PROVIDE CORNER, JAMB AND SPECIAL UNITS
 WHERE REQUIRED. REFER TO EXTERIOR ELEVATIONS FOR CONTROL
 JOINT LOCATIONS AND FINISH SCHEDULE.
- (4) SMOOTH FACE CONCRETE MASONRY UNIT (CMU), (7 5/8* X 7 5/8* X 15 5/8*) IN RUNNING BOND W/ HORIZONTAL REINFORCEMENT AT 16* O.C. REFER TO STRUCTURAL DRAWINGS FOR VERTICAL REINFORCEMENT REQUIREMENTS.
- (5) CONCRETE MASONRY UNIT (CMU) BOND BEAM, REFER TO STRUCTURAL DRAWING FOR REINFORCEMENT REQUIREMENTS. PROVIDE SMOOTH FACE UNITS AT EXTERIOR WALL TOP COURSES.
- (6) 8" COLD FORM METAL STUD FRAMING AT 24" O.C.)
- 7 6" COLD FORM METAL STUD FRAMING AT 24" O.C.
- (8) 6" (18 GA.) COLD FORM METAL STUD FRAMING AT 24" O.C. ATTACHED TO PRE ENGINEERED METAL BUILDING STRUCTURAL FRAMING
- \bigcirc COLD FORM METAL STUD FRAMING CLIP, REFER TO STRUCTURAL
- (10) 1 1/2" (25 GA.) COLD FORM METAL Z-FURRING FRAMING AT 24" O.C. AND POLYISOCYANURATE (R-9 MIN.) RIGID INSULATION BOARD WITH FOIL FACE VAPOR BARRIER.
- (1) FIRE TREATED 2X NAILER(S) CONTINUOUS. CUT TO FIT WALL WIDTH. ATTACHED TO METAL STUD FRAMING WITH #12 SCREWS AT 24" O.C. STAGGERED. ATTACHED TO CMU BOND BEAM WITH 1/2" DIA. ANCHORS AT 32" O.C.
- (12) FIRE TREATED 2X NAILER OR BLOCKING.
- (13) EXTERIOR INSULATION FINISH SYSTEM (EIFS) OVER RIGID INSULATION DRAINAGE BOARD IN THICKNESS INDICATED.
- (14) EXTERIOR INSULATION FINISH SYSTEM (EIFS) DRIP.
- (15) PRE-ENGINEERED METAL BUILDING ROOF INSULATION (R-36) LINER SYSTEM, REFER TO SCOPE OF WORK SCHEDULE). VAPOR BARRIER OVER HIGH STRENGTH STEEL SUSPENSION STRAPS ATTACHED TO BOTTOM OF PRE-ENGINEERED METAL BUILDING ROOF PURLINS WITH (1) LAYER 8° (R-25) UN-FACED BATT INSULATION PARALLEL WITH ROOF PURLIN CAVITY AND (1) AVER 8 10° (R-11) UN-FACED BATT INSULATION PERPENDICULAR OVER TOP OF ROOF PURLINS.
- $\langle \overline{16} \rangle$ 6" (R-19) BATT INSULATION WITH FOIL FACE VAPOR BARRIER.
- (T) FLEXIBLE FLASHING CONTINUOUS TO LAP OVER NAILERS AND DOWN BEHIND CONTINUOUS CLEATS ON BOTH SIDES. LAP JOINTS 8* MINIMUM AND MASTIC.
- (18) SHEET METAL (24 GA.) FLASHING, COUNTER FLASHING, EDGES, DRIPS TRIM, CLEATS AND ACCESSORIES.
- (20) 5/8" TYPE "X" GYPSUM BOARD. REFER TO INTERIOR WALL TYPES FOR ADDITIONAL REQUIREMENTS.
- (21) SUSPENDED ACOUSTICAL LAY IN CEILING SYSTEM. REFER TO INTERIOR FINISH SCHEDULE FOR TYPES AND LOCATIONS.
- $\begin{picture}(22)\line(22)$
- (23) SEALANT WITH BACKER ROD (WHERE REQUIRED) TYPICAL AT OPENING PERIMETER JOINTS.
- (24) ALUMINUM WINDOW SYSTEM. REFER TO FLOOR PLAN AND WINDOW SCHEDULES FOR TYPES.
- (25) DOOR AND FRAME SYSTEM, REFER TO FLOOR PLAN AND SCHEDULES FOR TYPES.
- (26) PRE-ENGINEERED METAL BUILDING PRIMARY AND SECONDARY STRUCTURAL FRAMING SYSTEMS.
- (27) PRE-ENGINEERED METAL BUILDING TRANSITION SUPPORT PLATE ASSEMBLY.
- (28) PRE-ENGINEERED METAL BUILDING ROOF PANEL SYSTEM WITH THERMAL SPACER BLOCKS (R-5 MIN.).
- (29) PRE-ENGINEERED METAL BUILDING SHEET METAL FLASHING, COUNTER FLASHING, CONTINUOUS CLEATS, DRIPS CLOSURES, TRANSITIONS, COPINGS AND ACCESSORIES AS REQUIRED.
- (30) PRE-ENGINEERED METAL BUILDING GUTTER AND DOWNSPOUT SYSTEM, REFER TO EXTERIOR ELEVATIONS FOR LOCATIONS. REFER TO P.E.M.B. SHOP DRAWINGS FOR SIZES. PROVIDE CONCRETE SPLASH BLOCKS UNLESS OTHERWISE INDICATED.
- (31) SURFACE MOUNTED WALL SIGN, OWNER FURNISHED AND INSTALLED (REFER TO SCOPE OF WORK SCHEDULE), PROVIDE BACKING AND ELECTRICAL ROUGH-IN, REFER TO ELECTRICAL DRAWINGS.
- (32) RECESSED LIGHTING FIXTURE, REFER TO ELECTRICAL DRAWINGS FOR TYPE AND LOCATION.

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SEAL:



PATRICK G. BLEES, ARCHITECT

10.14.16 DATE ISSUED

A-9014 REG. NO.

> PARTS TREET 54603 AUTO 12 GEORGE STI CROSSE, WI 5 (C. Reilly:


SHEET TITLE: WALL SECTIONS

REVISIONS: NO: DATE: 16115.014 PROJECT NO: KJO/BLC DRAWN BY:

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SHEET 4 OF 10

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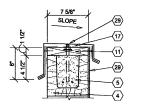


T.O. PURLIN EL. (VARIES) -(5) T.O. BOND BEAM SEL. 112'-0" **(5)** -(12) -23 1 **(2)** FINISH FLOOR

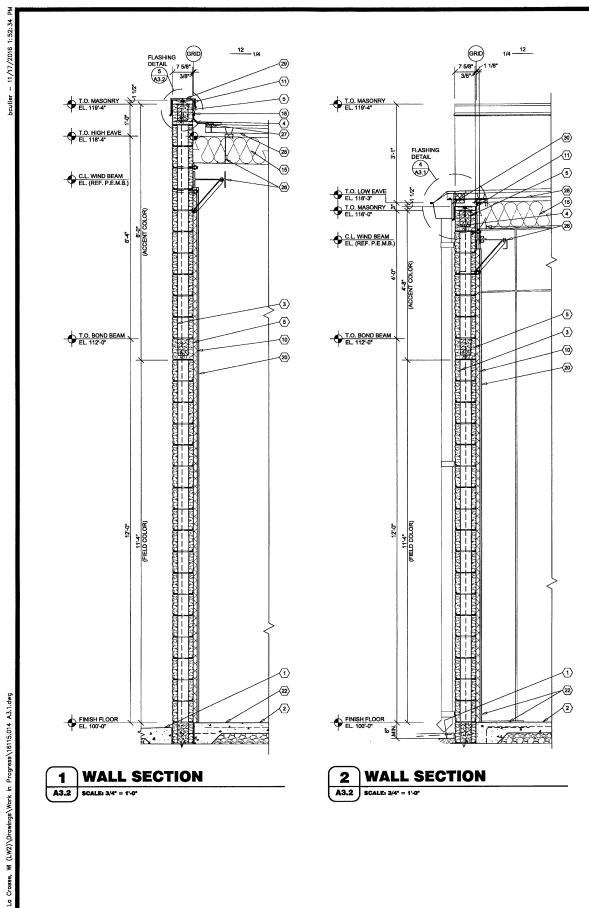3 WALL SECTION
A3.2 SCALE: 3/4" = 1'-0"

4 WALL SECTION
A3.2 SCALE: 3/4" = 1'-0"

FINISH FLOOR
EL. 100'-0"




NOTE: FOR TYPICAL EXTERIOR WALL CONSTRUCTION NOTATION, REFER

T.O. MASONRY EL. 119'-4"

T.O. PURLIN EL. (VARIES)

B.O. BOND BEAM -

3 A3.2

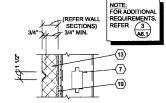

5 SECTION
A3.2 SCALE: 1 1/2" = 1'-0"

6 SECTION
A3.2 SCALE: 1 1/2" = 1'-0"

GENERAL NOTES

- (A) REFER TO PROJECT MANUAL AND SCOPE OF WORK SCHEDULE FOR
- (B) REFER TO CIVIL, STRUCTURAL, MECHANICAL, ELECTRICAL, PLUMBING AND PRE-ENGINEERED METAL BUILDING (P.E.M.B.) SHOP DRAWINGS FOR ADDITIONAL REQUIREMENTS.
- C REFER TO INTERIOR AND EXTERIOR FINISH SCHEDULES FOR MATERIAL TYPES, COLORS AND FINISHES.
- D DIMENSIONS ARE TO FACE OF CONCRETE, MASONRY, FRAMING, OR CENTER LINE OF STRUCTURE UNLESS OTHERWISE INDICATED.

KEY NOTES

- (1) FINISH LAWN, PAVEMENT OR SIDEWALK, SLOPE TO DRAIN AWAY FROM BUILDING. REFER TO CIVIL DRAWINGS.
- (2) CONCRETE FLOOR SLAB. REFER TO STRUCTURAL DRAWINGS.
- 3) SPLIT FACE CONCRETE MASONRY UNIT (CMU), (7 5/8" X 7 5/8" X 15 5/8") IN RUNNING BOND WITH HORIZONTAL REINFORCEMENT AT 16" O.C. REFER TO STRUCTURAL DRAWINGS FOR VERTICAL REINFORCEMENT REQUIREMENTS. PROVIDE CORNER, JAMB AND SPECIAL UNITS WHERE REQUIRED. REFER TO EXTERIOR ELEVATIONS FOR CONTROL JOINT LOCATIONS AND FINISH SCHEDULE.
- (4) SMOOTH FACE CONCRETE MASONRY UNIT (CMU), (7 5/8° X 7 5/8° X 15 5/8°) IN RUNNING BOND WI HORIZONTAL REINFORCEMENT AT 16° O.C. REFER TO STRUCTURAL DRAWINGS FOR VERTICAL REINFORCEMENT REQUIREMENTS.
- (5) CONCRETE MASONRY UNIT (CMU) BOND BEAM, REFER TO STRUCTURAL DRAWING FOR REINFORCEMENT REQUIREMENTS. PROVIDE SMOOTH FACE UNITS AT EXTERIOR WALL TOP COURSES
- (6) 8" COLD FORM METAL STUD FRAMING AT 24" O.C.
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- (9) COLD FORM METAL STUD FRAMING CLIP, REFER TO STRUCTURAL DRAWINGS.
- (19) 1 1/2* (25 GA.) COLD FORM METAL Z-FURRING FRAMING AT 24* O.C. AND POLYISOCYANURATE (R-9 MIN.) RIGID INSULATION BOARD WITH FOIL FACE VAPOR BARRIER.
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- (18) SHEET METAL (24 GA.) FLASHING, COUNTER FLASHING, EDGES, DRIPS TRIM, CLEATS AND ACCESSORIES.
- (19) 5/8" EXTERIOR FIBERGLASS REINFORCED SHEATHING WITH CONTINUOUS WEATHER BARRIER. REFER TO STRUCTURAL DRAWING FOR ATTACHMENT REQUIREMENTS.
- (20) 5/8" TYPE "X" GYPSUM BOARD. REFER TO INTERIOR WALL TYPES FOR ADDITIONAL REQUIREMENTS.
- (21) SUSPENDED ACOUSTICAL LAY IN CEILING SYSTEM. REFER TO INTERIOR FINISH SCHEDULE FOR TYPES AND LOCATIONS.
- (22) FLOORING AND BASE, REFER TO INTERIOR FINISH SCHEDULE FOR TYPES AND LOCATIONS.
- (23) SEALANT WITH BACKER ROD (WHERE REQUIRED) TYPICAL AT OPENING PERIMETER JOINTS.
- (24) ALUMINUM WINDOW SYSTEM. REFER TO FLOOR PLAN AND WINDOW SCHEDULES FOR TYPES.
- SCHEDULES FOR TIPES.
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- (26) PRE-ENGINEERED METAL BUILDING PRIMARY AND SECONDARY STRUCTURAL FRAMING SYSTEMS.
- (27) PRE-ENGINEERED METAL BUILDING TRANSITION SUPPORT PLATE ASSEMBLY.
- $\begin{tabular}{ll} \begin{tabular}{ll} \beg$
- (29) PRE-ENGINEERED METAL BUILDING SHEET METAL FLASHING, COUNTER FLASHING, CONTINUOUS CLEATS, DRIPS CLOSURES, TRANSITIONS, COPINGS AND ACCESSORIES AS REQUIRED.
- (30) PRE-ENGINEERED METAL BUILDING GUTTER AND DOWNSPOUT SYSTEM, REFER TO EXTERIOR ELEVATIONS FOR LOCATIONS. REFER TO P.E.M.B. SHOP DRAWINGS FOR SIZES. PROVIDE CONCRETE SPLASH BLOCKS UNLESS OTHERWISE INDICATED.
- (31) SURFACE MOUNTED WALL SIGN, OWNER FURNISHED AND INSTALLED, (REFER TO SCOPE OF WORK SCHEDULE), PROVIDE BACKING AND ELECTRICAL ROUGH-IN, REFER TO ELECTRICAL DRAWINGS.
- $\ensuremath{\langle \mathfrak{D} \rangle}$ recessed lighting fixture, refer to electrical drawings for type and location.

PATRICK
G. BLEES
planning · interior design

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SEAL:



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10.14.16 DATE ISSUED

A-9014
REG. NO.

AREILY AUTO PARTS
712 GEORGE STREET
LA CROSSE, WI 54603


SHEET TITLE: WALL SECTIONS

REVISIONS:
NO: DATE: BY:

A3.2

SHEET 5 OF 10

opyright patrick G. Blees architect, PLLC 2011

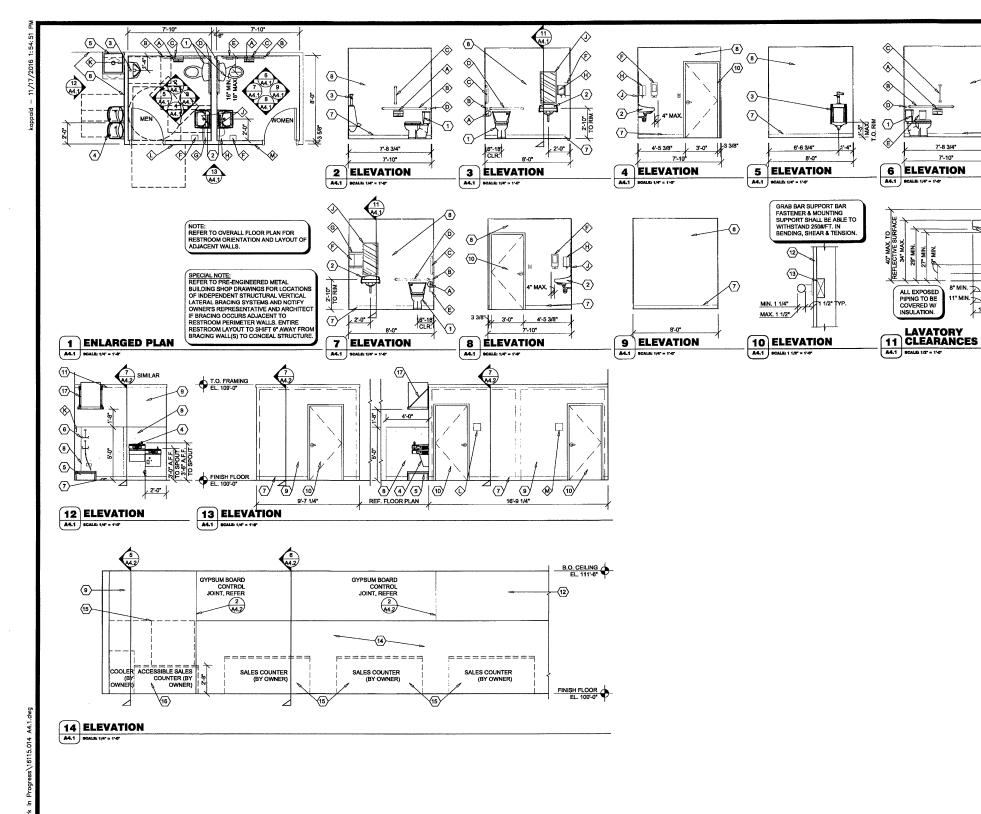

GENERAL NOTES

- (A) REFER TO PROJECT MANUAL FOR ADDITIONAL
- (B) LAYOUT DIMENSIONS OF PLUMBING FIXTURES AND ACCESSORIES TO FACE OF GYPSUM BOARD OR CENTER LINE OF FIXTURE. LAYOUT DIMENSIONS OF WALLS AND CELLINGS TO ROUGH FACE OF FRAMING, MASONRY, OR CENTER LINE OF STRUCTURE. ALL GYPSUM BOARD SIZE THICK UNLESS OTHERWISE INDICATED AND DIMENSIONS NOT SHOWN FOR CLAUDT.
- CD REFER TO PLUMBING DRAWINGS FOR FIXTURE TYPES AND ADDITIONAL REQUIREMENTS. PROVIDE ADDITIONAL COLD FORM METAL FRAMING OR FIRE TREATED BLOCKING AS REQUIRED FOR PROPER
- D REFER TO INTERIOR FINISH SCHEDULES FOR MATERIAL FINISH TYPES AND LOCATIONS.
- (E) ALL EXPOSED PIPING BELOW SINKS TO BE COVERED WITH INSULATION.

KEY NOTES

- (1) WATER CLOSET, ACCESSIBLE FIXTURE HEIGHT TO TOP OF SEAT TO BE 17" MINIMUM AND 19" MAXIMUM A.F.F.. ACCESSIBLE FIXTURE FLUSH CONTROLS TO BE ON WIDE SIDE OF TOILET.

7'-8 3/4"

7'-10*

B" MIN.

11" MIN.

- 3 WALL HUNG URINAL, MOUNT RIM 1'-5" MAXIMUM ABOVE
- 4 HIGH / LOW DRINKING FOUNTAIN WITH CANE GUARD. (5) FLOOR MOUNTED JANITOR SINK.

- **KEY NOTES**
- (6) EYE WASH STATION. INSTALL WITH TOP AT 48" ABOVE FINISH FLOOR.
- (7) BASE, REFER TO FINISH SCHEDULE.
- (B) SANITARY WALL PANEL SYSTEM, REFER TO FINISH SCHEDULE. PROVIDE TRIM AND EDGE MOLDING AROUND PERIMETER. ATTACH TO SUBSTRATE AS
- (9) PAINT, REFER TO FINISH SCHEDULE.
- (10) DOOR, REFER TO DOOR AND FINISH SCHEDULES.
- (11) WOOD TRIM, PAINT.
- (12) WALL CONSTRUCTION, REFER TO FLOOR PLAN FOR TYPES.
- (13) FIRE TREATED 2X WOOD BLOCKING.
- (14) WALL OPENING TO BEYOND, REFER TO FLOOR PLAN.
- (15) OWNER FURNISHED AND INSTALLED FURNISHING, SHELVING, OR FIXTURE. FOR REFERENCE ONLY (N.I.C
- (18) OWNER FURNISHED AND INSTALLED ACCESSIBLE CUSTOMER SERVICE COUNTER TO COMPLY WITH ACCESSIBLITY REQUIREMENTS, FOR REFERENCE CONTROL OF THE PROPERTY OF T ONLY (N.I.C.)
- (17) WALL MOUNTED WATER HEATER AND SUPPORT PLATFORM, REFER TO PLUMBING DRAWINGS. PROVIDE FIRE TREATED BLOCKING OR ADDITIONAL COLD FORM FRAMING AS REQUIRED FOR INSTALLATION.

ACCESSORY SCHEDULE


MK	DESCRIPTION	MANUFACTURER	SERIES / MODEL	MOUNTING LOCATION	ACCESSORY NOTES
♠	TISSUE PAPER DISPENSER	GEORGIA PACIFIC	COMPACT 56783	REFER PLANS, ELEVATIONS, LEGEND	NOTE 2
®	GRAB BAR	BOBRICK	B6806 x 48"	REFER PLANS, ELEVATIONS, LEGEND	
©	GRAB BAR	BOBRICK	B6806 x 18"	REFER PLANS, ELEVATIONS, LEGEND	
®	GRAB BAR	BOBRICK	B6806 x 36"	REFER PLANS, ELEVATIONS, LEGEND	
€	SANITARY NAPKIN RECEPTACLE	BOBRICK	B-270	REFER PLANS, ELEVATIONS, LEGEND	WOMEN'S RESTROOM ONLY
(F)	SOAP DISPENSER	GOJO	PRO 2000	REFER PLANS, ELEVATIONS, LEGEND	NOTE 2
©	PAPER TOWEL DISPENSER (MEN)	GEORGIA PACIFIC	59460	REFER PLANS, ELEVATIONS, LEGEND	NOTE 2
⊕	PAPER TOWEL DISPENSER (WOMEN)	GEORGIA PACIFIC	SOFPULL 52409	REFER PLANS, ELEVATIONS, LEGEND	NOTE 2
 <p< td=""><td>MIRROR</td><td>BOBRICK</td><td>B-165-1836 18" W X 36" H</td><td>REFER PLANS, ELEVATIONS, LEGEND</td><td></td></p<>	MIRROR	BOBRICK	B-165-1836 18" W X 36" H	REFER PLANS, ELEVATIONS, LEGEND	
⟨ €⟩	MOP HANGER	REFER TO PLUMBING DRAWINGS	REFER TO PLUMBING DRAWINGS	60" A.F.F. TO CENTER	REFER TO PLUMBING DRAWINGS
♦	DOOR SIGN (MEN)	ROCKWOOD	BF687	REFER PLANS, ELEVATIONS, LEGEND	WHITE TEXT ON BLAC BACKGROUND
ŵ	DOOR SIGN (WOMEN)	ROCKWOOD	BF688	REFER PLANS, ELEVATIONS, LEGEND	WHITE TEXT ON BLAC BACKGROUND

ACCESSORY GENERAL NOTES:

1. CONTRACTOR TO PROVIDE FIRE TREATED WOOD BLOCKING FOR INSTALLATION OF TOILET ACCESSORIES, INCLUDING OWNER FURNISHED AND CONTRACTOR INSTALLED ACCESSORIES. COORDINATE REQUIREMENTS WITH OWNER.

2. ACCESSORY OWNER FURNISHED AND CONTRACTOR INSTALLED. REFER TO SCOPE OF WORK SCHEDULE FOR ADDITIONAL REQUIREMENTS.


ACCESSORY MOUNTING LEGEND

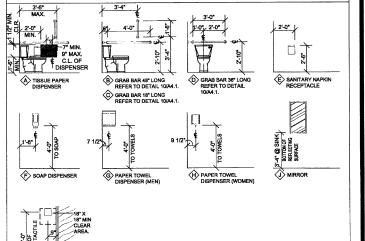

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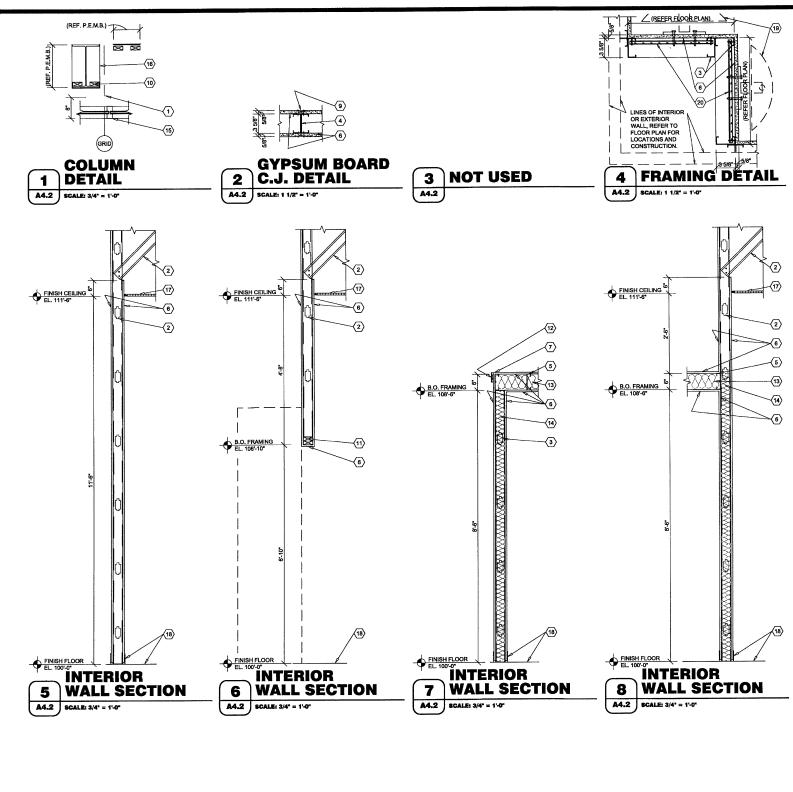
REVISIONS: NO: DATE:

PROJECT NO:

INTERIOR ELEVATIONS

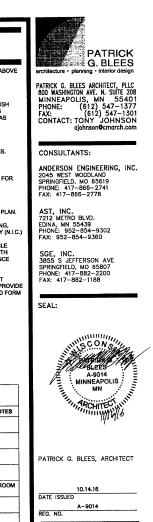TREET 54603

712 GEORGE SI LA CROSSE, WI



GENERAL NOTES

- (A) REFER TO PROJECT MANUAL FOR ADDITIONAL REQUIREMENTS
- B) DIMENSIONS ARE TO ROUGH FACE OF CONCRETE, MASONRY, FRAMING, OR CENTER LINE OF STRUCTURE UNLESS OTHERWISE INDICATED.
- © REFER TO INTERIOR FINISH SCHEDULES FOR MATERIAL TYPES, COLORS AND FINISHES.

KEY NOTES

- (1) PRE-ENGINEERED METAL BUILDING STRUCTURAL STEEL COLUMN, REFER TO P.E.M.B. SHOP DRAWINGS FOR ADDITIONAL REQUIREMENTS. PAINT (WHERE INDICATED).
- (2) 3 5/8" COLD FORM METAL FRAMING ATTACHED TO ROOF STRUCTURE, REFER TO STRUCTURAL DRAWINGS FOR FRAMING REQUIREMENTS.
- (3) 3 5/8" (20 GA.) COLD FORM METAL FRAMING AT 24" O.C., REFER TO INTERIOR WALL TYPES FOR ADDITIONAL REQUIREMENTS.
- 4 3 5/8" COLD FORM METAL STUDS DOUBLED AT CONTROL JOINT.
- $\overline{\left\langle 5\right\rangle }$ 6" (20 GA.) COLD FORM METAL JOIST FRAMING AT 24" O.C..
- 6 5/8" TYPE "X" GYPSUM BOARD. REFER TO INTERIOR WALL TYPES AND FOR ADDITIONAL REQUIREMENTS.
- (7) GYPSUM BOARD CORNER BEAD CONTINUOUS.
- B GYPSUM BOARD "J" MOLDING CONTINUOUS.
- B) GYPSUM BOARD CONTINUES ONE PIECE VEE-SHAPED SLOT CONTROL JOINT (1/4" X 7/16") AT BOTH SIDES OF WALL.
- 10 FIRE TREATED 2X NAILERS OR BLOCKING.
- $\langle \overline{11} \rangle$ (2) FIRE TREATED 2X NAILERS.
- (12) 1X4 WOOD TRIM (PAINT GRADE PINE) ATTACHED TO METAL STUD FRAMING WITH TECH 12 SCREWS AT 24" O.C. SET FLUSH. PAINT EXPOSED SURFACES TO MATCH WALL FINISH.
- (13) 6" UNFACED SOUND BATT INSULATION.
- $\overline{\left\langle 14\right\rangle}$ 3 1/2" UNFACED SOUND BATT INSULATION.
- (15) ALUMINUM WINDOW SYSTEM, REFER TO FLOOR PLAN AND WINDOW SCHEDULE FOR TYPES.
- (16) PRE-FINISHED SHEET METAL (24 GA.) COLUMN ENCLOSURE TO EXTEND THRU FINISH CEILING SYSTEM. COLOR TO MATCH WINDOW FRAMING FINISH. NO EXPOSED HORIZONTAL SEAMS PERMITTED.
- (17) SUSPENDED ACOUSTICAL CEILING SYSTEM, REFER TO INTERIOR FINISH SCHEDULE FOR TYPES AND LOCATIONS.
- (18) FINISH FLOORING AND BASE, REFER TO INTERIOR FINISH SCHEDULE FOR TYPES AND LOCATIONS.
- (19) OWNER FURNISHED AND INSTALLED FIXTURE, REFER TO INTERIOR FINISH PLAN FOR LAYOUT. (REFER TO SCOPE OF WORK SCHEDULE.)
- (20) 5/8° FIRE TREATED PLYWOOD BACKING TO BACK SIDE OF STUD INTERIOR FLANGE ON EACH EXPOSED WALL FACE FROM 8°4° TO 10°4° A.F.F. FOR INSTALLATION OF SECURITY MIRRORS (OWNER FURNISHED AND INSTALLED).



PATRICK G. BLEES

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CONSULTANTS:

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SGE, INC. 3855 S JEFFERSON AVE SPRINGFIELD, MO 65807 PHONE: 417-882-2200 FAX: 417-882-1188

SEAL:



PATRICK G. BLEES, ARCHITECT

10.14.16 DATE ISSUED

A-9014 REG. NO.

Reilly AUTO PARTS

SHEET TITLE: INTERIOR SECTIONS AND DETAILS

REVISIONS:									
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PROJE	CT NO:	16115.014							
DRAWN	BY:	KJ							

RIGHT PATRICK G. BLEES ARCHITECT, PLLC 2016

1 HEAD DETAIL A5.1 SCALE: 1 1/2" = 1'-0"

HOLLOW METAL DOOR AND FRAME SYSTEM, REFER TO DOOR SCHEDULE. SHIM AND ANCHOR PER MANUFACTURER'S RECOMMENDATIONS. PROVIDE (3) ANCHORS PER JAMB MIN. WITH REINFORGEMENT AT HAROWARE LOCATIONS. FILL FRAME CAVITY FULL WITH NON-EXPANSIVE FOAM-IN-PLACE INSULATION.

EXTERIOR CONCRETE MASONRY UNIT (CMU) WALL SYSTEM. REFER TO WALL SECTIONS.

CONCRETE MASONRY UNIT (CMU) JAMB UNIT, REFER STRUCTURAL DRAWINGS.

SEALANT BOTH SIDES (TYPICAL). PROVIDE FOAM INSULATION AT SHIM CAVITY.

FIRE TREATED 2X4 WOOD BLOCKING

1 1/2" (25 GA.) COLD FORM METAL Z-FURRING FRAMING AT 24" O.C. WITH 1 1/2" FOIL FACE POLYISOCYANURATE INSULATION (MIN R-9)

5/8" TYPE "X" GYPSUM BOARD.


JAMB DETAIL 2

A5.1 SCALE: 1 1/2" = 1'-0"

3 HEAD DETAIL

NOTE: FOR TYPICAL EXTERIOR WALL CONSTRUCTION NOTATION, REFER

A5.1 SCALE: 1 1/2" = 1'-0"

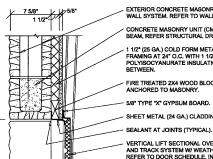

EXTERIOR CONCRETE MASONRY UNIT (CMU) WALL SYSTEM. REFER TO WALL SECTIONS. CONCRETE MASONRY UNIT (CMU) BOND BEAM, REFER STRUCTURAL DRAWINGS.

1 1/2" (25 GA.) COLD FORM METAL Z-FURRING FRAMING AT 24" O.C. WITH 1 1/2" FOIL FACE POLYISOCYANURATE INSULATION (MIN R-9) RETURED. FIRE TREATED 2X4 WOOD BLOCKING ANCHORED TO MASONRY.


- 5/8" TYPE "X" GYPSUM BOARD.

SHEET METAL (24 GA.) CLADDING.

VERTICAL LIFT SECTIONAL OVERHEAD DOOR AND TRACK SYSTEM W/WEATHER SEALS, REFER TO DOOR SCHEDULE INSTALL PER MANUFACTURER'S RECOMMENDATIONS. PROVIDE ADDITIONAL METAL FRAMING OR FIRE TREATED BLOCKING AS REQUIRED FOR

5 HEAD DETAIL

A5.1 SCALE: 1 1/2" = 1'-0"

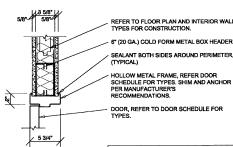

SPECIAL NOTE: UNLESS OTHERWISE INDICATED, KNOCK DOWN (KD) TYPE DOOR FRAMES ARE NOT PERMITTED.


HEAD DETAIL

A5.1 SCALE: 1 1/2" = 1'-0"



4 JAMB DETAIL

A5.1 SCALE: 1 1/2" = 1'-0"

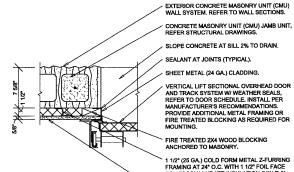


SEALANT AT JOINTS (TYPICAL). SHEET METAL (24 GA.) CLADDING. VERTICAL LIFT SECTIONAL OVERHEAD DOOR AND TRACK SYSTEM W/ WEATHER SEALS, REFER TO DOOR SCHEDULE. INSTALL PER FIRE TREATED 2X4 WOOD BLOCKING ANCHORED TO MASONRY.

1 1/2" (25 GA.) COLD FORM METAL Z-FURRING FRAMING AT 24" O.C. WITH 1 1/2" FOIL FACE POLYISOCYANURATE INSULATION (MIN R-9)

6 JAMB DETAIL

A5.1 | SCALE: 1 1/2" = 1'-0"

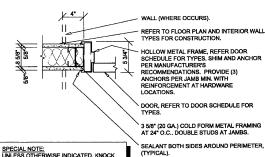

REFER TO FLOOR PLAN AND INTERIOR WALL DOOR, REFER TO DOOR SCHEDULE FOR 3 5/8" (20 GA.) COLD FORM METAL FRAMING AT 24" O.C., DOUBLE STUDS AT JAMBS.

WALL (WHERE OCCURS).

SPECIAL NOTE: UNLESS OTHERWISE INDICATED, KNOCK DOWN (KD) TYPE DOOR FRAMES ARE NOT PERMITTED.

8 JAMB DETAIL

A5.1 SCALE: 1 1/2" = 1'-0"

DOOR SCHEDULE

	DOOR					DOOR HARDWARE FRAME				DETAILS			FIRE	REMARKS (REFER	
MK	SIZE (W x H x D)	TYPE	SWING	MATERIAL	GLAZ. TYPE	SET #				HEAD WIDTH		JAMB	SILL	RATING	NOTES)
1	3'-0" X 7'-0" X 1-3/4"	Α	REFER TO FLOOR PLAN	ALUMINUM	1	1	A	1	ALUMINUM		4/A5.2	4/A5.2	5/A5.2		1, 2
1A	3'-0" X 7'-0" X 1-3/4"	Α	REFER TO FLOOR PLAN	ALUMINUM	1	7		1	ALUMINUM		4/A5.2	4/A5.2	5/A5.2		1, 2
2	3'-0" X 7'-0" X 1-3/4	В	REFER TO FLOOR PLAN	INSULATED METAL		2	А	2	INSULATED METAL	4"	1/A5.1	2/A5.1	5/A5.2 SIM.		1, 2, 3
3	6'-0" X 8'-0"	D	SECTIONAL OVERHEAD	INSULATED METAL		3			UFACTURER'S STANDARDS		5/A5.1	6/A5.1			1
4	3'-0" X 7'-0" X 1-3/4"	С	REFER TO FLOOR PLAN	SOLID WOOD		4		2	HOLLOW METAL		7/A5.1	B/A5.1			1, 4
5	3'-0" X 7'-0" X 1-3/4"	С	REFER TO FLOOR PLAN	SOLID WOOD		5		2	HOLLOW METAL		7/A5.1	8/A5.1			1, 4
6	3'-0" X 7'-0" X 1-3/4"	С	REFER TO FLOOR PLAN	SOLID WOOD		5		2	HOLLOW METAL		7/A5.1	8/A5.1			1, 4
7	3'-0" X 7'-0" X 1-3/4"	В	REFER TO FLOOR PLAN	INSULATED METAL		6		2	INSULATED METAL	4"	3/A5.1	4/A5.1	5/A5.2 SIM.		1, 3

OLES:
ALL DOORS SHALL BE SHOP PREPARED FOR HARDWARE.
ALL EXTERIOR DOORS TO BE KEYED ALIKE. CONTRACTOR TO FIELD VERIFY AND MATCH CORE OF DOOR MARKED "2".
EXTERIOR DOOR FAMME AND HARDWARE OWNER FURNISHED AND CONTRACTOR INSTALLED. REFER TO SCOPE OF WORK SCHEDULE.
EXTERIOR DOOR, FAMME AND HARDWARE OWNER FURNISHED AND CONTRACTOR INSTALLED. REFER TO SCOPE OF WORK SCHEDULE.
CONTRACTOR'S OPTION TO PURCHASE INTERIOR DOORS, FRAMES, AND HARDWARE THROUGH PREFERRED VENDOR. REFER TO SCOPE OF WORK SCHEDULE.


LOCKNET 100 COURCHELLE DRIVE NICHOLASVILLE, KY 40356 CONTACT: PAM PEEL PHONE 800-887-4307 EXT 133 FAX 859-881-5499

AA

SPECIAL NOTE:
UNILESS OTHERWISE INDICATED, KNOCK
DOWN (KD) TYPE DOOR FRAMES ARE NOT
PERMITTED.


DOOR TYPES

(SCALE 1/4" = 1'-0")

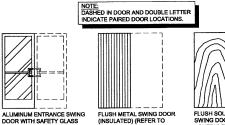




CC

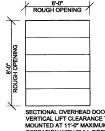

SECTIONAL OVERHEAD DOOR (INSULATED) WITH VERTICAL LIFT CLEARANCE TRACK SYSTEM MOUNTED AT 11'-0" MAXIMUM A.F.F.. MANUAL OPERATION WITH PULL ROPE, (REFER TO SCHEDULES FOR FINISHES)

D

FRAME TYPES

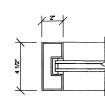

ALUMINUM ENTRANCE AND STOREFRONT FRAMING SYSTEM (THERMALLY BROKEN) WITH 1" INSULATED GLAZING.

REFER TO EXTERIOR FINISH SCHEDULES FOR FRAME COLORS AND GLAZING SCHEDULE FOR GLAZING TYPES.

REFER EXTERIOR AND INTERIOR FINISH SCHEDULES FOR COLORS

2

DOOR HARDWARE SCHEDULE

HARDWARE NOTES:

1. ALL HARDWARE TO BE ADA AND ANSI COMPLIANT.

2. VERIFY COMPATIBILITY OF HARDWARE SPECIFIED. NOTIFY ARCHITECT OF INCOMPATIBILITY ISSUES PRIOR TO ORDERING AND INSTALLATION.

SET NO. 1 (DR. 1)
1 CYLINDER: 20-062 X US26D - "E" KEYWAY (REMOVABLE CORE).....


DEADLOCK: MS1850S X US28...... DEADLOCK LEVER: 4550 X US28... STRIKE: MS4002 X US28. ADAMS R
SET PUSH/PULLS: 88-151 ULTRALINE W/ OFFSET PULL X US26D. EFGO
LCOSER: 40H-3077-181-17B X AL (ADJ. TO 8.5 LBS.) LCN
SET PERIMETER GASKETS: POLYMERIC BULB X LENGTH REQUIRED. PEMKO
SWEEP: 345AV X LENGTH REQUIRED. PEMKO SWEEP: 345AP X LENGTH REQUIRED.....
THRESHOLD: 270A X LENGTH REQUIRED (OFFSET PIVOT COMPATIBLE)

KICK PLATE: 190S X 8" X 34" X US32D.. THRESHOLD: 271A X LENGTH REQUIRED

SET NO. 3 (DR. 3)
REQUIRED HARDWARE FURNISHED WITH OVERHEAD DOOR SYSTEM (LOCKING FROM INSIDE ONLY)

SET NO. 4 (DR. 4) 3 HINGES: BB1279 X 4 1/2" X 4 1/2" X US26D.... 1 OFFICE LOCK: AU5307LN X US26D..... 1 WALL BUMPER: 409 X US26D..... ..HAGER ..YALE ..ROCKWOOD SET NO. 5 (DR. 5, 6) 3 HINGES: BB1279 X 4 1/2" X 4 1/2" X US26D.... PRIVACY LOCK: AU5302LN X US26D...... WALL BUMPER: 409 X US26D..... | SET NO. 6 (DR. 7)
| 3 HINGES: ECBB1100 X 4 1/2" X 4 1/2" X US32D X NRP. |
| 1 EXIT ONLY PANIC LOCK: 8300B X 486 X 689. |
| 1 CLOSER: 5300MLT X ALM (ADJ. 10 8.5 LBS.) |
| (THROUGH SEX BOLT MOUNTING). |
| 1 SET PERIMETER GASKETS: JAMBS - KERFED QEBD-500, HEADER - COST 878. | ..HAGER SET PERIMETER GASKE IS: "MYNOUS TO THE SET OF THE

(SCALE 3" = 1'-0")

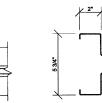

WELDED HOLLOW METAL FRAME (16 GA.) WITH (3) MIN. ANCHORS PER JAMB, (1) AT EACH JAMB SILL, AND ADDITIONAL ANCHORS AT HARDWARE LOCATIONS.

(B) REFER TO BUILDING CODE SUMMARY FOR PROJECT STRUCTURAL DESIGN CRITERIA. DOOR FRAMING AND ANCHORING SYSTEMS SHALL BE DESIGNED BY MANUFACTURER TO CONFORM TO PERFORMANCE AND TESTING REQUIREMENTS SPECIFIED.

GENERAL NOTES

 $\overline{\langle {\sf A} \rangle}$ REFER TO PROJECT MANUAL FOR ADDITIONAL REQUIREMENTS.

C REFER TO FLOOR PLAN, ELEVATIONS, AND SECTIONS FOR ADDITIONAL

(D) REFER TO EXTERIOR AND INTERIOR FINISH SCHEDULES FOR COLORS, PERIMETER SEALANT COLOR TO MATCH FRAME COLOR UNLESS OTHERWISE INDICATED.

Chelly:

SHEET TITLE: DOOR SCHEDULE

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PATRICK G. BLEES, ARCHITECT

A-9014

2 GEORGE STREET CROSSE, WI 54603

10.14.16 DATE ISSUED

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CONSULTANTS:

REVISIONS: NO: DATE: PROJECT NO: 16115.014

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SHEET 8 OF 10

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GENERAL NOTES

 $\overline{\left\langle \mathbf{A} \right\rangle}$ REFER TO PROJECT MANUAL FOR ADDITIONAL REQUIREMENTS.

B REFER TO BUILDING CODE SUMMARY FOR PROJECT STRUCTURAL DESIGN CRITERIA. WINDOW FRAMING AND ANCHORING SYSTEMS SHALL BE DESIGNED BY MANUFACTURER TO CONFORM TO PERFORMANCE AND TESTING REQUIREMENTS SPECIFIED.

© REFER TO FLOOR PLAN, ELEVATIONS, AND SECTIONS FOR ADDITIONAL REQUIREMENTS.

 $\langle \overline{D} \rangle$ WINDOW TYPE ELEVATIONS SHOWN VIEWED FROM EXTERIOR SIDE.

(E) REFER TO EXTERIOR FINISH SCHEDULES FOR ALUMINUM WINDOW FRAMING COLORS, PERIMETER SEALANT COLOR TO MATCH WINDOW FRAMING COLOR UNLESS OTHERWISE INDICATED.

(F) ALL DIMENSIONS TO ROUGH FACE OF FRAMING UNLESS OTHERWISE INDICATED. FIELD VERIFY FINAL ROUGH OPENINGS PRIOR TO FABRICATION.

G REFER TO DOOR AND HARDWARE SCHEDULES FOR ADDITIONAL REQUIREMENTS.

(H) SECURITY SHUTTERS MAY BE REQUIRED. CONTACT PROJECT ADMINISTRATOR FOR VERIFICATION, (REFER TO SCOPE OF WORK SCHEDULE). PROVIDE ADDITIONAL SUPPORT FRAMING SYSTEM AS REQUIRED.

WHEN WIND SPEED IS EQUAL TO OR GREATHER THAN 120 MPH, A STORM PANEL SYSTEM SHALL BE OWNER FURNISHED AND INSTALLED CONTACT PROJECT ADMINISTRATIOR TO VERIFY AND COORDINATE WITH SYSTEM PROVIDED BY OTHERS, (REFER TO SCOPE OF WORK SCHEDULE) PROVIDE ADDITIONAL SUPPORT FRAMING SYSTEM AS REQUIRED.

(J) CONTRACTOR'S OPTION TO DIRECT ORDER AND PURCHASE WINDOW FRAMING SYSTEM AND GLAZING FROM THE FOLLOWING SUPPLIER (REFER TO SCOPE OF WORK SCHEDULE):

COULTER & COMPANY 13711 E. 66TH ST. N. OWASSO, OK 74055 PHONE: (918) 272-4494 FAX: (918) 272-7908 EMAIL: coulter-co@earthlink.r CONTACT: BRENDA OR KEN

GLAZING SCHEDULE

1* INSULATED SAFETY GLAZING
(1/4* PPG "SOLEXIA" EXTERIOR PANE / 1/4* CLEAR INTERIOR PANE)
(SHADING COEFFICIENT 0.57

1" INSULATED SAFETY GLAZING (1/4" CLEAR EXTERIOR PANE / 1/4" CLEAR INTERIOR PANE) SHADING COEFFICIENT 0.81

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10.14.16 DATE ISSUED A-9014 REG. NO.


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SHEET TITLE: WINDOW SCHEDULE

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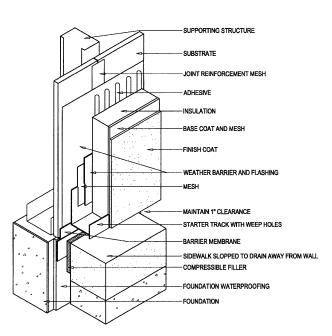
SHEET 9 OF 10



- NRCA RECOMMENDS PENETRATIONS SHOULD NOT INTERFERE WITH PANEL SEAMS OR OCCUR AT TRANSVERSE SEAMS.
 FIFELD PANELS OVERLEA AT THE FENETRATION, ATTACHMENT OF THE DOWN SLOPE PANEL. ALONG ITS UP SLOPE END MAY BE NECESSARY.
 VENT STACKS AND OTHER PIPES SHOULD HAVE DEFOUNTED CLEARANCE ON ALL SIDES FROM WALLS AND OTHER PROJECTIONS TO FACILITATE PROPER PLASHING AND PANEL DRIVINGS.
- PROPER FLASHING AND PANEL DRAINAGE. PEG, SPECIFIC HIGH-TEMPERATURE BOOTS SHOULD BE USED. 1 VASCA BETABRIER AND THERMAL BLOCKS FOR ROOF SYSTEM ARE NOT SHOWN FOR CLARITY

1 VENT THRU ROOF DETAIL

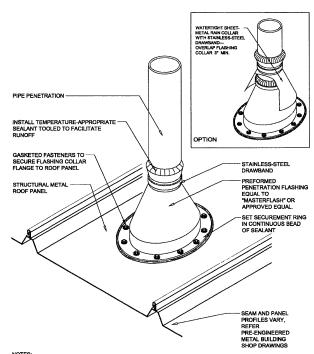A6.1 SCALE: N.T.S.




NOTE:
REFER TO SECTIONS AND DETAILS FOR WALL
CONSTRUCTION ASSEMBLIES AND NOTATION.

<u>NOTES:</u>

1. INSTALLATION TO BE COMPLETED IN ACCORDANCE WITH MANUFACTURER'S SPECIFICATIONS.


EIFS TERMINATION DETAIL

A6.1 SCALE: N.T.S.

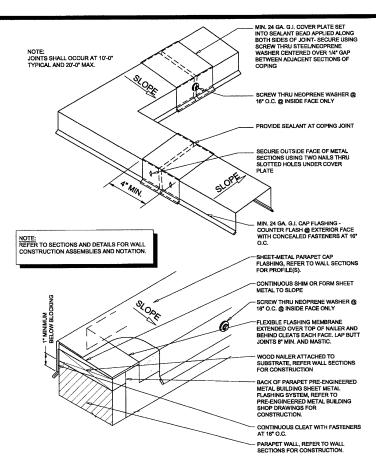

TYPICAL COPING FLASHING DETAIL


A6.1 SCALE: N.T.S.

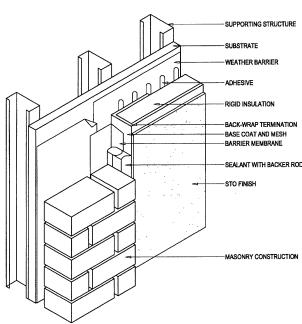

5 EIFS TERMINATION DETAIL

GENERAL NOTES

(B) SHEET METAL AND ROOFING CONSTRUCTION SHALL COMPLY WITH NATIONAL ROOFING CONTRACTORS ASSOCIATION (NECA) AND SHEET METAL AND AIR CONDITIONING CONTRACTORS NATIONAL ASSOCIATION (SMACNA) DESIGN STANDARDS AND RECOMMENDATIONS.

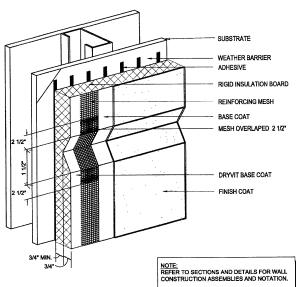

NOTES:

1. INSTALLATION TO BE COMPLETED IN ACCORDANCE WITH MANUFACTURER'S SPECIFICATIONS.

3 | EIFS DECORATIVE JOINT DETAIL

A6.1 SCALE: N.T.S.

(A) REFER TO PROJECT MANUAL AND SCOPE OF WORK SCHEDULE FOR ADDITIONAL REQUIREMENTS.

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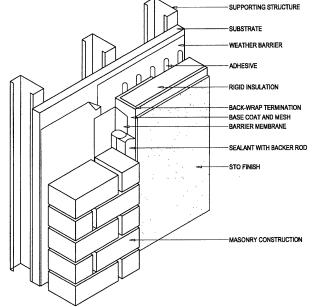
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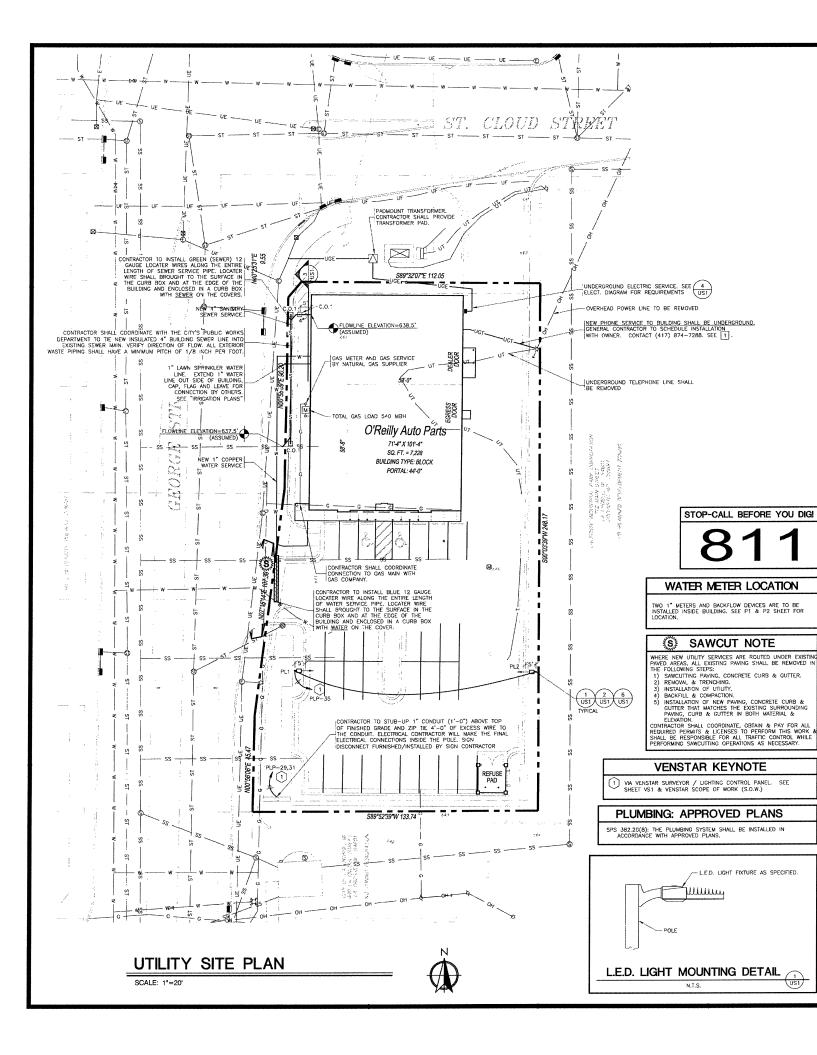



NOTE: REFER TO SECTIONS AND DETAILS FOR WALL CONSTRUCTION ASSEMBLIES AND NOTATION.

NOTES:

1. INSTALLATION TO BE COMPLETED IN ACCORDANCE WITH MANUFACTURER'S SPECIFICATIONS.

A6.1 SCALE: N.T.S.



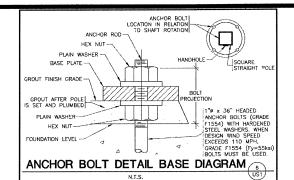


NOTE: WHENEVER WATER AND SANITARY SEWER PIPES ARE WITHIN TEN (10) FEET OF EACH OTHER, THE BOTTOM OF THE WATER PIPE SHALL BE INSTALLED A MINIMUM OF ONE (1) FOOT ABOVE THE TOP OF THE SANITARY SEWER PIPE. TAPE (SPEC 26 05 53) ₹ 52 --- WATER PIPE ~ 1/2" LIMESTONE GRAVEL -- SEWER PIPE WATER/SEWER SEPARATION DETAIL

NOTE: WHERE CROSSING OTHER UTILITIES MAINTAIN 12" CLEARANCE DETECTABLE PLASTIC WARNING 122 SELECTED BACKFILL - CLEAN GRAVEL UNDER PAVEMENT. 24" MIN. FOR SECONDARY ELECTR. & TELE. SERVICES 48" MIN, FOR PRIMARY ELECTRICAL SERVICES ELECTRICAL CONDUIT(S). SEE PLAN(S) FOR QTY. REQ'D. **®**--3" MIN. -~ 2* MIN. BETWEEN CONDUITS

UNDERGROUND ELECTRICAL CONDUITS N.T.S.

DETECTABLE PLASTIC WARNING TAPE (SPEC 26 05 53). VERIFY THE MINIMUM INSTALLATION DEPTH W/LOCAL AUTHORITIES. PIPE INSTALLATION DETAIL

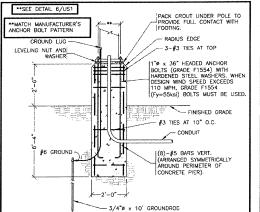

CONCRETE POLE BASE DETAIL

N.T.S.



I HEREBY CERTIFY THAT THESE ENGINEERING DOCUMENTS WERE PREPARED BY ME OR UNDER MY DIRECT PERSONAL SUPERVISION AND THAT I AM A DULY LICENSED PROFESSIONAL ENGINEER UNDER THE LAWS OF THE STATE OF MISCONSIN.



LICENSE RENEWAL DATE IS JULY 31, 2018

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NEW UTILITIES



BORE

ENSTERNMENT .

P.O.C. = POINT OF CONNECTION BETWEEN SITE PIPING (SPEC 02700) AND BUILDING IRRIGATION)

DESTRUCTION OF CRAVEL

EXISTING CONDITIONS NOTES

- THE CONTRACTOR IS OBLIGATED TO INSPECT FOR EXISTING CONDITIONS/INSTALLATIONS AND AVAILABLE INFORMATION PRIOR TO SUBMITTING A BID, REFER TO SPECIFICATIONS ALSO.
- EXISTING INSTALLATIONS (SUCH AS WATER MAINS/LINES, GAS MAINS/LINES, SEWER MAINS/LINES, TELEPHONE LINES, POWER LINES, AND UTILITY STRUCTURES IN THE VICINITY OF THE WORK TO BE DONE) ARE INDICATED ON THE DRAWINGS ONLY TO THE COURSE OF THE ACCURACY OR COMPLETENCSS OF SUCH INFORMATION, AND ALL RESPONSIBILITY FOR THE ACCURACY AND COMPLETENCSS THEREOF IS EXPRESSLY DISCLAIMED.
- THE CONTRACTOR SHALL BE SOLELY RESPONSIBLE FOR LOCATING ALL EXISTING INSTALLATIONS.
- ANY DELAY, ADDITIONAL WORK, FEES OR EXTRA COST TO THE CONTRACTOR CAUSED BY OR RESULTING FROM DAMAGE TO OR MODIFICATION OF EXISTING INSTALLATIONS BY THE CONTRACTOR OR AFFECTED UTLINY COMPANY SALLA NOT CONSTITUTE A CLAIM FOR EXTRA WORK, ADDITIONAL PAYMENT OR DAMAGES.
- THE CONTRACTOR SHALL FIELD VERIFY ALL EXISTING CONSTRUCTION PRIOR TO SUBMITTING HIS BID. NO EXTRAS WILL BE PAID DUE TO UNANTICIPATED EXISTING

■ TELEPHONE SERVICE REQUIREMENTS

SPECIAL NOTE: <u>NEW PHONE SERVICE TO BUILDING SHALL BE AN UNDERGROUND SERVICE</u> CONTRACTORS TO SCHEDULE INSTALLATION OF U/G TELEPHONE SERVICE CONDUIT WITH OWNER. CONTACT (417) 874-7288.

" PVC SCHEDULE 40 CONDUIT WITH RIGID GALVANIZED STEEL LONG SWEEP BENDS @ 8-24" DEPTH FOR PHONE SERVICE. PROVIDE MINIMUM 1/4" POLYPROFILENE PULL INE. PLACE CONDUIT A MINIMUM OF 12" FROM U/G ELECTRIC CONDUIT IN SAME

CAP END OF CONDUIT AT PROPERTY LINE BELOW FINISHED GRADE AND INSTALL CABLE MARKER FOR PHONE COMPANY, IF NECESSARY. OTHERWISE, CONTINUE PHONE SERVICE CONDUIT TO A POLE AND INSTALL RIGID GALVANIZED STEEL CONDUIT A MINIMUM 10' (4. ABOVE FINISHED GRADE ATTACHED TO POLE.

CONTRACTOR SHALL COORDINATE INSTALLATION AND VERIFY REQUIREMENTS WITH PHONE COMPANY, PLUS INCLUDE ALL FEES (IF ANY) BY PHONE COMPANY FOR INSTALLATION OF

COMPANY, PLUS INCLUDE ALL FEES (IF ANY) BY PHONE COMPANY FOR INSTALLATION (
NO LESS THAN 10 PAIR CABLE, IN AMENIONED CONDUIT, TO CONTRACTOR INSTALLED 4' X 6' X 3/4"
FIRE RETARRING BACKBOARD (IF PLYWOOD, PAINT BOARD W/FIRE RETARDING PAINT)
WITHIN BUILDING CONTRACTOR TO PROVIDE #6 AWG CU, GROUND TO TELEPHONE
EQUIPMENT LOCATION FROM ELECTRICAL GROUNDING ELECTRODE SYSTEM. FINAL
CONNECTIONS AND INSIDE PHONE WIRING BY OWNER.

ONLY IF UNDERGROUND PHONE SERVICE IS NOT AVAILABLE—THEN MAY CONTRACTOR INSTALL APPROPRIATE OVERHEAD PHONE SERVICE RISER, WEATHER HEAD, ETC. COORDINATE WITH OWNER & PHONE CO.

GENERAL NOTE:

PRIOR TO INSTALLATION, GENERAL CONTRACTOR SHALL CONFIRM THAT LIGHT POLES, LANDSCAPING AND UTILITIES DO NOT CONFLICT WITH SIGN LOCATION SHOWN. IF ANY POTENTIAL CONFLICT IS DISCOVERED, GENERAL CONTRACTOR SHALL CONTACT THE O'REILLY PROJECT ADMINISTRATOR BEFORE PROCEEDING.

UTILITIES CONTACTS:



CONTRACTOR CAUTION!!! VERIFY SEWER LINE ELEVATION

BEFORE STARTING ANY BUILDING PAD GRADING AND PLUMBING WORK, THE CONTRACTOR SHALL FIELD VERIFY LOCATION, MATERIAL CONDITION, ACCESSIBILITY (INCLUDING STATE HIGHWAY OR OTHER CONDITION, ACCESSIBILITY (INCLUDING STATE HIGHWAY OR OTHER CONTRACTOR OF THE CONTRACTOR OF T RIGHTS-OF-WAY) AND WORKABLE FLOW LINE ELEVATION OF THE EXISTING SANITARY SEWER SERVICE LINE OR MAIN.

IF A WORKABLE FLOW LINE HAS NOT BEEN ESTABLISHED AT THE TIME OF FINAL SANITARY SEWER SERVICE CONNECTION, THEN THE CONTRACTOR SHALL BE RESPONSIBLE FOR ALL EXPENSES ASSOCIATED WITH THE INSTALLATION OF A NEW GRINDER "PUMP SYSTEM EQUAL TO "ENVIRONMENT ONE" #DH152
PHONE: 518-346-6161 TO MEET OWNER AND LOCAL
REQUIREMENTS.



PATRICK G. BLEES

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CONTACT: TONY JOHNSON ajohnson@cmarch.com



SEAL:



11/11/16 DATE ISSUED

PARTS

AUTO

STREET 54603 710 GEORGE S LACROSSE, WI

SHEET TITLE:


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Reilly

UTILITY SITE

PROJECT NO: LW	NO:	DATE:	BY:
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SHEET 1 OF 2



SITE LIGHTING PHOTOMETRICS

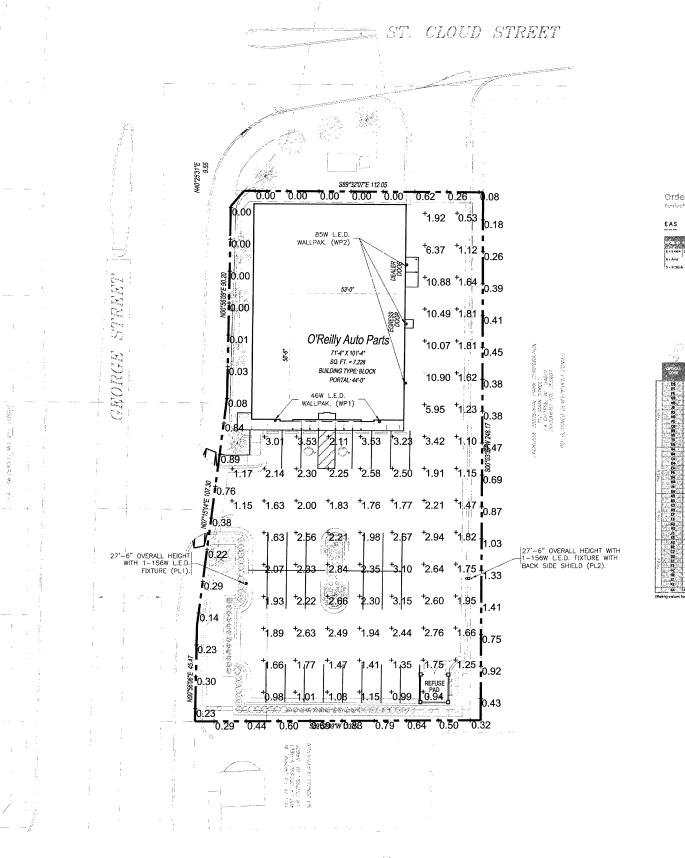SCALE: 1"=20'

EXTERIOR LIGHT FIXTURE SCHEDULE ATTN: SANDI YOUNG — DIRECT LINE: (314) 573-208
KATHY SCHRUMPF — DIRECT LINE: (314) 573sandra.young@graybar.com or Kathy.Schrumpf@grayba TOLL FREE: (800) 289-5: TOLL FREE FAX: (888) 280-0 CATALOG NUMBER LED EXTERIOR LIGHTS EWNA-0-A4-5-40-1-DKBZ NO SUBSTITUTIONS GE EVOLVE 120 DARK BRONZE X WP2 GE EVOLVE LED POLE LIGHTS PL1 | GE EVOLVE | EASC-0-G4-F-5-40-1-A-DKBZ | SECURITY LTC. | SSS-25-50-1-A2-DB-LAB (DRILED FOR 1 LG) 25' POLE LENGTH, ADVANCE BALLASTS, FULL CUT-OFF, NO SUBSTITUTIONS, ANCHOR BOLTS W/HARDWARE & TEMPLATE 25' POLE LENGTH, ADVANCE BALLASTS, FULL CUT-OFF, N SUBSTITUTIONS. ANCHOR BOLTS W/HARDWARE & TEMPLATE WITH BACK SIDE SHIELD ELS-EASX-FBL-BLCK GE EVOLVE EASC-0-G4-F-5-40-1-A-DKBZ PL2 SECURITY LTC. SSS-25-50-1-A2-DB-LAB (DRILLED FOR 1 LGT.)

Ordering Humber Logic C = BE D = Derming B-13 On Liquid T F = 07 130 - 127 F F = 7 100 - 120 F S = 7 100 F 0 = 120 - 73 1 = 120* 2 + 208* 3 + 250* 4 = 277* 5 = 490* D = 347* H = 247-466 *'picify angle voltage i hase 5.90 (1997) (199 EASC F3FSS0 JE EASC GPSS9 K EASC H3FS90 KE

AUTOMATIC LIGHTING CONTROL

COMPLIANCE WITH ENERGY CODE IS ACHIEVED BY: ONCE THE VENSTAR EMS HAS BEEN PROGRAMMED, THE INTERIOR AND EXTERIOR LIGHTS WILL TURN ON AND OFF USING THE FOLLOWING LOGIC: SEE SHEETS VS1, VS2 AND VS3

EXTERIOR SIGN LIGHTS WILL TURN ON WHEN ITS DARK ENOUGH OUTSIDE ANYTIME DURING STORE HOURS, AND WILL TURN OFF AT STORE CLOSING.

FOR NEW CONSTRUCTION LOCATIONS ONLY, THERE IS A TEMPORARY PROGRAM TO KEEP SIGN AND SITE LIGHTS ON UNTIL MIDNIGHT RATHER THAN THE TIMES INDICATED ABOVE. O'REILLY WILL DISABLE THIS PROGRAM ONE YEAR AFTER STORE OPENING.

RESTROOMS AND OFFICES: ALL LIGHTING IN THESE AREAS ARE CONTROLLED BY OCCUPANT-SENSING DEVICES.

Ordering Number Logic Evens LED Victorock Nissnes (EWIDA)

E - Scolve A - Photography 0
Series A 1
2 0 = 123-27 1 = 123* 2 = 208* 3 = 340* 4 = 277* 5 = 690* H= 347-487V D= 347* N - Housing Sicres Forting leads will be provided through the back of the arm unless specified with A or E FE Function
 R.S. Hilliagness can hall be purchased together. *Specify single veltage celly if fuse option is selected PE control not ovaloble for 347-480V Must be a decrete v-Roge (347) or 4804

	and outer	1	1110	10.00				2.00
		Maria	en tres	geric'i	A CONTRACTOR OF THE PERSON NAMED IN	New York	400	
Augment of Females	3.730	3750	MENTAL THE	MARIN SERVICE	1-0-1	1.01	EVINA_PAGES120-277/162	50°44_A4650120-2170°E3
Augmentic Forward	5510	5540	65	, 65	142	102	EWN4 84540 -120-277/1ES	RATIA_84550120-277/195
Apartments Forward	7,180	7,210	25	1 35	102	162	ENNA CASAD JES	BANNA_CASSO_IES
Assurance of Forward	£310	8650	1 //4	104	102	1-0-2	FWING EASAQ JES	BANN, CASSO_IES
Augment of Forward	16,370	10,410	: 23	123	202	2-0-2	EWAN, E4540ES	ENNA_E4550E5
Asarrentec Forward	12,320	12,360	148	149	2-0-3	2-03	EWNA F4543_JCS	CMNA_F4530KS
Agummetric Wide	4,076	4090	46	, 46	101	101	BATA A 1540 -120-277/1ES	FANA_A3590120-277/0E5
Asymmetric Wide	6.019	5040	65	E	1 101	161 !	EVNN_E3549123-277V:H5	EANN \$3550120-227/063
	7,830	7,860	35	85	142	1-02	PANA_C3540IES	FAMA_CLESQ_JES
	9,520	9699	100	154	282	2.67	FWHA TOKED IKE	PANK 07556_IPS
	: 11329	11,360	123	1 123	. 282	3-0-2	EWMA_E3SA9JE3	EWNA_E3750 KS
Anameric Vide	13450	13,500	, 146	148	202	5-0-5	EMIA F2S40_JES	ENNA F3550_JES
Asummetric Norrow	3,940	3960	46	46	141	1-0-1	EWING A2540120-277/165	EMIN_42550120277, IFS
Accordate Norma	5820	5950	65	65	141	1.01	EWNA 82540120-27*/TES	ENNA_82550126-27741ES
Assemble Namou	7.500	7420	35	85	242	2-0-2	ENTIA_C2540ES	PANA COSSO_JES
Augmenetric Narrow	9310	9,390	302	194	202	2-0-2	EWIND DISACTIFS	EMMA_02550_JES
Asymptodite Nation	11960	note	125	123	20.2	202	LWMA LESAD JES	ENNA_E2000_JES
Assummatric Nomale	13020	13,969	245	148	242	2/52	FAMILA FESSAD_JES	EMMA_F2ESO_JES
	Aggreette Freezel Aggreette Wel- Aggreette Berow Aggreette Berow Aggreette Berow Aggreette Berow	Ingranet formul 550 Sapranet formul 750 Sapranet formul 750 Sapranet formul 750 Sapranet formul 357 Sapran	Symmetrie Free 5510 \$450 \$450 \$450 \$450 \$450 \$150	Improvest Control 550 55	Suprestic Found 550 550 65 65	Represent Found 550 550 55 65 65 52 52 53 65 65 65 65 65 65 65	Supremic Forms 530 520 65 65 10.2 10.2	Buryantic Front 550 550 65 542 142 500.6 [2002.] 2027/015

Nominal Hominal Shaft Mounting Length Shaft Dis. Trickress Type

Catalog Rumber	AND VALUE	- Shart	70	80	90	100				Test City	Box >q.	Base Purce	Anchor Bott	1	MARK.
	ft en	Dim.	MPH	MPH	13.71	MPE	MPH	Thick	(Seg.)		1	(14)	Size	200	((tb))
SSS-10-40-1-XX-XX	70 3.6	1	25	25	22	127	11.6	1.119	112			10.25 . 0.75.	.3/4 x 30 x 3°	1 - 1	91
555-10-50-1-XX-XX	10 3.0	5	75	25	25	23	25	1.115	111	10 - 13.5	7.1 - 0.5	12 x 1	3/4 x 30 x 3"	14.	106
SSS-12-40-1-XX-XX	12 3.1	4	25	21	16	13.0	8.8	1.119	111	8-11	5.6 - 7.8	10.25 × 0.75	3/4 × 30 x 3"	4	104
555-12-50-1-XX-XX	12 3.7	3*	25	25	23	18	11.8	.119	11	10 - 13.5	7.1 - 95	12 × 1*	3/4 x 30 x 3*	4-	122
\$\$\$-14-40-1-XX-XX	14 4.3	1 4	24	18	3.21	11.0	6.6	1.110	22	5 11	5.6 - 7.8	30.25 x 0.75	3/4 x 30 x 1	9.	116
555-14-40-7-XX-XX	36 4.3	1	25	25	3	18	12.2	.179	41	8 1/2 - 12	6 8.4	11×1	3/4 x 30 x 3	4	158
SSS-14-50-1-XX	14 4.5	1 5	25	24	19	14.4	9.0	.113	21	10 - 13.5	7.1 - 9.5	. 12 x 1"	3/4 x 30 x 5	47	.138
535-16-40-1-XX-XX	16 14.9	4*	16	12.2	9.0	5.6	3.5	.119	11	8 - 11"	5.6 - 7.8	10.25 x 0.75	3/4 x 30 x 3"	6"	178
\$\$\$-16-40-7-XX-XX	16 4.9		25	20	15	12.2	7.6	.179"	111	8 175 - 15	6 8.4	:1 x 1"	3/4 x 30 x 3	4	276
SSS-16-50-1-XX-XX	16 4.5	3,0	22	16	12.2	9.2	5.2	1.119	1 23	10 - 13 5	7.1 - 9.5	12 > 1*	3/4 x 30 x 3"	151	153
SSS-16-50-7-XX-XX	36 4.5	3	25	23	24	19	12.4	.179*	21	20 - 13.5	7.1 9.5	12 7 1	3/4 x 30 x 3"	14	214
555-18-40-1-XX-XX	28 5.5	3.7	13.8	10.0	7.2	5.7	2.4	1.119	31	8 1/2 - 12	5.8 - 7.8	10.25 × 0.75	3/4 x 30 x 3	1471	147
SSS-18-40-7-XX-XX	38 5.3	1	23	1.17	13.0	10,0	6.0	470	111	10 - 13.5	7.1 - 9.5	7.11x1%	3/4 x 30 x 3°	151	501
555 18-10-1-XX-XX	38 5.5	1.050	18	13.2	9.6	7.0	134	.119	11	10 13.5	7.1 - 9.5"	12×1	3/4 x 30 x 3	4	175
535-18-50-7-XX-XX	18 18.3	2.5	25	- 25	20	16	9.8	179	31.	. 10 - 13.5"	6 - 8.4	12 x 1	3/4 x 30 x 3	1.51	243
\$\$\$-20-40-1-XX-XX	20 6.1	1 4	17.4	8.0	5.6	3.8	1.4	.119	11	8 - 11"	5.6 - 7.8	10.25 × 0.25	3/4 x 10 x 3"	14	160
SSS-20-40-7-1X-XX	20 6.1	4"	19	14.5	10.8	8.0	4,4	.179	110	B 1/2 - 12"	4 - 5.4	31 x 1"	3/4 x 30 x 3°	4	225
555-20-50-1-XX-XX	20 6,1		15	10.8	7.6	5.2	2.0	1,110	11,	10 - 13.5	7.1 9.5	12 , 1"	3/4 x 30 x 3	151	191
555-20-50-7-XX-XX	20 6.1	1 50	2.5	23	17	13.2	7.6	.179	11'	10 - 15.5	7.1 - 9.5"	12 x 1*	3/4 x 39 x 3*	14	264
555-20-60-7-XX-XX	20 6.1	3	25	25	24	28	11.2	.179	12"	11 - 13.5	7.8 - 9.5	12 × 1*	1 x 36 > 4"	14	312
555-25-40-1-XX-XX	25 7.6		7.0	4.2	2.2	MR	MR.	-119	23"	8~11	5.6 - 7.8	10.25 x 0.75	5/4 x 50 x 3	4	190
555-25-40-7-XX-XX	25 7	1	13.4	9.4	6.4	4.2	1.4	170	11	8.5 - 12"	6-84	11 × 1'	3/4 x 30 x 3"	4.1	266
SSS-25-50-1-XX-XX	25 7.6	51 5	2.6	8,0	3.4	3.4	NR.	1.217	11	10 - 13.5	7.1 . 9.5	12 x 1	1 x 36 x 4"	151	231
\$\$\$-29-50-7-XX-XX	25 7.6	5 5	22	15	11.2	7,8	3.4	1.179	112	10 - 13.5	.7.1. 0.5	12 * 1	1x36x4		324
\$\$\$-25-50-3-XX-XX	25 7.4	5	25	53	. 1.6	12.4	6.6	250	11	10 - 15.5	7.1 - 9.5	12 x 1	1 x 36 x 4"	14	437
355-25-60-7-XX-XX	25 7.5		25	22	16	11.6	5.6	.179	12	11 ^ 13.5"	7.8 - 9.5	12 x 1	1×36×4	14-1	404
555-27-40-7-XX-XX	27 8.2		12.4	7.8	5.0	3.0	HR	175	11"	8.5 - 12*	6 - 8.4	21 x 1	1x36x4"	141	290
555-30-40- <i>1</i> -XX-XX	30 9.1		8.2	5.0	2.8	1.2	HR.	179	11	8.5 - 12	6 - 8.4	11 × 1	123614		313
555-30-50-7-XX-XX	30 9.1	5	14.2	9.4	6.0	3.4	HR.	1,279	11,	10 - 13.5	7.1 9.5	K-12 K1	1 x 36 x 4"	1.1.1	398
SSS-30-50-3-XX-XX	30 9.1	100	20	14,6	122	6.8	24	250	1.11	10 - 13.57	7.1 9.5	12.81	1 x 36 x 4"	141	537
555-30-60-7-121-12	30 9.1		20	12.8	9.2	9.8	1.2	1.179	12"	11 - 13.5	7.8 - 9.5	17 x 1	3×36×4	141	467
555-30-60-7-XX-XX	30 9.1	6	25	24	W	12.6	6.2	.250	12	11 - 13.5	7.8 - 9.5	12 x 3"	1.25 x 42 x 6"	1.41	630
SSS-35-60-7-XX-XX	35 10.	7 6	14.2	8.4	4.6	1.6	NA	1.279	12	11 - 13.5	7.8 - 9.5	12 × 1°	1 x 36 x 4"	14.1	528
\$\$\$-35-60-3-XX-XX	35 10.	7 6	25	17	11.6	7.4	1.8	.250	12	11 - 13.5	7.8 9.5	12 x 3*	1.25 × 42 × 6	14	726
555-40-60-1-XX-XX	40 12	. 6	9.0	4.0	M.	NR.	MR	:179	12	11 + 13.9	7.8 9.5	12×1	1 x 36 x 4"	151	614
\$\$\$-40-60-3-XX-XX	40 12.	2 6	18	11.8	66	3.2	THE T	.250	11	11 - 19.5	7.8 - 9.5	12×1	1.25 x 42 x 6'	141	502

Movemble CPM volts 1.7 good tector. For determine exist, spok stoping wrought, wrotely selectable EPP by 20 fbs.
NOTE: Factory expected template about his used when secting access battle Holdest Eighting with damy any clean for it.

	YTHIG TYPE	FOR	H2	OP TH			
AT	Side - Sincie	DB	Dark Bronze	065	Intornal Coating (Hubbell Seat)		Follow the logic below when ordering location specific notions.
T.	Side - Double at 90°	FI.	Black	018	29 Amp GFCI Receptable		For each colors, include its
T,	Side - Double at 180°	WH	Withillo		and Cower		orientation (in degrees) and its
W.	Skde - Triple at 90°	GR	Gray	022"	Extra Handhele	-	height die feets Example: Oction (2% should be ordered as:
X	Side - Quad at 90°	PS	Platnum Silver	026	.5' Coupling		\$25-39-40-4-78-08-026-4-15
P1 -	Pad Moust - Spider Type	RD	Red (Premium Color)	927	.75" Counting		15" couples on the handhole/arm
2	Fad Mount - Yoke Type	PG	Forest Green (Premium Color)	636,	2" Coupling		ade of pole. 15 teet up from the
7	Pad Mount - Yoke Type	CC	Custom Color (Consult Factory)	032"	Mic-pole Luminaire Bracket	_	pole bases
	Grotormar XI. only)	PR	Primer Only	041	1st mode vibration democr	. 17	1' specing required between option. Conset factors for other
A	Tenon (2.375" 00)			042	2nd mode wistellion damper	. 1	configurations.
TR	Terror (2.875" 00)		LL PATTERNS: Region X yells	LAB	Less Anchor Bolls	117	
TR'	Renovable Yeron	- 1:	Specified Services with a straight pair (4-both) Concern CP1 MTV and Years Genes harvelving			15	
	Q.375 x 4.25)	4.0	MS & C3 kinesing			liter	one of applica for facts
CD	Concord Luttinaire		Spanding Colors II innuntries,			- 11	180*
FT	No shifting fincludes pole capt	2 Rec	months bear used in contraction with orde arm a			111	I
- ~	7		Execution followed by the "TR" potymon, Everyte	355-23-4	1-7- (5-18-0)	:11	N.1.01
1 2		j ''≫	city sphere becames using traje found on come."			ρĺ	90° ()
٩٩	Coo To A C	3 00 - 2	- Depoirs handhold location			11	630
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Due 1	o our continued efforts to imp	rove our	products, product specifications	ale en	рієст 10 спарде милот погиз		promentar.

DEPENDENTS One to our continued officin to improve our products, product specifications are subject to change without ordica.

O 2015 SPELING LECTOR, All Equa hoursels for one otherwise ried or winds: were unauddisplaying

PATRICK G. BLEES

PATRICK G. BLEES, ARCHITECT 800 WASHINGTON AVE. N. SUITE 208 MINNEAPOLIS, MN 55401 PHONE: (612) 547-1370 FAX: (612) 547-1301

CONTACT: TONY JOHNSON



SEAL:



11/11/16 DATE ISSUED

> Reilly AUTO PARTS STREET 54603 710 GEORGE S LACROSSE, WI

SHEET TITLE: SITE LIGHTING PHOTOMETRICS

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3 T | SHEET 2 OF 2

	PLUMBING FI	XTURE SCH	HEDULE / SPEC	C. 22 00 00 & 22 40 00	/ ALI	_ FIXT	URES	& FITTINGS MUST I	BE "LEAD F	REE"	PIPING LEGEND	GAS LOAD (PIPE SIZING BASED ON INTERNATIONAL	LICENSED PLUMBER
MARK	DESCRIPTION	MANUFACTURER	CATALOG NUMBER	ACCESSORIES		G REQUIRE		REMARKS	APPROVED MANUFACTURER'S	CODE APPROVALS	WS WATER SERVICE (BELOW GRADE) HIW HOT WATER CW COLD WATER	FUELGAS CODE, TABLE 402.4(2)) ITEM MBH/INPUT ROOFTOP UNIT (RTU-1) 1B0	NO PERSON MAY ENGAGE IN OR WORK AT PLUMBING IN THE STATE UNLESS LICENSED TO DO SO BY THE DEPARTMENT PER S.146.06, STATS.
H.W.C.	HANDICAP ACCESSIBLE WATER CLOSET	AMERICAN STANDARD	CADET RIGHT HEIGHT BOWL RIM @ 16-1/2" H PRESSURE-ASSISTED TOILET	CHURCH 9500CT WHITE OPEN FRONT SEAT	4"	2*	1/2"	LOW-CONSUMPTION 1.6 GPF MAX. MEETS ADA GUIDELINES	ZURN, ELJER	ANSI A117.1, ADA COMPLIANT	S WASTE	ROOFTOP UNIT (RTU-2) 180 ROOFTOP UNIT (RTU-3) 180 TOTAL CONNECTED LOAD 540	PLUMBING: APPROVED PLANS
LAV.	(TANK TYPE) HANDICAP ACCESSIBLE LAVATORY (WALL MOUNTED)	AMERICAN STANDARD	2467.016 LUCERNE 0355.012 4" CENTERS	ZURN #Z8737 FLAT GRID SINKSTRAINER, DELTA #501-DST CLASSIC CENTERSET FAUCET, JAY R. SMITH #0700-M31 FLOOR MOUNTED	2"	1-1/2"	3/4"	SEE NOTE 2. 1.5 GPM MAX.	ZURN, ELJER WADE	ANS A117.1 ASME A1112.18.1, ASME A112.18.2, ADA	GS GAS SERVICE (BELOW GRADE) WATER HAMMER ARRESTER, SEE SCHEDULE FLOOR DRAIN, SEE SCHEDULE CLEANOUT (INTERIOR), SEE SCHEDULE	GAS PIPING SIZED USING LONGEST MAXIMUM RUN OF EQUIVALENT LENGTH OF PIPING = 150'-0" INLET PRESSURE = 7in W.C. OR 1/4 psig MAXIMUM PRESSURE DROP = .5 INCH	SPS 382,20(8): THE PLUMBING SYSTEM SHALL BE INSTALLED IN ACCORDANCE WITH APPROVED PLANS.
M.V.	THERMOSTATIC MIXING VALVE	WATTS	#LFMMV-M1-US-1/2"	LAVATORY SUPPORTS IN WALL. THERMOSTATIC MIXING VALVE	-	-	1/2"	SEE DETAIL 3/P2 & NOTE #4. 110'F MAX. WATER TEMP.	WILKINS, POWERS	COMPLIANT ASSE 1070, IAPMO, ADA COMPLIANT, CUPC, NSF/ANSI 61	o CLEANOUT (EXTERIOR), SEE SCHEDULE	W.C. AND .6 SPECIFIC GRAVITY	
H.D.F.	BARRIER-FREE TWO STATION HI-LO DRINKING FOUNTAIN	ELKAY	EZSTLBLC	ACCESSORY APRON #LKAPREZL	2"	1-1/2"	1/2"	UPPER HEIGHT 40" A.F.F. LOWER HEIGHT 33" A.F.F.	HALSEY TAYLOR	ADA COMPLIANT		NOTE: SEE THE APPLICABLE PLUMBING CODE FOR MINIMUM WASTE PIPING SLOPE.	
F.D. F.S.	FLOOR DRAIN FLOOR SINK	ZURN ZURN	ZN415-B-P FD2378-NH2-H	1/2" TRAP PRIMER CONNECTION 8 SQ. TOP, 6" DEEP, LITE COMMERICAL	2" 2"	1-1/2"	-	COMBINATION WASTE VENT 1/2 GRATE	WADE & JAY R. SMITH	ASSE 1019-B			
C.O.	CLEANOUT (INTERIOR)	JAY R. SMITH	4100	W/CARPET CLAMPING RING WHERE REQUIRED	SEE PLAN	-	-	SAME SIZE AS LINE	WADE & ZURN	-			
C.O.1	CLEANOUT (EXTERIOR)	JAY R. SMITH	4250	-	SEE PLAN	-	-	SAME SIZE AS LINE. SEE DETAILS 1/P1 & 2/P2.	WADE & ZURN JAY R. SMITH.	-		100	
W.H.A.	WATER HAMMER ARRESTER	SIQUX CHIEF	652-A	-		-	3/4"	W/VACUUM BREAKER.	WADE, ZURN	-	1 2	3	4
H.B.	HOSE BIB	WOODFORD	MODEL 65	W/WALL CLAMP	_	-	3/4	OPERATING ROD ASSEMBLY MUST BE ORDERED PER WALL WIDTH. W/VACUUM BREAKER ON FAUCET.	-	-			
М.В.	MOP BASIN	FIAT	FIAT MSB-2424	FIAT #832-AA HOSE & BRACKET, FIAT #889-CC-24" MOP HANGER, ZURN #Z842M4-WHK-5H SERVICE FAUCET	3"	1-1/2"	3/4"	ALSÓ ADD HOSE CONNECTION VACUUM BREAKER (WATTS #8) ON FAUCET'S SPOUT	HAWS & ZURN	ASME A112.18.1-2000	SEE ENLARGED SUPPLY PIPING PLAN (THIS SHEET) FOR SUPPL' PIPING FOR REST ROOM	,	
E.W.	EYE WASH	SPEAKMAN	SEF-9200	SPEAKMAN THERMOSTATIC MIXING VALVE (SEF-TW)	-	-	3/4"	SET MIXING VALVE TO DELIVER 80dgF. NOTE: TEPID WATER RANGE IS 60—100dgF.	HAWS	CSA B125-98, ANSI Z358-1, INTEGRAL VACUUM BREAKER, ASSE 1011	A		INSIALLED AS HIGH AS POSSIBLE AND ROUTED WHERE SHOWN AD THE
URN.	URINAL (WALL MOUNTED)	ZURN	Z5755-U OMNI-FLO	SLOAN ROYAL #186-1 FLUSH VALVE, JAY R. SMITH SERIES #600 FLOOR MOUNTED URINAL SUPPORT	2"	1-1/2"	3/4"	1.0 GPF	KOHLER, ELJER & CRANE	ASME A1212.19.2, ANSI A117.1, ADA COMPLIANT	SEE UTILITY R.R. SITE PLAN FOR THE CONTINUE TO		-
2. SINKS EQUAL 3. FOR H	. TO "McGUIRE" #PW 2150 W	APPED ACCESS SHALL I VC, WHITE MOLDED CLO NTER CLOSET. FURNISH	BE INSTALLED W/OFFSET TAIL SED CELL VINYL, OR "TRUEB & INSTALL W/THE FLUSH H	PIECES. ALL SINK & LAVATORY DRAIN & WATER RO" #103W, WHITE MOLDED VINYL. ANDLE ON THE WIDE SIDE OF THE RESTROOM.	LINES SHAL	L BE INSUL	ATED W/PR	DTECTIVE DEVICES			CONTINUATION I H.W.C OF D. C.O.		WHA HB.
	PPLIED, CONTRACTOR INSTALL		HC MIXING VALVE.								103 VRN. VRN.	3/4"	H.B.
w.H.	WATER HEATER (ELECTRIC)	A.O. SMITH	EJCS-20	(19 GALLONS) 120V 10, 1.65 KW ELEMENT WITH T & P RELIEF VALVE	-	-	3/4"	PIPE DRAIN LINE FROM P & T RELIEF VALVE DOWN IN SHELF PAN. SEE DETAIL 5/P2 & 6/P2	NO SUBSTITUTIONS	CSA, ASME RATED, NAECA	FLOOR SINK FOR DRAIN LINE WATER RECEPTOR SEE IRRIGATION PLAN FOR CONTINUATION 7 ES C.O. H.D.F.		
SHELF	WATER HEATER SHELF	HOLDRITE QUICK STAND	#40-SWHP-WM	SUPPORTS WATER HEATERS UP TO 20 GALLON OR 300 LBS	-	-	-	PIPE DRAIN LINE FROM SHELF PAN SEE DETAIL 5/P2 & 6/P2	NO SUBSTITUTIONS	-	← Z IR 1 1 T T T T T T T T T T T T T T T T T	RTU-3	(a)
T.E.A.	THERMAL EXPANSION ABSORBER	AMTROL	ST-12	-	-	-	-	-	NO SUBSTITUTIONS	-	→ ¬ ws → ¬ s d s d s d s d s d s d s d s d s d s		
SHALL BE I RELEASED I	TER, SHELF AND T.E.A. DIRECT ORDERED AND OR FROM THE LISTED EQUIPMENT DISTRIBUTOR:			GRAYBAR ELECTRIC CO. INC. 11885 LACKLAND ROAD ST. LOUIS, MO 63146				ATTN: SANDI YOUNG — DIRECT LINE KATHY SCHRUMPF — DIRECT sandra.young@graybar.com or Kathy. TOLL F TOLL FREE	LINE: (314) 573-2084		SEE UTILITY SITE PLAN FOR CONTINUATION FOR CONTINUATION OFFICE	ן יבן פרו י	RTS AREA TO'
							1				B	1-1/4 NSTALLER	B B
			EFER TO ARCHITECTURAL PLA						s w	OTE: ROUTE 1" C.W. PIF HUT-OFF VALVE(S) EXP ALL. SECURELY FASTEN ACKFLOW DEVICE(S) &	ING TO METER(S) & DOSED ON INSIDE OF VALVE(S), METER(S),	<u> </u>	
3. PIPING UNDER ABOVE	MATERIAL SHALL BE AS FOI RGROUND WATER SERVICE GROUND HOT & COLD WATE	LLOWS: (SPEC 22 00 00) ER PIPING — (SPEC 22	2 00 00)) NOTED ON THE COVER SHEET.					Ľ	WALL AS REQUIRED. S		Ö	T_RTU1
4. VALVES	S ON WATER LINES SHALL B BE THE SAME SIZE AS THE	E BRONZE BALL VALVE IR INLET PIPING. (SPE	C 20 05 00)	JURISDICTION. E OR GLOBE VALVES. VALVES TRAPS, TAILPIECES, TRIM, ETC.				104 R.R.		FOR	CONTINUATION R AND SERVICE	1-1/4" RTU-2 G G G G G G G G G	
6. THE C	22 40 00) CONTRACTOR SHALL COOPERATIONS HIS WORK. COOPERATION	TE WITH ALL OTHER CO	ONTRACTORS & SUBCONTRACT					H		BY NATURAL APPLY PROTECTIVE	GAS SUPPLIER COATING PER UNIT TO MATCH		INSTALL CAS PIPING THRU ROOFTOP UNIT BASE AS REQUIRED. THE CONTRACTOR SHALL SUPPLY AND
8. DO NO PLAN.	OT INSTALL CAPPED AIR CHAN ARRESTERS ARE TO BE RAI OT & COLD WATER SURPLY	MBERS AT FIXTURES. I TED FOR INSTALLATION PIPING CONNECTION TO	EMENT THEREOF IS SPECIFICA INSTALL WATER HAMMER ARRI IN CONCEALED LOCATIONS. (FIXTURES ARE TO BE 1" UN	ESTERS AS CALLED FOR ON (SPEC 22 00 00)				LAV.		WATER LINE TO BE HIGH AS POSSIBLE	BUILDING. INSTALLED AS AND ROUTED WHERE SHOWN		INSTALL NECESSARY PIPING INCLUDING A PRE-ASSEMBLED, BLACK STEEL MANUAL SHUT-OFF VALVE (WITH 1/8"NPT PRESSURE TAP), ELBOWS AND UNION, THIS ASSEMBLY WILL REQUIRE
10. PLUMB "N.E.C. 11. <u>INSTAL</u> 12. CONTR	BING PIPING SHALL <u>NOT</u> BE I ." COORDINATE ELECTRICAL L PIPE INSULATION ON ALL MACTOR SHALL COORDINATE W	NSTALLED ABOVE ELECT PANEL LOCATIONS W/ DOMESTIC WATER LINES (ITH ALL STATE & LOCA	FRICAL PANELS. PROVIDE RE THE ELECTRICAL CONTRACTOR ABOVE FINISH FLOOR (SPEC AL BUILDING REGULATION AGE	COUIRED CLEARANCES PER R. 2. 22 07 19). CNCIES & UTILITY COMPANY(S) IN				3/4" 00000	>		III III III III III III III III III II	<u>└-</u> -	AS LINE TO RUN INSIDE THE UIUILINE AND INSTALLE TYPICAL. UIUILINE AND INSTALLED AS HIGH AS OSSIBLE, ROUTE WHERE SHOWN,
0F TH 13. PROVID 14. IT IS 1	IE WORK. DE CHROME ESCUTCHEON CO THE CONTRACTOR'S RESPONS	VERPLATES AT ALL PIP	E PENETRATIONS OF FINISHEI WATER PIPING AROUND SPAC	EQUIRED FOR THE PERFORMANCE D WALL SURFACES. ES W/ TEMPERATURES BELOW R PIPING OCCURS IT SHALL BE				W.H.A.			** ** *** *** *** *** *** *** *** ***		# = # = # = # = #
THE C ORIGIN 15. ALL CA	ONTRACTOR'S RESPONSIBILITY IALLY SERVED BY THE FROZE AULKING ON BUILDING PENET	TO REPAIR THE PIPIN IN PIPING. TRATIONS SHALL BE A	G THRU A NON-FREEZING SI 1-COMPONENT NON-SAG URING WILL BE REQUIRED TO R	PACE TO THE FIXTURE/APPLIANCE ETHANE SEALANT. ANY								this programmer to the second	
SPECIF 16. PLUMB REQUIF	FIED SEALANT (SPEC 07 92 BING SUB-CONTRACTOR SHALL REMENTS OF ALL PLUMBING	00). L INFORM THE ELECTRI EQUIPMENT TO BE INST	CAL SUB-CONTRACTOR OF TI					5 103 R.R.	Ш				
18. ALL W	ATER HEATERS & HOT WATER AS REQUIRED BY CODE.	R STORAGE TANKS SHAI	LL HAVE A DRAIN VALVE INST	TALLED AT THE BOTTOM OF THE				5-3/4" W.H.J	-1/2"		 -3/4"		+-+-+
Civieries	D CRADE 24" SC	" / 1	G.C. TO REV	IEW METAL BUILDING RAWINGS BEFORE				cw61"	3/4" SEE PLAN CONTINUAT	FOR ION		Γ	
1	D GRADE	CONCRETE	PAD CONSTRUCTION ANY ROD BE	ON BEGINS TO CONFIRM THAT RACES SHOWN IN THOSE ILL NOT INTERFERE WITH				O'É.W.			₩,HA,		
5" MIN.		FEMALE ADAP	FIXTURES SH	. ACCESSORIES OR PLUMBING IOWN IN REST ROOMS. G.C. 'YEILLY REPRESENTATIVE AND F THEY BELIEVE THAT THERE		3/4"		M.B. 6 5 P2 P2 P2		'			- C
	Ĭ	(ISOLATED FRI HOUSING)	MIGHT BE A A CONFLICT, AGAINST EXT	CONFLICT. IF THERE IS SUCH INSTALL 6" STUD WALL ERIOR WALL TO ENCAPSULATE		SEE CON	PLAN FOR TINUATION.	<i>f</i> — <u>a</u>					į
		REFER TO E 2/P2 FOR OF PIPE.	RODS (PLUM SIZE OPPOSITE EX	BING FIXTURES AND WALL KTERIOR WALL TO SHIFT TO THIS 6" WALL AS WELL.		N	D.C		MIN 72 - 4	N.I.		(3)	4
8_	TYPICAL EXT	S FRIOR						D SUPPLY PIP	ING PLA	<u> </u>		LUMBING PLAN	
	CLEANOUT DI				SC	ALE: 3/8"	= 1:-0"					ALE: 1/8" = 1'-0"	— (1)
<u> </u>	N.1.J.	$\overline{}$											FIN

PATRICK G. BLEES nning · Interior design

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11/11/16 DATE ISSUED



PLUMBING PLAN

REVIS	SIONS:	
NO:	DATE:	BY:
_		
		<u> </u>
_		
PROJE	CT NO:	LW2
ORAWN	BY:	LRB

P1

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PLUMBING PIPE MATERIALS:

- A. The following applications are for <u>inside, below & above the building slab</u> and ending at a point 5'-0" outside the perimeter building walls.

- Domestic Water Distribution Piping Below Ground: All interior domestic water piping shall be type "K" hard drawn copper tubing (SIL—FOS 2, FOS—FLO 7 or other silver brazing material). This is required for the water service line from the shut—off valve in the building to a point 5 feet outside the building.
 Domestic Water Distribution Piping Above Ground: Hard copper tube, Type L
 Soil, Waste, and Vent Piping Below Ground: Schedule 40 poly vinyl chloride (PVC) plastic DWV pipe;
 Noil, Waste, and Vent Piping Above Ground: Hubbess cost—iron soil pipe or Poly vinyl chloride (PVC) plastic DWV pipe
 Note: PVC piping is not permitted in air—handling ceiling spaces, use only cast—iron or ductile iron pipe in these locations.
- B. The following applications are for only from 5'-0" outside the building to the utility point of connection (POC).

Underground domestic water service piping from a point 5 feet outside the building to the POC.

(See Site Utilities Plon for which piping material (Copper or PVC) is required):

1. %" - 1 ½', Schedule 40 PVC pipe with solvent-weided pionts.

2. 1 ½' - 3', SDR-21, PVC pipe (ASTM D2241) Class 200, Bell and Spigot with rubber gasketed joints.

3. %" - 3', Type "%" hard drawn copper utbing (SLI-FOS 2, FOS-FLO 7 or other silver brazing material).

4. * and larger, SDR-18 PVC pipe (AWWA C-900) Class 150 Bell and Spigot with rubber gasketed joints.

- Underground sanitary sewer service piping from a point 5 feet outside the building to the POC. 1. Polyvinyl chloride (PVC) sewer pipe shall conform to ASTM D3034 (SDR-35). 2. Cost iron or ductile iron pipe shall conform to USASI #A-21 class 50.

- C. GAS pipe material:


 Low_Pressure Gas Systems, above Ground within or outside Building:


 Use the following:


 1. 2 Inches and Smaller: Steel pipe, malleable_iron, threaded fittings, and threaded joints.


 2. 2_1/2 Inches and Larger: Steel pipe, butt_welding fittings, and welded joints.


PROJECT:	D'REILLY	AUTO PART	rs					
PLUMBING	CALCULA	TION						
FIXTURE		QUANTITY	TOTAL-SFU	TOTAL	TOTAL-HW	TOTAL	DFU	TOTAL
W.C.	(TANK)	2	5	10	0	0	4	8
URN. (L	RINAL)	1	5	5	0	0	4	4
LAV. (LAV	ATORY)	2	2	4	1.5	3	2	4
M.B. (MOP	BASIN)	1	3	3	1.5	1.5	2	0
H.D.F. (FO	UNTAIN)	1	0.25	0.25	0	0	0.5	0.5
H.B. (HO	SE BIB)	2	3	6	0	0	0	0
			TOTAL	28.28	TOTAL	4.5	TOTAL	18.5

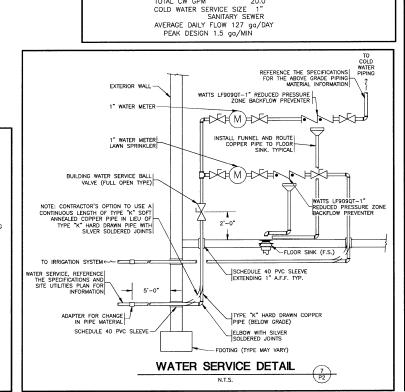


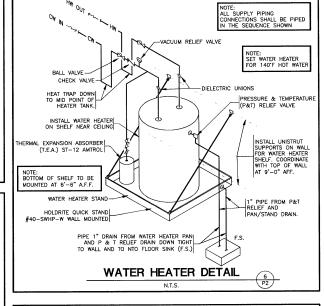


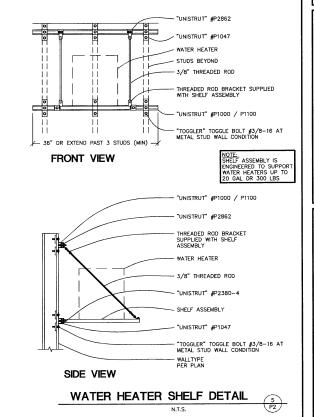

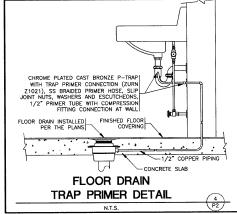

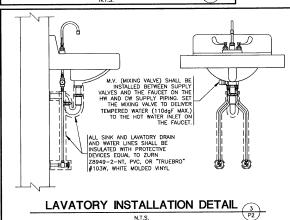

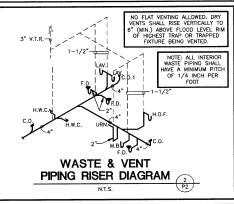

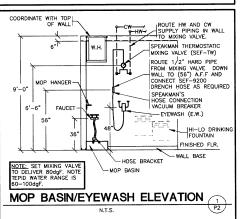



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CONTACT: TONY JOHNSON



SEAL:




11/11/16 DATE ISSUED

> 710 GEORGE S' LACROSSE, WI **Greily:**

SHEET TITLE: PLUMBING SCHEDULES

REVISIONS: NO: DATE: PROJECT NO: DRAWN BY:

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1-	Demand of building in water supply fixture units (WSFU);	(WSFU)22	.25
1.a.	Demand of building in WSFU converted to Gallons Per Minute: (Table SPS 382.40-3)		20
2-	Elevation difference from main or external pressure tank to build		1
3-	Size of water meter (when required) 5/8"3/4" 1"	X other	
4-	Developed length from main or external pressure tank to buildin	g control valve; (feet)_	
5-	Low pressure at main in street or external pressure tank.	(psi) _	
	CULATE WATER SERVICE PRESSURE LOSS nnecessary for internal pressure tanks)		
6-	Low pressure at main in street or external pressure tank. (value	of # 5 above)	
7-	Determine pressure loss due to friction in1 inch diame	eter water service.	
	Water service piping material is Copper		
	Pressure loss per 100 ft. = 13.6 X 1.3 (dec	imal equivalent of	
	service length, i.e. 65 ft = 0.65)	Subtract value of "7" _	17.
	•	Subtotal	72.
8-	Determine pressure loss or gain due to elevation, (multiply the value of # 2 above by .434)	Subtract value of "8"	4.:
9-	Available pressure after the bldg. control valve.	Subtotal _	67.
CAL	CULATE THE PRESSURE AVAILABLE FOR UNIFORM LOSS (VA	ALUE OF "A")	
B.	Available pressure after the bldg. control valve. (from "9" above) Value of "B" _	67.
C.	Pressure loss of water meter (when meter is required)	Subtract value of "C"_	
		Subtotal _	63
D.	Pressure at controlling fixture*.		
	(Controlling fixture is: Urinal).	Subtract value of "D" _	
	(*Contolling fixture is the fixture with the most demanding pressure to operate properly which includes the following when determining fixture performance; loss due to instantaneous water heaters, water	Subtotal	48
	treatment devices, and backflow preventers which serve the controlling fixture)	
E.	Difference in elevation between building control valve		
	and the controlling fixture in feet; 3 X .434 psi/ft.	Subtract value of "E"	
		Subtotal _	4

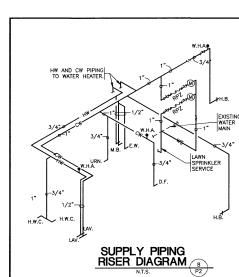	alc Worksheet	O'Reilly Auto Parts - La Crosse, WI Name of Project		
F.		due to water treatment devices and backflow e controlling fixture. (Water softeners, filters, etc.		
	(Pressure loss	due to; Backflow	.).	
	F1. WSFU Do	wnstream of Water Treatment Device;	22.25	
	F2. Convert w	sfu to GPM using Table 382.40-3:	20	
		or sfu to GPM using Table 382.40-3e* ual dwellings only)	<u>N/A</u>	
		anuf. graph to obtain pressure loss:	12	
	(If no water tre	eatment device enter "0")	Subtract value of F4	12.0
			Subtotal	34.7
G.		through tankless water heaters, combination exchangers which serve the controlling fixtur		
G.	heaters, heat e Hot water WSI Refer to manu	exchangers <u>which serve the controlling fixtur</u> FU's; <u>N/A</u> convert to; GPM = facturer's pressure loss graph to determine to	e; N/A (Table 382.40-3) loss at the required GPM;	
G.	heaters, heat e Hot water WSI Refer to manu	exchangers which serve the controlling fixture. FU's; N/A convert to; GPM =	e: N/A (Table 382.40-3) loss at the required GPM; Subtract value of "G"	
G.	heaters, heat e Hot water WSI Refer to manu	exchangers <u>which serve the controlling fixtur</u> FU's; <u>N/A</u> convert to; GPM = facturer's pressure loss graph to determine to	e; N/A (Table 382.40-3) loss at the required GPM;	
G. H.	heaters, heat e Hot water WSI Refer to manu N/A pre	exchangers which serve the controlling fixtur FU's; N/A convert to; GPM = facturer's pressure loss graph to determine the sessure loss. gth from building control valve to controlling.	e: N/A (Table 382.40-3) loss at the required GPM; Subtract value of "G" Subtotal	34.
	Hot water WSf Refer to manu N/A pre	exchangers which serve the controlling fixtur FU's; N/A convert to; GPM = facturer's pressure loss graph to determine the sessure loss. gth from building control valve to controlling.	8: N/A (Table 382.40-3) loss at the required GPM; Subtract value of "G" Subtotal	34. ⁻ 178.
	Hot water WSf Refer to manu N/A pre	exchangers which serve the controlling fixtur FU's; N/A convert to; GPM = facturer's pressure loss graph to determine the sessure loss. gth from building control valve to controlling.	E: N/A (Table 382.40-3) loss at the required GPM; Subtract value of "G" Subtotal Divide by value "H"	34. 178. 0.194280
	heaters, heat e Hot water WSI Refer to manu N/A pre Developed len fixture in feet	exchangers which serve the controlling fixtur FU's; N/A convert to; GPM = facturer's pressure loss graph to determine the sessure loss. gth from building control valve to controlling.	E: N/A (Table 382.40-3) oss at the required GPM; Subtract value of "G" Subtotal Divide by value "H" Subtotal Multiply by:	178. 0.19428



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11/11/16 DATE ISSUED



SHEET TITLE:


PLUMBING DETAILS

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NO:	DATE:	BY:
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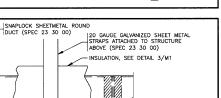
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SHEET 3 OF 3

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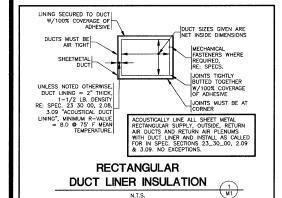
ROUND DUCT WRAP INSULATION N.T.S.




ALL TRANSVERSE DUCT JOINTS SHAL BE SEALED WITH DUCT SEALANT

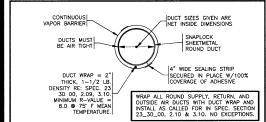DUCT SEALANT SHALL BE OF THE ROUND DUCT





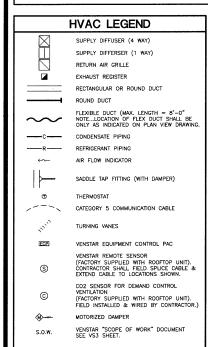

HVAC OUTDOOR AIR REQUIREMENTS

MECHANICAL CODE REFERENCE: FOR REQUIRED OUTDOOR VENTILATION AIR IN RETAIL — "SALES/STORAGI

SHOWROOM = 3100 SOLIARE FEET . HARD PARTS = 3822 SQUARE FEET

CFM/ PERSON x PERSONS) + (CFM/SQUARE FEET x SQUARE FEET) = CFM (7.5 x 47) + (.12 x 3100) = 720.75 CFM OF OUTSIDE AIR REQUIR

HARD PARTS (STORAGE ROOM)

3822 x .12 (CFM/SQUARE FEET) = 458.64 CFM OF OUTSIDE AIR REQUIRE

458.64 + .8 (EFFECTIVENESS) = 573.30 CFM

720.75 ± .8 (EFFECTIVENESS) = 900.94 CFM

901 CFM + 573 CFM = 1474 TOTAL CFM

TOTAL OUTSIDE AIR MINIMUM REQUIRED BY CODE: 1474 CFM

OUTSIDE AIR SPECIFIED ON PLAN SHEET M1: 1476 CFM

HVAC SYSTEMS TESTING & BALANCING

THE HVAC SYSTEM SHALL BE TESTED AND BALANCED (T&B) BY TH CONTRACTOR PER SPEC SECTION: 23_05_93 AND IN ACCORDANCE WITH THE PROCEDURES OF ABBC ON NEBS CONTRACTOR SHALL SUBMIT WRITTEN T&B REPORTS TO THE OWNER. SINCE THIS O'RELLY STORE IS LESS THAN 50,000 SQ. FT. THEN SYSTEM COMMISSIONING IS NOT REQUIRED PER ASHRAE 90.1.

HVAC - KEYNOTES

- 1) THERMOSTATS. (TYPICAL WIRING FOR EACH THERMOSTAT) SEE
- 2 12"x12" DUCT W/ ELBOW FROM "R2" TO JUST ABOVE THE CEILING PLATFORM.
- 3 WALL CAP 500 CFM EXHAUST. ARCHITECTURAL ELEVATIONS SHOW DIMENSIONED LOCATION.

HVAC ROOF BRACING CONFLICTS

CONTRACTOR TO FIELD VERIFY ROOF'S HORIZONTAL ROD BRACING OCATIONS. IF NECESSARY, SHIFT RTU'S AND DUCTS AS REQUIRED TO AVOID CONFLICT WITH BRACING.

OUTSIDE AIR SETUP:

- INTRACTOR TO SET DAMPERS AS FOLLOWS ECONOMIZER MODE MAXIMUM CFM PER UNIT 7.5 TON RTU = 3,000
- MINIMUM OUTSIDE AIR CFM PER RTU TYPICAL) = 492 DURING OCCUPIED HOURS

HVAC GENERAL NOTES

- DRAWING IS DIAGRAMMATIC AND IS NOT TO BE SCALED.
 REFER TO ARCHITECTURAL PLANS OR FIELD MEASUREMENTS
 FOR DIMENSIONS.
- REFER TO ARCHITECTURAL PLANS OR FIELD MEASUREMENTS FOR DIMENSIONS BE PERFORMED IN ACCORDANCE WITH THE PROPULCABLE CODE(S) NOTED ON THE COVER SHEET. THE CONTRACTOR SHALL FIELD VERBY ALL BYTH THE PROPULCABLE OF THE CONTRACTOR SHALL FIELD VERBY ALL BYTH OF THE PROPULCABLE OF THE PR
- THERSE, SPEURIAGLI VALLED OUT TO BE FORWARD FOR POPOSED TO BE USED ON THE JOB SHALL BE PREPARED AS SOON AS POSSIBLE AFTRE AWARD OF THE CONTRACT. THE SUBMITTAL WILL BE REVIEWED BY THE OWNER FOR EQUAL QUALITY AND PERFORMANCE TO THE ITEMS SPECIFIED. ALL CONTROL. DEVICES SHALL BE INCLUDED IN THE SUBMITTAL. THE PROPER PERFORMANCE OF THE CONTRACTOR. STYLEM IS THE RESPONSIBILITY OF THE CONTRACTOR. AND COORDINATE HIS WORK WITH THE WORK OF OTHER SUBGONIFACTORS OF THE PROJECT. COORDINATION DOES NOT MEAN "I WAS HERE PROJECT. COORDINATION DOES NOT MEAN "I WAS HERE PIEST"
- ALL WORK IS TO BE GUARANTEED FOR ONE YEAR UPON OCCUPANCY.

- THE CONTRACTOR SHALL BE RESPONSIBLE FOR INSTALLING A COMPLETE AND FUNCTIONAL SYSTEM IN ACCORDANCE WITH THINENT OF THE PLANS, WHETHER OR NOT EVERY ELEMENT THEREOF IS SPECIFICALLY CALLED OUT. DUCT DIMENSIONS ON PLANS ARE TO BE FINISHED INSIDE
- DIMENSIONS.
 DUCT MATERIALS SHALL BE AS FOLLOWS:
- DIMENSIONS.

 I. DUCT MATERIALS SHALL BE AS FOLLOWS:

 ROUND SUPPLY AIR DUCT (SPEC 23 30 00)

 RECIARQUARS SUPPLY AND RETURN AIR DUCT WORK —

 (SPEC 23 30 00) INSTALL UTWINIO VANES IN ALL ELBOWS.

 DO NOT SUBSTITUTE RADIUSED ELBOWS.

 RONOUTS 10. DIFFLYSERS (SPEC 23 30 00) (SEE DIFFUSER INSTALLATION DETAIL).

 EXHAUST DUCT (SPEC 23 30 00)

 ITRANSTIONS SHALL CONFORM 10 SMACNA STANDARDS.

 12. INSULATE HVAC CONDENSATE DRAIN PIPING WITH 1/2"

 ARMAPLE.

 3. NO EQUIPMENT OR FIXTURE SUBSTITUTIONS (THAT ARE NOT CURRENITY USTED) WITHOUT PRIOR WRITTEN APPROVAL OF CHEROITY USTED) WITHOUT PRIOR WRITTEN APPROVAL OF COMPANIONS.

 14. UPON COMPLETION BALANCE SYSTEMS TO AIR FLOWS SHOWN.

 REPORT THE BALANCING MEASUREMENTS ON THE "AS BUILT" DRAWNOS.


 15. MOUNT CONDENSATE AND REFRIGERANT LINES AS HIGH AS POSSIBLE.

 16. CONTROL WRITING BY HVAC CONTRACTOR, FINAL CONNECTIONS

- BY HVAC CONTRACTOR, FINAL CONNECTIONS BY HVAC CONTRACTOR.
- 7. ALL CAULKING ON BUILDING PENETRATIONS SHALL BE A ONE-COMPONENT NON-SAG URETHANE ELASTOMERIC SEALANT. ANY CONTRACTOR WHO USED SILCONE OR ANY OTHER CAULKING WILL BE REQUIRED TO REMOVE AND REPLACE WITH A SPECIFIED SEALANT (SPEC: 07 92 00).

 B. THE HYAC SYSTEM SHALL BE CONSTRUCTED IN ACCORDANCE WITH NFPA 1017-72 and NFPA 90A ACCORDANCE WITH NFPA 1017-72 ON NFPA 90A AND VERTILED MYSTEMS.
- AND VENTILATION SYSTEMS".

 ALL HVAC SYSTEM FLUES & VENTS SHALL BE
 CONSTRUCTED IN ACCORDANCE WITH NFPA 54 (LATEST
- 19. ALL HVAC SYSTEM FLUES & VENTS SHALL BE CONSTRUCTED IN ACCORDANCE WITH NFPA 54 (LATEST EDITION).
 20. PROVIDE AIR FILITATION MEDIA FOR OUTSIDE AND RETURN AIR PRIOR TO OCCUPANCY THAT PROVIDES AT LEAST A MINIMUM EFFICIENCY REPORTING VALUE (MERV) OF 8.
 21. COVERING OF DUCT OPENINGS AND PROTECTION OF MECHANICAL EQUIPMENT DURING CONSTRUCTION: AT THE TIME OF ROUGH INSTALLATION, OR DURING MAL STARTUP OF THE HEATING AND COULING AND UNTIL FINAL STARTUP OF THE HEATING AND COULING MENTAL STARTUP OF THE HEATING AND COULING THE METHOD SHALL BE COVERED WITH TAPE, PLASTIC, SHEET METAL OR OTHER METHODS ACCEPTABLE TO THE ENFORCING AGENCY TO REDUCE THE AMOUNT OF DUST OR DEBMIS WHICH MAY COLLECT IN THE SYSTEM.
 2. ALL HVAC CONDENSARE LINES SHALL RUN AT A MINIMUM SLOPE OF 1/8—INCH PER FOOT.

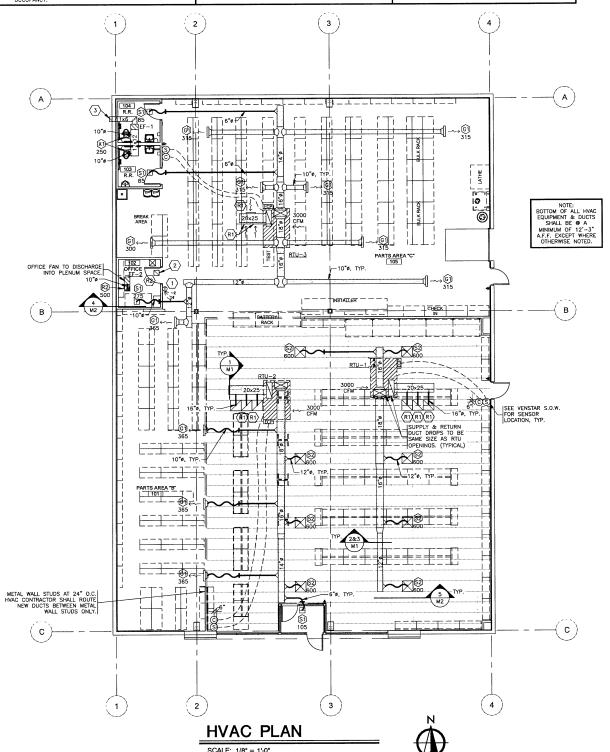



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SEAL:



11/11/16 DATE ISSUED



SHEET TITLE:

HVAC PLAN

REVISIONS: NO DATE PROJECT NO: DRAWN BY: LRB

M


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CALL THE CARRIER CUSTOMER SERVICE REP. BELOW FOR RTU - RESPONSIBILITIES) ALL CARRIER HVAC UNITS WITH ACCESSORIES ARE OWNER SUPPLIED BY O'REILLY AUTOMOTIVE.) MECHANICAL CONTRACTOR IS RESPONSIBLE FOR THE INSTALLATION OF ALL CARRIER HVAC UNITS.) MECHANICAL CONTRACTOR IS RESPONSIBLE FOR THE FIRST YEAR LABOR WARRANTY ON ALL OWNER SUPPLIED EQUIPMENT. CONFIRMATION OF ORDERS. DO NOT CALL CARRIER FOR QUOTES! SUPPLIED EQUIPMENT.), MECHANICAL CONTRACTORS WORKING ON O'REILLY PROJECTS MUST CALL "CARRIER CORPORATION'S NATIONAL ACCOUNTS" DEPARTMENT FOR CONFIRMATION OF ORDERS ONLY!), MECHANICAL CONTROTOR IS RESPONSIBLE FOR SCHEDULING, SHIPPING & RECEIVING OF ALL CARRIER UNITS FROM CARRIER NATIONAL ACCOUNTS. CONTACT CUSTOMER SERVICE REP. LISTED TO THE RIGHT. HTG. MBH STAGE 1 STAGE 2 TITL. HTG THERM. STAGE 1 STAGE 2 TITL. COOL ILEER EER CFM O.A. ESP HP MCA MOCP (Ibs.) DESCRIPTION MFR. ACCESSORIES - FACTORY SUPPLIED & FIELD INSTALLED CO2 = CO2 SENSOR, WALL MOUNT. #33ZCSPTCO2LCD-01 CO2/SPACE TEMPERATURE SENSOR WITH LCD DISPLAY & NO OVERRIDE. EC = ENTHALPY ECONOMIZER IV. W/BAROMETRIC RELIEF. STAINLESS STEEL GAS HEAT EXCHANGER. (MEDIUM HEAT) (15 YR. WARRANTY). RETURN AIR SMOKE DETECTOR. RETURN AIR SMOKE DETECTOR. MEDIUM STAID BLOWER, (SINGLE SPEED). LOUVERD HAIL GLARDS. UN-POWERD CONTYNIENCE OUTLET (FIELD POWERED), 15AMP, 120V, GROUND FAULT CIRCUIT INTERRUPTER (GFGI) TYPE. HIRU-THE-BOTTOM-ELECTRIC & GAS SERVICES, (SEE ROOF TOP UNIT DETAILS) HI & LOW REFRICEARM SAFETY SWITCHES. (STANDARD ON EVERY UNIT) YENSTAR SURVEYOR, (ECP & SENSORS) ACCESSORIES - O'REILLY SUPPLIED & FIELD INSTALLED VENSIAR COMMUNICATION THERMOSTAT, (NO SUBSTITUTIONS). REFER TO SHEET VS1. VENSTAR REMOTE SENSOR, (NO SUBSTITUTIONS). REFER TO SHEET VS1. NON-PUSED DISCONNECT SMITCH. (GRAYBAR/O'REILLY) SUPPLIED W/ ELECTRICAL BILL OF MATERIALS. ACCESSORIES - FIELD SUPPLIED & FIELD INSTALLED ROOF CURE: (12" STANDARD, 14" IN EXTREME SNOW DRIFT AREA'S) ON NEW BUILDING, ROOF CURE IS BY BUILDING MANUFACTURER. ON EXISTING BUILDING, ROOF CURE IS BY ENGENT ABOUT OF ROOF CURE IS MY ENGLISH ABOUT. REMARKS ⚠ COOLING CAPACITY BASED ON 80°F EDB AND 67°F EWB. A FACTORY EQUIPPED WITH STANDARD LOW AMBIENT COOLING TO 35'F ODB. CAPACITY BASED ON 95'F AMBIENT TEMPERATURE. OUTSIDE AIR, SEE PLAN FOR UNIT(S) REQUIRING OUTSIDE AIR. NOTE! HVAC COMPLETION. AT CONSTRUCTION COMPLETION: 1. CONTRACTOR SHALL REPLACE ALL RETURN AIR FILTERS INSIDE ALL HVAC UNITS W/CLEAN NEW AIR FILTERS. 2. CONTRACTOR SHALL SUPPLY AN ADDITIONAL CLEAN SET OF FILTERS TO THE OWNER AT JOB CONFILETION. 3. CONTRACTOR SHALL SHOW THE STORE MANAGER THE LOCATION OF & INSTRUCT HIM/HER HOW TO CHANGE ALL AIR FILTERS. . MAXIMUM CIRCUIT BREAKER OR TIME-DELAY FUSE.

FANS: *GREENHECK *CARNES


NATIONAL ACCOUNT - ROOFTOP UNIT SCHEDULE - 7.5 TON - GAS (3-PHASE) - BY O'REILLY

	F	AN S	SCHE	DULE						
ON MED	CATALOG	CFM	STATIC	MOTOR	ELECTRICAL			ACCESSORIES	REMARKS	REF.
ON MFR.	NUMBER	(MOM)	PRESS.	H.P.	V/PH	MCA	моср	ACCESSORIES	KEMAKKS	DETAI
AN COOK	GN-640	500	0.1	350W	120/1	-	-	BD,DS,WC	\triangle	<u> </u>
соок	GN-640	500	0.1	350W	120/1	-	-	BD,DS,SS	3	
			RE	MARKS						
			Λ	ADJUST	FOR CFM	REQUIRE	ED.			
ITCH	u		1 🙀	3				THE E		
			1/2	7 EVHAD2	I LAN 2H	MLL BE A	TIKEU BI	LIGHT SWITCH.	AL CONTRACT	OK II
	COOK DRAFT DAMPER WITCH OK" #WCA-6, ALUMINU	OON	ION	TON	TON	NUMBER NUMBER NOM PRESS H.P. V/PH	DON MFR. CATALOG CFM STATIC MOTOR ELECTRICA	ION	ON MFR.	ION

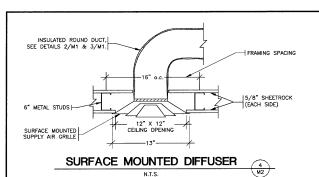

MARK	DESCRIPTION	MFR.	CATALOG NUMBER	SIZE (in.)	FINISH	MOUNTING	BRANCH DUCT SIZE	ACCESSORIES	REMARKS	REF. DETAIL
(i)	SUPPLY GRILLE	ANEMOSTAT	S2H0	14x14	WHITE	DUCT	SEE PLAN	OB	\triangle	-
<u>(§)</u>	SUPPLY DIFFUSER	ANEMOSTAT	E-1-D	12×12	WHITE	SURFACE	SEE PLAN	DT	$\Lambda \Delta$	4/M2
62	SUPPLY DIFFUSER	ANEMOSTAT	EPL	24×24	WHITE	DUCT/LAY-IN	SEE PLAN	-	2	5/M2
ŔĴ	RETURN GRILLE	ANEMOSTAT	GC5	24x24	WHITE	LAY-IN/EXPOSED	SEE PLAN	-	NON-FILTERED GRILLE	5/M2
R2	RETURN GRILLE	ANEMOSTAT	GC5	12x12	WHITE	SURFACE	SEE PLAN	-	NON-FILTERED GRILLE	4/M2
(XI)	EXHAUST GRILLE	ANEMOSTAT	S3HS	12x12	WHITE	CEILING	SEE PLAN	ОВ	-	-
ACCESSO	DRIES				REMARK	S				
OB - DT -	OPPOSED BLADE DAM DIRECTIONAL TABS.	IPER.			1-V					
APPROVI	ED ALTERNATE MANUFA	CTURER'S				ECTIONAL TABS, CATED ON PLAN		PROVIDE THRO	W AS	
*TUTTLE	DIFFUSERS & DAMPER & BAILEY *NAILO NDUSTRIES *TITUS	OR *ARR	OW *	CARNES]	3.1.25 3.1.1.2.1.				

GRILLE AND DIFFUSER SCHEDULE

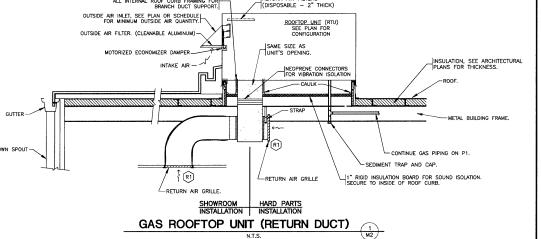

MOTORIZED ECONOMIZER

SUPPLY DUCT

MECHANICAL CONTRACTOR SHALL FURNISH ALL INTERNAL ROOF CURB FRAMING FOR BRANCH DUCT SUPPORT

Lin

GAS ROOFTOP UNIT (SUPPLY DUCT)

DUTSIDE AIR FILTER. (CLEANABLE ALUMINUM)

MOUNT SUPPLY GRILLE ON END OF DUCT.

SQUARE TO ROUND

PIPE CONDENSATE WITH 3/4" PVC ELECTRICAL CONDUIT ULTRA VIOLET RESISTANT.

ATTACH CONDENSATE LINE TO GUTTER W/ C-CLAMP SCREWS (STAINLESS STEEL

GUTTER

INSTALL GAS PIPING TO ROOFTOP UNIT BASE AS REQUIRED. THE CONTRACTOR SHALL SUPPLY AND INSTALL NECESSARY PIPING INCLUDING A PRE-ASSEMBLED, BLACK STEEL MANUAL SHUT-OFF VALVE (WITH 1/5 MPT PRESSURE TAP), ELBOWS AND UNION. THIS ASSEMBLY WILL REQUIRE FIELD LABOR TO INSTALL.

CONTRACTOR TO INSTALL J-BOX FOR FIRE ALARM. MOUNT J-BOX BELOW-CONVENIENCE OUTLET LOCATION.


ROOF INSULATION, SEE ARCHITECTURAL | PLANS FOR THICKNESS.


CONTINUE GAS PIPING ON P1

LAY-IN DIFFUSER, SEE DETAIL 5/M2.-SEDIMENT TRAP AND CAP

ROUND SHEET METAL DUCT WITH WRAP INSULATION, SEE DETAIL 3/M1.

METAL BUILDING FRAME. ---

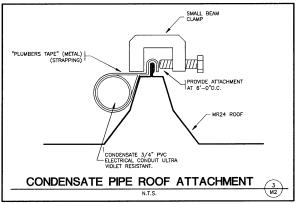

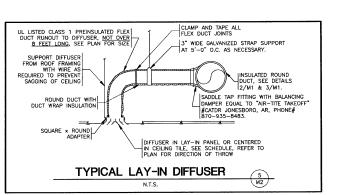



ACCOUNT MANAGER:
PAUL WITZ
CELL 315-317-2481
paul.witz@carrier.utc.com

ACCESSORIES

REMARKS REF

1/1/2/3

CUSTOMER SERVICE REPS: SARA TILTON SAKA IILTON 866-389-4658 EXT. 3429 sara.tilton@carrier.utc.com PATRICK G. BLEES, ARCHITECT 800 WASHINGTON AVE. N. SUITE 208 MINNEAPOLIS, MN 55401 PHONE: (612) 547-1370 FAX: (612) 547-1301

CONTACT: TONY JOHNSON ajohnson@cmarch.com



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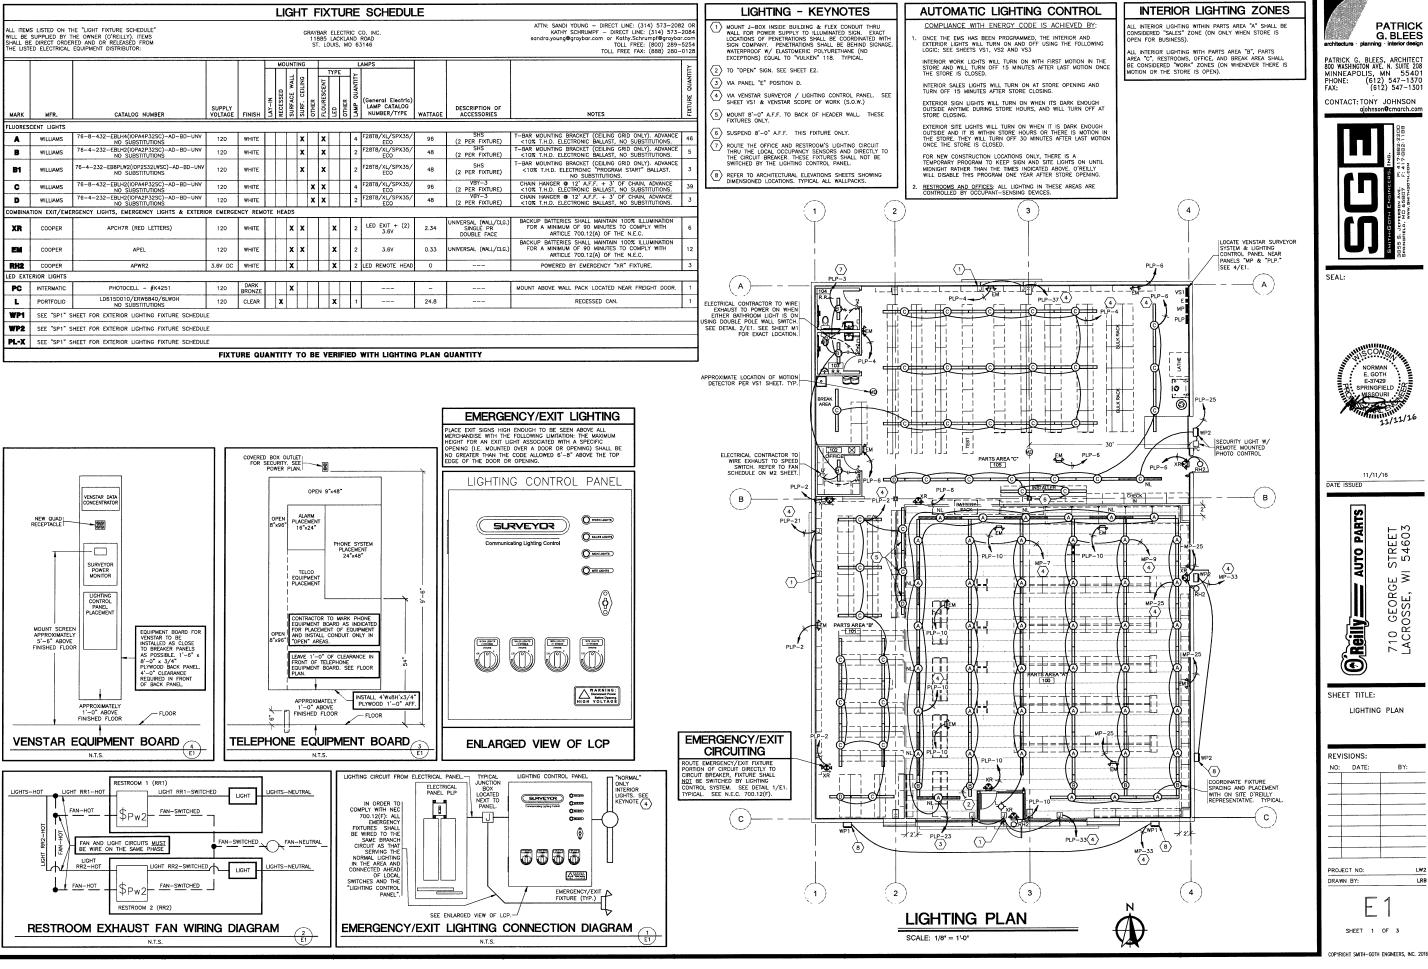
DATE ISSUED

CREILY AUTO PARTS STREET I 54603

SHEET TITLE: MECHANICAL SCHEDULES

NO:	DATE:	BY:
	CT NO:	LV
DRAWN	BY:	LF

M2SHEET 2 OF 2



PATRICK G. BLEES

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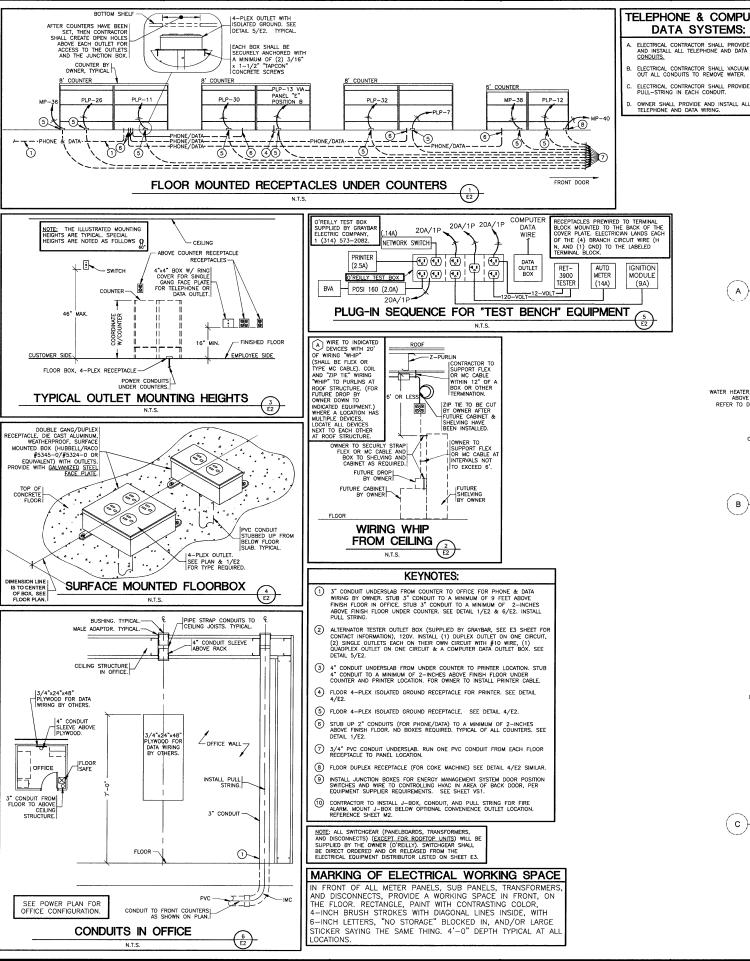


SHEET TITLE:

LIGHTING PLAN

REVIS	SIONS:	
NO:	DATE:	BY:
PROJE	CT NO:	LW2
DRAWN	BY:	LRB
		1

SHEET 1 OF 3



TELEPHONE & COMPUTER DATA SYSTEMS:


- ELECTRICAL CONTRACTOR SHALL VACUUM OUT ALL CONDUITS TO REMOVE WATER.
- OWNER SHALL PROVIDE AND INSTALL ALL TELEPHONE AND DATA WIRING.

FIRE ALARM NOTE:

ITIE ALAMN INVIE.

IN THE EVENT A MONITORED FIRE ALARM SYSTEM IS REQUIRED BY THE AUTHORITY HAVING JURISOLITON. THE ALARM SYSTEM WILL BE CONTRACTED DIRECTLY BY THE ALARM SYSTEM WILL BE CONTRACTED DIRECTLY BY THE ALARM SYSTEM WILL BE CONTRACTED DIRECTLY AUTOMOTIVE CORPORATE OFFICE. THE GENERAL CONTRACTOR SHALL NOT PROCUPE ANYONE TO INSTALL OR QUOTE THESE SYSTEMS UNLESS THEY HAVE BEEN ASKED TO DO SO BY LEIGH SIDES. PLEASE CONTACT LEICH SIDES

#17-829-3712 | IF A SYSTEM IS NEEDED OR IF THERE ARE ANY QUESTIONS.

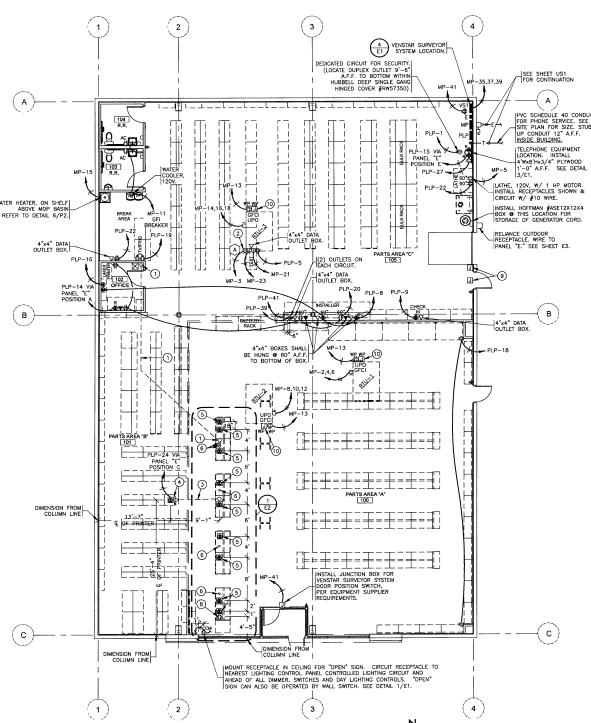

POWER PLAN

SCALE: 1/8" = 1'-0"



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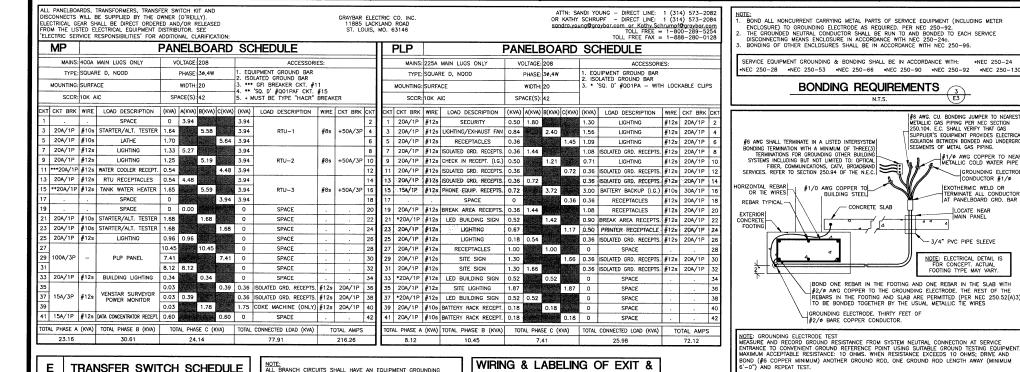
11/11/16 DATE ISSUED



SHEET TITLE: POWER PLAN

REVISIONS: NO: DATE: PROJECT NO: DRAWN BY:

SHEET 2 OF 3 COPYRIGHT SMITH-GOTH ENGINEERS, INC. 2016



Е	TRANSFI	ER SWITCH SCHEDULE
POSITION	CIRCUIT BREAKER	LOAD DESCRIPTION
Α	15A/1P	OFFICE COMPUTER
В	15A/1P	COUNTER RECEPTACLES
С	*20A/1P	PRINTER
D	*20A/1P	SHOWROOM LIGHTING
Ε	15A/1P.	TELEPHONE EQUIPMENT RECEPTACLE
F	15A/1P	SPARE
* CONTR	ACTOR SHALL WIRE	LIGHTING CIRCUITS TO 20 A BREAKERS.

NOTE:
ALL BRANCH CIRCUITS SHALL HAVE AN EQUIPMENT GROUNDING CONDUCTOR ROUTED WITH THE CIRCUIT CONDUCTORS. THIS MEANS ALL CONDUITS MUST HAVE. A GREEN WIRE INSTALLED IN THEM AND SIZED IN ACCORDANCE WITH TABLE 250.122 OF THE N.E.C.

WIRING & LABELING OF EXIT & **EMERGENCY LIGHT CIRCUITS**

- SEE DETAIL 1/E1 FOR WIRING OF EXIT & EMERGENCY LIGHTS ON THESE CIRCUITS.
- ALL EXIT & EMERGENCY LIGHTING CIRCUITS SHALL BE LABELED BY THE CONTRACTOR ON THE "PANEL
- DIRECTORY". (SPEC: NFPA 70 408.4 & 700.12€.)

GENERAL ELECTRICAL NOTES

- DRAWINGS ARE DIAGRAMMATIC & ARE NOT TO BE SCALED. SEE THE ARCHITECTURAL PLANS & FIELD VERIFY CONDITIONS FOR DIMENSIONS. ALL ELECTRICAL WORK SHALL COMPLY WITH THE EDITION OF NFPA 70-NATIONAL ELECTRIC CODE (NEC) AS NOTED ON THE COVER SHEET.
- ALL WRING SHALL BE IN CODUIT. EXCEPT THAT MC-CABLE MAY BE SUBSTITUTED ONLY AS FOLLOWS:

 A. MC-CABLE (MAXIMUM CABLE LENGTH OF 10'-0') MAY BE INSTALLED ONLY FOR BRANCH CIRCUIT WIRING TO LIGHT FIXTURES.

 B. MC-CABLE (MAXIMUM CABLE LENGTHS SHOWN ON DETAIL 1/E2) SHALL BE INSTALLED INSIDE OF
- FRONT CHECKOUT COUNTERS.

 FEEDER CONDUIT SHALL BE IMC OR RGS ABOVE GRADE & PVC BELOW GRADE WITH IMC OR RGS ELLS & RISERS. INTERIOR BRANCH CIRCUIT CONDUIT SHALL BE ELECTRICAL METALLIC TUBING. EXTERIOR BRANCH CIRCUIT CONDUIT SHALL BE PVC BELOW GRADE WITH IMC OR RIGID GALVANIZED STEEL CONDUIT CONTINUIN
- ABOVE GRADE. (SPEC 26 05 33)
 COORDINATE ALL WORK WITH OTHER TRADES TO AVOID CONFLICTS. COORDINATION DOES NOT MEAN "I WAS
- COORDINATE ALL BURN BITTO THE VIBER TO THE VIBER FIRST.

 ALL WIRING IN FINISHED SPACES SHALL BE CONCEALED, UNLESS NOTED OTHERWISE.

 THE CONTRACTOR SHALL BE RESPONSIBLE FOR INSTALLING A COMPLETE & FUNCTIONAL SYSTEM IN ACCORDANCE WITH THE INTENT OF THE PLANS, WHETHER OR NOT EVERY ELEMENT THEREOF IS SPECIFICALLY CALLED OUT.

 COORDINATE ALL EQUIPMENT ROUGH—IN CONNECTION REQUIREMENTS.

- . COORDINATE ALL EQUIPMENT ROUGH-IN CONNECTION REQUIREMENTS.
 ALL OUTLET BOXES SHALL BE METALLIC. (SPEC 26 05 34)

 D. ALL CAULKING ON BUILDING PENETRATIONS SHALL BE ELASTOMERIC POLYURETHANE (NO EXCEPTIONS), EQUAL
 TO "VULKEM" 116. ANY CONTRACTOR WHO USES SILLCOND OR ANY OTHER CAULKING WILL BE REQUIRED TO
 REMOVE & REPLACE WITH ELASTOMERIC POLYURETHANE.

 RECEPTACES INSTALLED IN RESTROOMS SHALL BE GFCI TYPE OR SHALL BE PROTECTED BY A GFI DEVICE.

- THREE-WAY SWITCHES —
 THREE-WAY SWITCHES —
 DUPLEX RECEPTACLE (SPEC 26 27 26)
 GFCI DUPLEX RECEPTACLE —
 ISO. GRD. RECEPTACLES —

- ONTE DUPLEX RECEPTACLES —

 13. USE DEVICE PLATES MANUFACTURED BY THE DEVICE MANUFACTURER. (SPEC 28 27 28)

 14. FERENCE M. BRANCH CIRCUIT CONDUCTORS SHALL BE COPPER, STRANDED, 800V THIN/THINN INSULATION.

 15. CONTRACTOR SHALL PROVIDE A. ONE(1) YEAR WHERMITY OF DRIVING PROVIDED AND STRANDED.

 16. CONTRACTOR SHALL PROVIDE A. ONE(1) YEAR WHERMITY OF DRIVING PROVIDED AND STRANDED.

 17. CONTRACTOR SHALL PROVIDE A. ONE(1) YEAR WHERMITY OF DRIVING AND STRANDED.

 18. CONTRACTOR SHALL PROVIDE A. ONE(1) YEAR WHERMITY OF DRIVING STRANDED.

 18. CONTRACTOR SHALL PROVIDE A. ONE(1) YEAR WHERMITY OF DRIVING STRANDED.

 19. CONTRACTOR SHALL CONTRACTOR WHITH A SHALL INCLUDE ALL FEES FOR THE SERVING "ELECTRIC UTILITY CO." TO PROVIDE ELECTRIC SERVICE AS SHOWN. CONTRACTOR SHALL ARRANGE FOR A INCLUDE ALL FEES FOR THIS SCOPE OF WORK.

 19. CONTRACTOR SHALL ARRANGE FOR A INCLUDE ALL FERMITS & FEES FOR HIS SCOPE OF WORK.

 20. CONTROLOR SHALL ARRANGE FOR A INCLUDE ALL PERMITS & FEES FOR HIS SCOPE OF WORK.

 21. APPROVED MANUFACTURERS:

 21. APPROVED MANUFACTURERS:

 22. PANCELES OSSICONNECTS:

 23. PANCELES OSSICONNECTS:

 24. CONTRACTOR SHALL ARRANGE FOR A INCLUDE ALL FEES FOR HIS SCOPE OF WORK.

 25. STEEL CITY"

 26. STEEL CITY"

 26. STEEL CITY"

 27. STEEL CITY"


 28. STEEL CITY"


 28. STEEL CITY"

 29. LEVITON'

 29. STEEL CITY"

 29. STEEL CITY S
 - -- 'STEEL CITY -- 'APPLETON'
 - -- 'HUBBELL' -- 'LEVITON' -- 'PASS & SEYMOUR' - 'SEIMENS' 'CUTLER-HAMMER'
 - (SPEC 26 24 00) (SPEC 26 27 26) (SPEC 26 05 34)
 BRANCH CIRCUITS WITH A "SHARED NEUTRAL" ARE NOT ALLOWED FOR SINGLE PHASE CIRCUITS

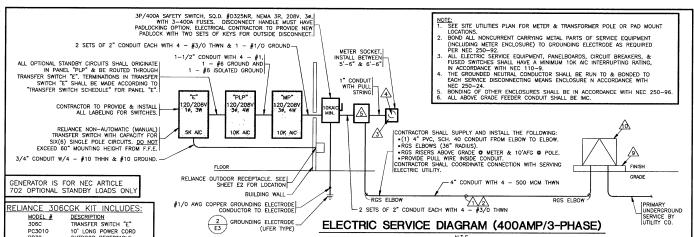

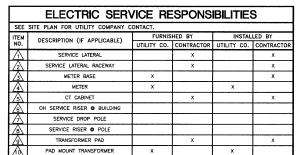

BONDING REQUIREMENTS (3) (E3)

- CONCRETE SLAB

GROUNDING ELECTRODE. THIRTY FEET OF #2/Ø BARE COPPER CONDUCTOR.

NEUTRAL TERMINAL BLOCK

EQUIPMENT GROUND BAR

TYPICAL ISOLATED GROUND RECEPTACLE

INSULATED EQUIPMENT GROUND BAR

INSULATED EQUIPMENT GROUNDING CONDUCTOR TO FEEDING PANEL'S EQUIPMENT GROUND BAR

CONDUCTOR TO GROUND METAL BOX

ISOLATED GROUND

Q-O

0

GROUNDING ELECTRODE (UFER TYPE)

& BONDING JUMPER(S) DETAIL

#6 AWG. CU. BONDING JUMPER TO NEAREST METALLIC GAS PIPING PER NEC SECTION 250.104. E.C. SHALL VERITY THAT GAS SUPPLER'S EQUIPMENT PROVIDES ELECTRICAL ISOLATION BETWEEN BONDED AND UNDERGROU SEGMENTS OF METAL GAS PIPING.

#1/ø AWG COPPER TO NEARE: METALLIC COLD WATER PIPE

EXOTHERMIC WELD OR TERMINATE ALL CONDUCTORS AT PANELBOARD GRD. BAR

LOCATE NEAR MAIN PANEL

- 3/4" PVC PIPE SLEEVE

NOTE: ELECTRICAL DETAIL I FOR CONCEPT. ACTUAL FOOTING TYPE MAY VARY.

ISOLATED GROUND PANEL

PANEL SHOWN SERVICE PANEL SIMILAR

BOND ONE REBAR IN THE FOOTING AND ONE REBAR IN THE SLAB WITH #2/8 AWG COPPER TO THE GROUNDING ELECTRODE. THE REST OF THE REBARS IN THE FOOTING AND SLAB ARE PERMITTED (PER NEC 250.52(A)3) TO BE BONDED TOGETHER BY THE USUAL METALLIC ITE WIRES


GROUNDING ELECTRODE CONDUCTOR #1/ø

BOND METALLIC COLD AND HOT WATER PIPING AT WATER HEATER NOTE:

1. PROVIDE AT ALL WATER HEATER LOCATIONS.
2. BONDING AT WATER HEATER IS IN ADDITION TO BONDING COLD WATER PIPE AT ELECTRICAL SERVICE ENTRANCE. DIELECTRIC UNION - WATER HEATER METALLIC WATER PIPE BONDING

ELECTRICAL SYMBOL LEGEND & ABBREVIATIONS

- SINGLE POLE SWITCH
- THREE-WAY SWITCH
- MOTOR STARTING SWITCH WITH PILOT LIGHT
- CLASS 1. DIVISION 1 HAZARDOUS LOCATION RATED SWITCH ASSEMBLY
- WALL MOUNTED OCCUPANCY SENSOR EQUAL TO "LEVITON, ODS10-ID"
- WALL MOUNTED OCCUPANCY SENSOR EQUAL TO "LEVITON, OSSMD-MD"
- \$sa FAN SPEED SWITCH (SUPPLIED BY HVAC CONTRACTOR / INSTALLED BY ELECTRICAL CONTRACTOR) Φ
- DUPLEX RECEPTACLE
 - ISOLATED GROUND DUPLEX RECEPTACLE (ORANGE IN COLOR) $\begin{pmatrix} 1 \\ F3 \end{pmatrix}$
- QUADPLEX RECEPTACLE (TWO DUPLEX RECEPTACLES IN ONE 2-GANG BOX UNDER A SINGLE
- EXISTING UNPOWERED DUPLEX RECEPTACLE
- ISOLATED GROUND QUADPLEX RECEPTACLE (TWO ISO. GRD. DUPLEX RECEPTACLES IN ONE 2—GANG BOX UNDER A SINGLE RED IN COLOR COVERPLATE) **₩**_R
- AC. ABOVE COUNTER GEGL (GROUND FAULT CIRCUIT INTERRUPTING) DUPLEX RECEPTACLE
- WEATHER PROOF GFCI (GROUND FAULT CIRCUIT INTERRUPTING) DUPLEX RECEPTACLE. COVER TO PROVIDE WEATHER PROOF PROTECTION WITH CORD AND PLUG IN USE.
- TELEPHONE OUTLET BOX.
- \mathbf{V} TELEPHONE OUTLET FLOOR BOX. SEE DETAIL 5/E2.
- PD PHONE/DATA FLOOR BOX. SEE DETAIL 5/E2
- ∇ COMPUTER DATA OUTLET FLOOR BOX. SEE DETAIL 5/E2
- (J) JUNCTION BOX
- □PC
- COMPUTER DATA OUTLET BOX.
- 4" SQUARE STEEL BOX MOUNTED FLUSH ON FLOOR W/QUADPLEX RECEPTACLE (SEE ABOVE RECEPTACLE DESCRIPTION). SEE DETAIL 5/E2 FOR INSTALLATION OF BOX.
- 4" SQUARE STEEL BOX MOUNTED FLUSH ON FLOOR W/QUADPLEX ISOLATED GROUND RECEPTACLE (SEE ABOVE ISOLATED GROUND RECEPTACLE DESCRIPTION). SEE DETAIL 5/E2 FOR INSTALATION OF BOX
- 4" SQUARE STEEL BOX MOUNTED FLUSH ON FLOOR W/QUADPLEX ISOLATED GROUND RECEPTACLE (SEE ABOVE ISOLATED GROUND RECEPTACLE DESCRIPTION). SEE DETAIL 5/E2 FO INSTALLATION OF BOX. OUTLET COVER SHALL BE RED IN COLOR.
- 2" x 4" RECTANGULAR STEEL BOX MOUNTED FLUSH ON FLOOR W/DUPLEX RECEPTACLE (SEE ABOVE RECEPTACLE DESCRIPTION). SEE DETAIL 5/E2 FOR INSTALLATION OF BOX
- NEMA 15-30R SPECIAL RECEPTACLE
- 6 MOTOR
- XX/XX FUSED DISCONNECT (SAFETY) SWITCH W/ SWITCH AMPACITY / FUSE AMPACITY AS INDICATED NON-FUSED DISCONNECT (SAFETY) SWITCH
- POWER OR LIGHTING PANEL W/PANEL DESIGNATION SHOWN ON PLAN (SIZES & MOUNTING INDICATED ON PLANS)
- XR. WALL/CEILING MOUNTED COMBINATION "EXIT/EMERGENCY" SIGN W/SHADING INDICATING FACES
- ₽₩ EMERGENCY LIGHTING FIXTURE WITH BATTERY
- 24 HOUR LIGHT, WIRE AHEAD OF ANY LOCAL SWITCHES.
- FEEDING PANEL AND CIRCUIT NUMBER(S)

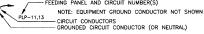


- BY VENSTAR (NOT USED WHERE DIMMING OF INTERIOR LIGHTING IS REQUIR

9	MOTION DETECTOR
AC AFF BCU CDU EF EFU FURN AHP	LOCATED ABOVE COU ABOVE FINISHED FLO BLOWER COIL UNIT CONDENSING UNIT EXHAUST FAN ELECTRIC FURNACE GAS FURNACE AIR HANDLER HEAT PUMP UNIT

RTU PACKAGED ROOFTOP UNIT IME INTERMEDIATE METALLIC TUBING INTERMEDIATE ME

PROJECT NO:

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SEAL:
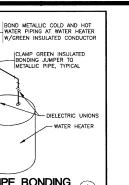
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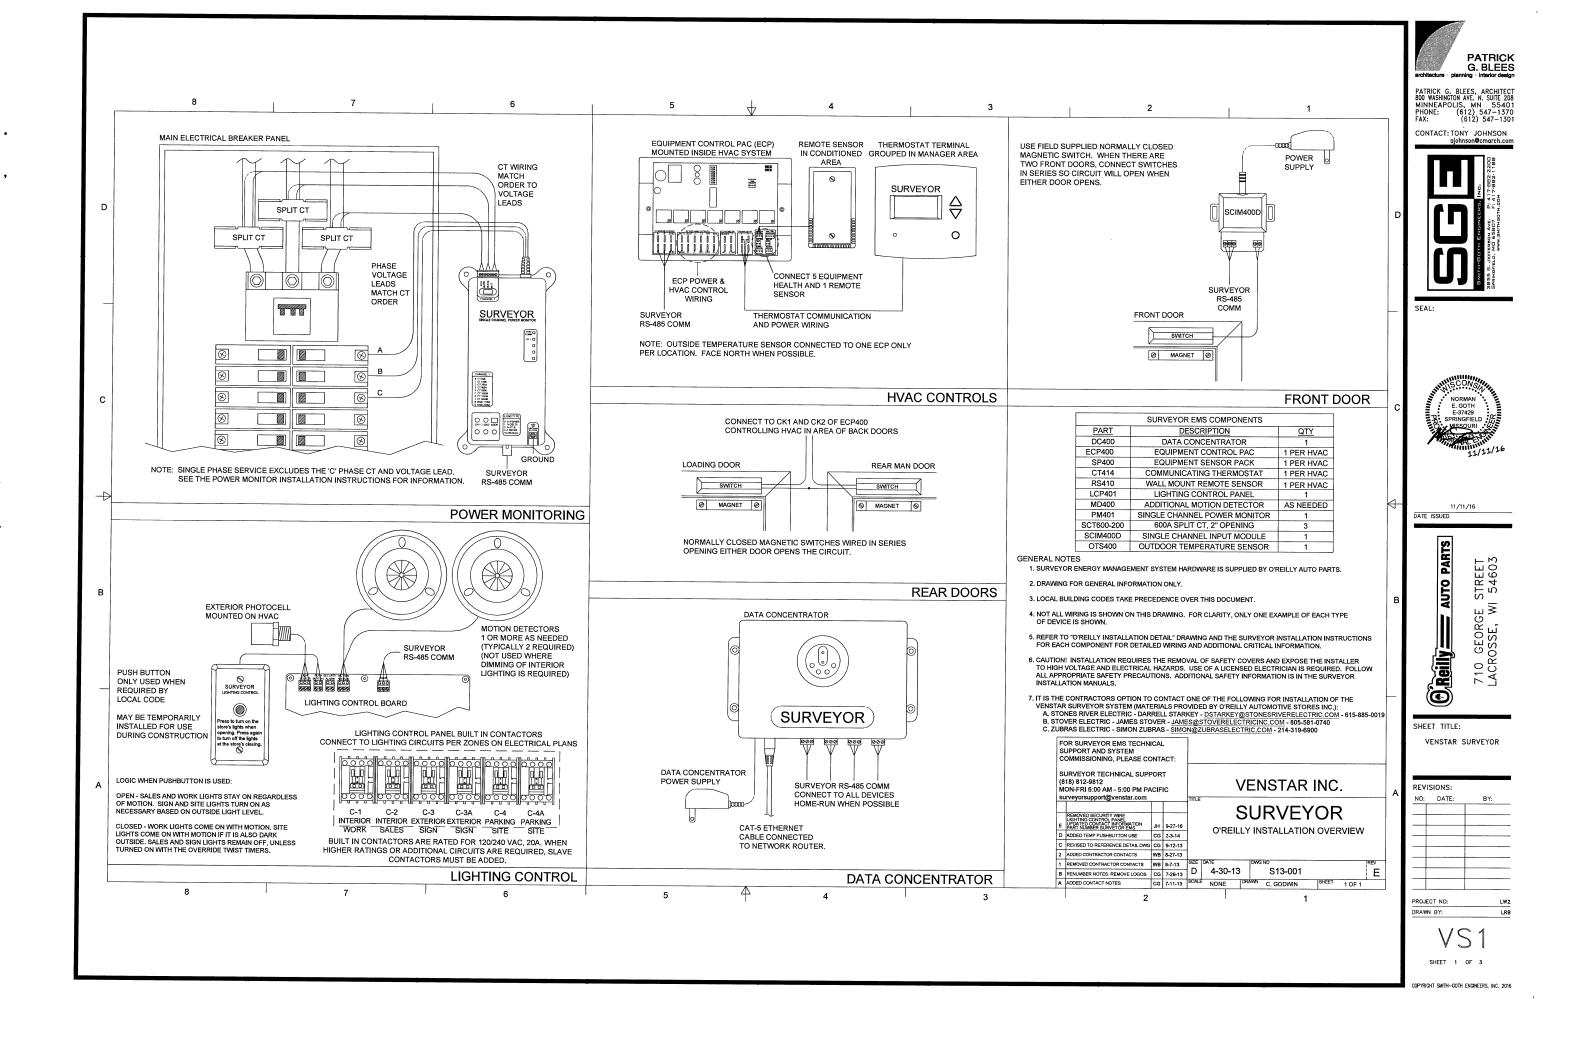
11/11/16 DATE ISSUED




SHEET TITLE:

ELECTRICAL SCHEDULES

REVISIONS: DATE



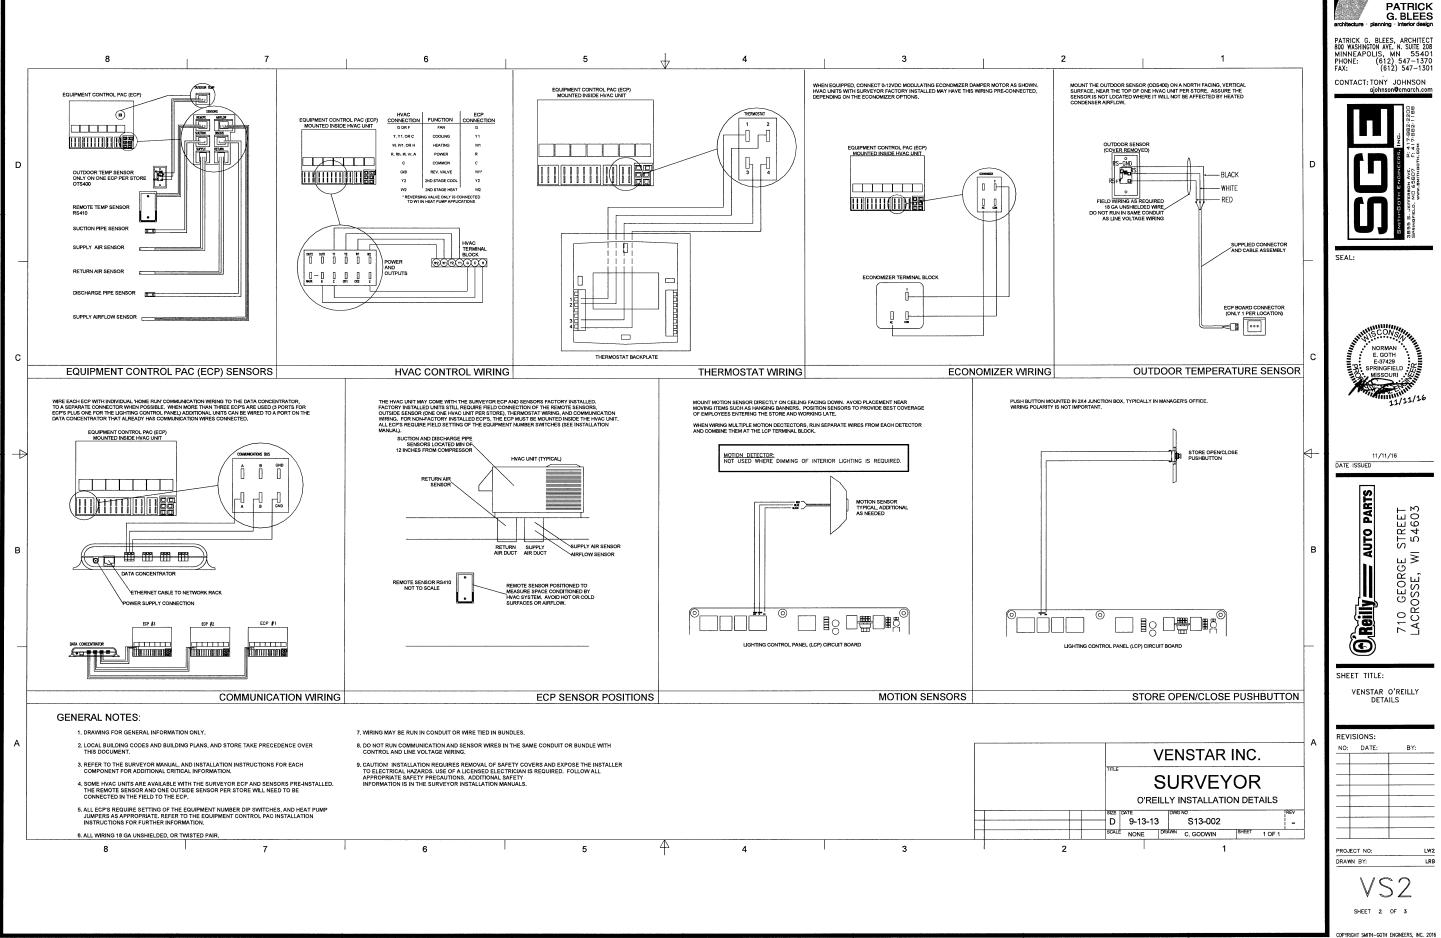

PATRICK

SURVEYOR

O'Reilly New Construction Statement of Work (SOW)

General Notes

- The Venstar Surveyor Energy Management System is supplied by O'Reilly Auto Parts and installed by the contractor. Please note: Local building codes and building plans take precedence over this document.
- More details can be found on the VS1 and VS2 drawings, as well as the installation instructions included with each Surveyor hardware component.

Surveyor EMS Components

Part#	Quantity
DC400-E2	One per location
LCP401-R1	One per location
OTS400	One per location
ECP400-R1	One per HVAC uni
CT414	One per HVAC uni
SP400	One per HVAC uni
RS410	One per HVAC uni
MD400	Two total per location (typical)
PM401	One per location
	Three per location
SWP400	Two per location (typical)
SWP400	One per location (typical)
SCIM400D	One per location
	DC400-E2 LCP401-R1 OTS400 ECP400-R1 CT414 SP400 RS410 MD400 PM401 SWP400 SWP400

Installing the Data Concentrator

Connect to the "Low Side" router and plug into the first available port. (This is the same router as the store's training computer and/or the same router that the DM connects to when making store visits.)

Wiring Instructions

- Connect Cat 5 cable from Data Concentrator to the store router in the designated port
- Connect power supply to Data Concentrator

Hardware Configuration

The Data Concentrator ships to the job site pre-programmed with network settings provided by O'Reilly. Additional hardware configuration is not typically required.

Installing the Equipment Control Pac, Communicating Thermostat, and sensors

Hardware Placement

- Mount an Equipment Control Pac (ECP) inside each HVAC unit
- Label ECPs per O'Reilly terminology (For example: HVAC 1, HVAC 2, etc.)
 Connect sensors from Sensor Pac
- Communicating Thermostat(s):
 - Mount the thermostats at a level permitting easy access near the manager's workstation, if
 - Label front of thermostat doors per O'Reilly terminology (HVAC 1, HVAC 2, etc.) to be consistent
- with labels on ECPs. Remote temperature sensors are to be mounted in an optimal position:
 - Use RS410 (wall-mount) sensor for all HVAC units and place it 5-6 feet AFF (above finished
 - The sensor should be placed in the zone it is controlling
 - Identify a location where the sensor does not have airflow interference from a supply vent. Given the choice, place closer to return air vent instead of supply air vent.

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SURVEYOR

O'Reilly New Construction Statement of Work (SOW)

DO NOT:

Place the remote sensor on the decorative wall striping

- Place the sensor in direct airflow stream between a supply and return grille (where supply air is pulled directly into return)
- Place sensor where it receives direct heat from any piece of equipment
- Place sensor where it will be impacted by any door opening
- Place sensor near the windows where it will receive sun interference (radiant heat)
- Place sensor where it will receive heat interference from the lighting
- Outside Temperature Sensor:
 - o One per location, mount outside on roof, facing north
- Door Switches (delivery and rear man door), when applicable
 - o One switch per door, normally closed, wired in series
 - Do not install rear door switch(es) for: - Stores with one HVAC unit
 - Stores that only receive deliveries through the front door

Wiring Instructions

- Connect ECP to HVAC terminal board
- Connect Communicating Thermostat to ECP
- Connect Sensor Pac sensors to ECP
- Connect Remote Sensor to ECP
- Connect door switches (loading and rear man door) to ECP that conditions the space near doors
- Connect the RS485 terminals of the ECP to the Data Concentrator
- All wiring shall be installed and terminated in accordance with the NEC as well as any applicable state and local regulations

Hardware Configuration

- Set ECP address dip switch for each unit
- Set ECP jumper for Heat Pump or Gas/Electric
- Set ECP jumper to O or B reversing valve (Heat Pump only)

Installing the Lighting Control Panel

Hardware Placement

- Surface mount the Lighting Control Panel (LCP) at a level as convenient and feasible to the existing breaker panel
 - o It is permissible to recess the panel, if necessary
- Photocell for exterior lighting:
 - One per location
 - Mount outside on roof, horizontal and facing north with no influence from shade or
 - surroundings (trees, equipment, etc.) Connect photocell to LCP
- Motion Detectors for interior lighting:
 - Two per location typical, unless otherwise shown on MEP drawings.
 - Refer to MEP drawings for exact locations.
- Alarm Interface:
- o One per location, leave coiled above panel for connection by alarm company
- Push Button:
 - Temporary push button may be installed for use during construction.
 - Permanent push button will <u>not</u> be installed at O'Reilly Auto Parts stores except in rare cases when required by code.

Lighting Circuit Identification

- All lighting circuits shall be identified and classified into lighting zones
- Each lighting circuit shall be identified by breaker circuit number and assigned to a specific contactor

Lighting Zone Configuration

- The following describes the lighting zones controlled by Surveyor:
 - Interior Lighting (Work) Work and stock areas, excluding nighttime delivery and emergency lights
 - Interior Lighting (Sales) Sales floor, customer areas, and interior open/close sign Exterior Lighting (Sign) - Lights for store signs on building and other store signage

 - Exterior Lighting (Site) Parking lot lights, building accent lights, and other exterior lights
 - NOTE: Certain fixtures are designated night lights and are zoned to be on 24/7 for safety and security.

Wiring Instructions

- Connect lighting accessories to LCP, as appropriate
- Connect the RS485 terminal of the LCP to the Data Concentrator
- All wiring shall be installed and terminated in accordance with the NEC as well as any applicable state and

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SURVEYOR

O'Reilly New Construction Statement of Work (SOW)

Installing the Front Door Counter (Single Channel Input Module)

Hardware Placement

One switch per door at front entrance, normally closed, wired in series (for more than

Mount SCIM400D in back of store near other Surveyor hardware

Wiring Instructions

- Connect door switch(es) to SCIM400D
- Connect the RS485 terminals of the SCIM400D to the Data Concentrator
- All wiring shall be installed and terminated in accordance with the NEC as well as any

local regulations

Installing the Building Power Monitor

Hardware Placement

- Place PM401 near the breaker panel or main electrical service, as appropriate
- Place CTs to measure all phases of building power

Wiring Instructions

- Connect CTs to Power Monitor (PM401)
- Connect voltage leads and ground terminal
- Connect the RS485 terminals of the Power Monitor (PM401) to the Data Concentrator
- All wiring shall be installed and terminated in accordance with the NEC as well as any applicable state and

local regulations

Hardware Configuration

- Set slide switch for CT type
- Set CH1 rotary switch for CT size
- Set Load rotary switch for electrical service type

Commissioning

Upon completion of the installation, the contractor shall contact Surveyor Support for commissioning. The contractor shall be onsite and provide all support required during the commissioning process. The checklist below serves as a quick reference for the contractor to verify that the installation was completed successfully.

Surveyor Technical Support

surveyorsupport@venstar.com

Direct: 818-812-9812

Office: 818-341-8760

Mon-Fri 6:00am-5:00pm Pacific Time

Data Concentrator

- Confirm power and Ethernet connections
- Verify communication to all Surveyor equipment
- Contact the Surveyor Support line at 818-812-9812 to verify connectivity to the

O'Reilly server

Equipment Control Pacs

- Verify proper addressing
- Verify door switch functionality (loading and rear man door) Re-start all HVAC equipment and verify heating/cooling operation

Communicating Thermostat(s)

- Test operation in all modes
- Verify sensor readings

Lighting Control Panel and accessories

- Test Photocell
- Test Motion Detectors
- Test operation and function of twist-timer overrides
- Confirm lighting circuitry does not affect any other store equipment

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Building Power Monitor

Verify sensor readings

Front Door Counter (Single Channel Input Module)

Verify door switch functionality

VENSTAR

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DATE ISSUED


OREIII AUTO PARTS STREET I 54603 710 GEORGE S LACROSSE, WI

SHEET TITLE:

VENSTAR SURVEYOR

REVIS	SIONS:	
NO:	DATE:	BY:
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GENERAL NOTES

- (A) REFER TO PROJECT MANUAL AND SCOPE OF WORK SCHEDULE FOR ADDITIONAL REQUIREMENTS.
- (B) SITE DIMENSIONS TO FACE OF CONCRETE FOUNDATION, SIDEWALK, CURB GUTTER LINE, PROPERTY LINE, OR CENTER LINE OF STRIPING UNLESS OTHERWISE NOTED.
- C COORDINATE WORK WITH OTHER SITE RELATED DEVELOPMENT DRAWINGS.
- (D) PRIOR TO INSTALLATION, CONTRACTOR TO VERIFY LOCATIONS OF LIGHT POLES, LANDSCAPING, AND UTILITIES DO NOT CONFLICT WITH SITE SIGN LOCATION SHOWN, IF CONFLICT IS DISCOVERED, CONTRACTOR TO NOTIFY OWNER'S REPRESENTATIVE PRIOR TO PROCEEDING WITH THE WORK.
- (E) "COMING SOON" TEMPORARY CONSTRUCTION SIGN TO BE PROVIDED BY CONTRACTOR. APPLIED SIGNAGE GRAPHICS TO BE OWNER FURNISHED AND CONTRACTOR INSTALLED. LOCATE TEMPORARY CONSTRUCTION SIGN ON SITE SO AS TO BE VISIBLE TO PUBLIC FROM RIGHT-OF-WAY. REFER TO DETAIL 1/SG1.2.

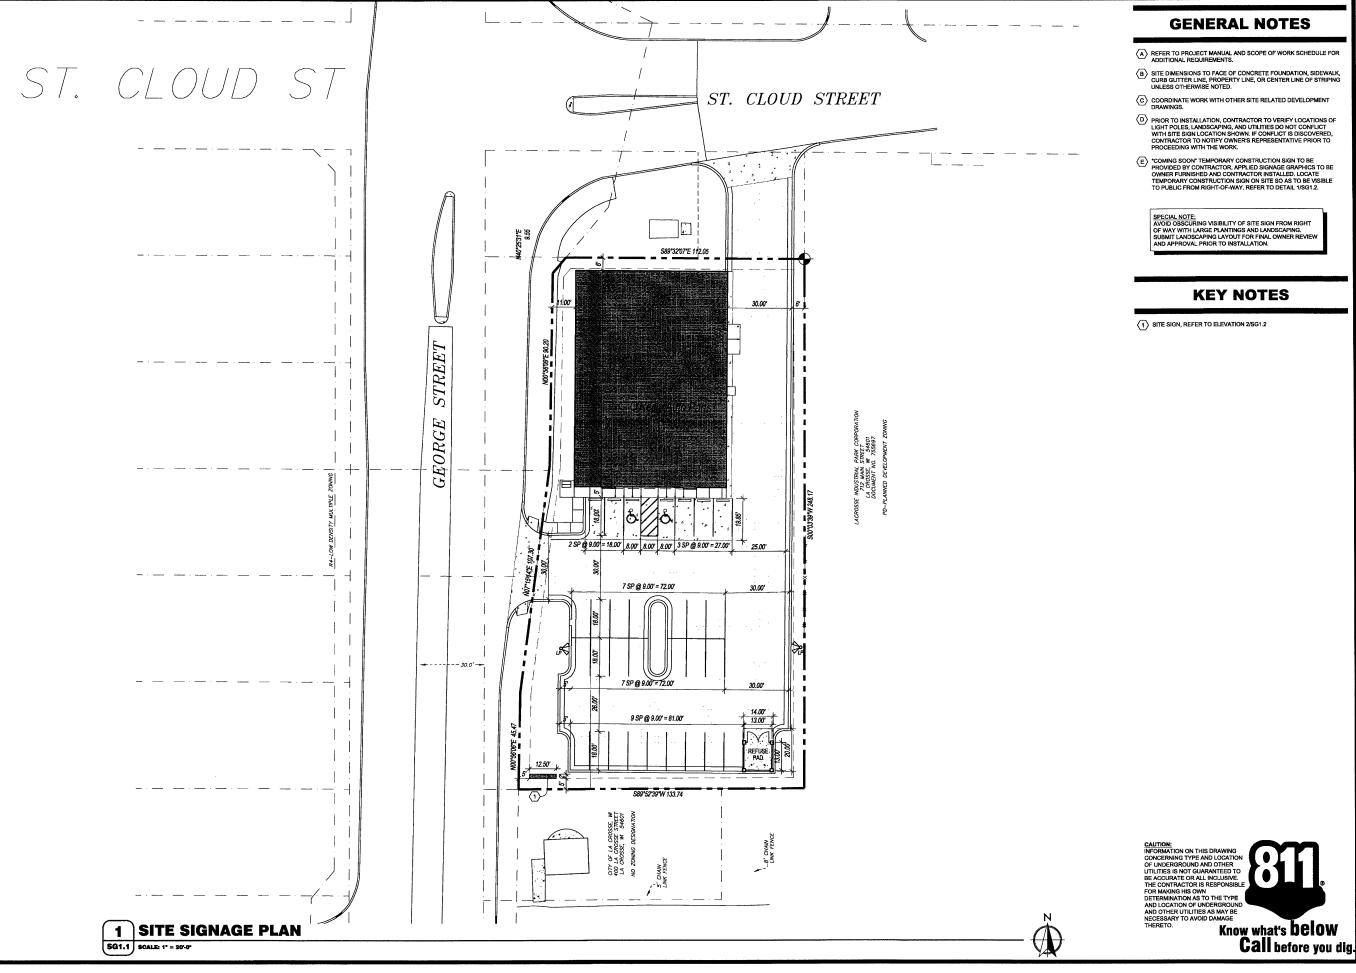SPECIAL NOTE:
AVOID OBSCURING VISIBILITY OF SITE SIGN FROM RIGHT
OF WAY WITH LARGE PLANTINGS AND LANDSCAPING.
SUBMIT LANDSCAPING LAYOUT FOR FINAL OWNER REVIEW
AND APPROVAL PRIOR TO INSTALLATION.

KEY NOTES



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CONSULTANTS:

AST, INC. 7212 METRO BLVD. EDINA, MN 55439 PHONE: 952-854-9302 FAX: 952-854-9360

SGE, INC. 3855 S JEFFERSON AVE SPRINGFIELD, MO 65807 PHONE: 417-882-2200 FAX: 417-882-1188

SEAL:



PATRICK G. BLEES, ARCHITECT

DATE ISSUED

A-9014 REG. NO.

Reilly AUTO PARTS

SHEET TITLE: SITE SIGNAGE PLAN

REVISIONS: NO: DATE: PROJECT NO: DRAWN BY:


SG1.

1 TEMPORARY CONSTRUCTION SIGN

SQ1.2 SCALE: 1/4" = 1'-0"


2 NOT USED

\$Q1.2 SCALE: 1/4" = 1'-0"

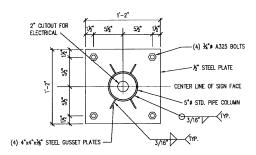

3 SIGN MATCH PLATE

SG1.2 SCALE: 1 1/2" = 1'-0"

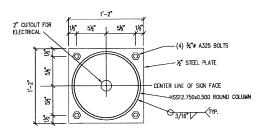

4 POLE CAP PLATE
\$G1.2 SCALE: 1 1/2" = 1'-0"

SIGN POLE ENCASED IN CONCRETE FOOTING

NOTE: VERIFY LOCATION PRIOR TO POURING TO ASSURE NO INTERFERENCE WITH ALL UTILITI

SIGN POLE

- EXISTING GRADE

ELECTRICAL CONNECTION WITH SEALANT

5 POLE FOUNDATION

SG1.2 SCALE: 3/4" = 1'-0"

GENERAL NOTES

- (A) REFER TO PROJECT MANUAL FOR ADDITIONAL REQUIREMENTS.
- (B) CONTACT OWNER'S OR TENANT'S DESIGNATED PROJECT ADMINISTRATOR FOR QUESTIONS OR CLARIFICATIONS.
- (C) PERMANENT SIGNAGE OWNER FURNISHED AND INSTALLED, (RÉFER TO SCOPE OF WORK SCHEDULE). SIGNAGE GRAPHICS PROVIDED FOR REFERENCE ONLY (N.I.C.) AND CONTRACTOR'S COORDINATION WITH SPECIFIC PROJECT CONSTRUCTION CONDITIONS.
- $\begin{picture}(c) \hline D \end{picture} \begin{picture}(c) \hline SITE SIGN FOUNDATIONS AND ROUGH-IN ELECTRICAL TO BE PROVIDED BY CONTRACTOR. \end{picture}$
- (E) REQUIRED GOVERNMENTAL PERMITS FOR PERMANENT TYPE SIGNAGE TO BE PROVIDED BY SIGN COMPANY PER OWNER'S DIRECTION (N.I.C.).
- (F) "COMING SOON" TEMPORARY CONSTRUCTION SIGN TO BE PROVIDED BY GENERAL CONTRACTOR, APPLIED SIGNAGE GRAPHICS TO BE OWNER FURNISHED AND GENERAL CONTRACTOR INSTALLED. LOCATE TEMPORARY CONSTRUCTION SIGN ON SITE SO AS TO BE VISIBLE TO PUBLIC FROM RIGHT-OF-WAY.

SITE SIGN SCHEDULE

CONSULTANTS:

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PATRICK G. BLEES planning · interior design

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SGE, INC. 3855 S JEFFERSON AVE SPRINGFIELD, MO 65807 PHONE: 417–882–2200 FAX: 417–882–1188

SEAL:



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10.14.16 DATE ISSUED A-9014 REG. NO.

REIN AUTO PARTS
712 GEORGE STREET
LA CROSSE, WI 54603

SHEET TITLE: SITE SIGNAGE DETAILS

REVISIONS:
NO: DATE: BY:


PROJECT NO: 16115.014

DRAWN BY: KJO

SG1.2

SHEET 2 OF 3

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BUILDING SIGN SCHEDULE

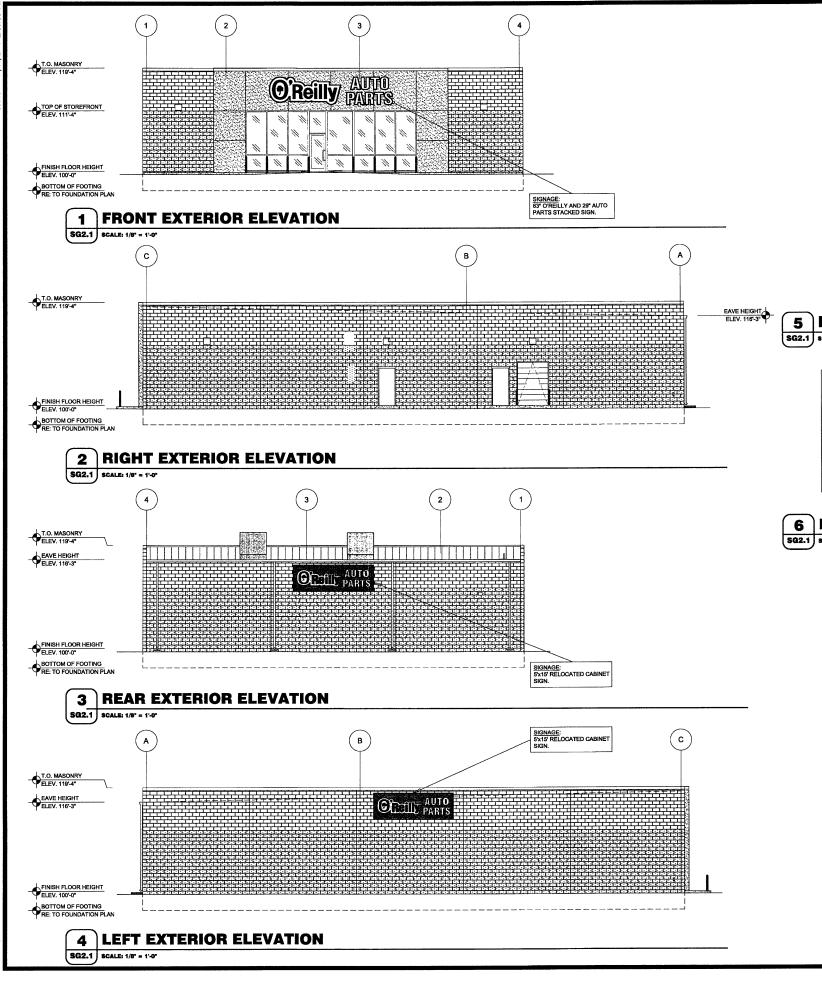FRONT EXTERIOR ELEVATION:
TYPE: OR 63* / 29" AP STACKED
DETAIL: REFER TO 5/SG2.1 & 6/SG2.1

RIGHT EXTERIOR ELEVATION: TYPE: NO SIGN DETAIL:

LEFT EXTERIOR ELEVATION:
TYPE: RELOCATED 5'x15' CABINET SIGN

REAR EXTERIOR ELEVATION:
TYPE: RELOCATED 51/15' CABINET SIGN
DETAIL:

E GENERAL NOTES

- (A) CONTACT OWNER'S OR TENANT'S DESIGNATED PROJECT ADMINISTRATOR FOR QUESTIONS OR CLARIFICATIONS.
- (B) BUILDING PERMANENT SIGNAGE OWNER FURNISHED AND INSTALLED, REFER TO SCOPE OF WORK SCHEDULE). SIGNAGE GRAPHICS PROVIDED FOR REFERENCE ONLY FULL, AND CONTRACTOR'S COORDINATION WITH SPECIFIC PROJECT CONSTRUCTION CONDITIONS. CONTRACTOR'S CONTRACTOR'S AND ROUGH-IN ELECTRICAL AS REQUIRED FOR INSTALLATION.
- (C) REQUIRED GOVERNMENTAL PERMITS FOR PERMANENT TYPE SIGNAGE TO BE PROVIDED BY OWNER OR OTHERS (N.I.C.).



Front View Scale 1/4* = 11-0* 109.49 sq. ft. (Combined Individual Components) 127.73 (Encompassed Recta

Countries — 1-07


"O'Reilly" Could Logo with "AP" channel letters on "P() is 1" (d) wireways. Wherevey pain its: COAP REID

"O'Reilly" Could Logo is formed polycarb with double embossment with 2nd surface painted graphics. Paint match to: Green (PMSS 342c), Black and White

"AP" to have formed polycarb cape with "If "I letter Youngs", Black 5" allumination coll returns. And safets Black and White paint. WHITE LEID Humination.

5 FRONT WALL SIGN ELEVATION

SG2.1 SCALE: 1/4" = 1'-0"

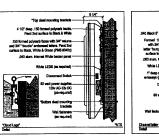

Formed Cloud Logo with "AP" Formed Caps & Channel Returns Part# 63/29-S-CldLogo&Chitrs-WFC

6 FRONT WALL SIGN MOUNTING DETAILS

SQ2.1 SCALE: 1/4" = 1'-0"

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SEAL:



PATRICK G. BLEES, ARCHITECT

10.14.16 DATE ISSUED A-9014 REG. NO.

712 GEORGE STREET
LA CROSSE, WI 54603

SHEET TITLE:
BUILDING EXTERIOR
SIGNAGE

SIONS:	
DATE:	BY:
CT NO:	16115.014
BY:	KJO/BLC
	DATE:

SG2.1

SHEET 3 OF 3

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