# LA CROSSE REGIONAL AIRPORT CAR RENTAL FACILITY

LA CROSSE, WISCONSIN


ISG PROJECT # 16-19065



PRELIMINARY NOT FOR CONSTRUCTION

ABBREVIATIONS				<b>MATERIALS KEY</b>	TAGS AN	ID SYMBOLS						
										SECTION NUMBER		
#	POUND OR NUMBER AT	EX	EXISTING	MTD	MOUNTED	TEL	TELEPHONE	DATT INCLUATION		→ SHEET NUMBER		ONLY ONE DOOR
@ A.C.T.	ACOUSTICAL CEILING TILE	EXP EXT	EXPANSION EXTERIOR	MULL NA	MULLION NOT APPLICABLE	TEMP TER	TEMPERATURE TERRAZZO	BATT INSULATION		SHEET NOWBER		IN A ROOM
ADA	AMERICANS WITH DISABILITIES ACT	F&I	FURNISH AND INSTALL	NIC	NOT AFFEICABLE  NOT IN CONTRACT	TO	TOP OF		SECTION		DOOR NUMBERS	
ADD	ADDENDUM	FA	FRESH AIR	NTS	NOT TO SCALE	TP	TOILET PARTITION			\AX.XX/	DOOK NOWIBERS	
ADDL	ADDITIONAL	FAAP	FIRE ALARM ANNUNCIATOR PANEL	OC / O.C.	ON CENTER	TR	TAMPER RESISTANT	//// BRICK				(100A)
ADJ	ADJACENT	FACP	FIRE ALARM CONTROL PANEL	OCEW /	ON CENTER EACH WAY	TRANF	TRANSFORMER					<b>—</b>
AFF	ABOVE FINISH FLOOR	FD	FLOOR DRAIN	O.C.E.W.	OUTOIDE DIAMETED	TS	TUBE STEEL / THRESHOLD / TRANSITION STRIP		INTERIOR (	ELEVATION NUMBER		MULTIPLE DOORS —
AHU	AIR HANDLING UNIT	FE	FIRE EXTINGUISHER	OD OH	OUTSIDE DIAMETER OVERHEAD	TV	TELEVISION	CONCRETE (SECTION)	INTERIOR /	SHEET NUMBER		IN A ROOM
ALT ALUM	ALTERNATE ALUMINUM	FEC FF	FIRE EXTINGUISHER CABINET FLOOR FINISH	OL	OVERALL LENGTH	TYP UH	TYPICAL UNIT HEATER	CONCRETE (SECTION)	EXTERIOR	AX.XX		
APPROX	APPROXIMATELY	FFE	FINISHED FLOOR ELEVATION	OPNG	OPENING	UNO	UNLESS NOTED OTHERWISE		ELEVATION			
ARCH	ARCHITECTURAL	FRP	FIBERGLASS REINFORCED PLASTIC	OSB	ORIENTED STRAND BOARD	VCT	VINYL COMPOSITE TILE				WALL TYPE	M12
BD	BOARD	FRZ	FREEZER	PC	PHOTO CELL	VERT	VERTICAL	CMU (SECTION)				
BLDG	BUILDING	FT	FOOT OR FEET	PLAM	PLASTIC LAMINATE	VEST	VESTIBULE					
ВО	BOTTOM OF	FTG	FOOTING	PLWP	PLASTIC LAMINATE WALL PANEL	VIF	VERIFY IN FIELD			▲ <sup>2</sup> → ELEVATION NUMBERS		
BRG	BEARING	GA	GAUGE	PNT POLYETH	PAINT	VTR	VENT THROUGH ROOF	EARTH				
BSMT CG	BASEMENT CORNER CHARD	GALV	GALVANIZED GENERAL CONTRACTOR	POLYETH	POLYETHYLENE POLYISOCYANURATE	VWP W/	VENEER WALL PANEL WITH		INTERIOR	7,,,,,,	<b>WINDOW TYPE</b>	[W1]
CIP	CORNER GUARD CAST IN PLACE	GC GFCI	GROUND FAULT CIRCUIT INTERRUPT	PRV	POWER ROOF VENTILATOR	W/O	WITH		ELEVATION	AX.XX	_	
Cil	CONTROL JOINT	GL	GLAZING	PVC	POLYVINYL CHLORIDE	WC	WATER CLOSET	GRANULAR FILL	(ALTERNATIVE)			
CL	CENTERLINE	GYP	GYPSUM	QT	QUARRY TILE	WCG	WALL COVERING	OVANULAR TILL	(**= * = * * * * * * * * * * * * * * * *	SHEET NUMBER		
CLG	CEILING	HD	HUB DRAIN	QTZ	QUARTZ	WD	WOOD			4		( 4 )
CLR	CLEAR	HDW	HARDWARE	RA	RETURN AIR	WF	WALL FINISH					( 1
CM	CORRUGATED METAL	HM	HOLLOW METAL	RB RBR	RESILIENT BASE RUBBER	WG	WALL GUARD	GRAVEL	DE	TAIL NUMBER —		
CMU	CONCRETE MASONRY UNIT	HORIZ	HORIZONTAL	RCP	REFLECTED CEILING PLAN	WH WHTR	WALL HYDRANT		QL	HEET NUMBER2		_
CO CONC	CLEANOUT CONCRETE	HSS HT	HOLLOW STRUCTURAL SECTION HEIGHT	RD	ROOF DRAIN	WHIR	WATER HEATER WEATHERPROOF (ELEC)	OVPOLIM POARD		A1.21	NEW	
CONF	CONFERENCE	HVAC	HEATING VENTILATION AND AIR CONDITIONING	REF	REFRIGERATOR	WWF	WELDED WIRE FABRIC	GYPSUM BOARD		$\sim$	CONSTRUCTION	( <b>A</b> )— '— —
CONT	CONTINUOUS	ID	INSIDE DIAMETER	REINF	REINFORCED		WEEDED WINE LY, BING	OR SHEATHING				
CPT	CARPET	IG	ISOLATED GROUND	REQD	REQUIRED				DETAIL CALLOUT	•	GRIDS	
CR	CHAIR RAIL	INFO	INFORMATION	REV	REVISION / REVISED			RIGID INSULATION	DETAIL GALLOGT	1		
CRK	CORK	INP	IN-PLACE	RM RO	ROOM ROUGH OPENING			MOD INSOLATION		AREA OF DETAIL		
CT CY	CERAMIC TILE CUBIC YARD	INSUL INT	INSULATION INTERIOR	ROW / R/W	RIGHT OF WAY							
DEMO	DEMOLITION	JAN	JANITOR	RTU	ROOF TOP UNIT			PLYMACOR				
DE	DRINKING FOUNTAIN	JST	JOIST	SA	SUPPLY AIR			PLYWOOD				l
DH	DOOR HOLDER (MAGNETIC)	LAV	LAVATORY	SC	SEALED CONCRETE			<del>&gt;&gt;&gt;&gt;&gt;&gt;&gt;</del>				
DIA	DIAMETER	LB	POUND	SF	SQUARE FOOT				F1 F1/4-101/	LEVEL 1 100'-0"		
EA	EACH	LLH	LONG LEG HORIZONTAL	SIM	SIMILAR			SAND	ELEVATION	4001.011		
EF	EXHAUST FAN	LLV	LONG LEG VERTICAL	SM SPEC	SURFACE MOUNTED			<u> </u>		100'-0"		
EIFS	EXTERIOR INSULATION FINISH SYSTEM	LN	LINEAR LUXURY VINYL TILE	SPEC	SPECIFICATION SOLID SURFACE							〈 <b>2</b> 〉
ELEC ELEV	ELECTRICAL ELEVATION	LVT MATL	MATERIAL	SSTL	STAINLESS STEEL							\ _ /
EMERG	EMERGENCY	MAX	MAXIMUM	STD	STANDARD			STEEL				
ENCL	ENCLOSURE	MECH	MECHANICAL	STN	STONE					VIEW NAME		
EPDM	ETHYLENE PROPYLENE DIENE MONOMER	MEZZ	MEZZANINE	STOR	STORAGE				DRAWING TITLE	/ 1 \ \ \ \ \ \ \ \ \ \ \ \ \ \ \ \ \ \	EXISTING	/ _ \
EPX	EPOXY	MFR	MANUFACTURER	SUSP	SUSPENDED			SYNTHETIC STUCCO		1/4" = 1'-0"	CONSTRUCTION	⟨ B ⟩
EQ	EQUAL	MH	MANHOLE	SV	SHEET VINYL					/ 1/4 - 1-0	GRIDS	
EQUIP	EQUIPMENT	MIN	MINIMUM	SY T&G	SQUARE YARDS							
ETC EWC	ETCETERA ELECTRIC WATER COOLER	MISC MO	MISCELLANEOUS MASONRY OPENING	T&P	TONGUE AND GROOVE TEMPERATURE AND PRESSURE			WOOD		ROOM NAME		ı
EVVC	LLLOTRIC WATER COULER	IVIO	ININOCINTI OFEINING	101	. Lim Livitone / MD I NEGOGILE			WOOD	ROOM NAME			I
									AND NUMBER	101		

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#### CONTRACT DOCUMENTS SHALL BE ISSUED TO ALL SUBCONTRACTORS BY THE GENERAL CONTRACTOR IN COMPLETE SETS IN ORDER TO ACHIEVE THE FULL EXTENT AND COMPLETE COORDINATION OF ALL WORK. CONTRACTOR IS RESPONSIBLE FOR COORDINATING AND CORRELATING QUANTITIES AND WRITTEN DIMENSIONS TAKE PRECEDENCE OVER SCALED DIMENSIONS. NOTIFY ARCHITECT/ENGINEER OF ANY DISCREPANCIES OR CONDITIONS REQUIRING INFORMATION OR CLARIFICATION BEFORE PROCEEDING WITH THE WORK. DETAILS SHOWN ARE INTENDED TO BE INDICATIVE OF THE PROFILES AND TYPE OF DETAILING REQUIRED THROUGHOUT THE WORK. DETAILS NOT SHOWN ARE SIMILAR IN CHARACTER TO DETAILS SHOWN. WHERE SPECIFIC DIMENSIONS, DETAILS OR DESIGN INTENT CANNOT BE DETERMINED, NOTIFY ARCHITECT / ENGINEER BEFORE PROCEEDING WITH THE WORK. ALL MANUFACTURED ARTICLES, MATERIALS AND EQUIPMENT SHALL BE APPLIED, INSTALLED, CONNECTED, ERECTED, CLEANED AND CONDITIONED ACCORDING TO MANUFACTURERS' INSTRUCTIONS. IN CASE OF DISCREPANCIES BETWEEN MANUFACTURERS' INSTRUCTIONS AND THE CONTRACT DOCUMENTS, NOTIFY SMALLER-SCALE, LESS SPECIFIC DETAILS AND INFORMATION. MORE STRINGENT REQUIREMENTS FOR CODE, PRODUCTS AND INSTALLATION TAKE PRECEDENCE OVER LESS STRINGENT REQUIREMENTS. NOTIFY ARCHITECT/ENGINEER OF ANY DISCREPANCIES OR CONDITIONS REQUIRING INFORMATION OR CLARIFICATION PROVIDE CONTINUOUS SEALANT AROUND ALL MATERIALS AT EXTERIOR WALL PENETRATIONS. REFER TO SPECIFICATIONS FOR APPROPRIATE SEALANT. ALL DISSIMILAR METALS SHALL BE EFFECTIVELY ISOLATED FROM EACH OTHER TO AVOID GALVANIC CORROSION. SEAL ALL OPENINGS IN WALLS, FLOORS, CEILINGS, AND ROOFS, AROUND DUCTS, PIPES, VENTS, TRAPS, CONDUIT AND ALL OTHER PENETRATIONS WITH FIRESTOPPING AS SPECIFIED AND REQUIRED BY CODES. PROVIDE SOLID WALL BACKING WITH METAL OR FIRE-RETARDANT WOOD BLOCKING BEHIND DOOR HARDWARE SUCH AS WALL STOPS, BUMPERS, HOLD
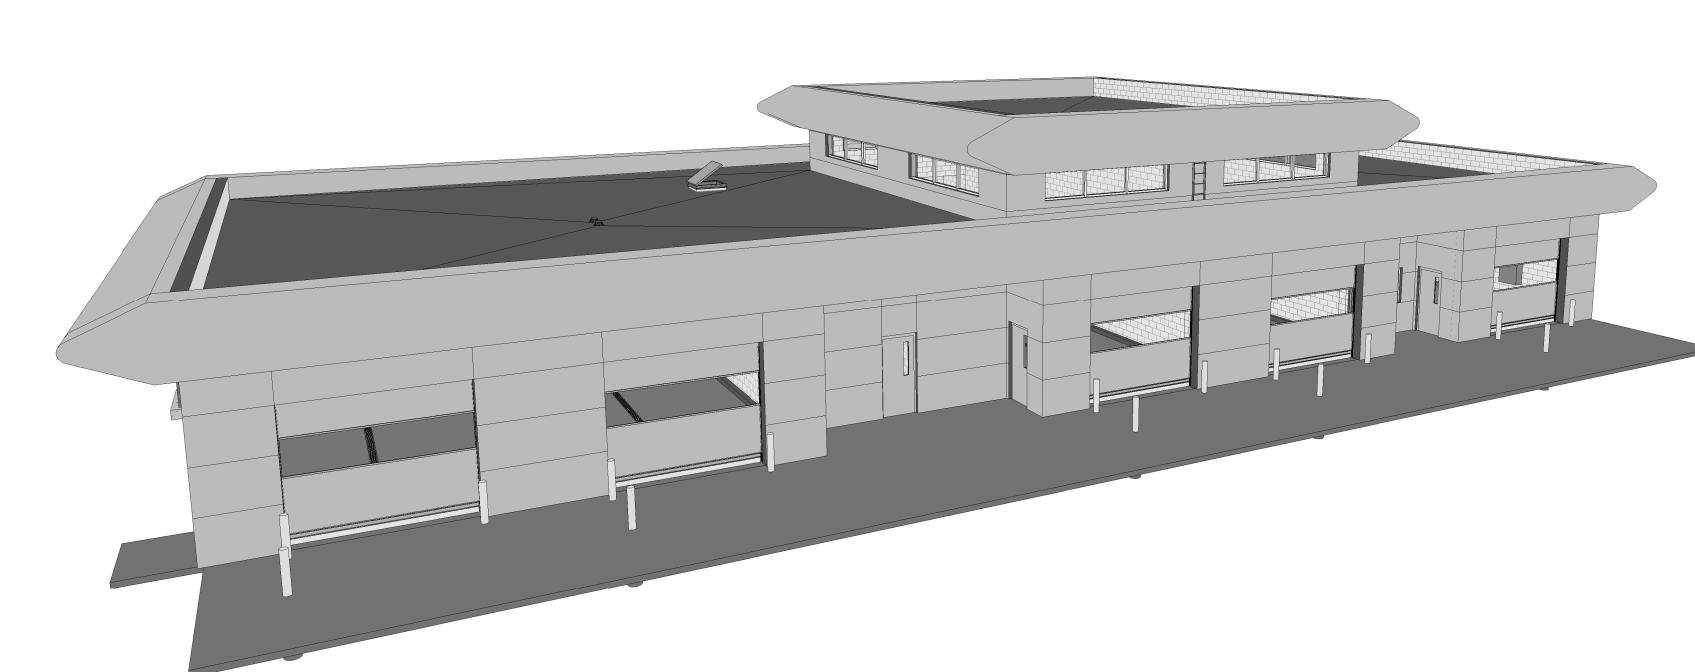
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## **CAR RENTAL FACILITY**

LA CROSSE **WISCONSIN REVISION SCHEDULE** DESCRIPTION

ROJECT NO.	ISG Project No. 19065
ILE NAME	19065 Arch R-17.rvt
RAWN BY	RRW
ESIGNED BY	KMB
EVIEWED BY	KMB
RIGINAL ISSUE DATE	03/31/2017
LIENT PROJECT NO.	

## PROJECT INDEX:

**OWNER:** 

LA CROSSE REGIONAL AIRPORT 2850 AIRPORT DR. LA CROSSE, WI 54603

**PROJECT ADDRESS:** 

LA CROSSE REGIONAL AIRPORT **CAR RENTAL FACILITY** 2840 AIRPORT DR. LA CROSSE, WI 54603

**MANAGING OFFICE:** 


LA CROSSE OFFICE **201 MAIN STREET SUITE 1020** 

ISG

LA CROSSE, WI 54601 PHONE: 608.789.2034 **PROJECT MANAGER: KEVIN BILLS** EMAIL: kevin.bills@is-grp.com

TITLE SHEET, SHEET INDEX, **PROJECT GENERAL NOTES** 

**G1-11** 

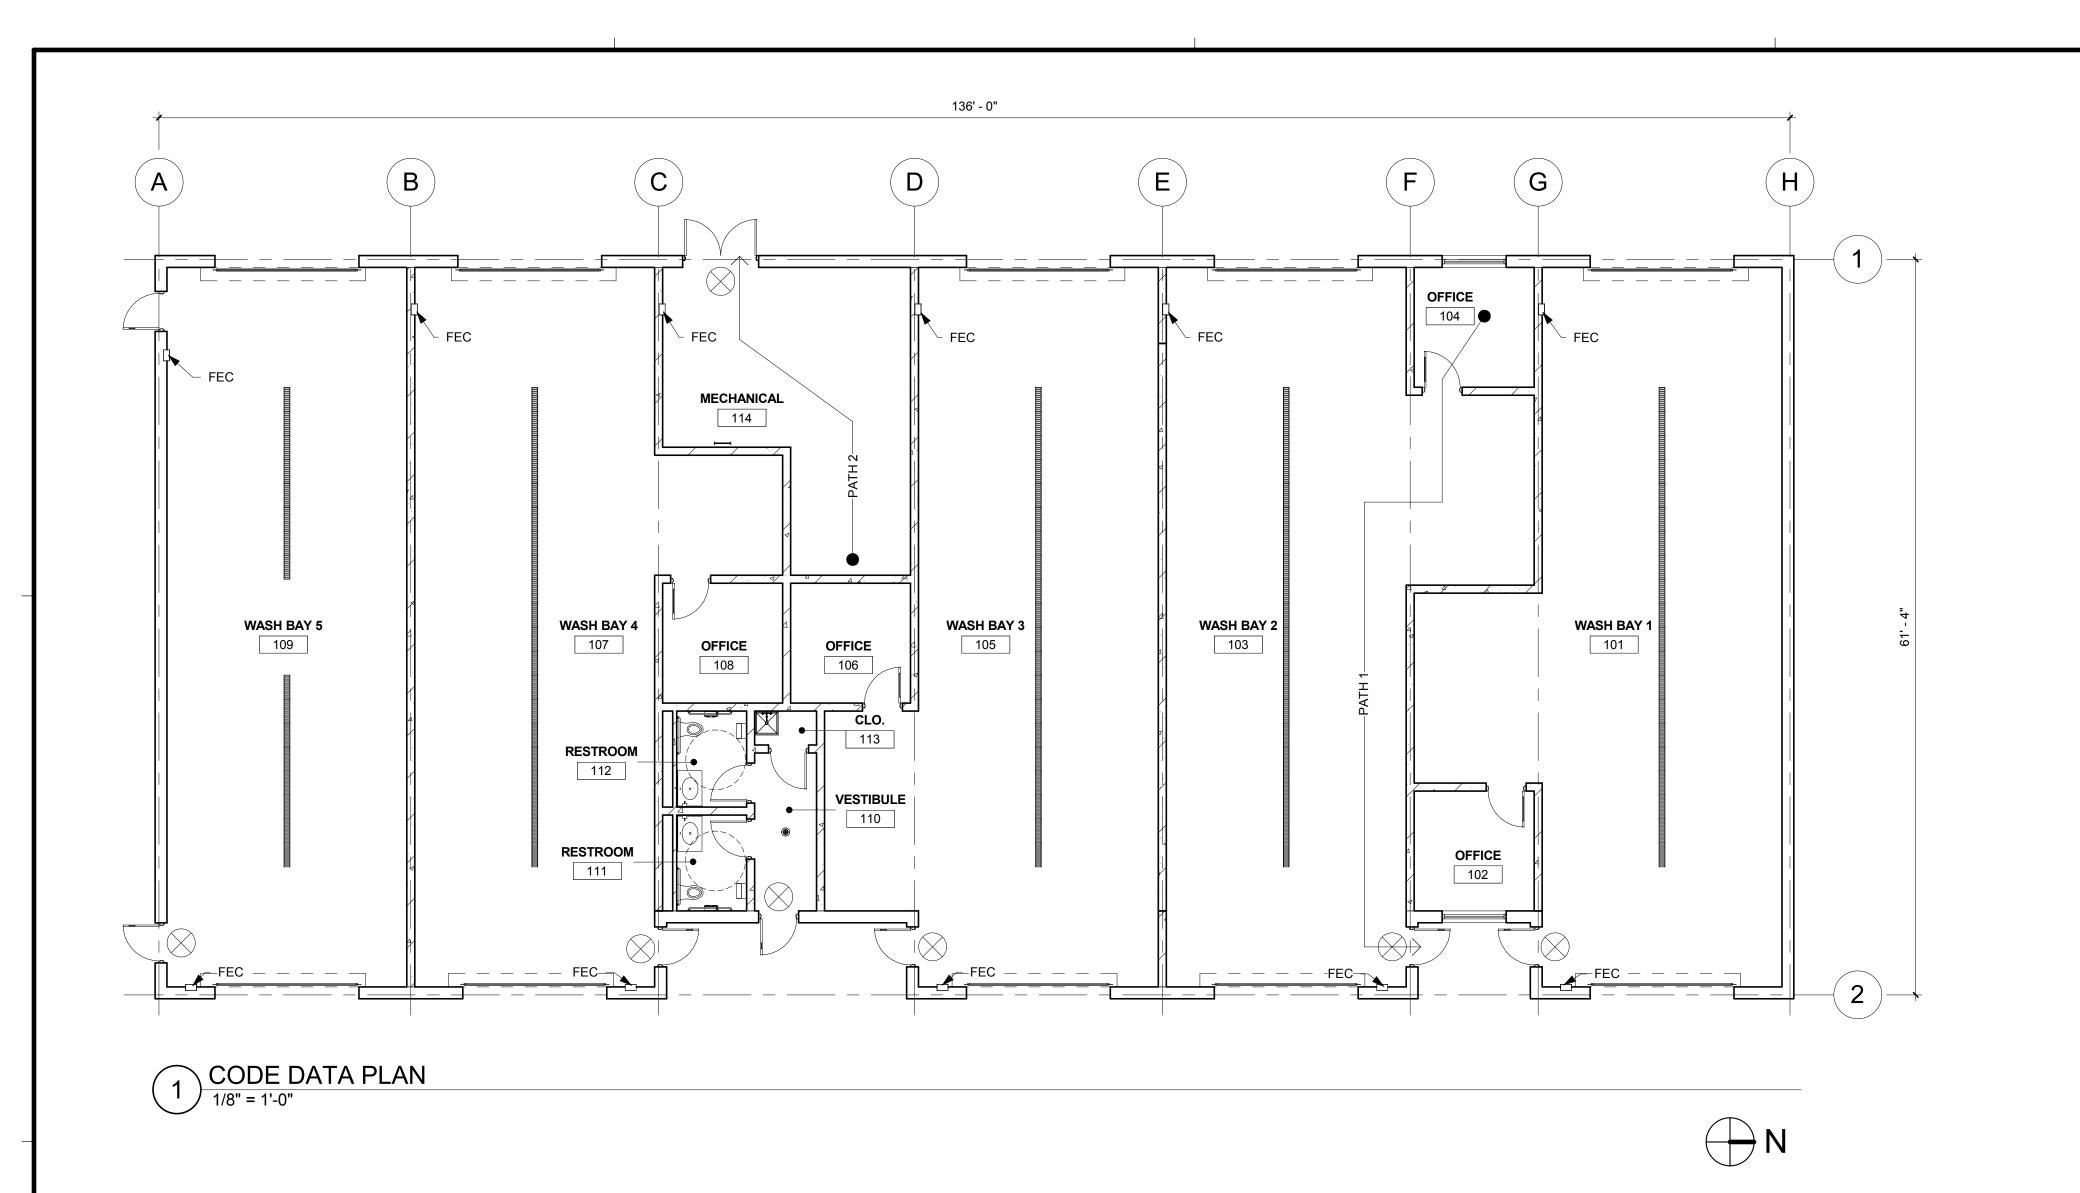

**GENERAL CODE DATA** 

CLIENT: LA CROSSE REGIONAL AIRPORT 2850 AIRPORT DRIVE

LA CROSSE, WI 54601

ARCHITECT:

201 MAIN STREET, SUITE 1020

LA CROSSE, WI 54601

**BUILDING LOCATION:** RENTAL CAR FACILITY

2850 AIRPORT DRIVE LA CROSSE, WI 54601

## APPLICABLE CODES:

2009 INTERNATIONAL BUILDING CODE (IBC) WISCONSIN COMMERCIAL BUILDING CODE, CHAPTER 62 2009 INTERNATIONAL MECHANICAL CODE (IMC) WISCONSIN COMMERCIAL BUILDING CODE, CHAPTER 61 - 84

2008 NATIONAL ELECTRICAL CODE (NEC) WISCONSIN COMMERCIAL BUILDING CODE, CHAPTER 16 2009 INERNATIONAL ENERGY CONSERVATION CODE (IECC) 2009 INTERNATIONAL FUEL GAS CODE (IFGC) WISCONSIN COMMERCIAL BUILDING CODE, CHAPTER 65

2009 NFPA-1 / LIFE SAFETY CODE

#### OCCUPANCY CLASSIFICATIONS:

BUSINESS GROUP S-1: 8,376 S.F.

CONSTRUCTION TYPE: IIB

BASIC ALLOWABLE S-1 AREA: 17,500 S.F.

BASIC ALLOWABLE BUIDING AREA (IBC TABLE 503):

ACTUAL AREA: 8,376 S.F.

### BASIC ALLOWABLE BUIDING HEIGHT (IBC TABLE 503):

BASIC ALLOWABLE S-1 HEIGHT: 2 STORIES / 55 FEET ACTUAL AREA: 1 STORY / 26 FEET

#### OCCUPANT LOAD:

STORAGE AREA (S-1 MODERATE HAZARD): 8,376 S.F. / 100 S.F. PER OCCUPANT = 84 OCCUPANTS

TOTAL OCCUPANCY = 84 OCCUPANTS

#### **EXIT WIDTH:**

MINIMUM REQUIRED EGRESS WIDTH: (84 OCCUPANTS)(0.2) = 16.8 INCHES TOTAL EXIT WIDTH PROVIDED: 252 INCHES DIRECTLY TO EXTERIOR (7) 3'-0"

#### PLUMBING FIXTURES REQUIRED:

#### **BUSINESS GROUP B**

84 OCCUPANTS / 2 = 42 MEN AND 42 WOMEN

1 PER 100 PERSONS = REQUIRED WATER CLOSETS .42 WATER CLOSETS FOR MEN .42 WATER CLOSETS FOR WOMEN

1 PER 100 PERSONS = REQUIRED LAVATORIES .42 LAVATORIES FOR MEN

WISCONSIN COMMERCIAL BUILDING CODE, CHAPTER 14 & 30 .42 LAVATORIES FOR WOMEN

#### TOTAL PLUMBING FIXTURES REQUIRED:

.42 WATER CLOSET FOR MEN .42 WATER CLOSET FOR WOMEN .42 LAVATORY FOR MEN .42 LAVATORY FOR WOMEN

.02 HI/LO DRINKING FOUNTAIN

1 LAVATORY FOR WOMEN

TOTAL PLUMBING FIXTURES PROVIDED: 1 WATER CLOSET FOR MEN 1 WATER CLOSET FOR WOMEN 1 LAVATORY FOR MEN

CODE DATA PLAN KEY			
(	$\otimes$	EXIT	
	<b>b</b>	FIRE EXTINGUISHER	
		FIRE EXTINGUISHER CABINET	
	КВ	KNOX BOX	

EGRESS PATH SCHEDULE					
PATH MARK	TRAVEL DISTANCE	EGRESS WIDTH	COMMENTS		
PATH 1	64' - 11"	3' - 0"			
PATH 2	30' - 1"	3' - 0"			

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PRELIMINARY NOT FOR CONSTRUCTION

LA CROSSE **REGIONAL AIRPORT** 

## **CAR RENTAL FACILITY**

**REVISION SCHEDULE** DESCRIPTION

WISCONSIN

PROJECT NO	o. 19065	
ILE NAME	19065 Arch R-17.rvt	
DRAWN BY	RRW	
DESIGNED E	BY KMB	

ORIGINAL ISSUE DATE 03/31/2017 CLIENT PROJECT NO.

TITLE


REVIEWED BY

## **CODE DATA AND CODE DATA PLAN**

SHEET

**G1-21** 

MOUNTING HEIGHTS AND STANDARDS

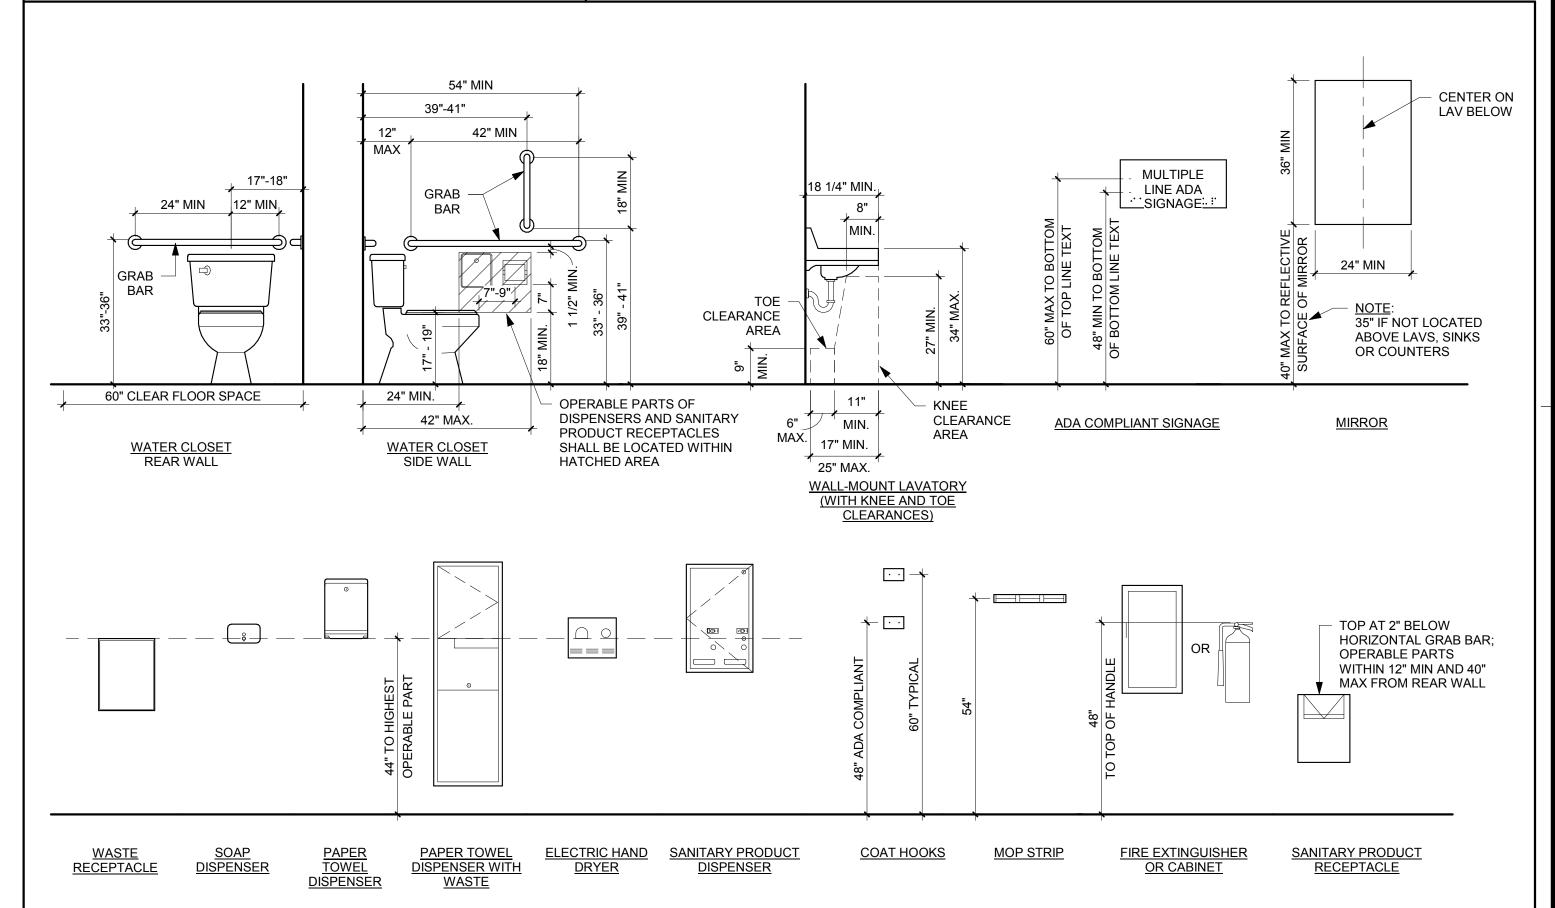



### **LOCATION MAP**

LOT LINE

EASEMENT

CULVERT

GAS

CONTOUR

MANHOLE

**HYDRANT** 

VALVE

**CATCH BASIN** 

RIGHT OF WAY

STORM SEWER

SANITARY SEWER

OVERHEAD ELECTRIC

STORM SEWER (PIPE WIDTH)

SANITARY SEWER (PIPE WIDTH)

1" = 1000'

**PROPOSED** 

#### **PROJECT GENERAL NOTES**

- ALL WORK SHALL CONFORM TO THE CONTRACT DOCUMENTS, WHICH INCLUDE, BUT ARE NOT LIMITED TO, THE OWNER - CONTRACTOR AGREEMENT, THE PROJECT MANUAL (WHICH INCLUDES GENERAL SUPPLEMENTARY CONDITIONS AND SPECIFICATIONS), DRAWINGS OF ALL DISCIPLINES AND ALL ADDENDA, MODIFICATIONS AND CLARIFICATIONS ISSUED BY THE ARCHITECT/ENGINEER.
- CONTRACT DOCUMENTS SHALL BE ISSUED TO ALL SUBCONTRACTORS BY THE GENERAL CONTRACTOR IN COMPLETE SETS IN ORDER TO ACHIEVE THE FULL EXTENT AND COMPLETE COORDINATION OF ALL WORK.
- WRITTEN DIMENSIONS TAKE PRECEDENCE OVER SCALED DIMENSIONS. NOTIFY ARCHITECT/ENGINEER OF ANY DISCREPANCIES OR CONDITIONS REQUIRING INFORMATION OR CLARIFICATION BEFORE PROCEEDING WITH THE WORK.
- 4. RADII ARE MEASURED TO THE BACK OF CURB UNLESS OTHERWISE SHOWN OR NOTED ON THE PLANS
- FIELD VERIFY ALL EXISTING CONDITIONS AND DIMENSIONS. NOTIFY ARCHITECT/ENGINEER OF ANY DISCREPANCIES OR CONDITIONS REQUIRING INFORMATION OR CLARIFICATION BEFORE PROCEEDING WITH THE WORK.
- DETAILS SHOWN ARE INTENDED TO BE INDICATIVE OF THE PROFILES AND TYPE OF DETAILING REQUIRED THROUGHOUT THE WORK. DETAILS NOT SHOWN ARE SIMILAR IN CHARACTER TO DETAILS SHOWN. WHERE SPECIFIC DIMENSIONS, DETAILS OR DESIGN INTENT CANNOT BE DETERMINED, NOTIFY ARCHITECT/ENGINEER BEFORE PROCEEDING WITH
- ALL MANUFACTURED ARTICLES, MATERIALS AND EQUIPMENT SHALL BE APPLIED, INSTALLED, CONNECTED, ERECTED, CLEANED AND CONDITIONED ACCORDING TO MANUFACTURERS' INSTRUCTIONS. IN CASE OF DISCREPANCIES BETWEEN MANUFACTURERS' INSTRUCTIONS AND THE CONTRACT DOCUMENTS, NOTIFY ARCHITECT/ENGINEER BEFORE PROCEEDING WITH THE WORK.
- 8. ALL DISSIMILAR METALS SHALL BE EFFECTIVELY ISOLATED FROM EACH OTHER TO AVOID GALVANIC CORROSION.
- THE LOCATION AND TYPE OF ALL INPLACE UTILITIES SHOWN ON THE PLANS ARE FOR GENERAL INFORMATION ONLY AND ARE ACCURATE AND COMPLETE TO THE BEST OF THE KNOWLEDGE OF I & S GROUP, INC. (ISG). NO WARRANTY OR GUARANTEE IS IMPLIED. THE CONTRACTOR SHALL VERIFY THE SIZES, LOCATIONS AND ELEVATIONS OF ALL INPLACE UTILITIES PRIOR TO CONSTRUCTION. CONTRACTOR SHALL IMMEDIATELY NOTIFY ENGINEER OF ANY DISCREPANCIES OR VARIATIONS FROM PLAN.
- 10. PAVEMENT AND CURB REMOVAL TO THE NEAREST JOINT OR SAWED/MILLED EDGE WILL BE REQUIRED AS DIRECTED BY THE ENGINEER.
- 11. WHEN A PORTION OF EXISTING ASPHALT SURFACES ARE TO BE REMOVED TO ACCOMMODATE NEW CONSTRUCTION, THE LINE OF SUCH REMOVAL SHALL BE NEATLY DELINEATED WITH A SAW CUT JOINT THROUGH THE ASPHALT SURFACE SO THAT REMOVAL OF THE ASPHALT SHALL BE ACCOMPLISHED WITHOUT DAMAGE TO REMAINING PORTIONS. THE LOCATION OF SAW JOINTS AND THE AMOUNT REMOVED WILL BE DETERMINED IN THE FIELD BY THE ENGINEER.
- 12. IT IS THE RESPONSIBILITY OF THE CONTRACTOR TO KEEP EXISTING DRAINAGE STRUCTURES FUNCTIONAL DURING EXCAVATION OPERATIONS TO PROVIDE TEMPORARY DRAINAGE.
- 13. NO TREES OR SHRUBS SHALL BE REMOVED UNLESS SUCH TREES OR SHRUBS HAVE BEEN DESIGNATED FOR REMOVAL BY THE ENGINEER.

### **PROJECT GENERAL NOTES**

- 14. SIGNS THAT MUST BE REMOVED FOR GRADING SHALL BE REMOVED AND STORED AT A LOCATION DETERMINED BY THE ENGINEER. SIGNS SHALL REMAIN IN PLACE UNTIL CONSTRUCTION OPERATIONS REQUIRE THEIR REMOVAL UNLESS THE ENGINEER APPROVES THEIR REMOVAL.
- 15. STORM SEWER SHALL HAVE RUBBER GASKET JOINTS.
- 16. ADJUSTMENT RINGS ON CATCH BASINS AND MANHOLES SHALL NOT BE LESS THAN 2
- 17. ALL NEW STORM SEWER MANHOLES WILL BE INSTALLED WITHOUT STEPS.
- 18. EROSION CONTROL FEATURES AS SHOWN ON THE PLANS ARE AT THE SUGGESTED LOCATIONS. THEIR EXACT LOCATIONS WILL BE DETERMINED IN THE FIELD BY THE
- 19. AFTER PLACING CURB AND GUTTER, ANY ACCESS CONCRETE PROTRUDING BEYOND THE BACK OF CURB SHALL BE REMOVED BY THE CONTRACTOR PRIOR TO BACK FILLING.
- 20. ELEVATION ADJUSTMENTS OF WATER SERVICE CURB BOXES ARE INCIDENTAL TO THE CONTRACT. VALVE BOXES ARE PAID BY BID ITEM.
- 21. THE CONTRACTOR IS TO CONTACT "DIGGER'S HOTLINE" FOR UTILITY LOCATIONS, MINIMUM 3 BUSINESS DAYS PRIOR TO ANY EXCAVATION / CONSTRUCTION (811 OR 1-800-242-8511).

#### PROJECT DATUM

HORIZONTAL COORDINATES HAVE BEEN REFERENCED TO THE NORTH AMERICAN DATUM OF 1983 (NAD83), 1996 ADJUSTMENT (NAD83(1996)) ON THE LA CROSSE COUNTY COORDINATE SYSTEM, IN Ú.S. SURVEY FEET.

#### **TOPOGRAPHIC SURVEY**

THIS PROJECTS TOPOGRAPHIC SURVEY CONSISTS OF DATA COLLECTED ON 07/16 & 02/17 BY

**B.M. ELEVATION = XXXX.XX** 

## **LEGEND**

<b>EXISTING</b>	
	CITY LIMITS
	SECTION LINE
	QUARTER SECTION LINE
	RIGHT OF WAY LINE
	PROPERTY / LOTLINE
	EASEMENT LINE
ΔΔ	ACCESS CONTROL
	WATER EDGE
WET	WETLAND BOUNDARY
<u>मार मार मार मार मार</u>	WETLAND / MARSH
XXXX	FENCE LINE
><	CULVERT
	STORM SEWER
	SANITARY SEWER
	SANITARY SEWER FORCEMAIN
	WATER
UT	UNDERGROUND TELEPHONE
——————————————————————————————————————	OVERHEAD ELECTRIC
——————————————————————————————————————	UNDERGROUND ELECTRIC
——————————————————————————————————————	UNDERGROUND TV
——————————————————————————————————————	GAS
——————————————————————————————————————	UNDERGROUND FIBER OPTIC
<u> </u>	CONTOUR (MAJOR)
— — <u> </u>	CONTOUR (MINOR)
{·}	DECIDUOUS TREE
	CONIFEROUS TREE
	TREE LINE
$\bigcirc$	MANHOLE/STRUCTURE
	CATCH BASIN
- <b>Ó</b> -	HYDRANT
$\bowtie$	VALVE
8	CURB STOP
Ø	POWER POLE

UTILITY PEDESTAL / CABINET

### UTILITY CONTACT INFORMATION

CHARTER COMMUNICATIONS PO BOX 279 ONALASKA, WI 54650 ATTN: PERRY MCCLELLAN PHONE: (608)783-8130 EMAIL: PMCCLELLAN@CHARTERCOM.COM CENTURYLINK 333 N FRONT ST LA CROSSE, WI 54601 ATTN: BRIAN STELPLUGH

PHONE: (608) 796-5142

EMAIL: BRIAN.STELPLUGH@CENTURYLINK.COM UNDERGROUND ELECTRIC UNDERGROUND TV XCEL ENERGY - ELECTRIC 3215 COMMERCE ST LA CROSSE, WI 54602-0727 ATTN: CHRIS CARLSON PHONE: (608) 789-3979

> XCEL ENERGY - GAS 3215 COMMERCE ST LA CROSSE, WI 54602-0727 ATTN: DAN MARTI PHONE: (608) 789-3629 EMAIL: DANIEL.R.MARTI@XCELENERGY.COM

> > LA CROSSE WATER UTILITY 400 LA CROSSE ST LA CROSSE, WI 54601 ATTN: MARK JOHNSON PHONE: (608) 789-7384 EMAIL: JOHNSONM@CITYOFLACROSSE.ORG

> > LA CROSSE WASTE WATER UTILITY 905 HOUSKA PARK DRIVE LA CROSSE, WI 54601 ATTN: RICK DOERING PHONE: (608) 789-7324 EMAIL: DOERINGR@CITYOFLACROSSE.ORG

CITY OF LA CROSSE - ELECTICAL 400 LA CROSSE ST LA CROSSE, WI 54601 ATTN: MATTHEW GALLAGER PHONE: (608) 789-7392 EMAIL: GALLAGERM@CITYOFLACROSSE.ORG

400 LA CROSSE ST LA CROSSE, WI 54601 ATTN: RANDY HINZE PHONE: (608) 789-7305 EMAIL: HINZER@CITYOFLACROSSE.ORG

LA CROSSE STREET DEPARTMENT

LA CROSSE MUNICIPAL TRANSIT AUTHORITY ISLE LA PLUME LA CROSSE, WI 54601 ATTN: KEITH CARLSON PHONE: (608) 789-7569 EMAIL: CARLSONK@CITYOFLACROSSE.ORG

CITY OF LA CROSSE 400 LA CROSSE ST LA CROSSE, WI 54601 ATTN: RANDY TURTENWALD PHONE: (608) 789-7569 EMAIL: TURTENWALDR@CITYOFLACROSSE.ORG

LA CROSSE PUBLIC WORKS DIRECTOR 400 LA CROSSE ST LA CROSSE, WI 54601 ATTN: DALE HEXOM PHONE: (608) 789-7571 EMAIL: HEXOMD@CITYOFLACROSSE.ORG

#### SITE SUMMARY SITE DATA SITE AREA 4.83 **BUILDING AREA** 8,400

STANDARD ABBREVIATIONS

LT

NO

QTY

R/W

TYP

UG

VAR

LEFT

NUMBER

QUANTITY

RIGHT

POINT OF INTERSECTION

PROPERTY LINE

REFERENCE LINE

SANITARY SEWER

STORM SEWER

SQUARE YARD

UNDERGROUND

**TELEPHONE** 

**TYPICAL** 

**VARIABLE** 

RIGHT-OF-WAY

SQUARE FOOT

SHOULDER

AGGREGATE

BENCH MARK

CENTERLINE

CUBIC YARD

DRIVEWAY

ELEVATION

**EXCAVATION** 

FOOT

FOOTING

**HYDRANT** 

INVERT

POUND

LINEAR FOOT

LUMP SUM

BACK OF CURB

**CURB AND GUTTER** 

FIBER OPTIC CABLE

ASPHALT

AGG

**ASPH** 

PARKING DATA CONSOLIDATED CAR TYPE EMPLOYEE LOT RENTAL FACILITY EXISTING PARKING STALLS PROPOSED PARKING STALLS 216

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PROJECT

## LA CROSSE REGIONAL AIRPORT

### **CAR RENTAL FACILITY**

LA CR	OSSE	WISCO	NSIN
	REVISION SCHEDULE		
DATE	DESCRIPTION		BY


PROJECT NO.	16-19065
FILE NAME	19065 C0 LOCATION
DRAWN BY	ADB
DESIGNED BY	KBR
REVIEWED BY	WAK
ORIGINAL ISSUE DATE	03/31/2017
CLIENT PROJECT NO.	-


**CIVIL NOTES & SPECIFICATIONS** 

SHEET

**CO-10** 



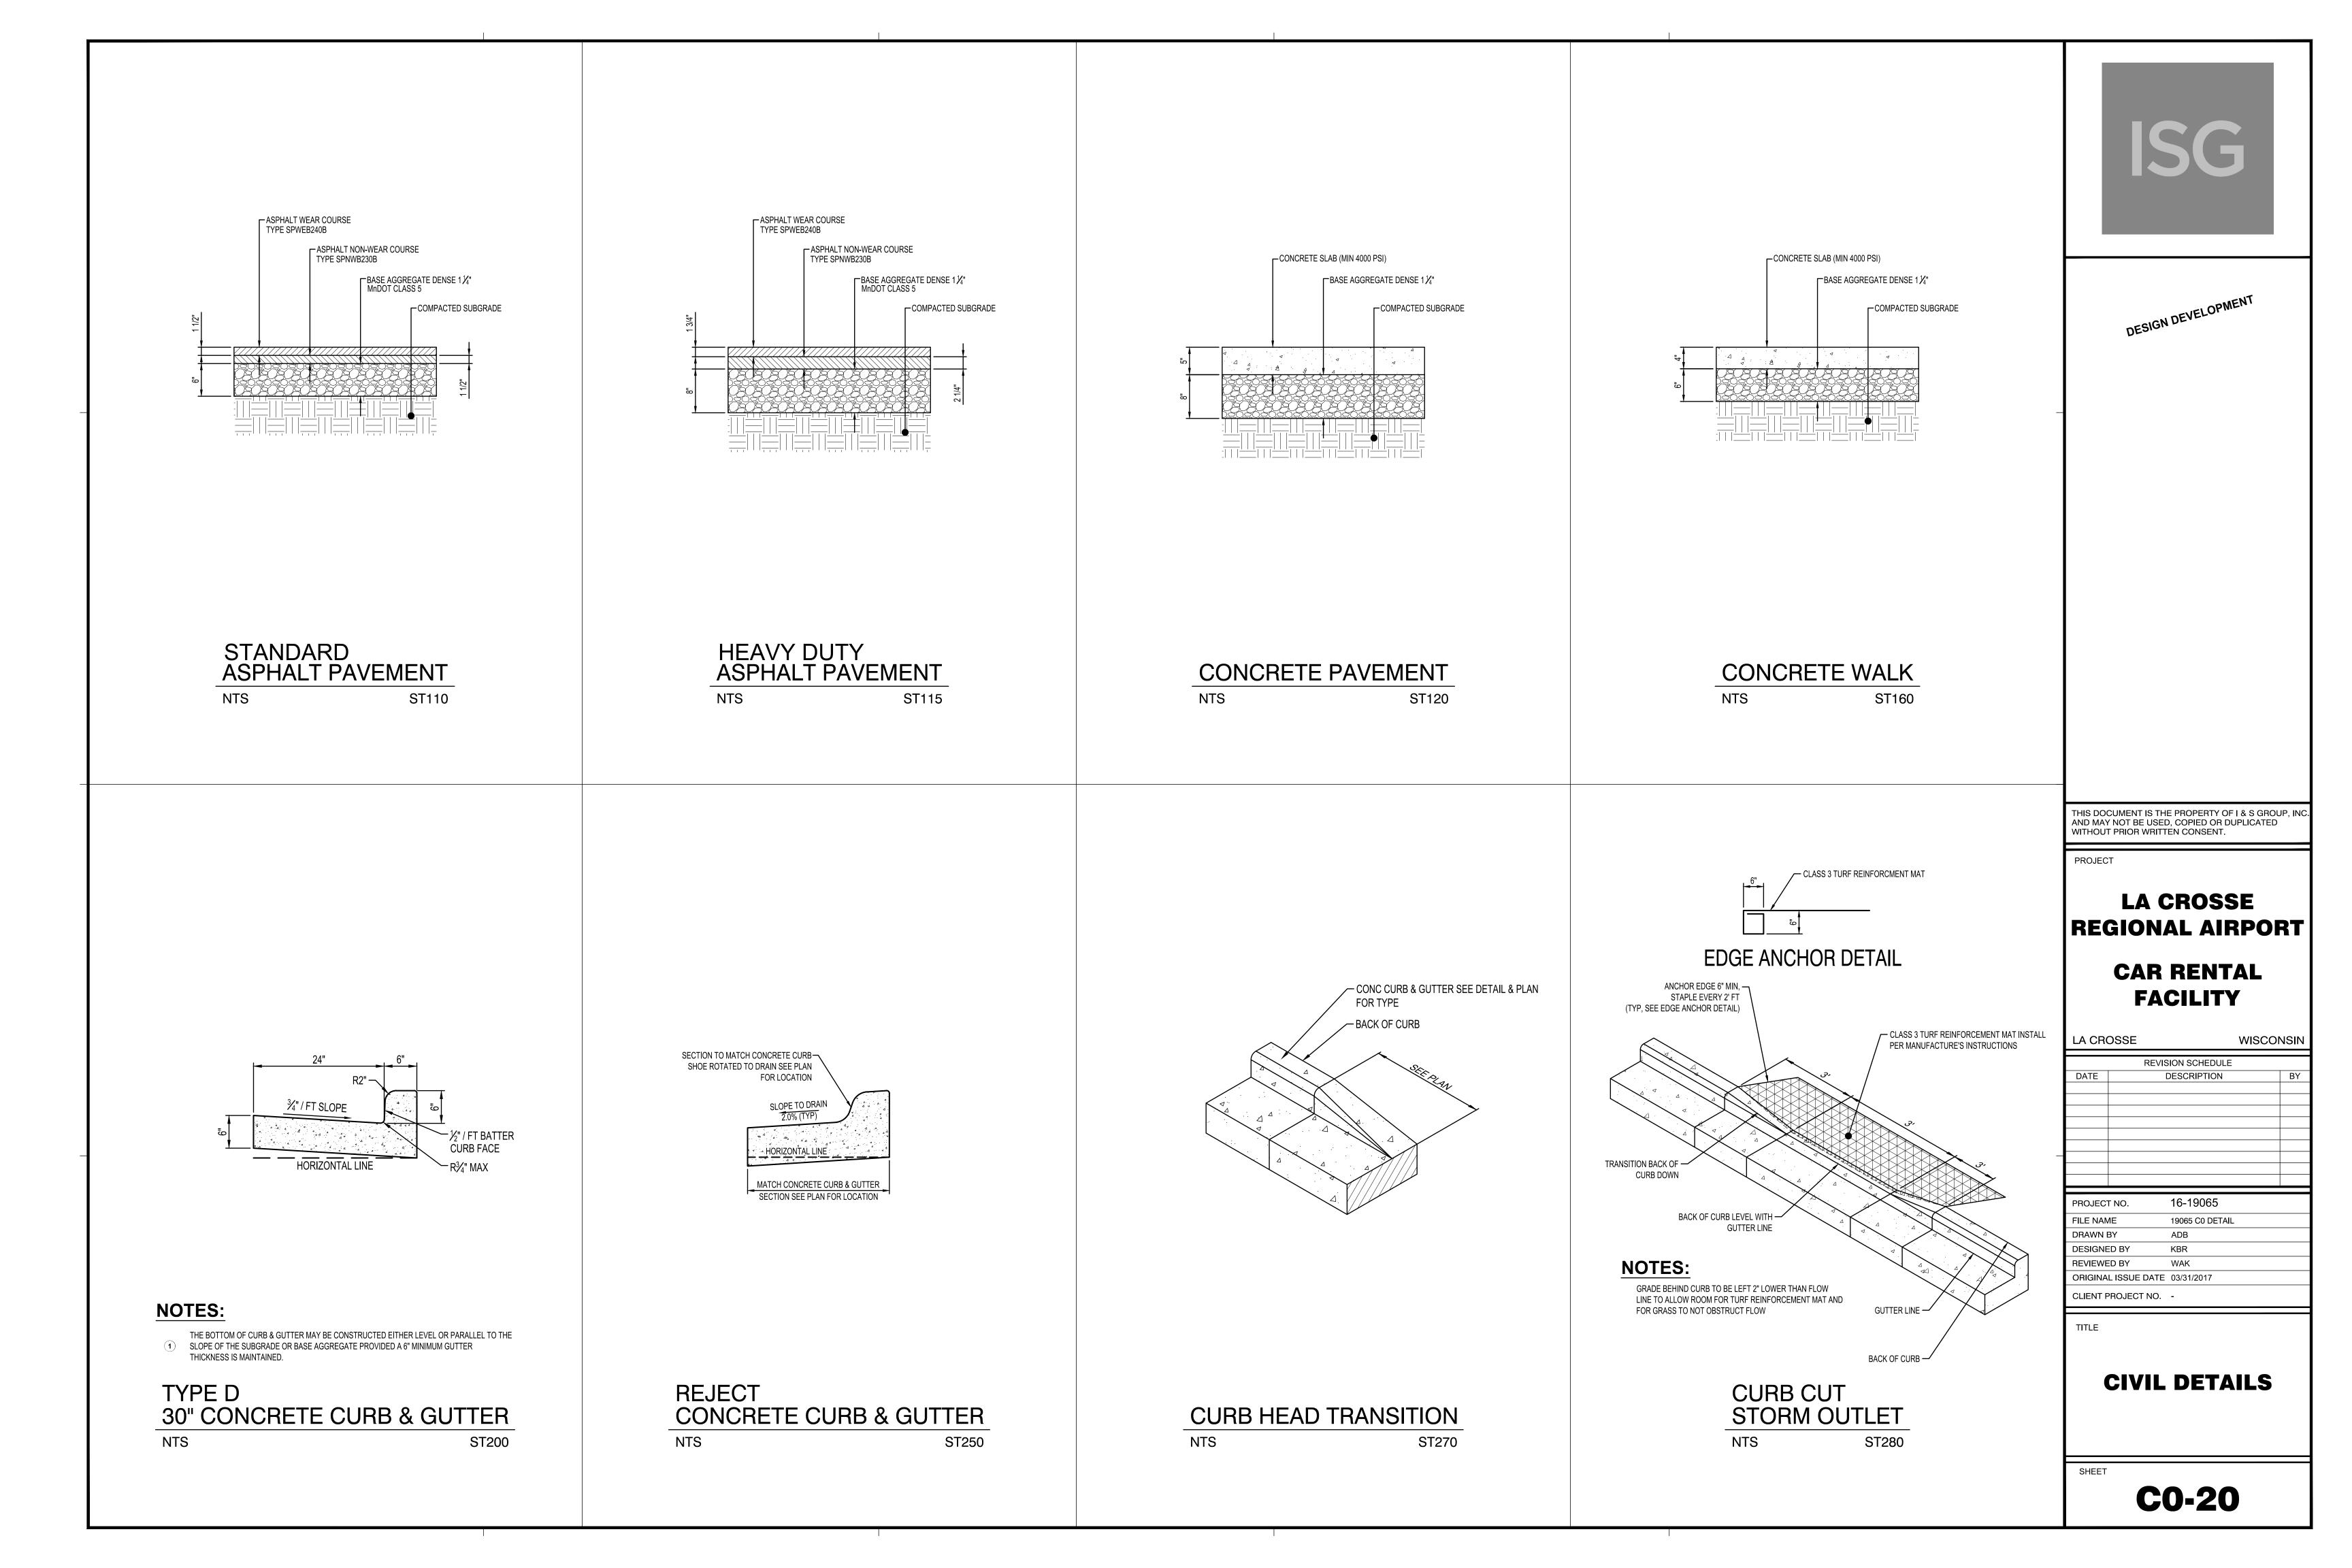

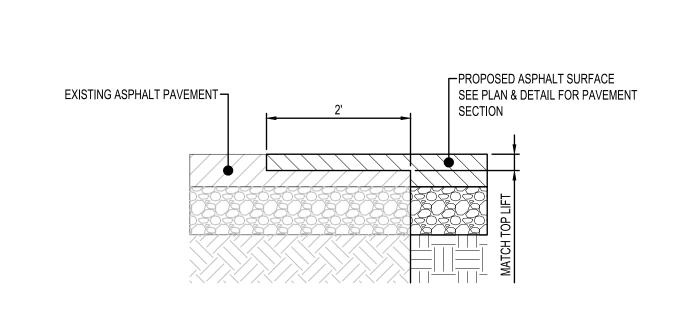


#### **NOTES:**

USE WHENEVER NEW ASPHALT ABUTS EXISTING ASPHALT

## **EDGE MILLING**

NTS


ST350

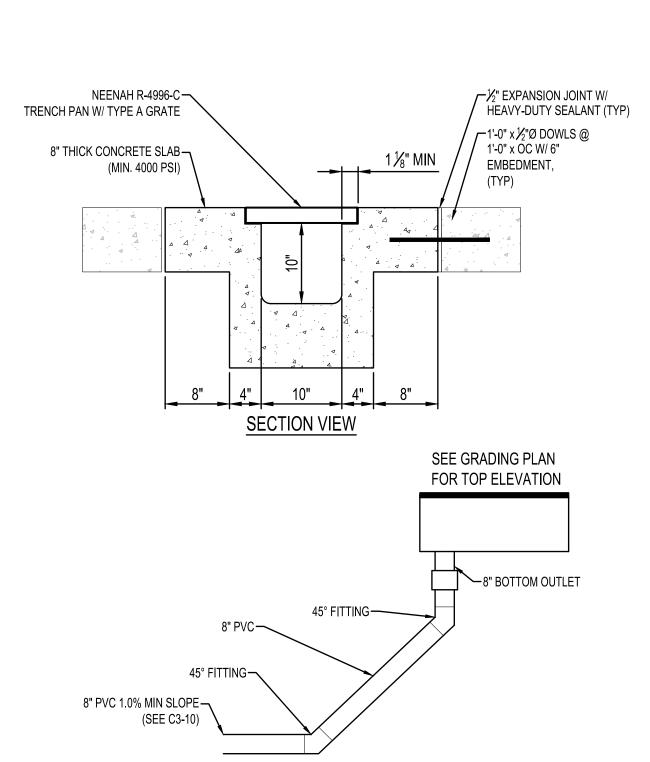

CONCRETE TRENCH DRAIN

SD550

NTS

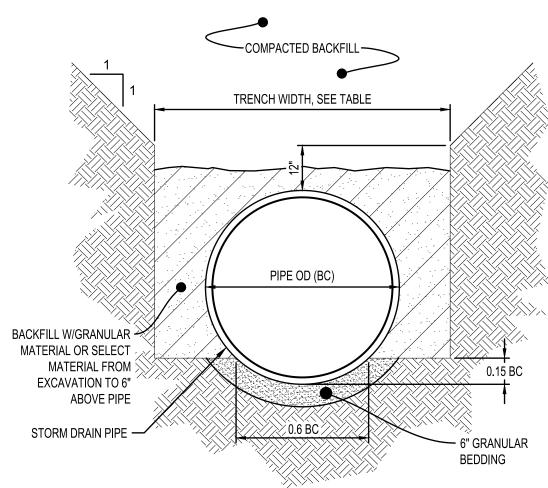

TRENCH WIDTH			
PIPE Ø	TRENCH WIDTH		
36" OR LESS	BC + 24"		
42" TO 54"	1.5 x BC		
60" OR OVER BC + 36"			


### NOTES:

NTS

GRANULAR BEDDING AND BACKFILL FOR STORM DRAIN PIPES SHALL BE INCIDENTAL TO STORM DRAIN CONSTRUCTION

### NON-CONCRETE STORM DRAIN PIPE BEDDING

SD600

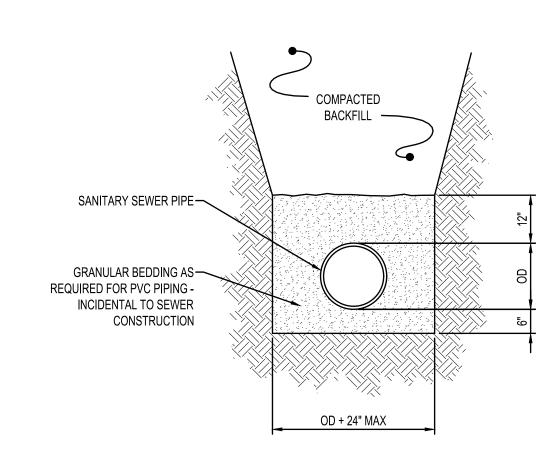

### NOTES:

GRANULAR BEDDING AND ENCASEMENT FOR SANITARY SEWER PIPES SHALL BE INCIDENTAL TO CONSTRUCTION

### PIPE BEDDING SANITARY SEWER

NTS SA400



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PROJE

## LA CROSSE REGIONAL AIRPORT

## CAR RENTAL FACILITY

LA CR	OSSE	WISCO	NSIN
	REVISION SCHEDULE		
DATE	DESCRIPTION		BY


PROJECT NO.	16-19065
FILE NAME	19065 C0 DETAIL
DRAWN BY	ADB
DESIGNED BY	KBR
REVIEWED BY	WAK
ORIGINAL ISSUE DATE	03/31/2017
CLIENT PROJECT NO.	-

TITLE

**CIVIL DETAILS** 


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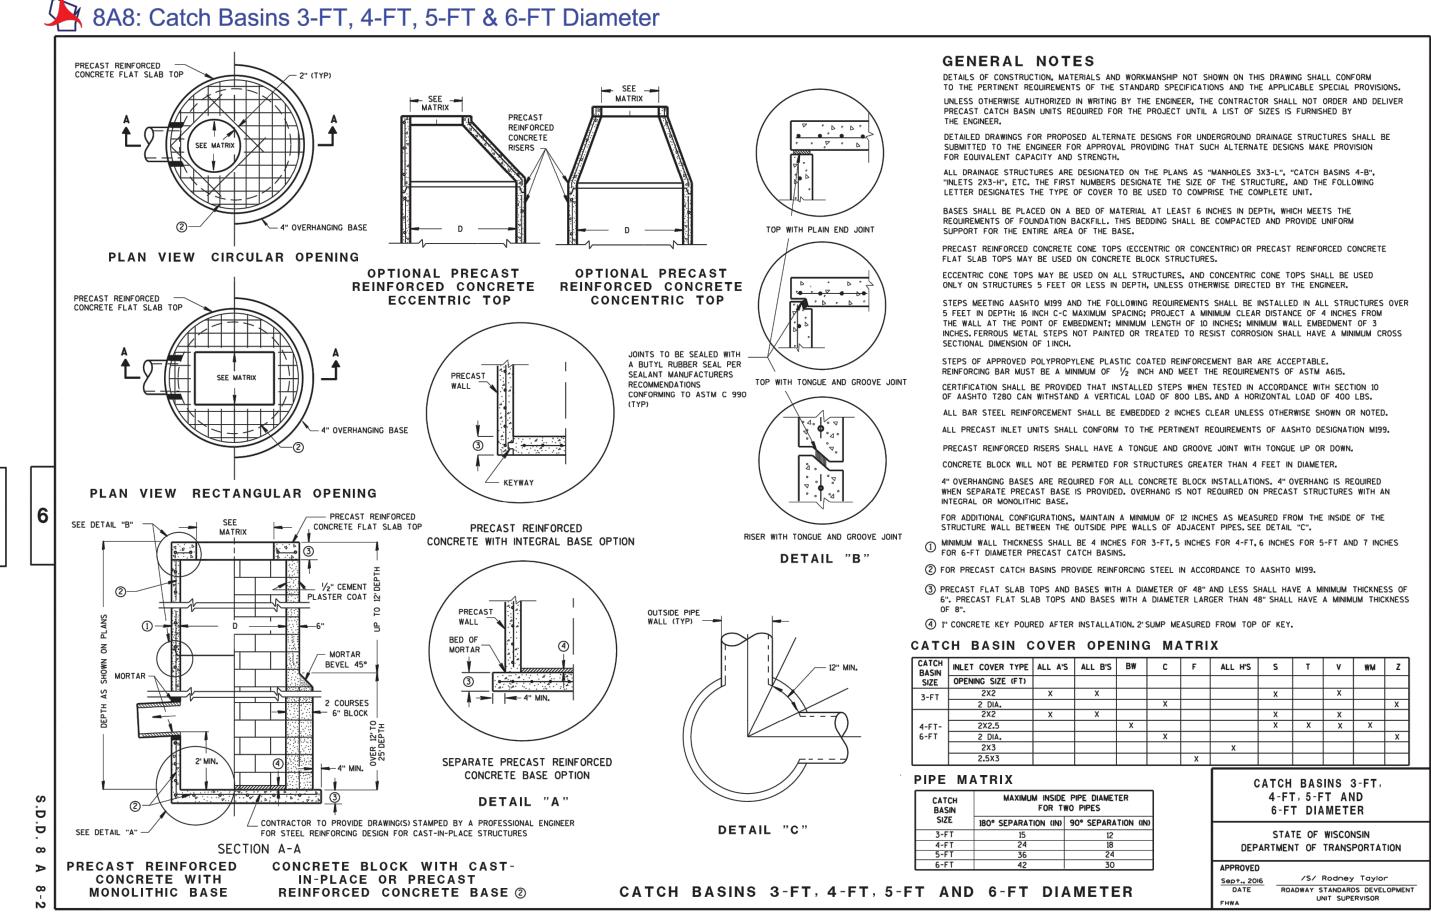
**C0-21** 

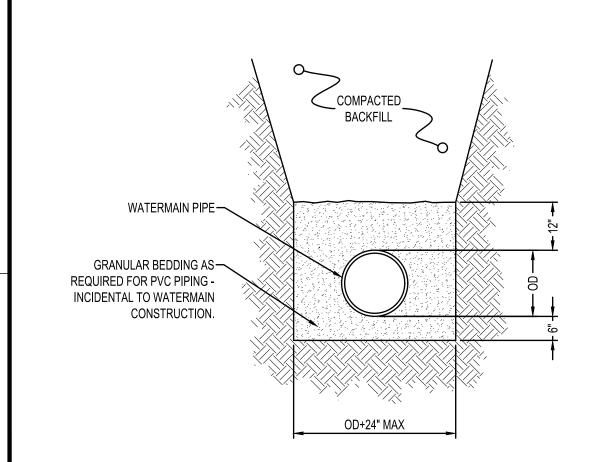

PIPE BEDDING FOR WATERMAIN

NTS WM300



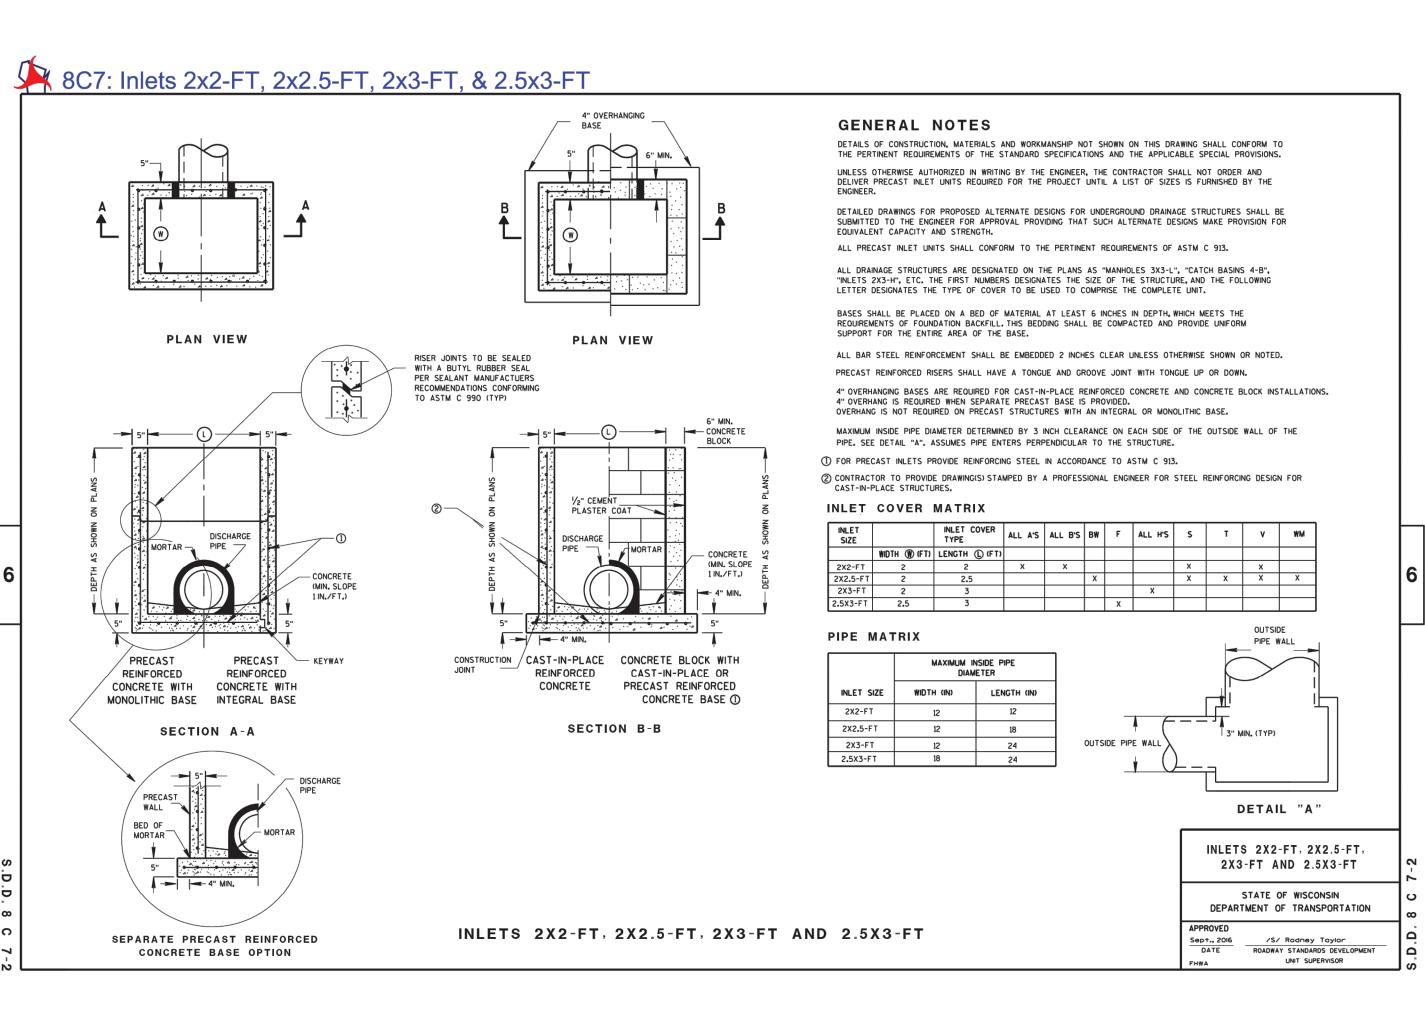

ISG

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PROJECT

## LA CROSSE REGIONAL AIRPORT

## CAR RENTAL FACILITY

REVISION SCHEDULE

DATE DESCRIPTION BY


PROJECT NO.	16-19065
FILE NAME	19065 C0 DETAIL
DRAWN BY	ADB
DESIGNED BY	KBR
REVIEWED BY	WAK
ORIGINAL ISSUE DATE	03/31/2017
CLIENT PROJECT NO.	-


TITLE

CIVIL DETALS

SHEET


**C0-22** 

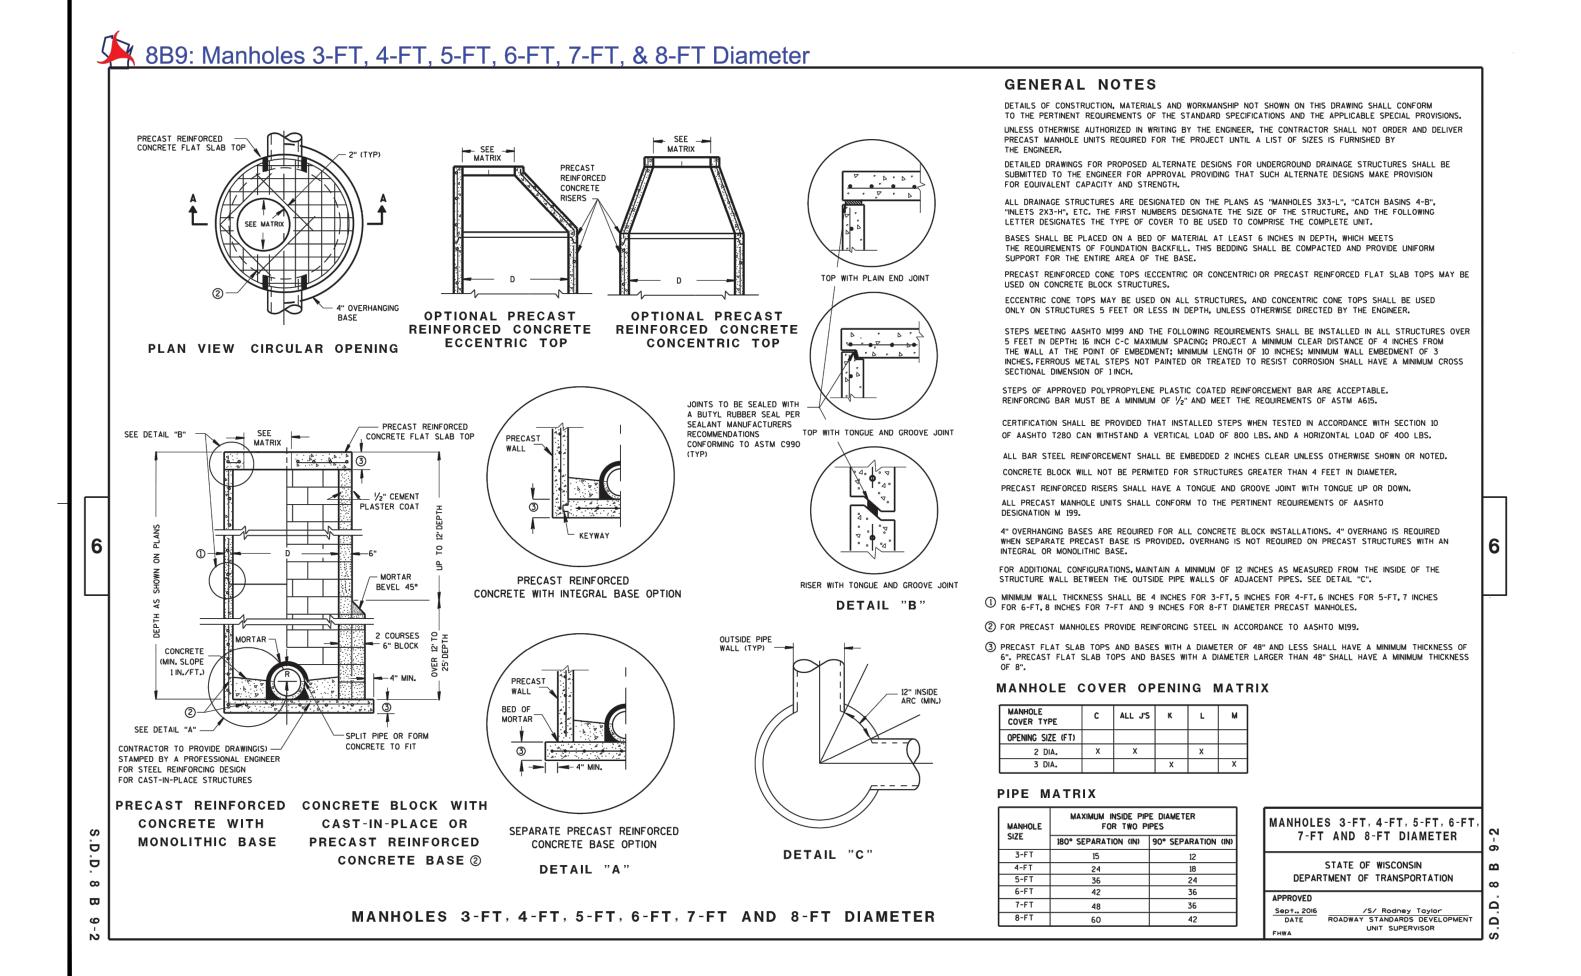

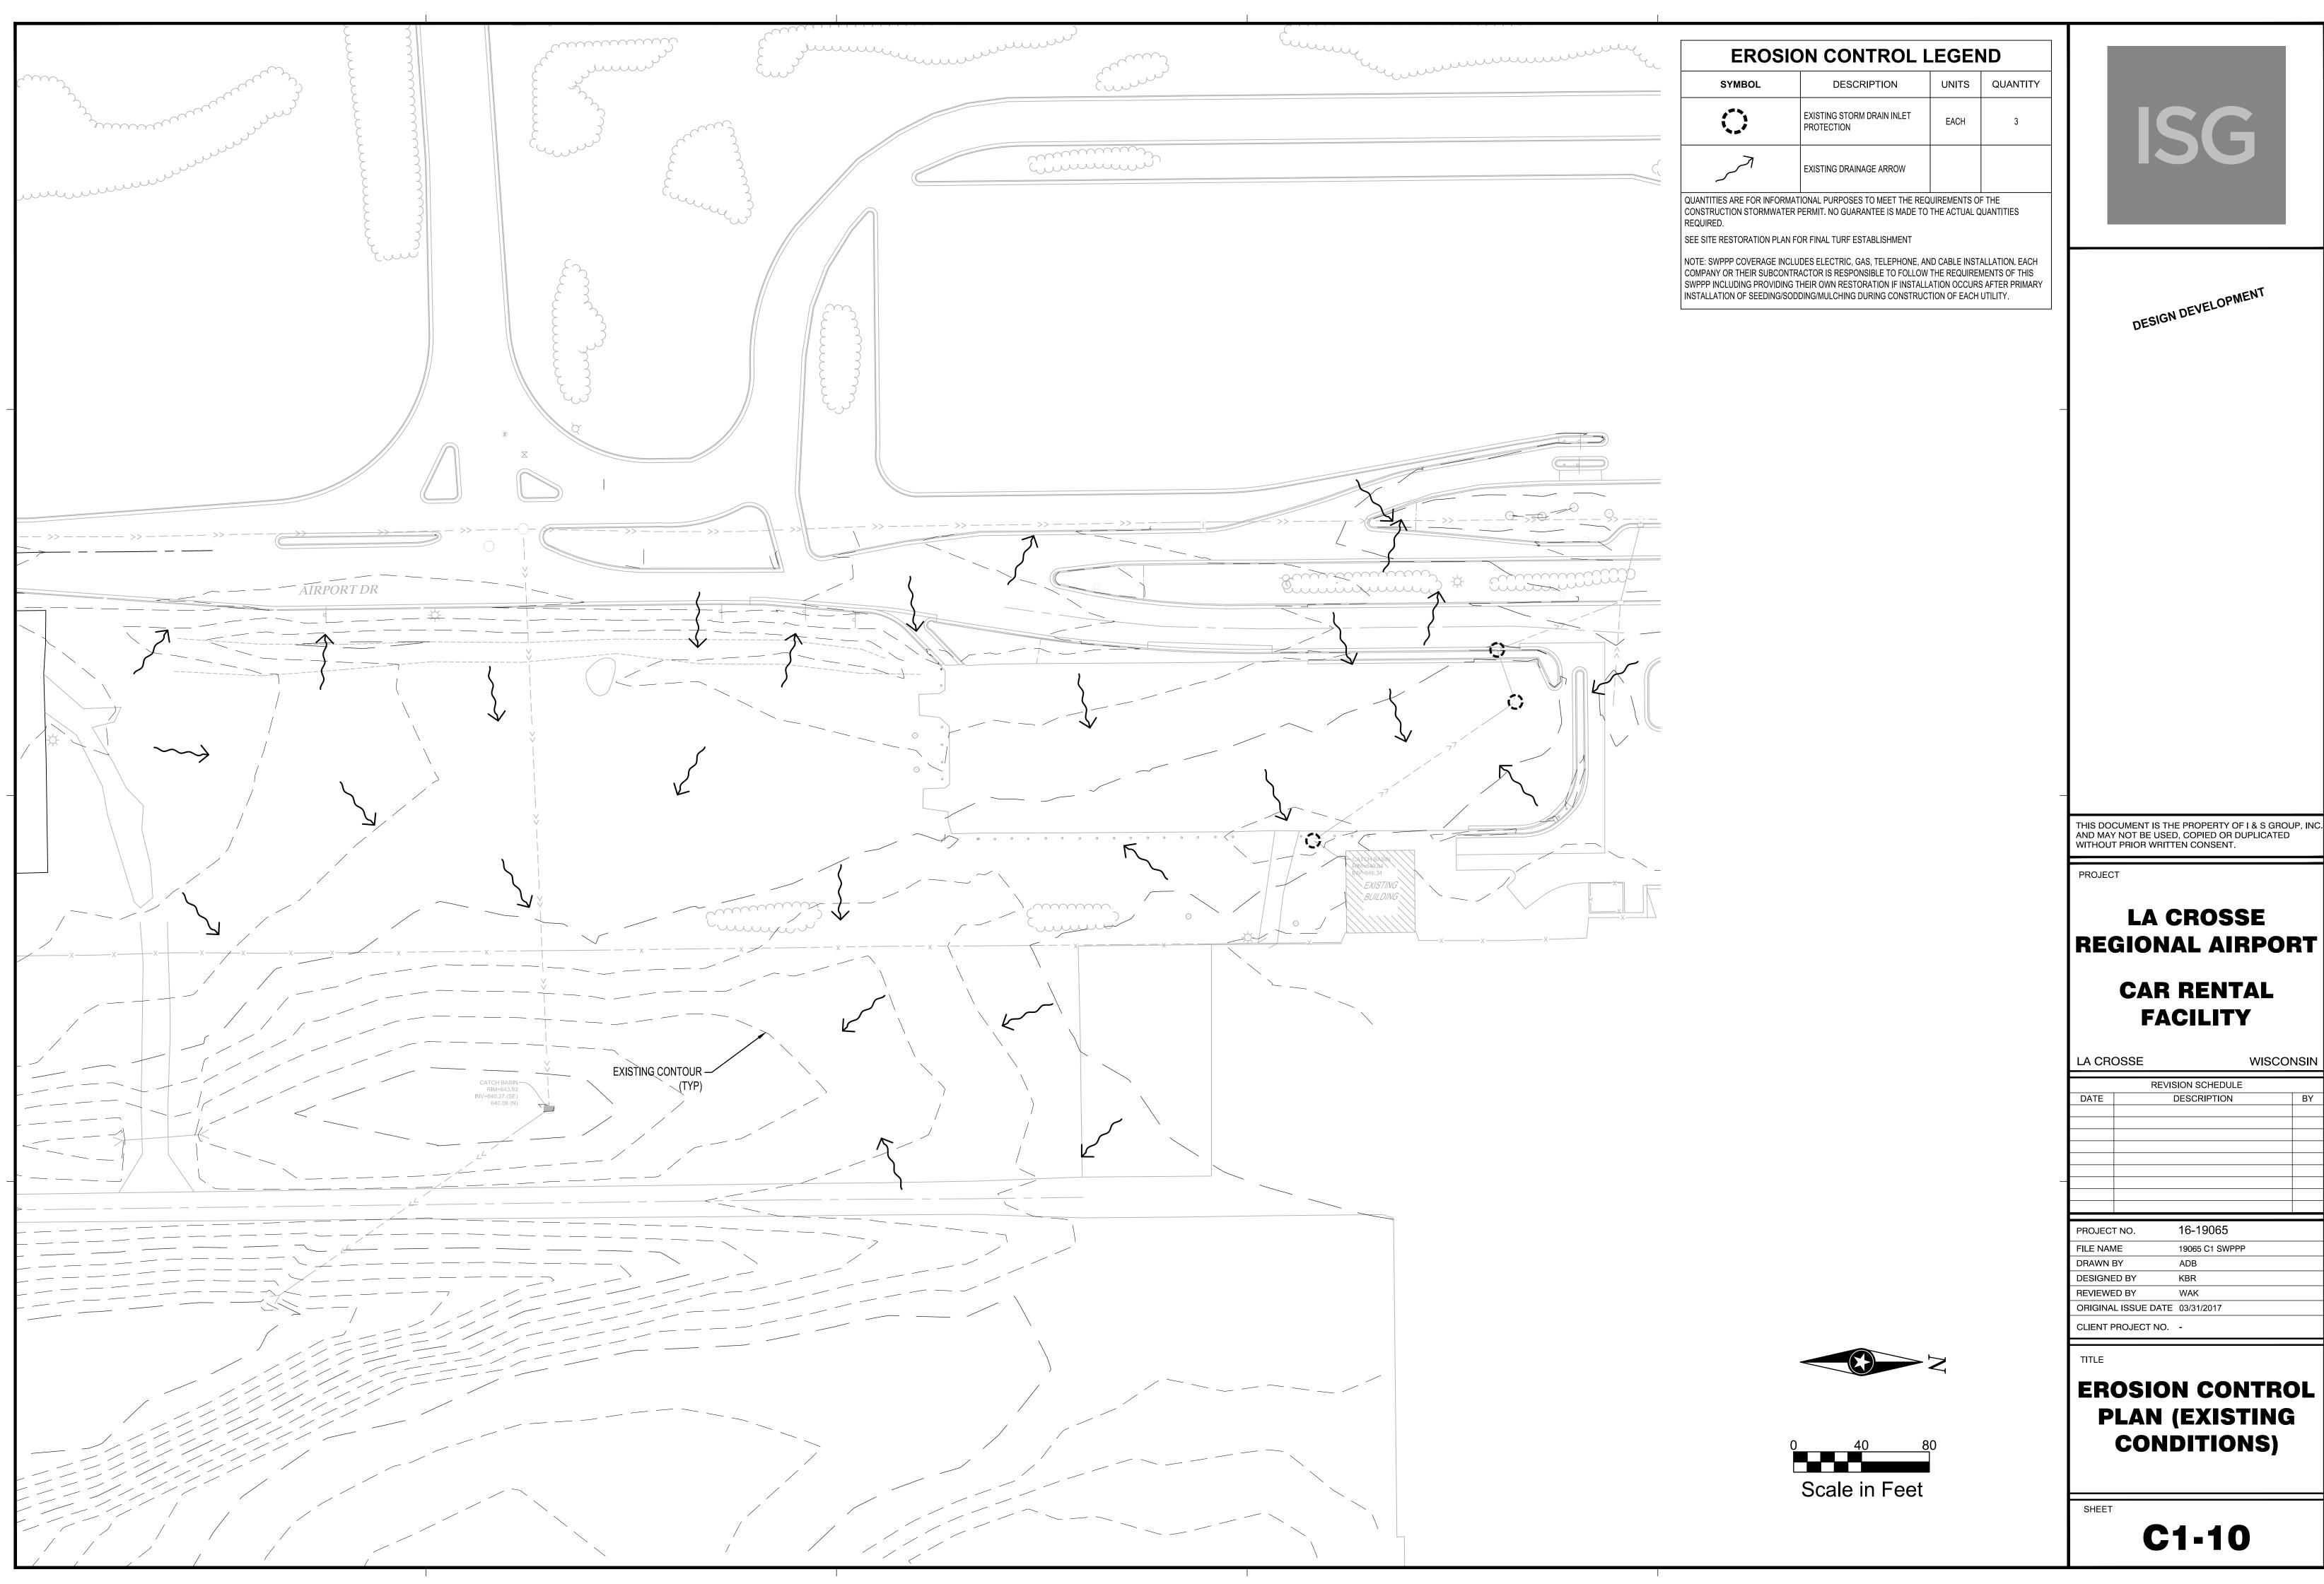

WISCONSIN

PROJECT NO.	16-19065
FILE NAME	19065 C1 SWPPP
DRAWN BY	ADB
DESIGNED BY	KBR
REVIEWED BY	WAK
ORIGINAL ISSUE DATE	03/31/2017
CLIENT PROJECT NO.	-

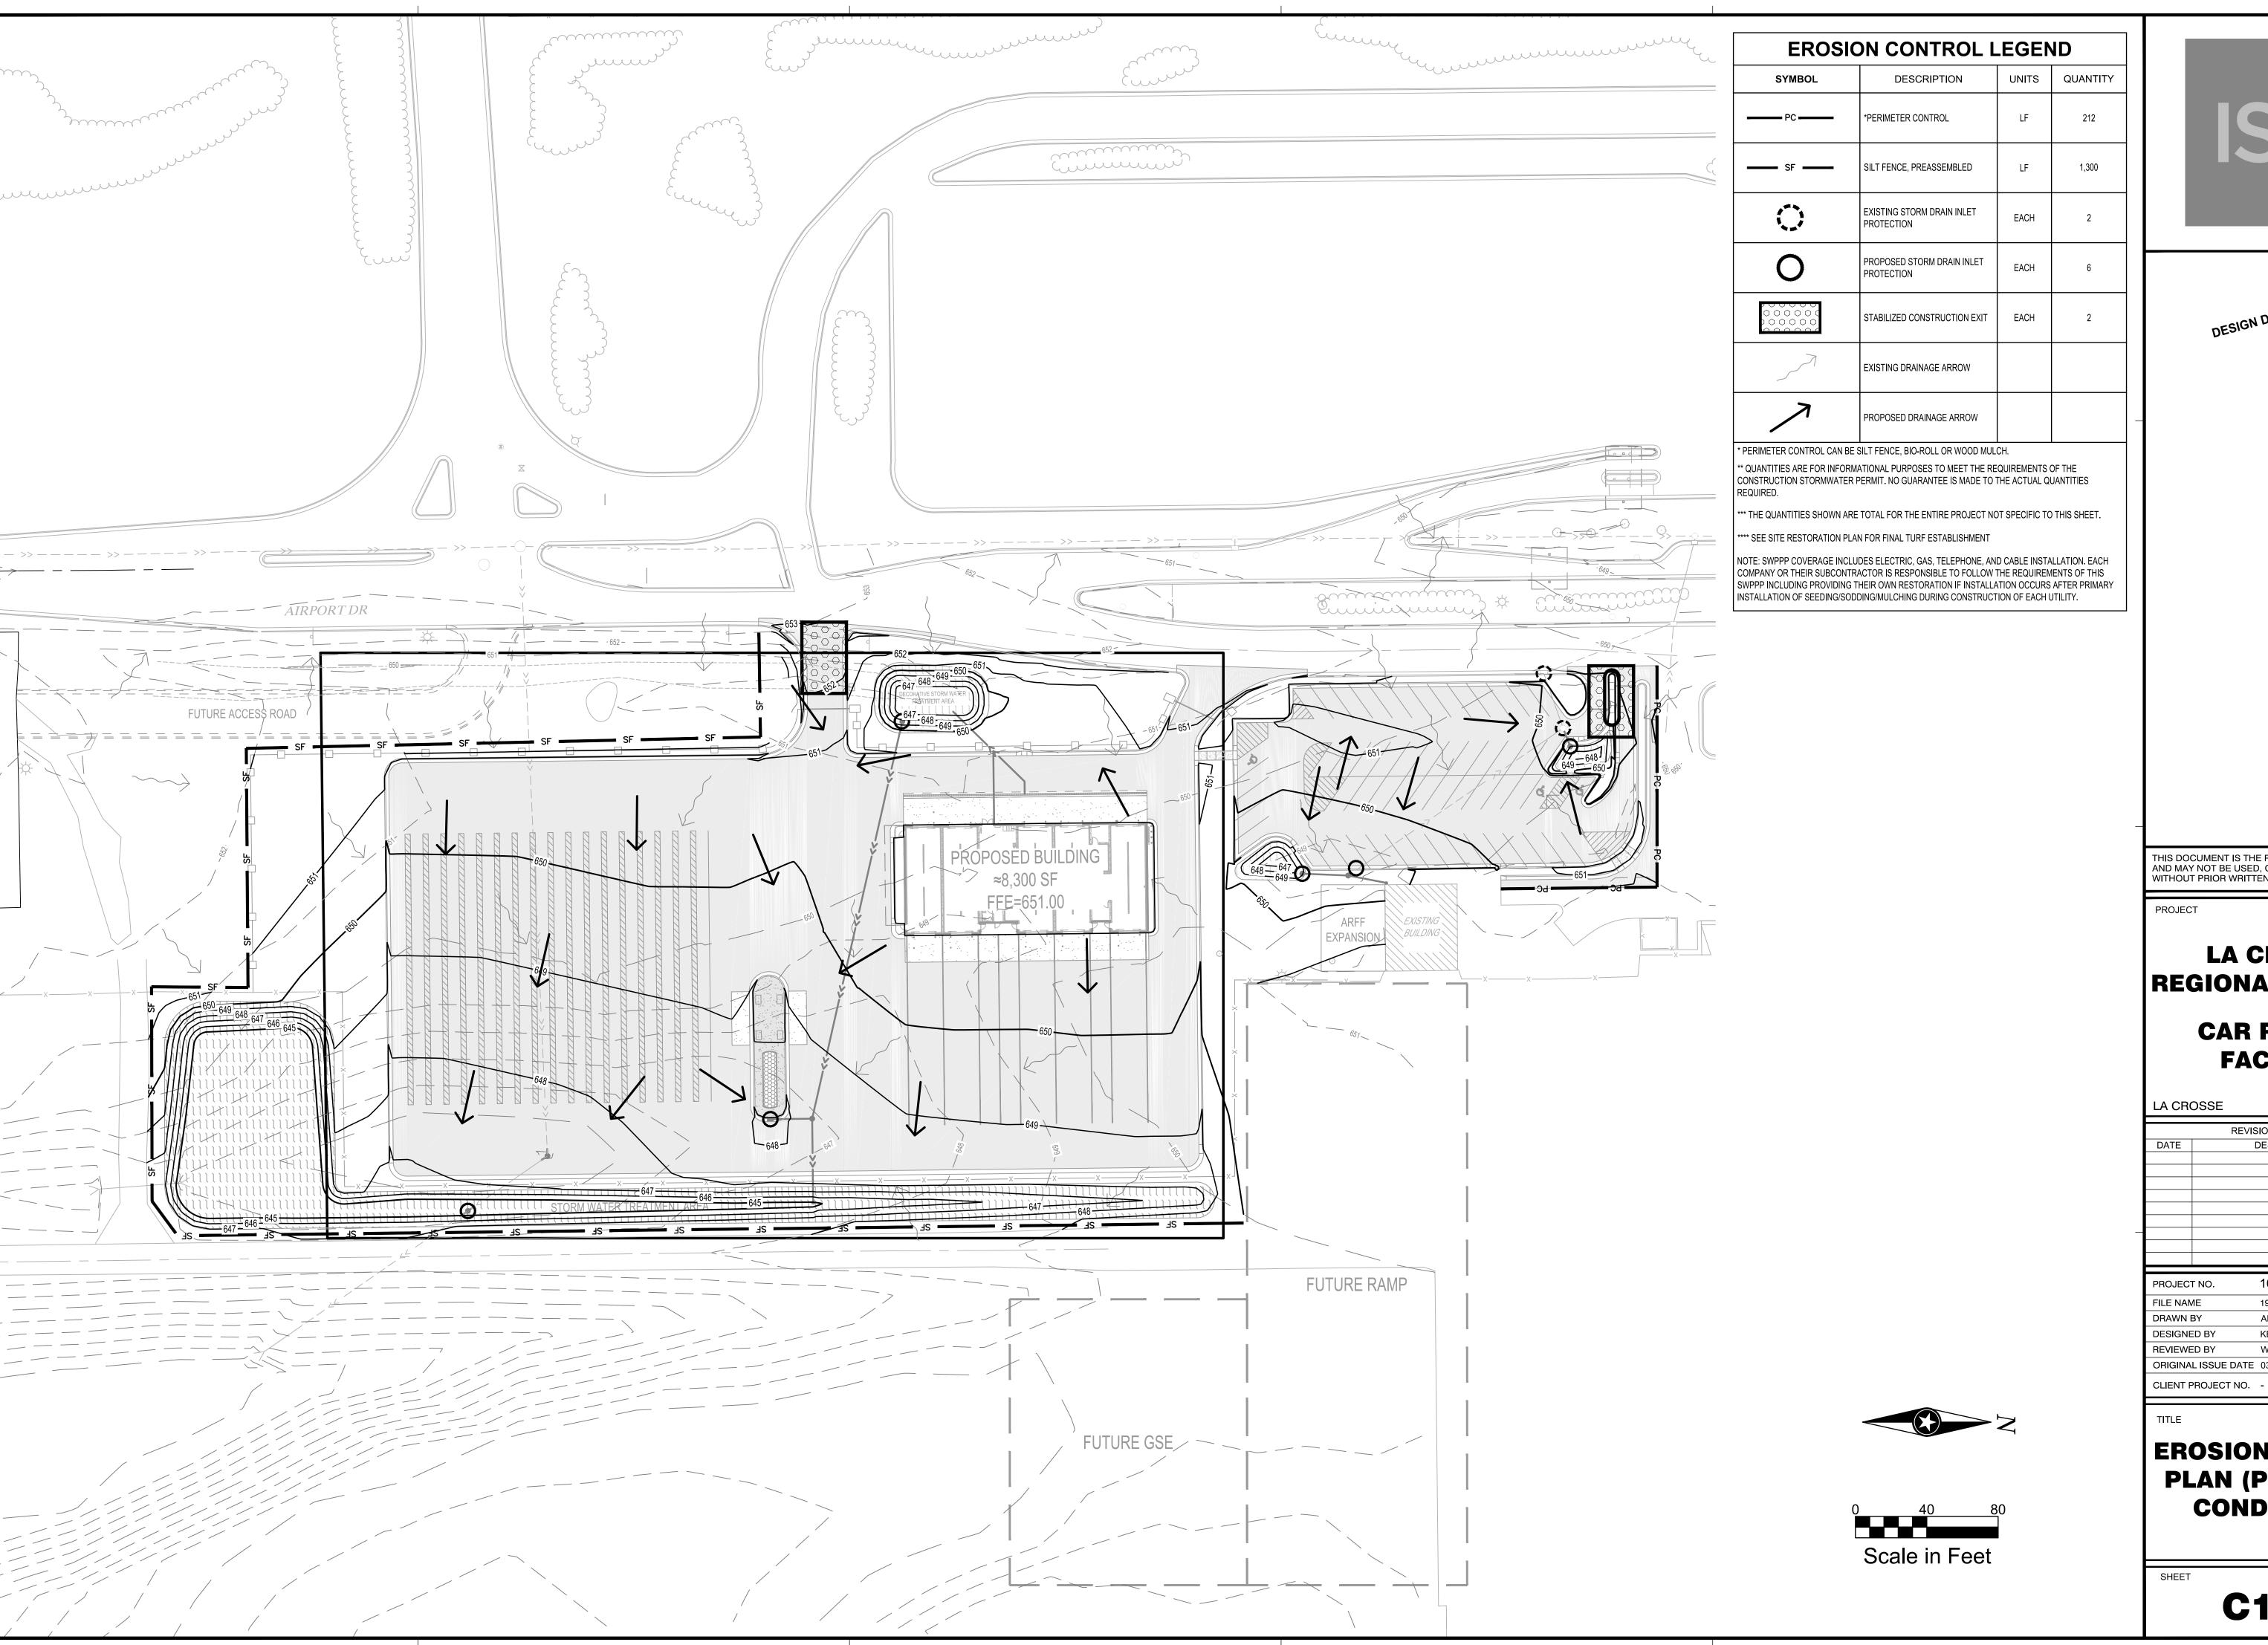

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## LA CROSSE REGIONAL AIRPORT

# CAR RENTAL FACILITY

LA CR	OSSE	WISCONSIN
	REVISION SCHEDU	JLE
DATE	DESCRIPTION	N BY
		·

PROJECT NO.	16-19065
FILE NAME	19065 C1 SWPPP
DRAWN BY	ADB
DESIGNED BY	KBR
REVIEWED BY	WAK
ORIGINAL ISSUE DATE	03/31/2017
CLIENT PROJECT NO.	-

EROSION CONTROL PLAN (PROPOSED CONDITIONS)

**C1-20** 

#### STORM WATER POLLUTION PREVENTION PLAN NOTES:

GENERAL PROJECT INFORMATION:

#### PROJECT NARRATIVE:

This project consists of the construction of an 8,400 sf building, bituminous pavement, concrete pavement, concrete sidewalk, curb & gutter, storm service, sanitary service, and water service, along with all the necessary grading, paving, utilities, erosion control, site restoration, and any incidental items.

#### **RESPONSIBLE PARTIES:**

Contractor and Owner are required to apply for and receive a Wisconsin Pollution Discharge Elimination System (WPDES) Stormwater Construction Permit from the WDNR at least 14 working days prior to beginning work.

Contractor and owner shall identify a person knowledgeable and experienced in the application of erosion prevention and sediment control BMP's who will oversee the implementation of the Erosion Control Plan according to WDNR requirements.

Company:	Contact Person:	Phone:
Address:		
Company:	 Contact Person:	

#### Address:

Owner shall identify the entity responsible for the long term Operation and Maintenance of the storm water management system.

Company:	Contact Person:	Phone:

#### PROJECT AREAS:

- Total project size (disturbed area) = 4.83 acres Minimum area requiring WDNR permit = 1.00 acres
- \*\*PROJECT DOES REQUIRE A WPDES PERMIT\*\*
- I HOULD'I DOLO HEQUINE A WI DEG I EHIMIT

Existing area of impervious surface = 1.21 acres

Post construction area of impervious surface = 3.14 acres

Total new impervious surface area created = 1.93 acres

Minimum area of new impervious surface created requiring permanent storm water management = 1.00 acres

#### RECEIVING WATERS:

Surface waters which will receive storm water from the site within 1 mile (aerial radius measurement) of project boundary. Include waters shown on USGS 7.5 minute quad and all waters identified in Appendix A of the permit.

Name of Water Body	Type (ditch, pond, wetland, lake, etc.)	Appendix A Special or Impaired Water?
Mississippi	River	Impaired
Black	River	Impaired

Additional BMPs together with enhanced runoff controls are required for discharges to Special or Impaired waters within 1 mile of the site. (See Appendix A)

SOIL TYPES:

#### **CONSTRUCTION ACTIVITY NOTES:**

#### EROSION PREVENTION:

Construction of silt fence and all other erosion control measures shall be complete before other construction activity occurs. Use phased construction wherever practical and establish turf as soon as possible to minimize sediment transport.

Turf establishment or temporary seeding or mulching of all exposed soil not being actively worked should be practiced following the table below:

Type of Slope		Remain Open Without tively Worked
or Disturbance Area	Normal Water	WATER-TYPE
Steeper than 3:1	14 days	7 days
10:1 to 3:1	14 days	7 days
Flatter 10:1	14 days	7 days
Ditches	1 day	1 day
Pipe Ends	1 day	1 day
Within 200 Feet of Surface Water	1 day	1 day

Temporary cover during construction is incidental.

Pipe outlets must be provided with temporary or permanent energy dissipation within 24 hours after connection to a surface water.

All exposed soils shall be seeded or sodded at the earliest possible time to prevent/reduce erosion.

A. Seeding shall be per site restoration plan

B. Sodding shall be applied according to WisDOT Specification Section 631.

#### **CONSTRUCTION ACTIVITY NOTES(CONT):**

#### EROSION PREVENTION(CONT):

C. Temporary mulching shall be applied at a rate of 2 tons/acre. Mulch shall be disc

Additional erosion prevention measures may be found at the Wisconsin Department of Natural Resources Best Management Practices.

#### SEDIMENT CONTROL PRACTICES:

Construction of silt fence and all other erosion control measures shall be complete prior to land disturbing activities occur.

Inlet erosion protection shall be installed and maintained until turf or pavement has been established.

The contractor shall be responsible to control erosion from leaving the construction zone. All eroded material that leaves the construction zone shall be collected by the contractor and returned to the site at the contractor's expense.

Contractor shall maintain a 50-foot natural buffer or use redundant sediment controls near surface waters if a buffer is not feasible.

Contractor shall take the necessary steps to minimize soil compaction and preserve topsoil on site.

All streets must be swept within 24 hours when any tracking occurs.

Silt fence or other effective erosion control measures must be installed around the perimeter of any soil stockpiled, including temporary stockpiles, at this location or any other on the project site. Stockpiles cannot be placed in surface waters, including storm water conveyances such as curb and gutter systems, or conduits and ditches.

Perimeter control shall be installed along the back of curb immediately following curb installation at all locations with positive drainage to parking lot and/or streets, and remaining until stabilization is achieved. This shall be accomplished through the use of silt fence.

(Biorolls, Rock logs, or other methods approved by the engineer prior to installation shall also be placed acceptable)

#### **DEWATERING AND BASIN DRAINING:**

Dewater sediment—laden water to sedimentation basins if possible, or use other BMP's to prevent erosion when discharging to surface waters. Use appropriate energy dissipation measures on all discharges.

Dewatering practices cannot cause nuisance conditions, erosion or in receiving channels or inundation of wetlands resulting in adverse impacts.

#### POLLUTION PREVENTION:

All solid waste collected from the construction site must be disposed in accordance with all

All hazardous materials (oil, gasoline, fuel, paint, etc) must be properly stored to prevent spills, leaks, or other discharge. Storage areas shall provide secondary containment and a hazardous materials spill kit. Equipment fueling and maintenance shall occur in a designated, contained area. Storage and disposal of hazardous waste must be in compliance with all applicable regulations. All runoff containing any hazardous material must be properly collected and disposed. No engine degreasing shall be allowed on site.

All sanitary wastes must be collected from portable units on site by a licensed sanitary waste management contractor. The units must be secured and shall be maintained on a regular basis as needed to prevent overfilling.

Emergency Spill Plan — The Contractor is responsible for all construction personnel to be informed of the manufacturers' recommended spill cleanup methods, and the location of that information and cleanup supplies. The Contractor shall modify the SWPPP as required within seven calendar days of knowledge of the release to: provide a description of the release, the circumstances leading to the release, and the date of the release. Plans must identify measures to prevent the reoccurrence of such releases. If a spill occurs, the following steps shall be followed:

- 1. Observe the safety precautions associated with the spilled material. Stop the source of the spill, if you can do so safely. Call 911 if fire or public safety hazards are created.
- 2. Contain the spilled material. Dirt, sand, or any semi-impermeable material may be used to create a containment structure to prevent the material from flowing.
- 3. Report the spill to Wisconsin's Spill Hotline at (800) 943-0003.
- 4. Clean up the spilled material and dispose of the wastes properly.

The contractor is responsible for monitoring air pollution and ensuring it does not exceed levels set by local, state, or federal regulations. This includes dust created by work being performed on the site. Air pollution and dust control correction is considered incidental to the unit bid prices for which work is being performed. Additional dust control measures may be required by the Engineer.

Concrete washout off site: All liquid and solid wastes generated by concrete washout must be contained and not have the opportunity to come in contact with the surface waters or ground water. This includes ditches, slopes to ditches, curb and gutter, storm sewer systems, and ponds. All excess water and concrete must leave the site within the concrete trucks. Liquid and solid wastes must be disposed of properly.

#### INSPECTION AND MAINTENANCE:

The Permittees must routinely inspect the construction site once every seven (7) days during active construction and within 24 hours of a rainfall event greater than 0.5 inches in a 24 hour period.

All inspections performed during construction must be recorded and records retained with the erosion plan in accordance with the Permit. Contractor is responsible for keeping a record of all rainfall data & erosion control maintenance until final establishment of turf.

#### **CONSTRUCTION ACTIVITY NOTES(CONT):**

INSPECTION AND MAINTENANCE(CONT):


Erosion control and other BMP's must be replaced, repaired, or supplemented when they reach 33% design load.

#### FINAL STABILIZATION:


The Contractor must ensure final stabilization of the site. The Contractor must submit a Notice of Termination when the site has undergone final stabilization and all stormwater discharges associated with the construction site activities that require to have WPDES coverage have ceased.


All temporary erosion control measures and BMP's must be removed as part of the final site

The storm water permit further defines final stabilization and its requirements.

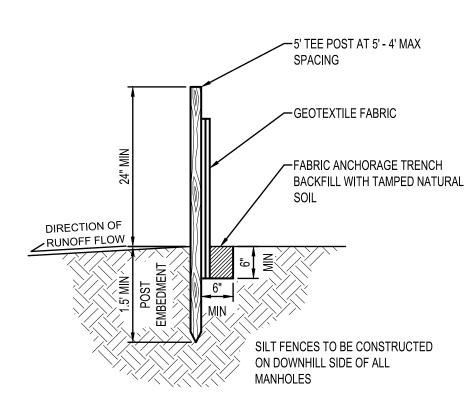

## SILT FENCE NTS EC100

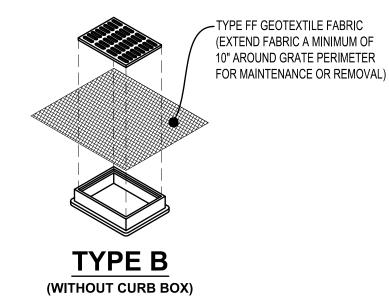

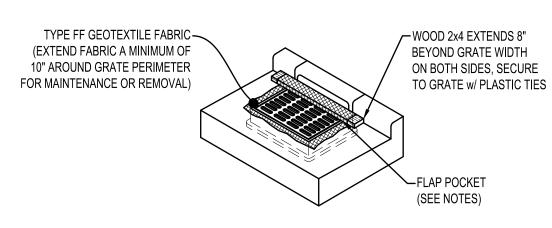


## TYPE C (WITH CURB BOX)

#### **NOTES:**


FLAP POCKETS SHALL BE LARGE ENOUGH TO ACCEPT WOOD 2" x 4". THE REBAR, STEEL PIPE, OR WOOD SHALL BE INSTALLED IN TEH REBAR FLAP AND SHALL NOT BLOCK THE TOP HALF OF THE CURB FACE


WHEN REMOVING OR MAINTAINING INLET PROTECTION, CARE SHALL BE TAKEN SO THAT THE SEDIMENT TRAPPED IN THE FABRIC DOES NOT FALL INTO THE STRUCTURE. MATERIAL THAT HAS FALLEN INTO THE INLET SHALL BE IMMEDIATELY REMOVED.



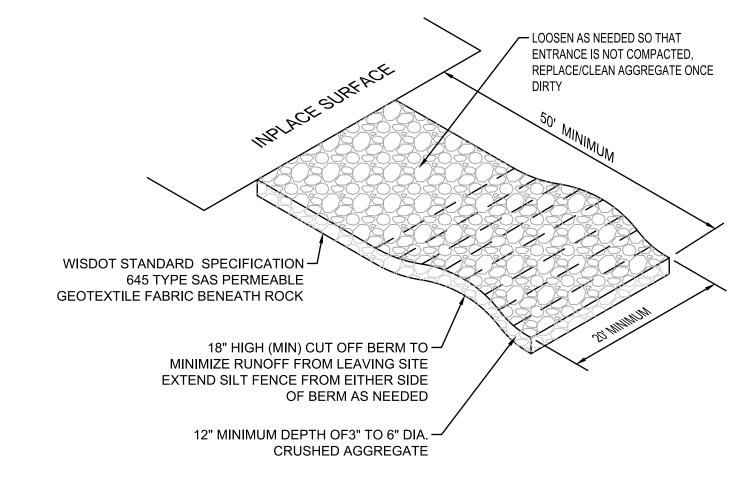

## STONE TRACKING PAD NTS EC600

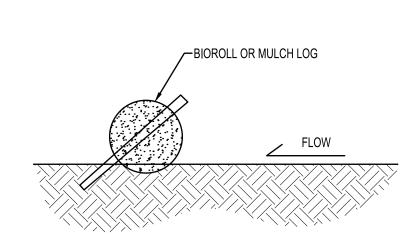

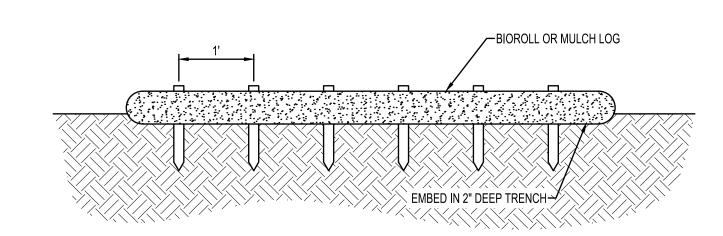

#### **NOTES:**

BIOROLL/MULCH LOGS TO BE 6" DIAMETER UNLESS OTHEWISE NOTED.
STAKED INTO THE GROUND WITH WOOD STAKES.

WOOD STAKES ARE A MINIMUM OF 2"x16"x½" UNLESS PRECLUDED BY PAVED SURFACE OR ROCK.

WOOD STAKES DRIVEN THROUGH BACK HALF OF BIOROLL OR WOOD MULCH LOG AT AN APPROXIMATE ANGLE OF 45° WITH THE TOP OF STAKE POINTING UP STREAM.

WHEN MORE THAN ONE BIORLLL IS NEEDED, OVERLAP ENDS A MINIMUM OF 6" AND STAKE

BIOROLL STAKING
NTS EC300



DESIGN DEVELOPMENT

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PROJECT

## LA CROSSE REGIONAL AIRPORT

## CAR RENTAL FACILITY

LA CR	OSSE	WISCO	NSIN
	REVISION SCHEDULE		
DATE	DESCRIPTION		BY


PROJECT NO.	16-19065
FILE NAME	19065 C1 SWPPP
DRAWN BY	ADB
DESIGNED BY	KBR
REVIEWED BY	WAK
ORIGINAL ISSUE DATE	03/31/2017
CLIENT PROJECT NO.	-


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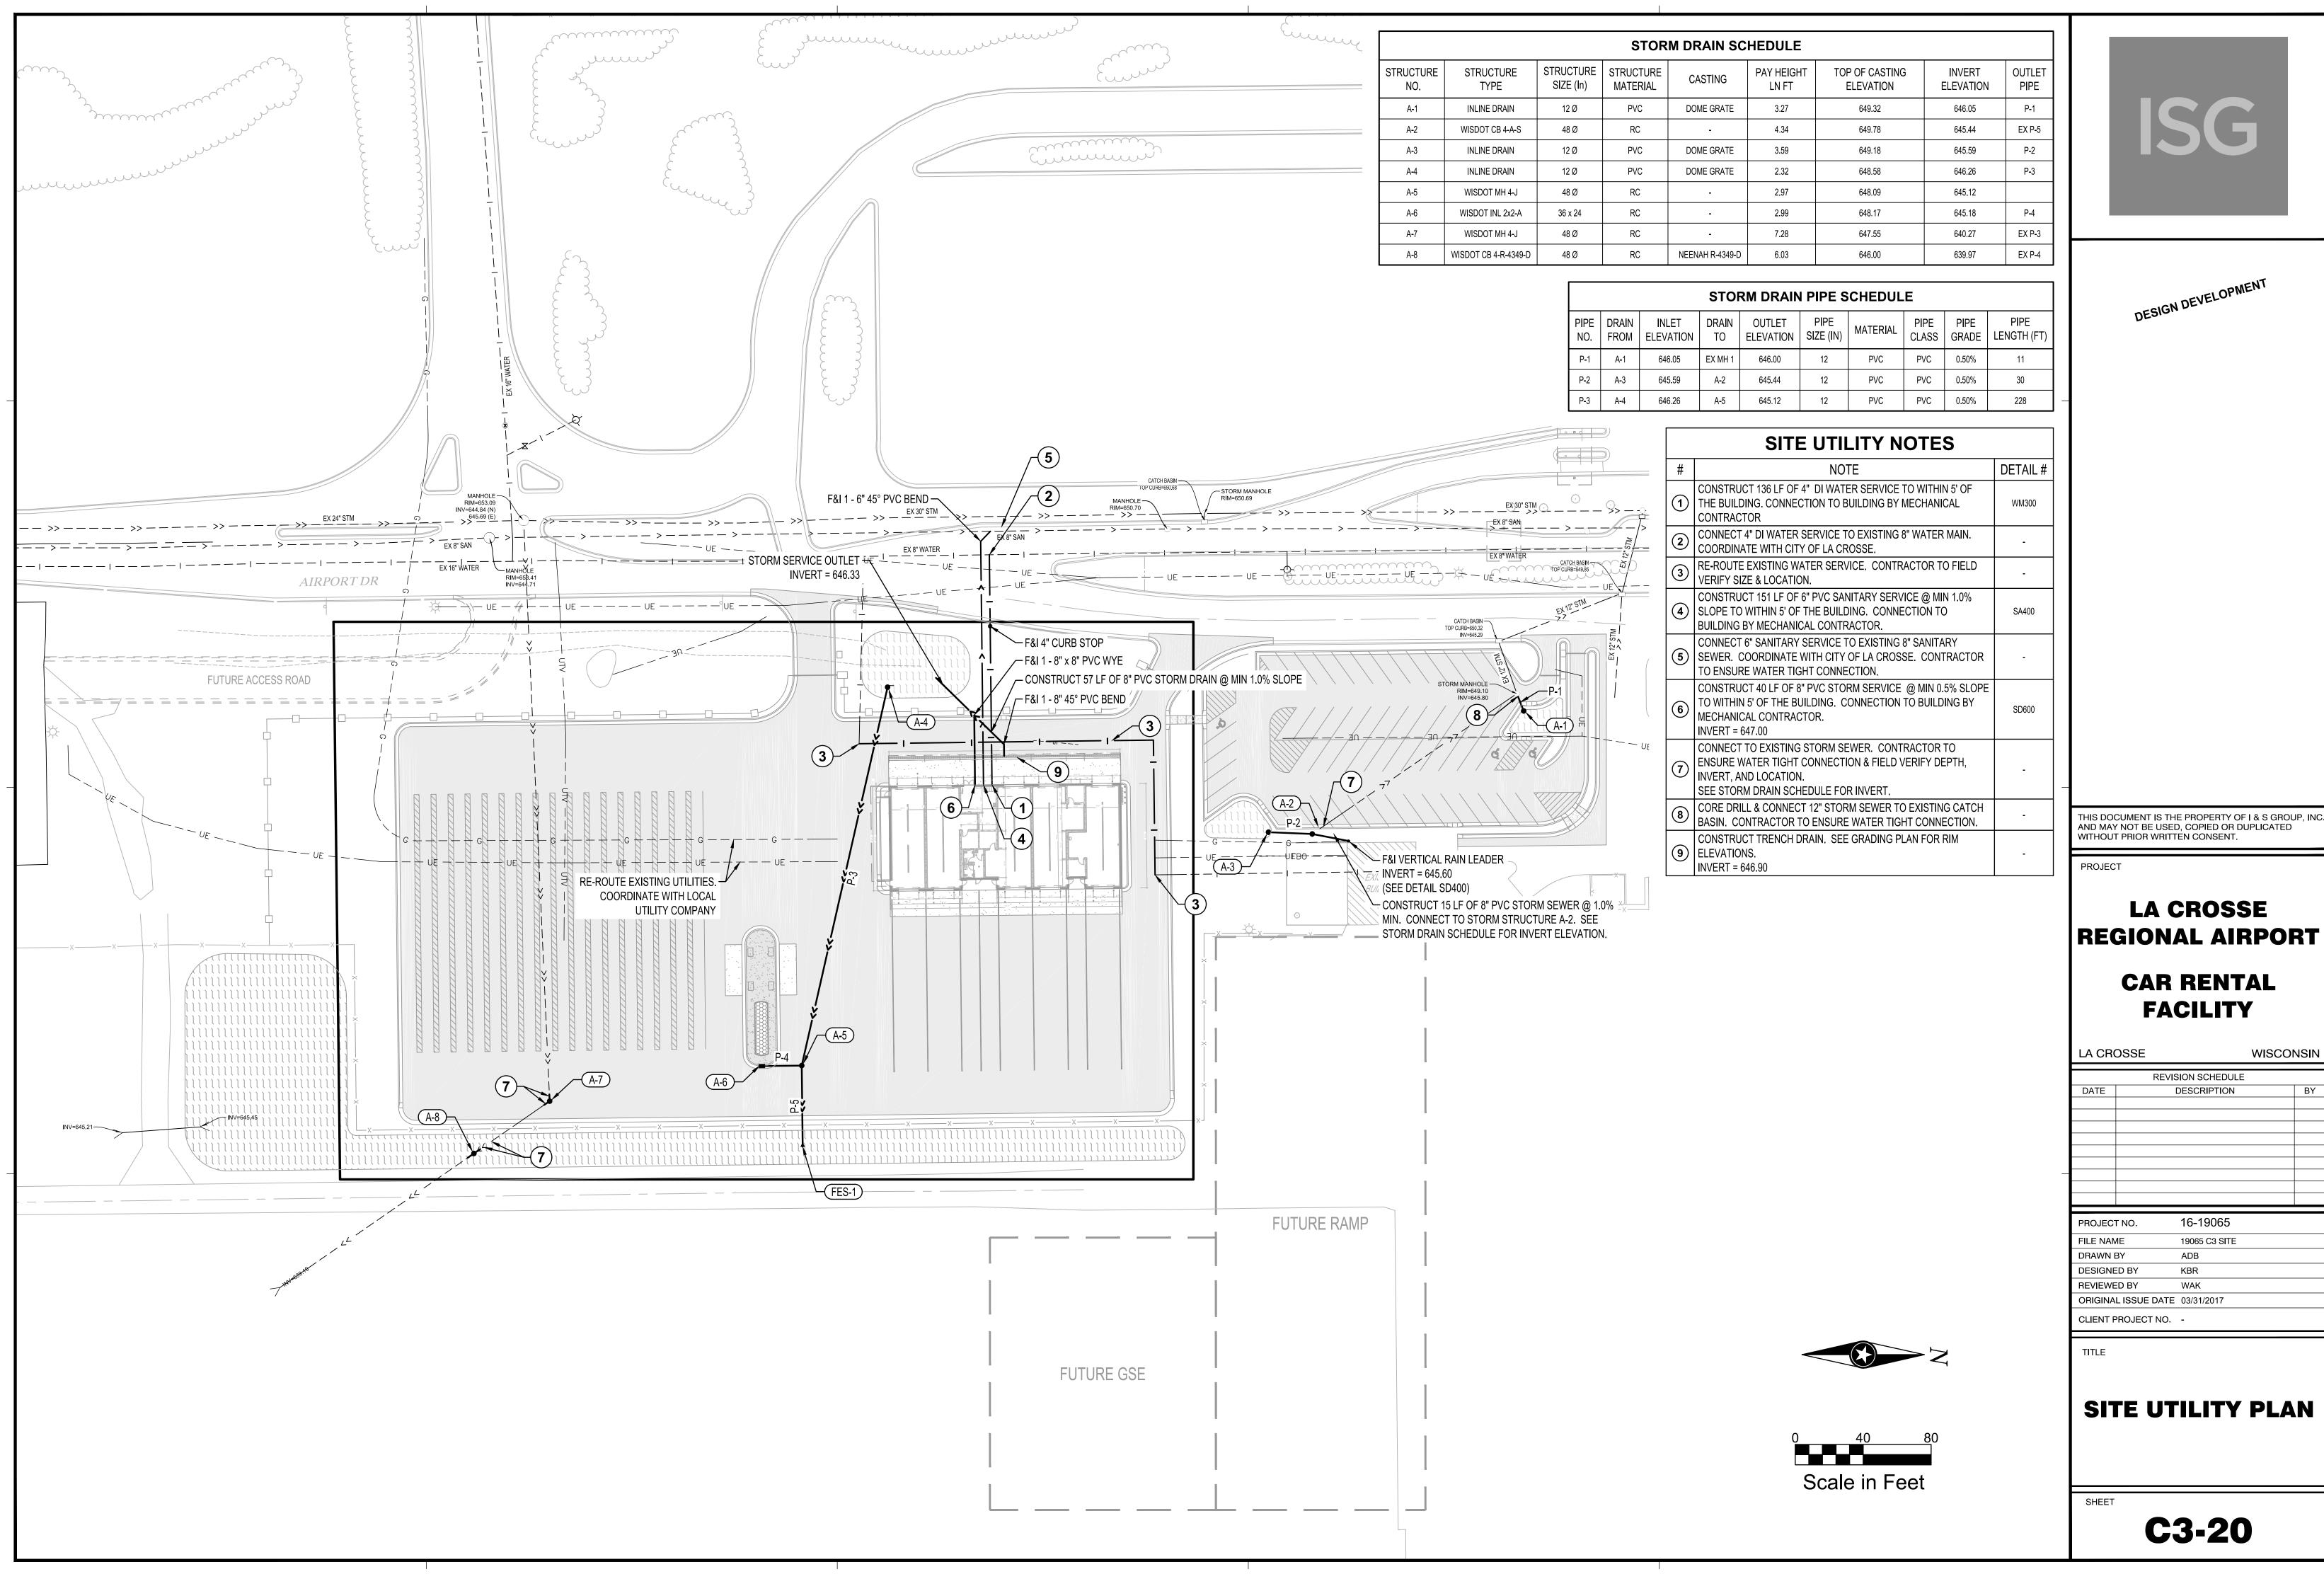
## EROSION CONTOL NOTES & DETAILS

SHEET

C1-30



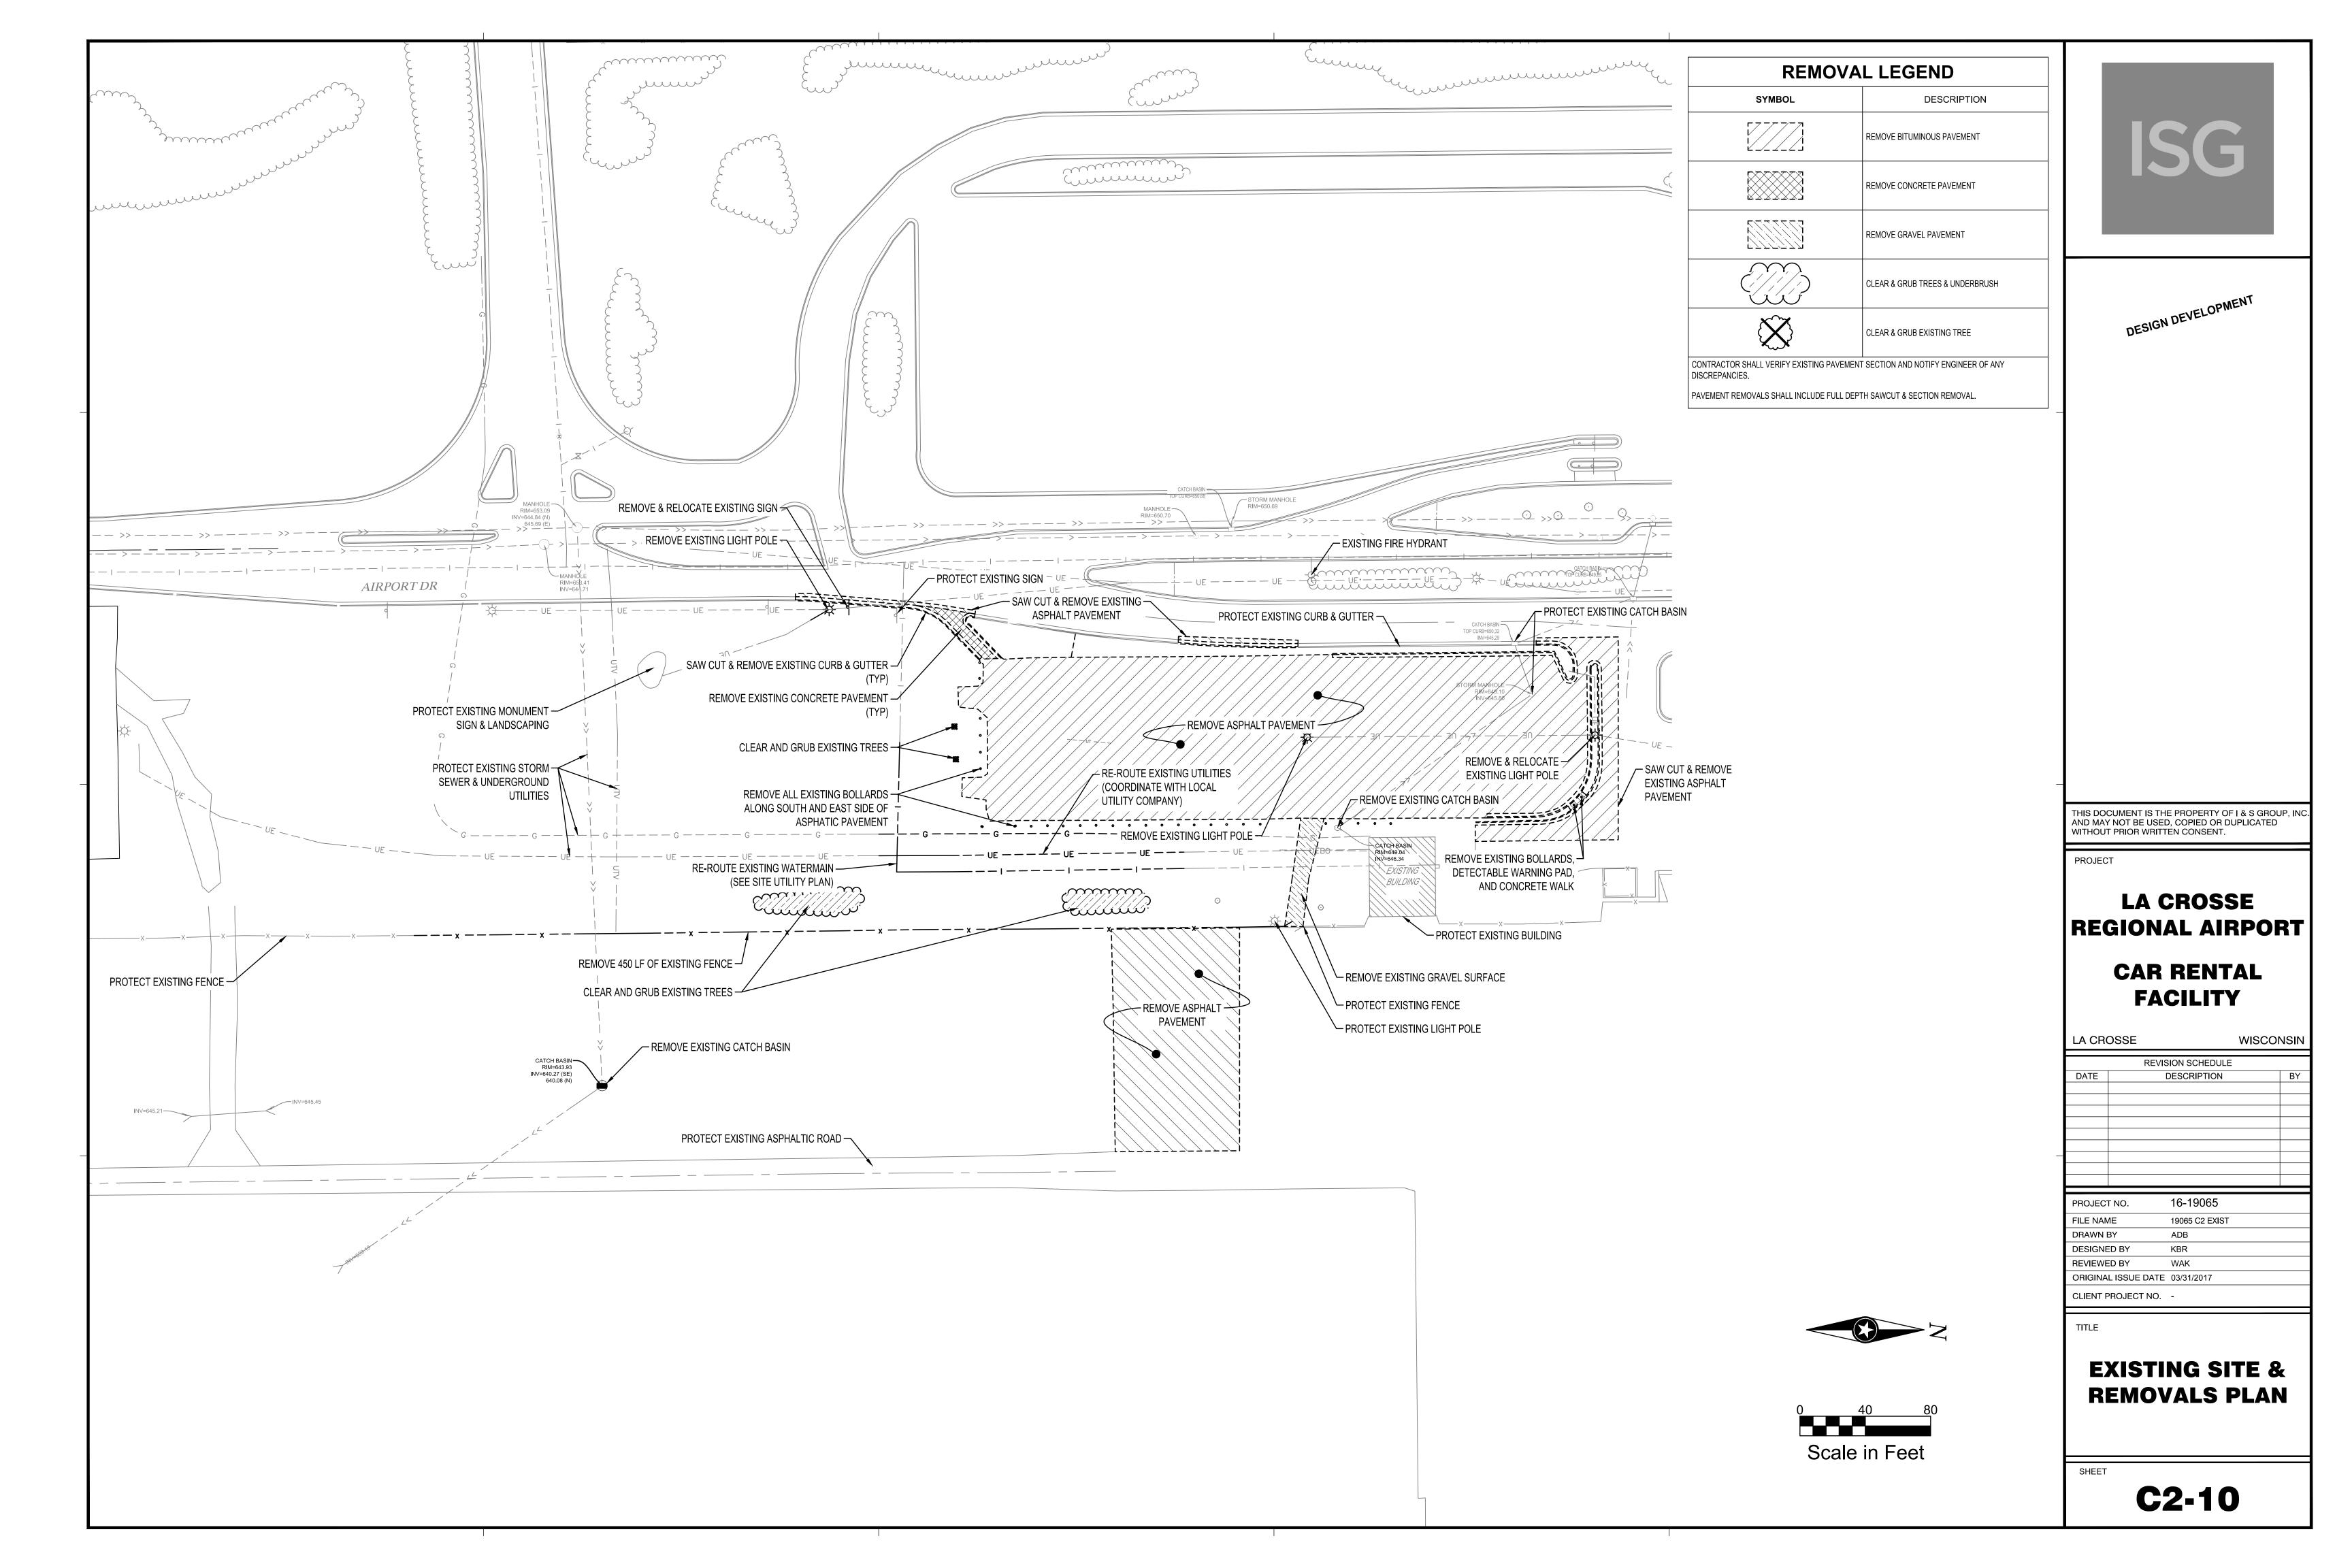


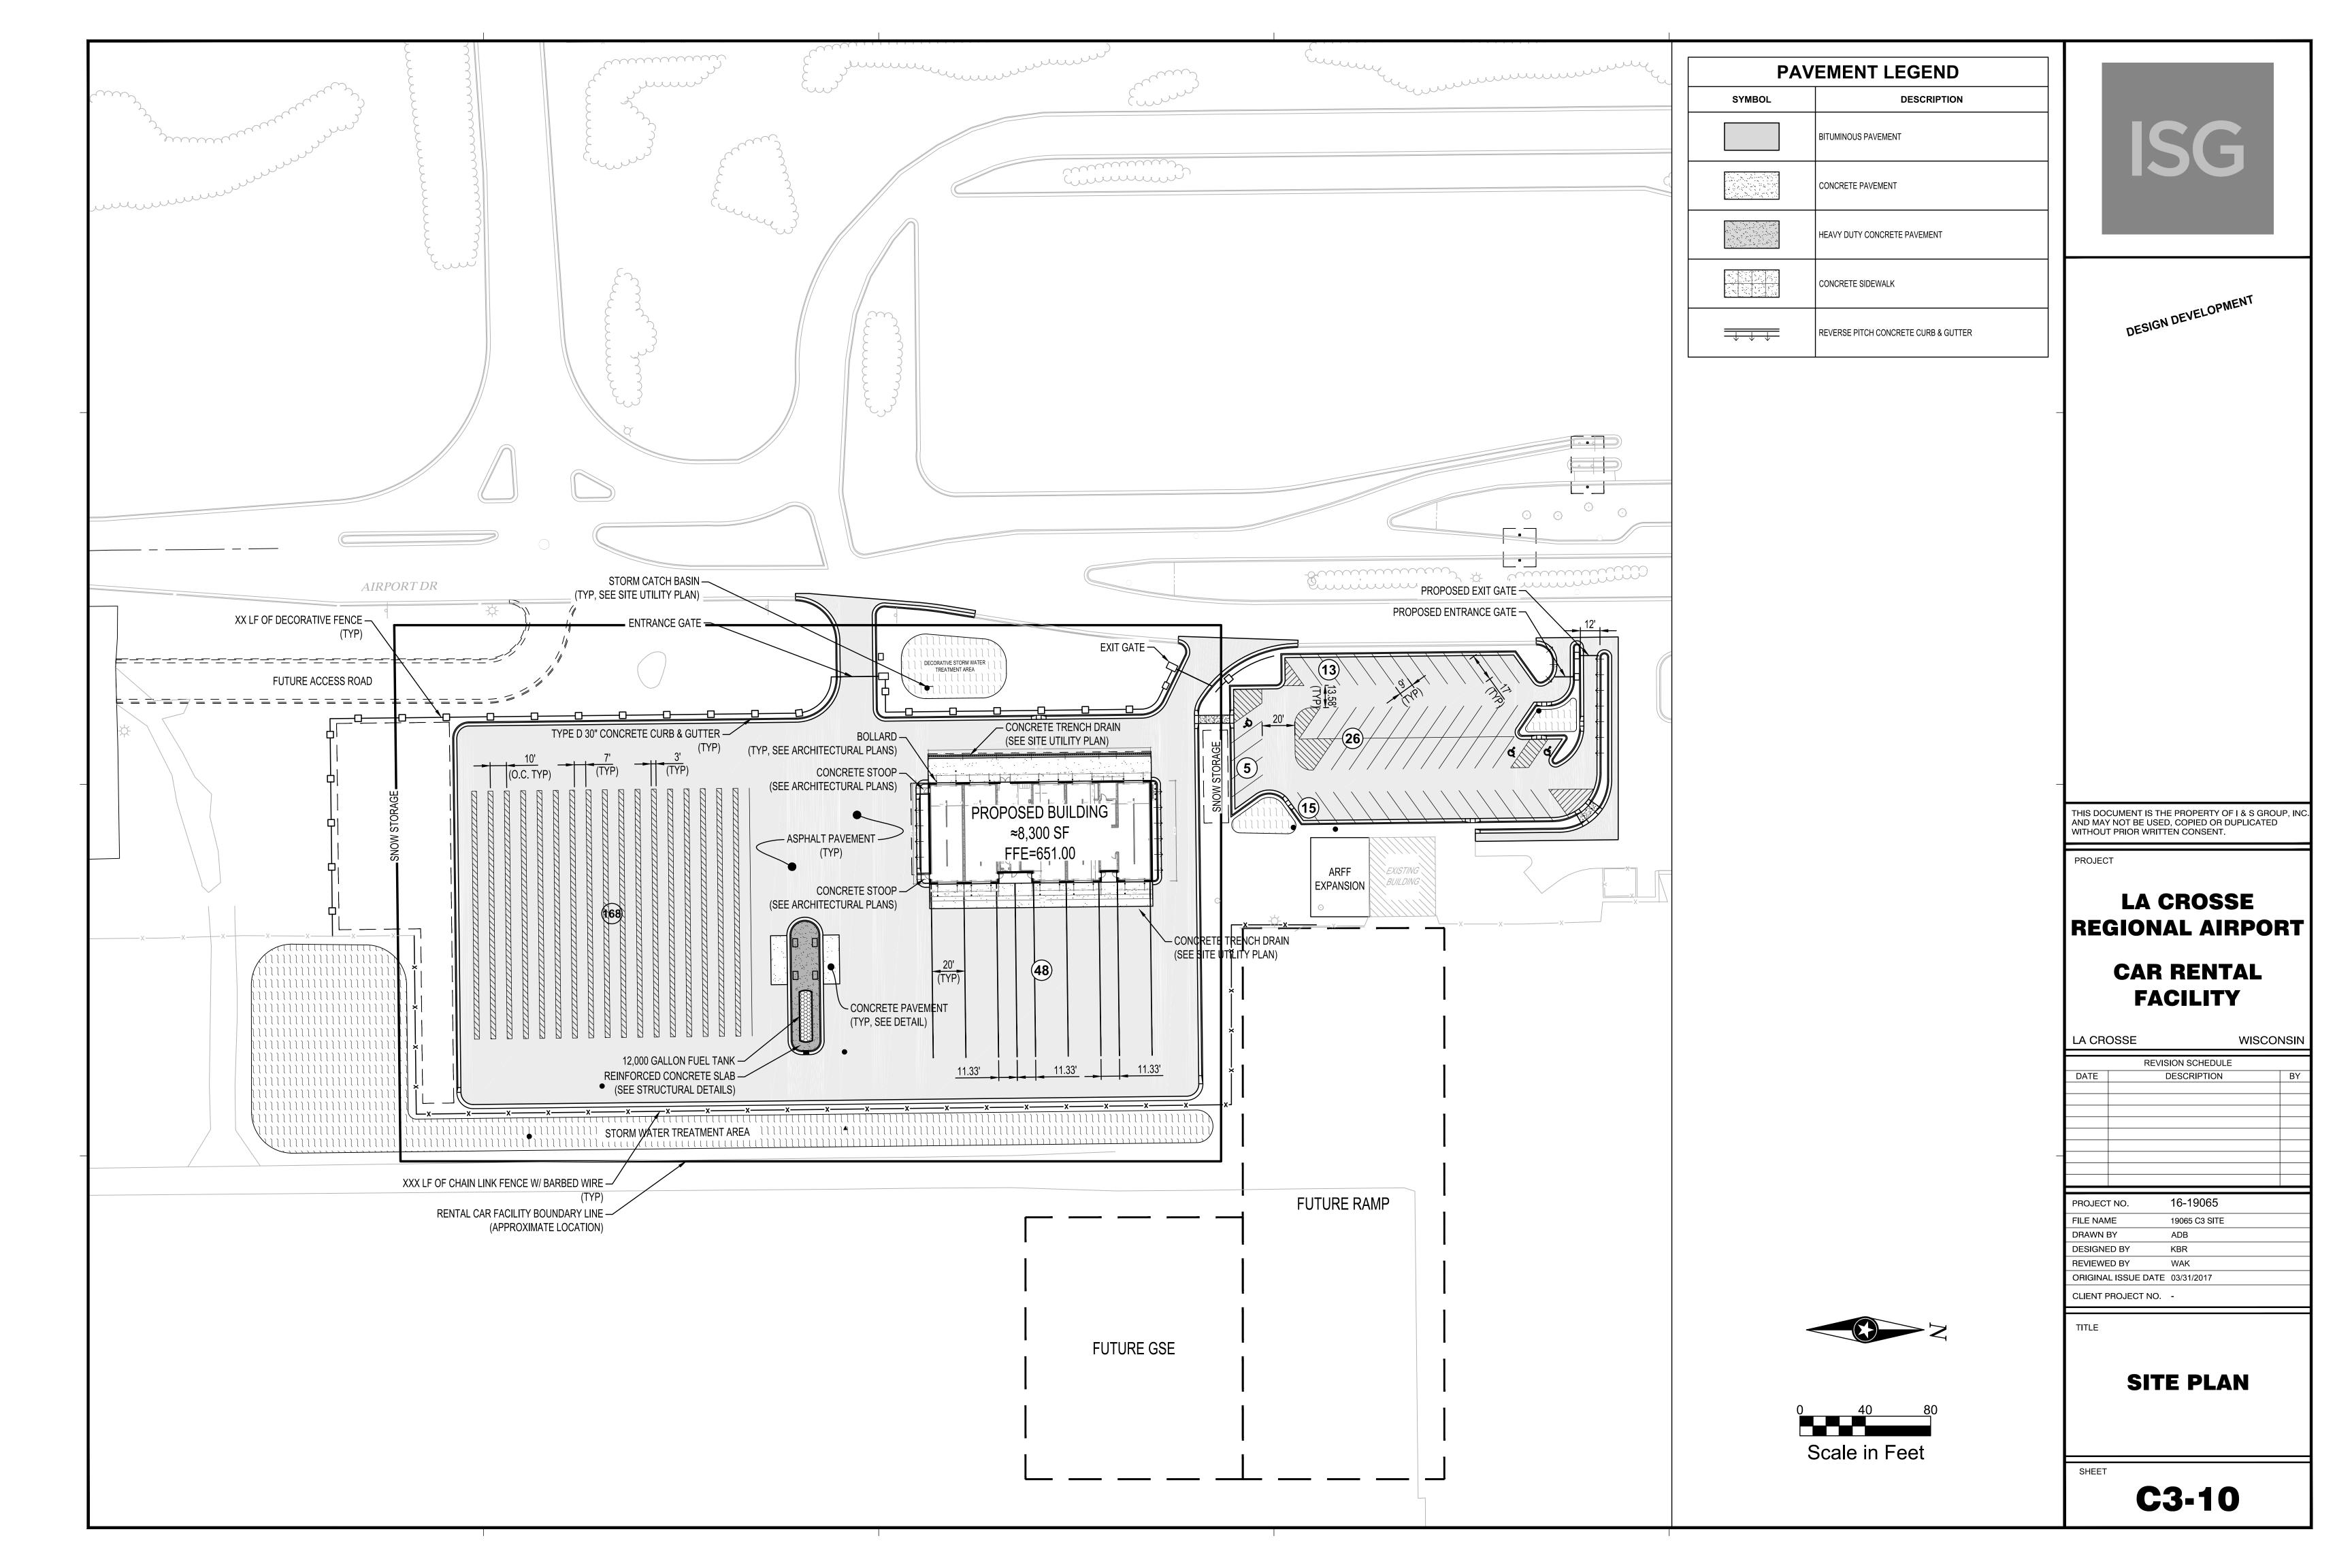



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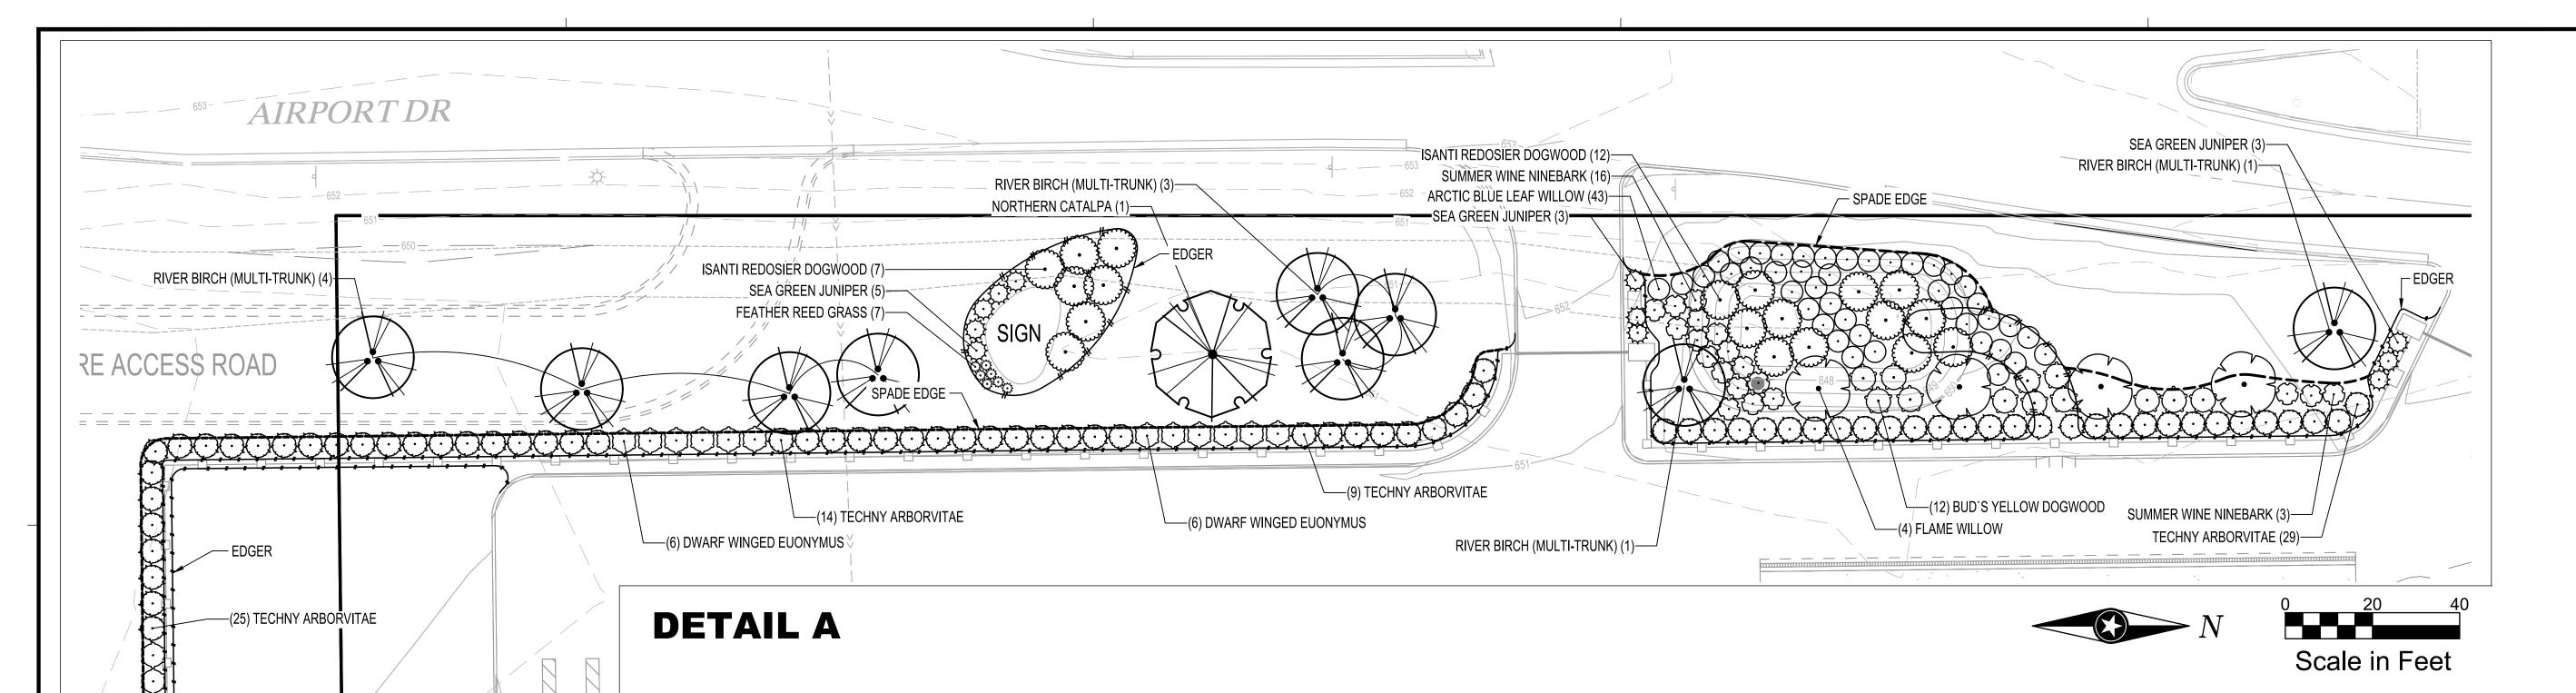
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PROJECT NO.	16-19065
FILE NAME	19065 C3 SITE
DRAWN BY	ADB
DESIGNED BY	KBR
REVIEWED BY	WAK
ORIGINAL ISSUE DATE	03/31/2017
CLIENT PROJECT NO.	-





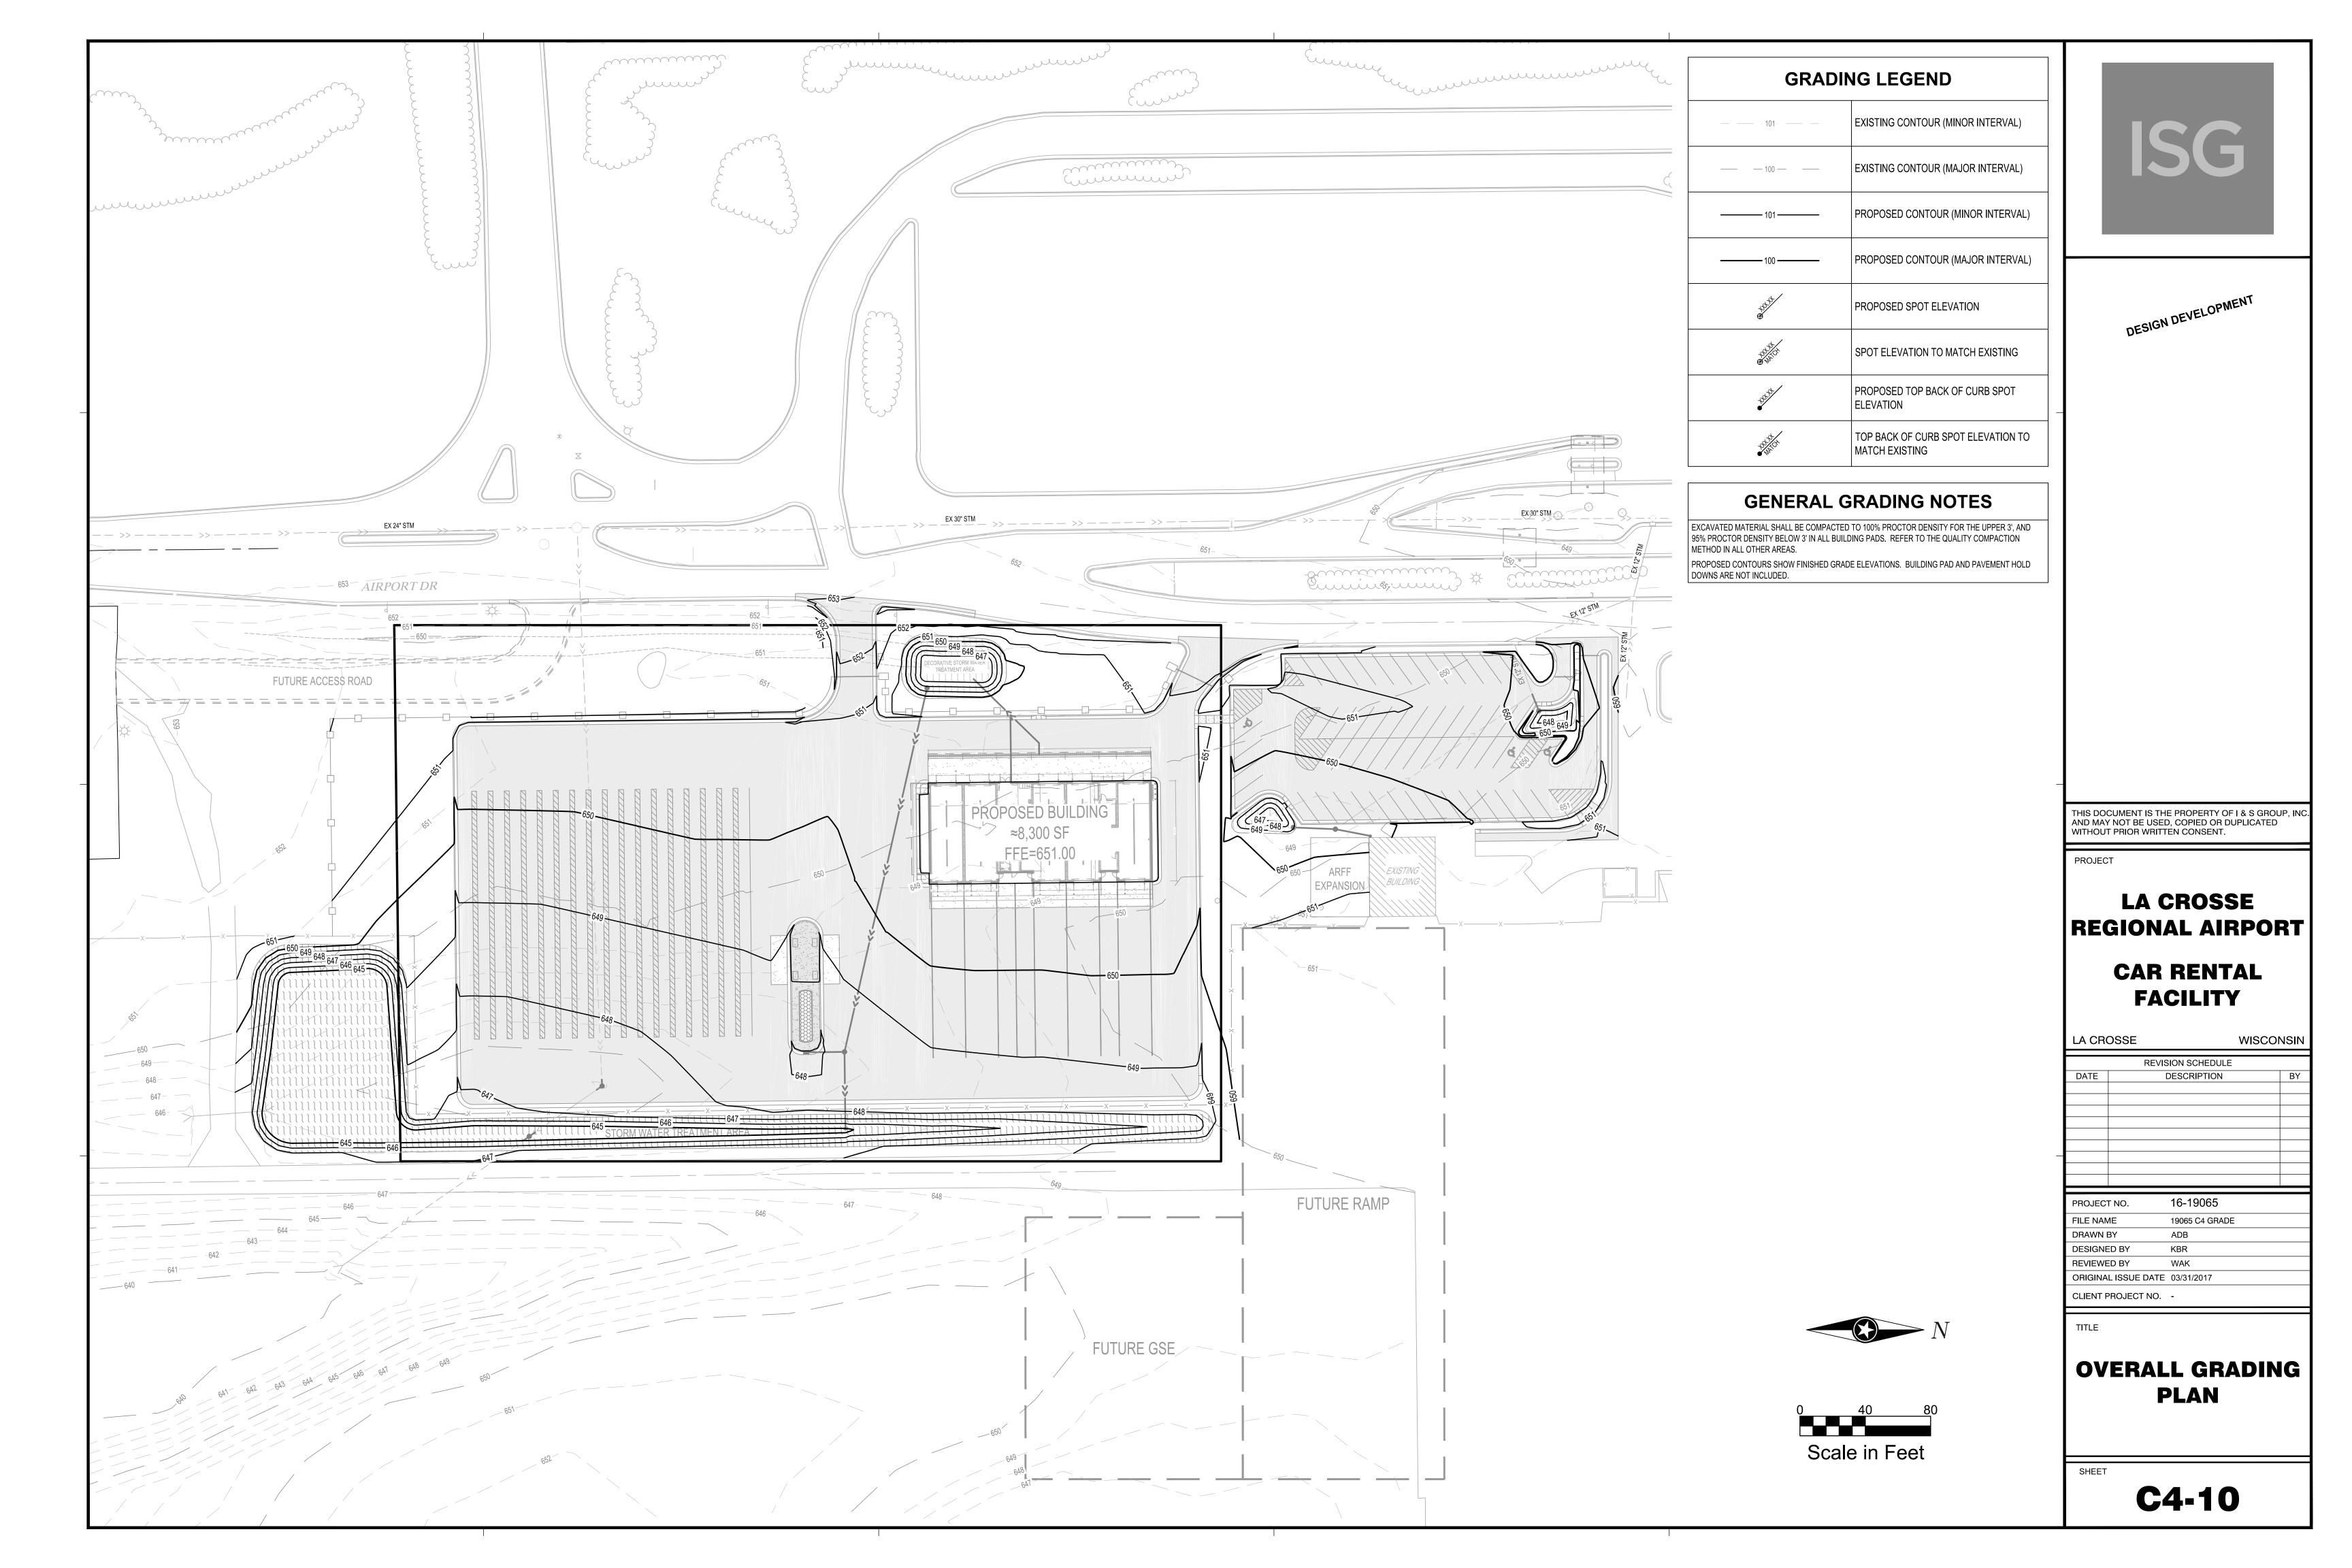

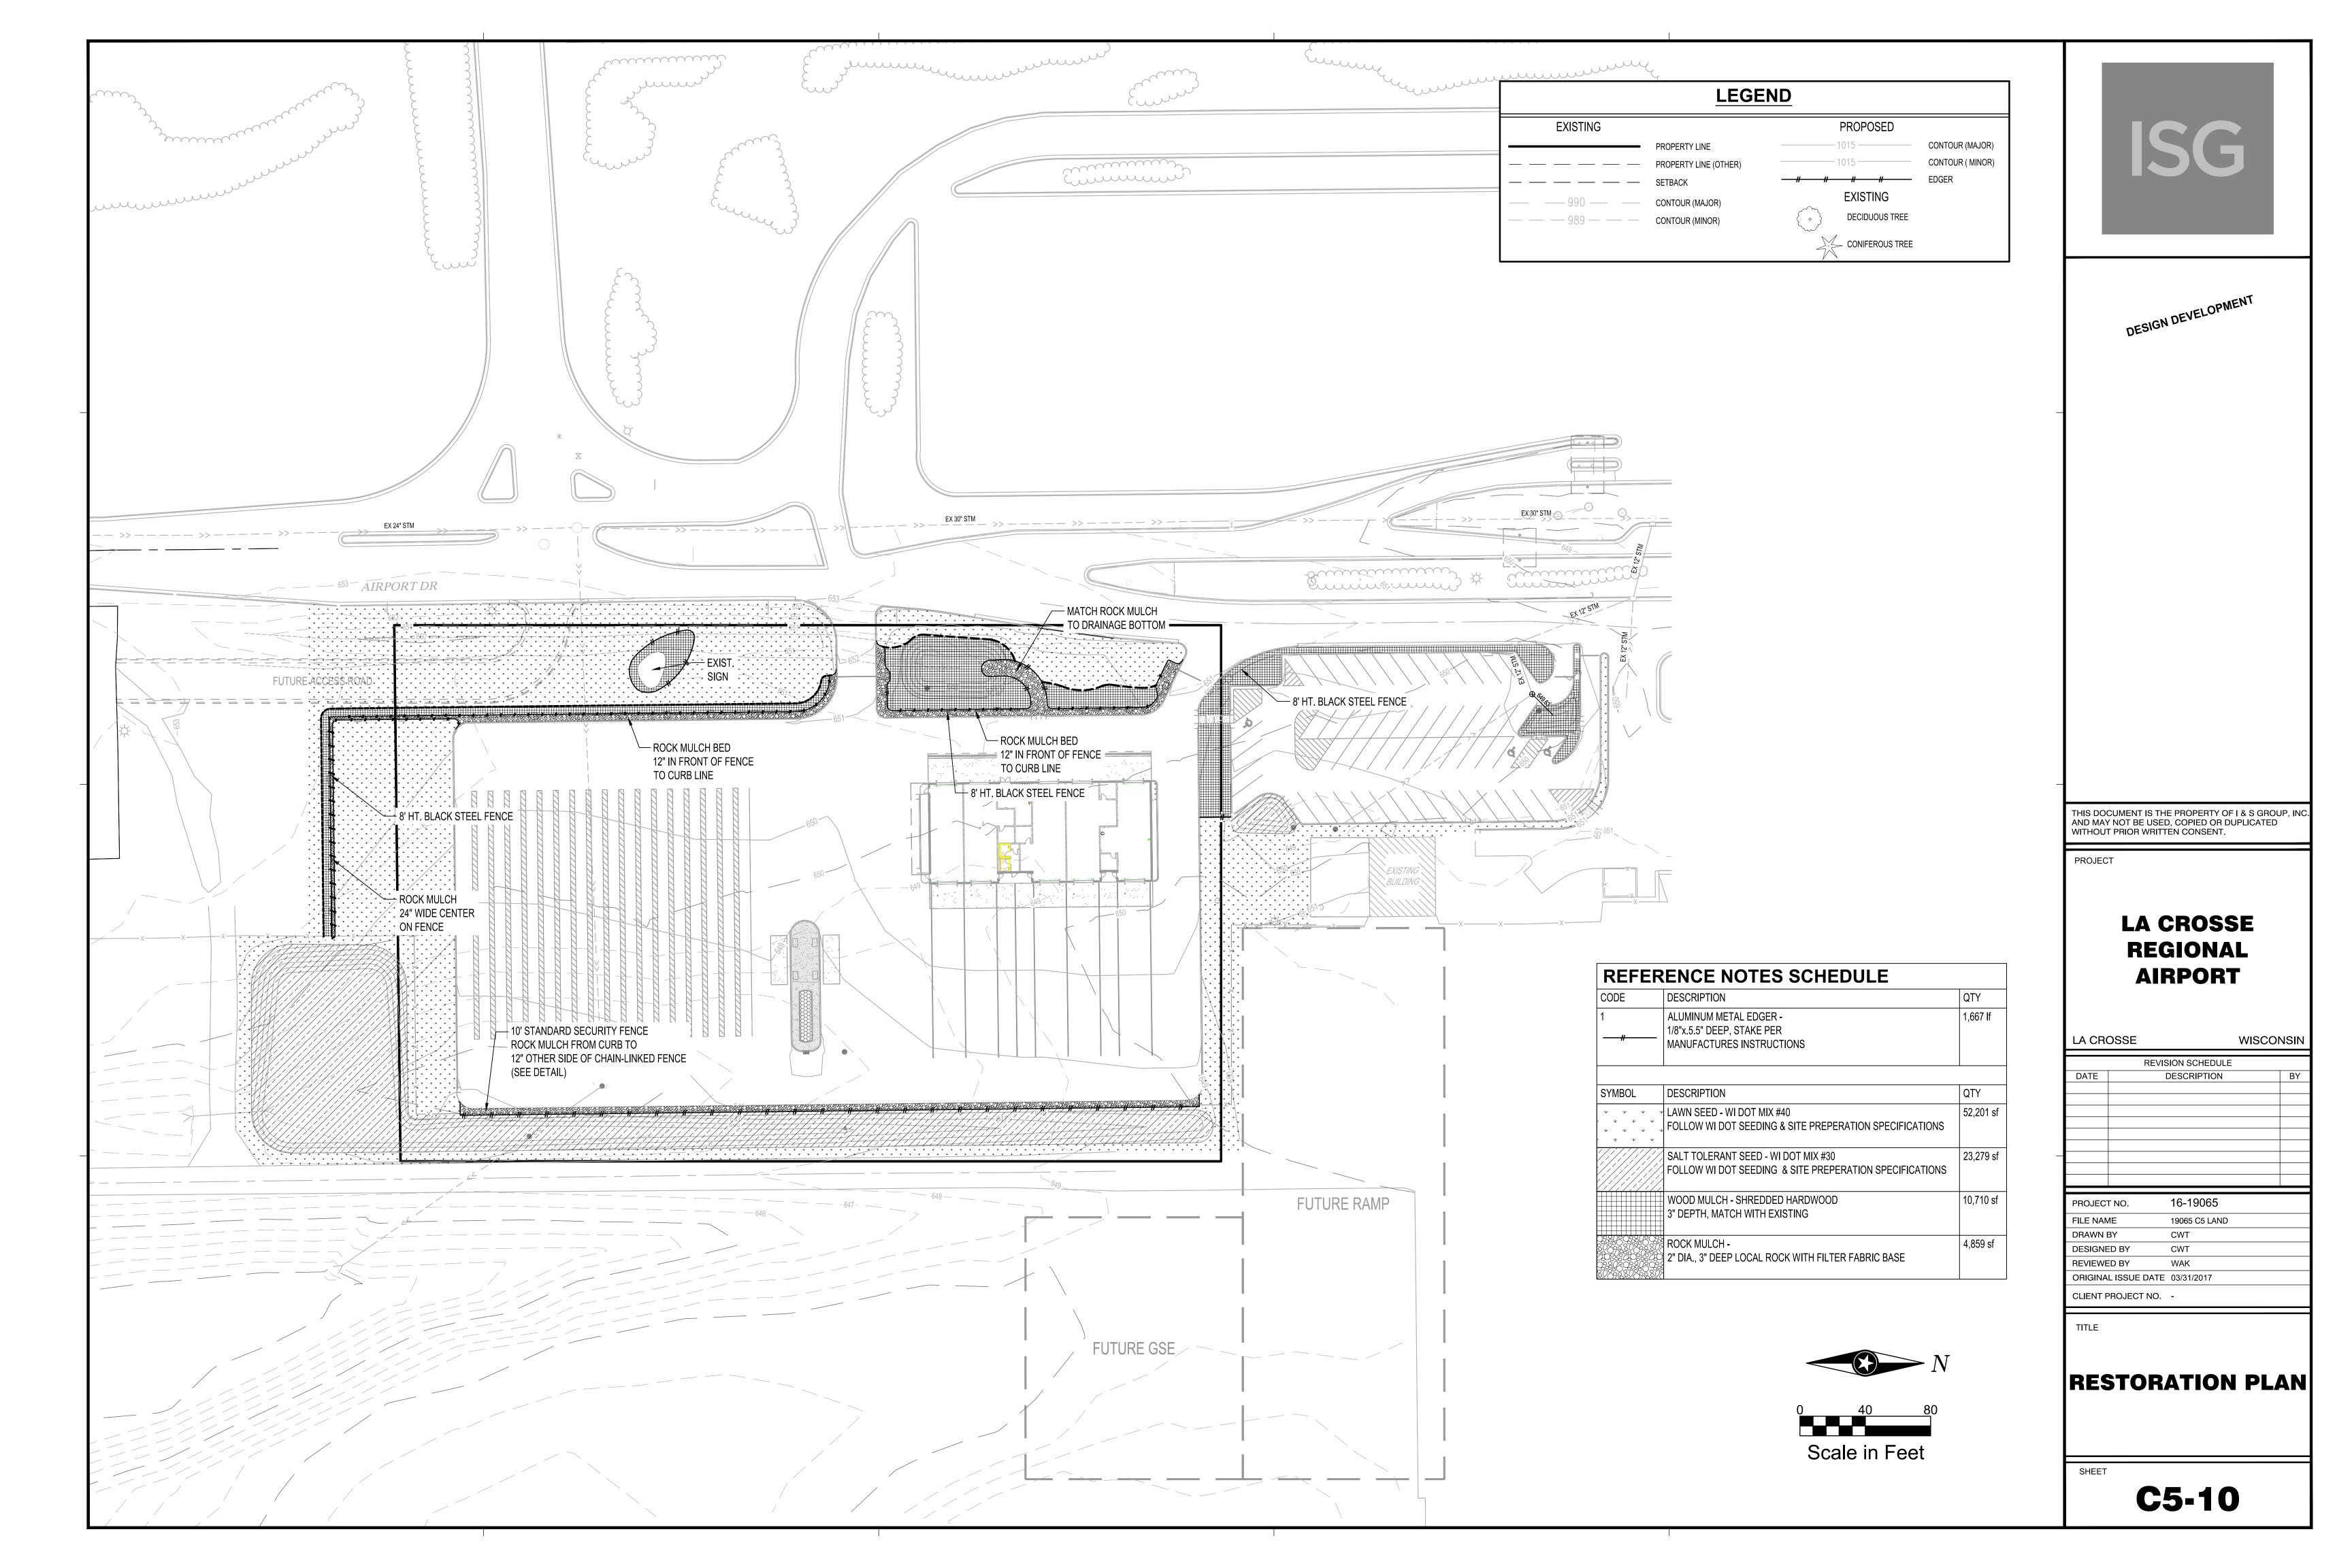
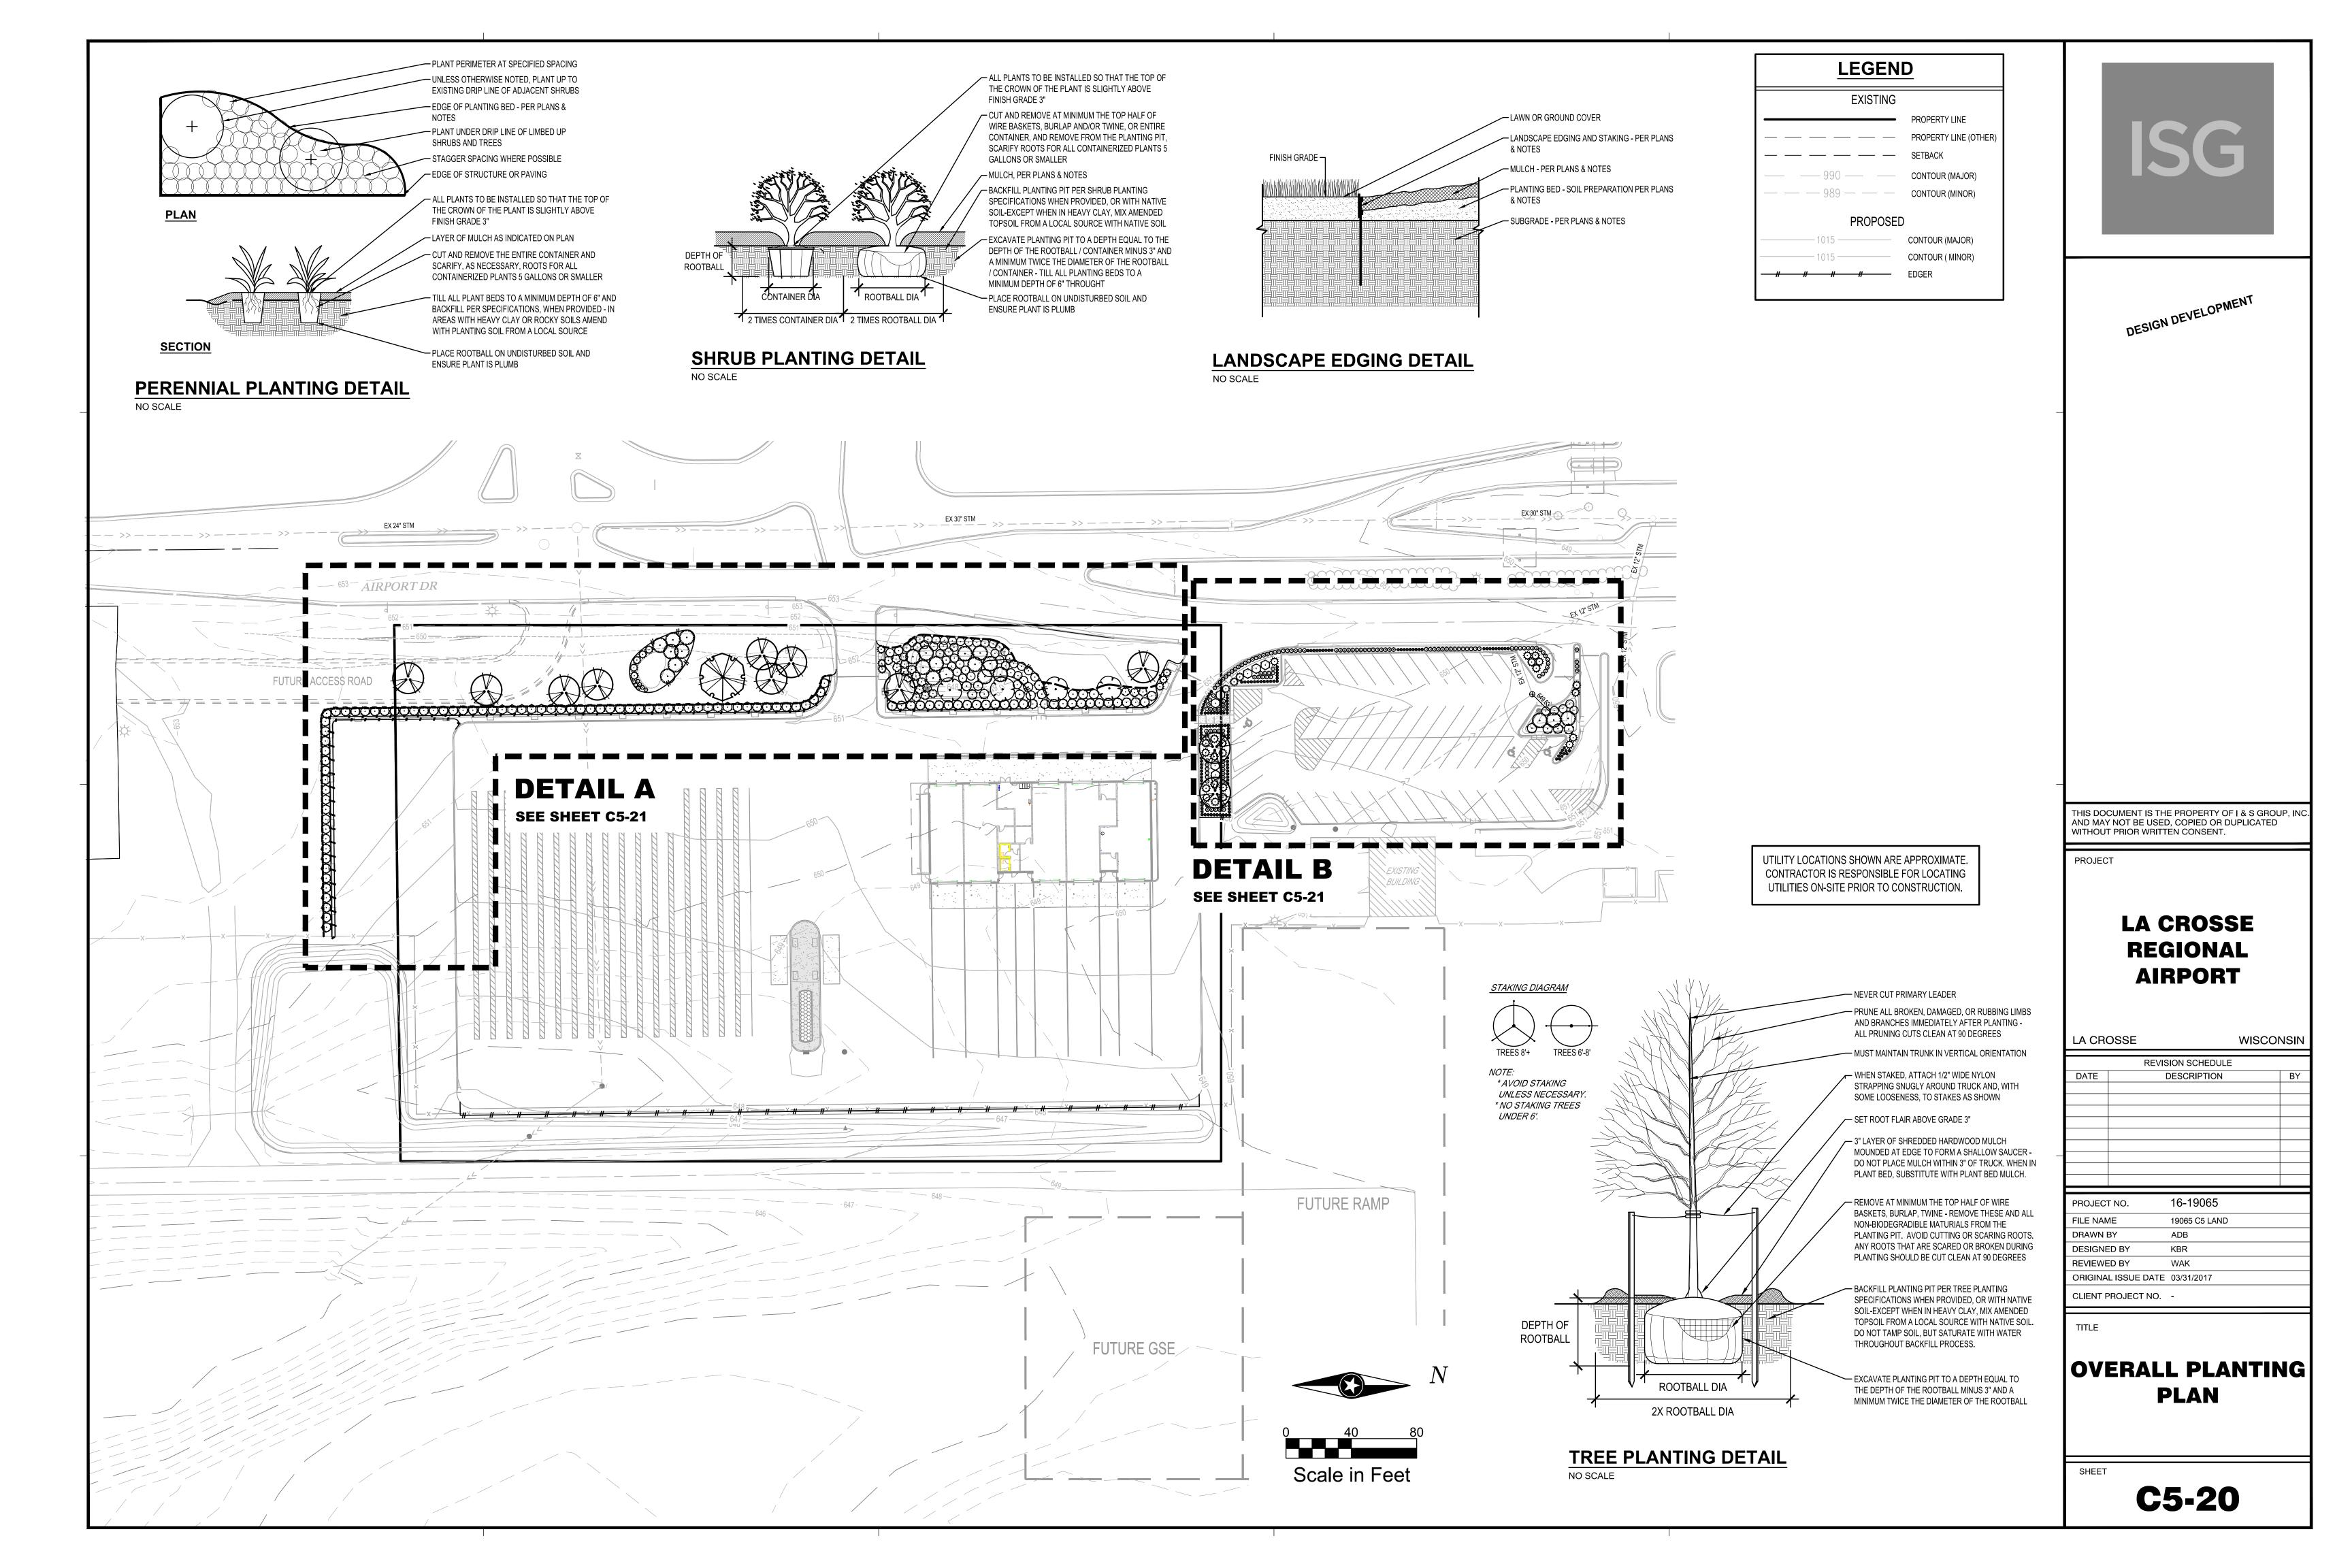
## **LEGEND EXISTING** PROPERTY LINE (OTHER CONTOUR (MAJOR) — — 989 — — — CONTOUR (MINOR) CONTOUR (MAJOR) CONTOUR ( MINOR)

**GENERAL PLANTING NOTES** 

1. COORDINATE LOCATION OF ALL UTILITIES (LINES, DUCTS, CONDUITS, SLEEVES, FOOTINGS, ETC.) WITH LOCATIONS OF PROPOSED LANDSCAPE ELEMENTS (FENCE, FOOTINGS, TREE ROOTBALLS, ETC.). CONTRACTOR SHALL REPORT ANY DISCREPANCIES TO OWNER'S

REPRESENTATIVE PRIOR TO CONTINUING WORK. 2. SAVE AND PROTECT ALL EXISTING TREES NOT NOTED TO BE REMOVED. 3. REMOVE ALL CONSTRUCTION DEBRIS AND MATERIALS INJURIOUSTO PLANT GROWTH FROM

PLANTING PITS AND BEDS PRIOR TO BACKFILLING WITH PLANTING MIX. 4. LAWN AREAS SHALL HAVE 6" MINIMUM DEPTH OF TOPSOIL. TOPSOIL SHALL BE COMPACTED TO

85% MAXIMUM DENSITY AT OPTIMUM MOISTURE CONTENT.

5. REFER TO PLANTING DETAILS PLAN FOR AMENDED SOIL DEPTH IN PLANTING BEDS AND SURROUNDING TREES. REFER TO SPECIFICATIONS FOR MIX TYPE.

6. FIELD STAKE PLANTINGS ACCORDING TO PLAN. OWNER'S REPRESENTATIVE SHALL APPROVE ALL PLANT LOCATIONS PRIOR TO INSTALLATION. OWNER RESERVES THE RIGHT TO REVISE PLANTING LAYOUT AT TIME OF INSTALLATION.

7. ALL PLANT MATERIALS SHALL BE TRUE TO THEIR SCIENTIFIC NAME AND SIZE AS INDICATED IN THE PLANT SCHEDULE.

8. IF DISCREPANCIES EXIST BETWEEN THE NUMBER OF PLANTS DRAWN ON THE PLANTING PLAN AND THE NUMBER OF PLANTS IN THE SCHEDULE, THE PLANTING PLAN SHALL GOVERN.

9. OWNER RESERVES THE RIGHT TO REVISE QUANTITIES TO SUIT BUDGET LIMITATIONS.

CONTRACTOR'S UNIT BID PRICES SHALL PREVAIL FOR ANY CHANGES IN QUANTITIES. 10. ANY PROPOSED SUBSTITUTIONS OF PLANT SPECIES SHALL BE MADE WITH PLANTS OF EQUIVALENT OVERALL FORM, HEIGHT, BRANCHING HABIT, FLOWER, LEAF, COLOR, FRUIT AND CULTURE, AND ONLY AFTER WRITTEN APPROVAL OF THE OWNER'S REPRESENTATIVE AND

11. ALL PLANT MATERIALS MUST CONFORM TO AMERICAN STANDARDS FOR NURSERY STOCK (A.N.S.I.), LATEST EDITION PUBLISHED BY THE AMERICAN ASSOCIATION OF NURSERYMEN, WASHINGTON D.C. LARGER SIZED PLANT MATERIALS OF THE SPECIES LISTED MAY BE USED IF THE STOCK CONFORMS TO A.N.S.I.

12. ALL PLANT MATERIAL SHALL BE GUARANTEED TO BE IN A LIVE AND HEALTHY GROWING CONDITION FOR ONE FULL GROWING SEASON (ONE YEAR) AFTER FINAL PROJECT ACCEPTANCE OR SHALL BE REPLACED FREE OF CHARGE WITH THE SAME GRADE AND SPECIES. ALL TREES SHALL HAVE A STRONG CENTRAL LEADER.

13. CONTRACTOR IS RESPONSIBLE FOR ALL DAMAGE DUE TO OPERATIONS INSIDE AND OUTSIDE OF THE CONTRACT LIMIT LINE. ANY AREAS OUTSIDE THE LIMIT OF WORK THAT ARE DISTURBED SHALL BE RESTORED TO ITS ORIGINAL CONDITION AT NO ADDITIONAL COST TO THE OWNER. 14. ALL PLANTING BEDS SHALL HAVE SPADE DUG EDGES, EXCEPT WHERE NOTED OTHERWISE.

15. PLANTING BED EDGING - USE 1/8" x 4" STEEL EDGING IN ALL AREAS WHERE PLANTING BED MEETS LAWN AREAS OR WHERE INDICATED. USE 12" METAL SPIKES AS INSTRUCTED BY MANUFACTURER.

16. PROVIDE SHREDDED HARDWOOD MULCH, NATURAL COLOR, SURROUNDING ALL PROPOSED TREES TO A 3-INCH MINIMUM DEPTH AS SHOWN IN TREE PLANTING DETAIL. DO NOT USE AN UNDERLAYMENT SUCH AS PLASTIC SHEET OR LANDSCAPE FABRIC. IF LOCATED WITHIN A PLANT BED, SUBSTITUTE THIS MULCH WITH THE MULCH CALLED FOR WITHIN THAT PLANT BED. APPLY PRE-EMERGENT TO ALL PLANTING BEDS PRIOR TO MULCHING.

17. PROVIDE SHREDDED HARDWOOD MULCH IN LOCATIONS SHOWN ON PLAN AT 3-INCH MINIMUM DEPTH. DO NOT USE AN UNDERLAYMENT SUCH AS PLASTIC SHEET OR LANDSCAPE FABRIC. APPLY PRE-EMERGENT TO ALL PLANTING BEDS PRIOR TO MULCHING.

18. PROVIDE ROCK MULCH IN ALL PLANTING BEDS TO A 3-INCH MINIMUM DEPTH. USE A PROFESSIONAL GRADE WOVEN WATER PERMEABLE LANDSCAPE FABRIC UNDERLAYMENT. DO NOT USE PLASTIC SHEETING. APPLY PRE-EMERGENT TO ALL PLANTING BEDS PRIOR TO

19. INDICATED QUANTITIES ARE ESTIMATES AND SHOULD BE CONFIRMED BY THE CONTRACTOR/BIDDER.

LA CROSSE WISCONSIN REVISION SCHEDULE DATE DESCRIPTION

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LA CROSSE

**REGIONAL** 

**AIRPORT** 

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PROJECT

DESIGN DEVELOPMENT


16-19065 PROJECT NO. FILE NAME 19065 C5 LAND DRAWN BY ADB DESIGNED BY KBR REVIEWED BY WAK ORIGINAL ISSUE DATE 03/31/2017 CLIENT PROJECT NO. -

TITLE

**PLANTING PLAN DETAILS** 

SHEET

C5-21

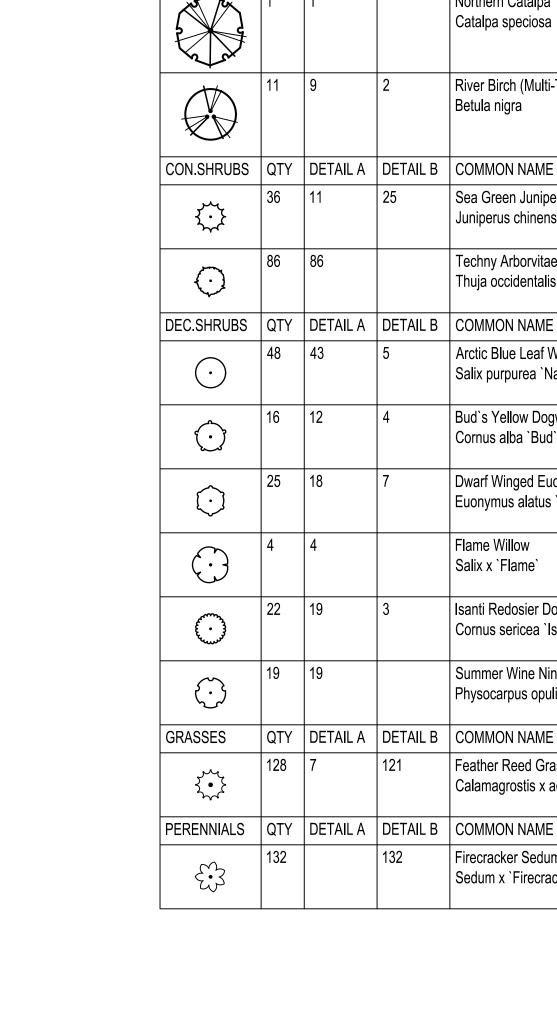

PLANT SCHEDULE

SHADE TREE | QTY | DETAIL A | DETAIL B | COMMON NAME

Northern Catalpa

River Birch (Multi-Trunk)

| Sea Green Juniper

Techny Arborvitae

Juniperus chinensis 'Sea Green'

Thuja occidentalis `Techny`

Arctic Blue Leaf Willow

Salix purpurea 'Nana'

Bud`s Yellow Dogwood

Cornus alba `Bud`s Yellow`

Dwarf Winged Euonymus

Isanti Redosier Dogwood

Cornus sericea 'Isanti'

Summer Wine Ninebark

Feather Reed Grass

Firecracker Sedum

Sedum x `Firecracker`

Physocarpus opulifolius `Summer Wine`

Calamagrostis x acutiflora `Karl Foerster`

Flame Willow

Salix x `Flame`

Euonymus alatus 'Compactus'

2-1/2" Cal | B & B

SIZE

SIZE

24" Ht.

24" Ht.

4` Ht.

36" Ht

24" Ht.

24" Ht.

SIZE

12" Ht

SIZE

6" HT.

B&B

Cont

Cont

ROOT

Cont

Cont

Cont

Cont

Cont


Cont

ROOT

#1 Cont.

ROOT

#1 Cont.

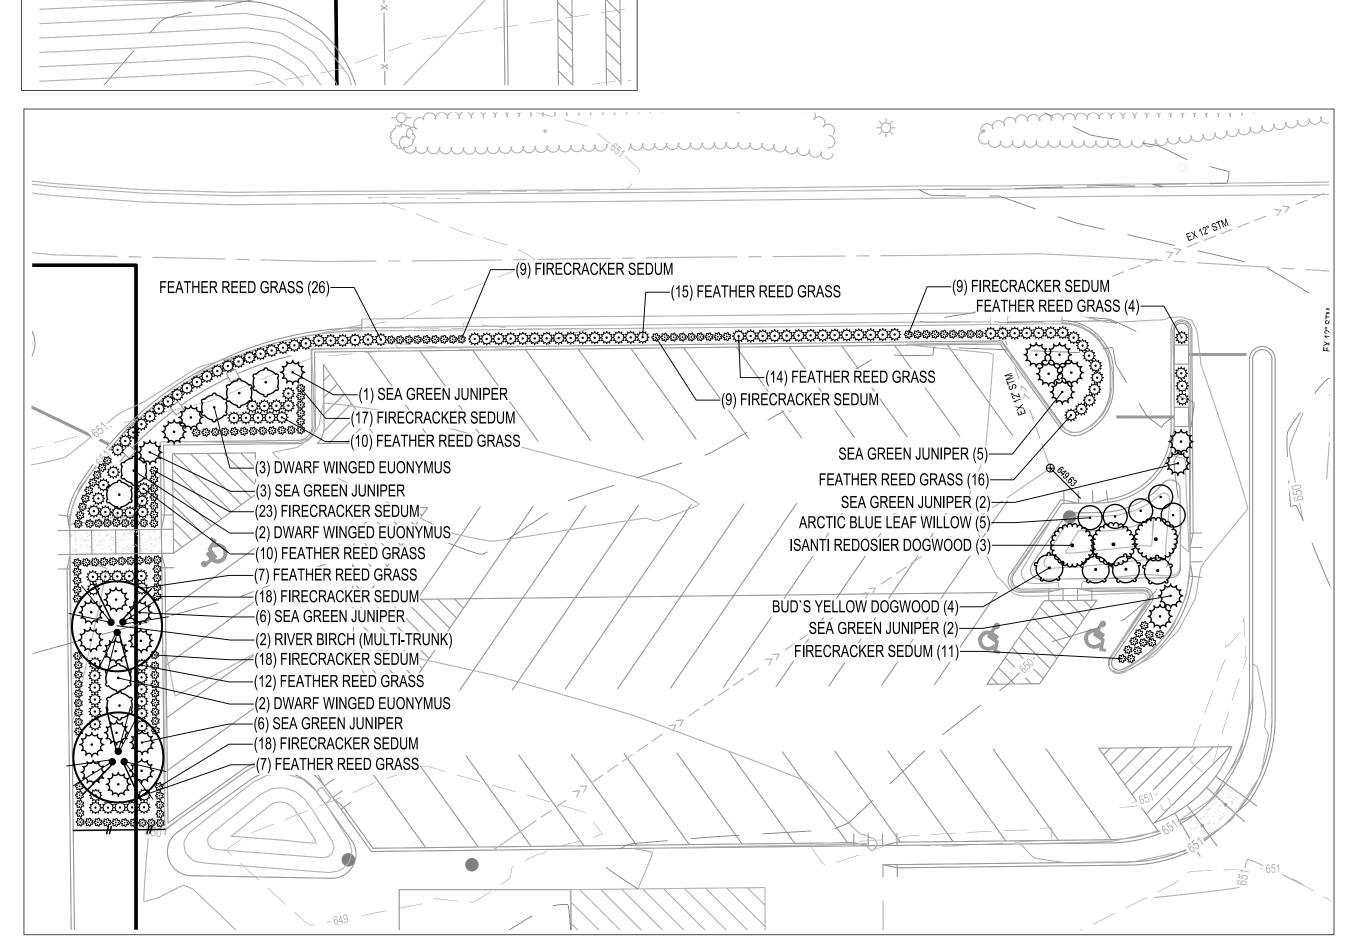

-(6) DWARF WINGED EUONYMUS

-(9) TECHNY ARBORVITAE

**DETAIL B** 



UTILITY LOCATIONS SHOWN ARE APPROXIMATE.

CONTRACTOR IS RESPONSIBLE FOR LOCATING


UTILITIES ON-SITE PRIOR TO CONSTRUCTION.



### **INTERIOR PARTITION KEY NOTES:**


#### NOT ALL KEY NOTES APPLY TO PROJECT. VERIFY WITH SPECIFIC WALL TYPE.

- 1. INCLUDE FIBERGLASS SOUND INSULATION.
- 2. PROVIDE FIRE-RATED SEALANT AT WALL BASE, TOP AND AROUND ALL PENETRATIONS.
- 3. REFER TO 2009 IBC TABLE 721.3.2 FOR CALCULATED FIRE-RESISTANCE RATING.
- 4. SPECIAL 8" BLOCK WITH 1.75" MIN. FACE SHELL THICKNESS.
- REFER TO MANUFACTURER'S SPECIFICATIONS FOR STANDARD CONNECTION DETAILS, SPECIFIC R-VALUE AND ADDITIONAL INFORMATION.
- 6. REFER TO SPECIFICATIONS FOR SPECIFIC WALL PANEL FACE FINISH AND PROFILE.
- 7. INCLUDE ACOUSTIC SEALANT AT WALL BASE AND TOP TERMINATION, BOTH SIDES OF WALL.

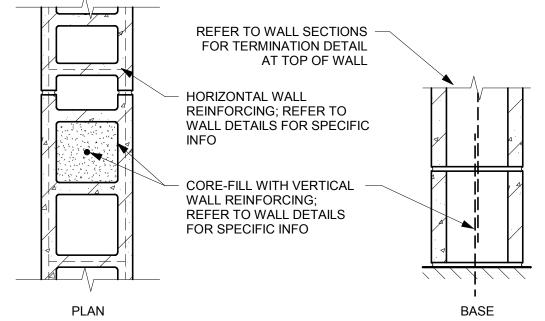

	WALL TYPE	BLOCK SIZE (NOMINAL WIDTH AND HEIGHT)	CALCULATED FIRE RATING	REINFORCING	COMMENTS
ſ	M4	4x8		REFER TO WALL	
	(M6)	6x8		DETAILS FOR SPECIFIC	
ſ	(M8)	8x8		INFO	

2 WALL TYPE M (INTERIOR NON-RATED MASONRY)
1 1/2" = 1'-0"

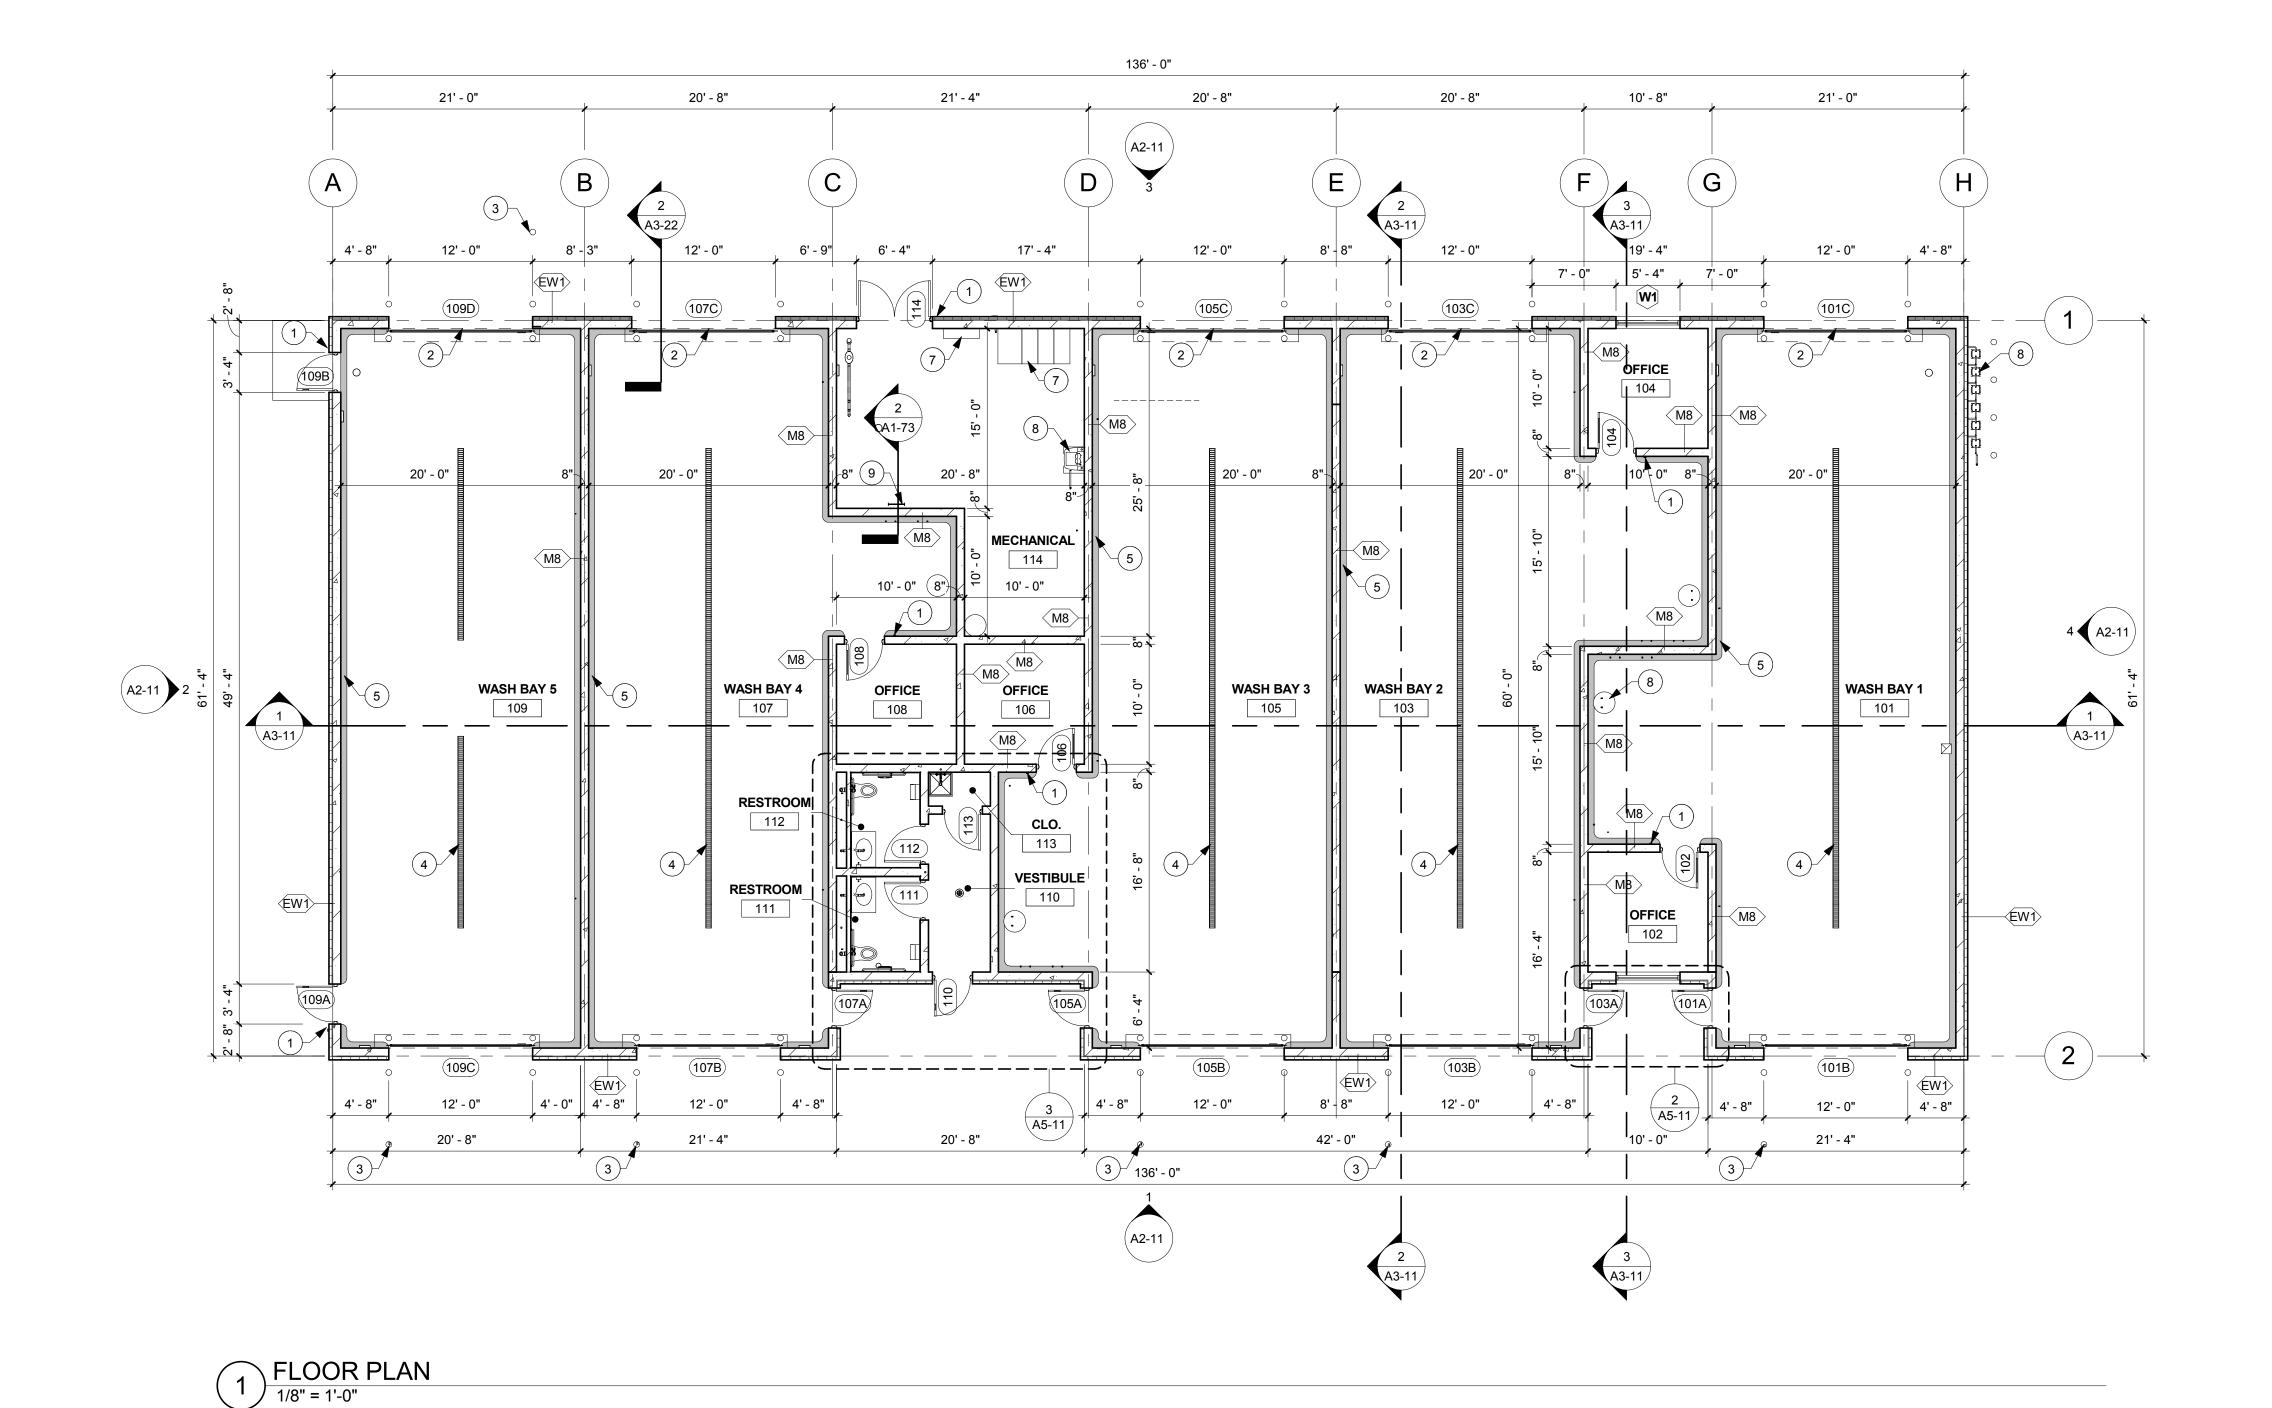

### SHEET NOTES

- ALL INTERIOR PARTITION WALLS SHALL BE WALL TYPE M8, UNLESS OTHERWISE NOTED.
- PITCH ALL CONCRETE STOOPS 1/4" PER FOOT AWAY FROM BUILDING.
- DIMENSIONS ARE FROM FACE OF MASONRY/ CONCRETE AND FACE OF GYPSUM BD. TO FACE OF GYPSUM BD. FOR STUD WALL, UNLESS NOTED OTHERWISE.
- REFER TO G1-21 FOR RATED WALL LOCATIONS. HOUSEKEEPING AND EQUIPMENT PADS BY GENERAL CONTRACTOR. REFER TO FIRE PROTECTION, PLUMBING, HVAC & ELECTRICAL DOCUMENTS FOR LOCATIONS.
- REFER TO STRUCTURAL DOCUMENTS FOR MASONRY WALL BRACING DETAILS. PROVIDE LINTELS AS SHOWN IN STRUCTURAL DRAWINGS
- ON NON-LOAD BEARING WALL LINTEL SCHEDULE AT ALL NON-BEARING WALL OPENINGS, INCLUDING DUCT ALL PIPING, CONDUITS AND RELATED MECHANICAL AND ELECTRICAL ITEMS SHALL BE CONCEALED WITHIN

GYPSUM BOARD FURRING AS REQUIRED IN FINISHED

AREAS WHETHER SHOWN ON DRAWINGS OR NOT, UNLESS NOTED OTHERWISE. PROVIDE BULLNOSE CORNERS AT VERTICAL CORNERS UNLESS OTHERWISE INDICATED. PROVIDE SQUARE EDGE CMU AT VERTICAL CORNERS WHERE CMU IS SCHEDULED

#### **KEYNOTE LEGEND**

- 1 KEYLESS ACCESS POINT, REFER TO ELECTRICAL
- DOCUMENTS. 2 CAR ACTIVATED MOTION SENSOR ABOVE OVERHEAD
- DOOR, REFER TO ELECTRICAL DOCUMENTS. 3 KEYLESS ACCESS POINT MOUNTED ON BOLLARD, REFER
- TO ELECTRICAL DOCUMENTS. 4 TRENCH DRAIN SHOWN FOR REFERENCE ONLY, REFER TO MECHANICAL DOCUMENTS.
- 5 ALTERNATE BID CONCRETE CURB AT WASH BAY WALLS 7 ELECTRICAL EQUIPMENT, REFER TO ELECTRICAL
- DOCUMENTS. 8 MECHANICAL EQUIPMENT, REFER TO MECHANICAL
- DOCUMENTS. 9 ROOF ACCESS LADDER.

TO RECEIVE CERAMIC TILE.



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LA CROSSE **REGIONAL AIRPORT** 

**CAR RENTAL FACILITY** 

LA CROSSE

WISCONSIN

	REVISION SCHEDULE							
DATE	DESCRIPTION	BY						
•	·							


PROJECT NO.	19065
FILE NAME	19065 Arch R-17.rvt
DRAWN BY	RRW
DESIGNED BY	KMB
REVIEWED BY	KMB
ORIGINAL ISSUE DATE	03/31/2017
CLIENT PROJECT NO.	

TITLE

**FLOOR PLAN** 

 $\bigcirc$  N

**A1-21** 

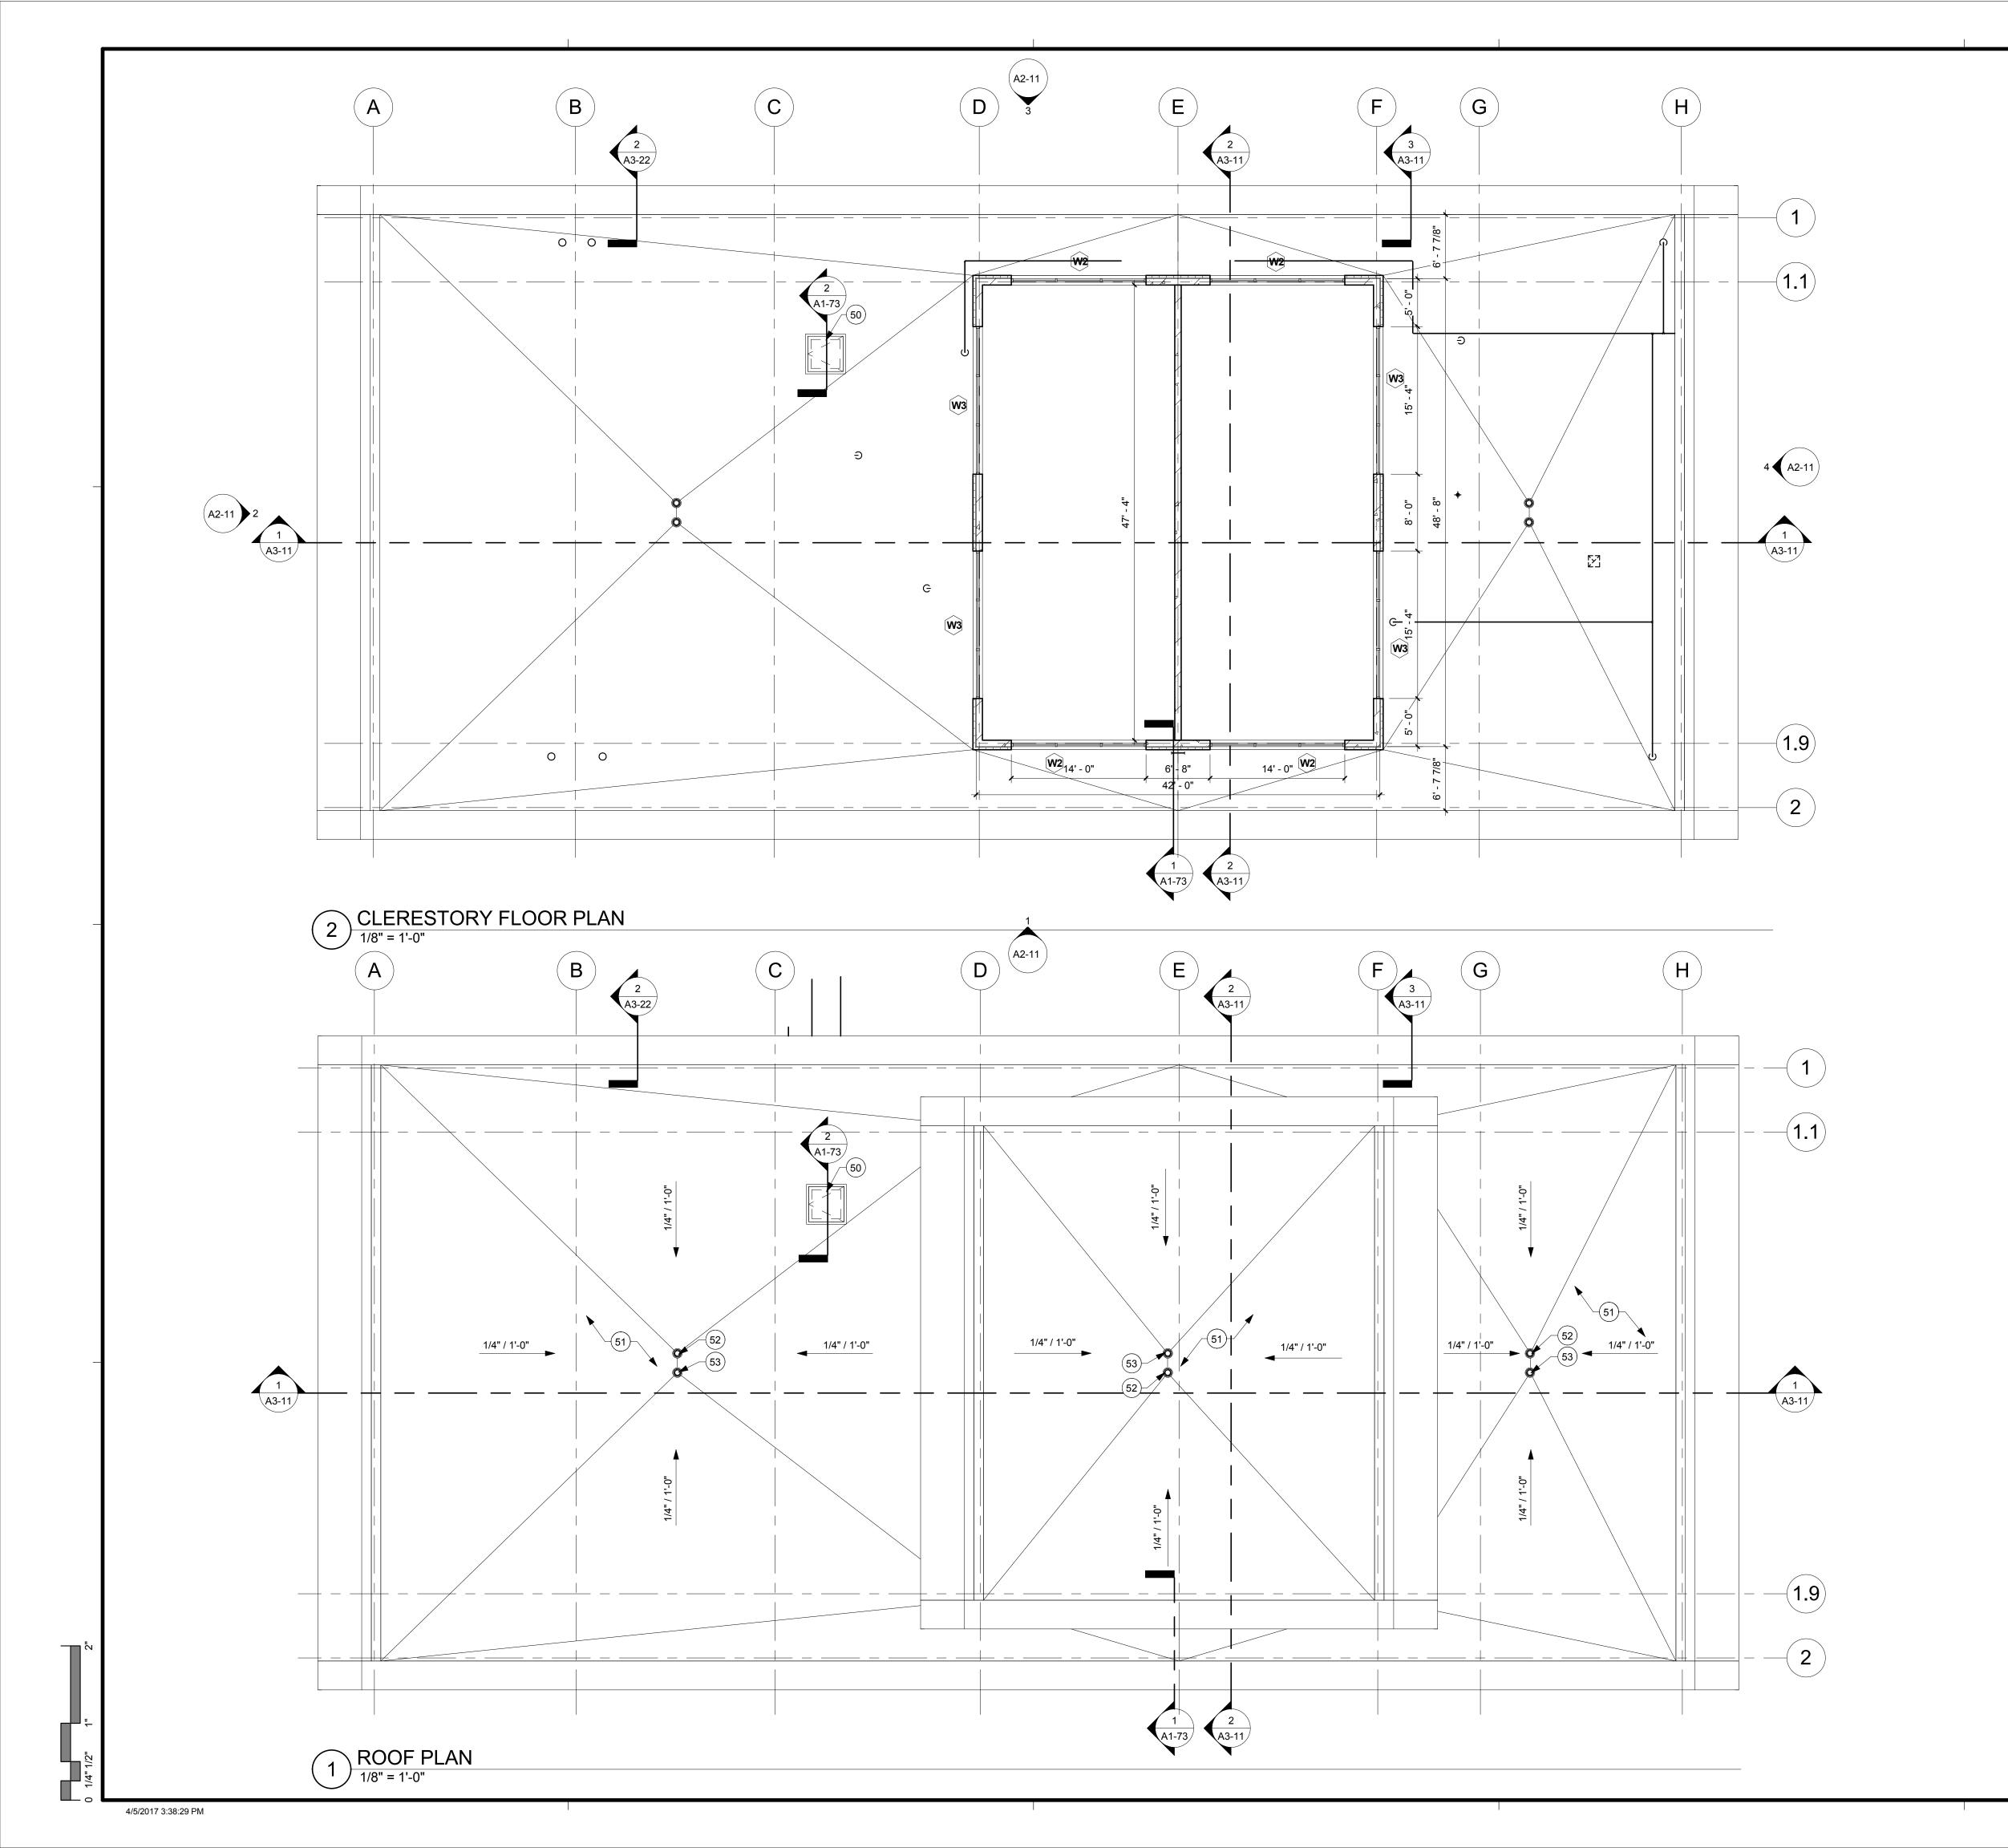

- ALL INTERIOR PARTITION WALLS SHALL BE WALL TYPE M8,
- UNLESS OTHERWISE NOTED.
   DIMENSIONS ARE FROM FACE OF MASONRY/ CONCRETE AND FACE OF GYPSUM BD. TO FACE OF GYPSUM BD. FOR STUD WALL, UNLESS NOTED OTHERWISE.
- REFER TO G1-21 FOR RATED WALL LOCATIONS.
   REFER TO STRUCTURAL DOCUMENTS FOR MASONRY

WALL BRACING DETAILS.

- PROVIDE LINTELS AS SHOWN IN STRUCTURAL DRAWINGS ON NON-LOAD BEARING WALL LINTEL SCHEDULE AT ALL NON-BEARING WALL OPENINGS, INCLUDING DUCT
- OPENINGS.

  ALL PIPING, CONDUITS AND RELATED MECHANICAL AND ELECTRICAL ITEMS SHALL BE CONCEALED WITHIN GYPSUM BOARD FURRING AS REQUIRED IN FINISHED.
- GYPSUM BOARD FURRING AS REQUIRED IN FINISHED AREAS WHETHER SHOWN ON DRAWINGS OR NOT, UNLESS NOTED OTHERWISE.

   PROVIDE BULLNOSE CORNERS AT VERTICAL CORNERS
- UNLESS OTHERWISE INDICATED. PROVIDE SQUARE EDGE CMU AT VERTICAL CORNERS WHERE CMU IS SCHEDULED TO RECEIVE CERAMIC TILE.
  FIELD VERIFY EXACT QUANTITY, SIZE AND LOCATIONS OF
- ROOF HOODS, VENTS, DRAINS, EQUIMENT, ETC.

   ALL VENT-THRU PIPES SHALL BE EXTENDED, AS NECESSARY, TO PROTECT MINIMUM OF 12" ABOVE FINISHED ELEVATION OF ROOFING. FLASH ALL VENTS WITH PREMOLDED PIPE BOOTS WITH STAINLESS STEEL CLAMPING RING. ANY THAT EXTEND ABOVE THE PARAPET
- PAINTED, UNLESS NOTED OTHERWISE.

   ALL ROOF TOP CURBS TO BE SADDLES WITH MINIMUM 1/2" PER FOOT PITCH.

HEIGHT AND ARE VISIBLE FROM GROUND LEVEL SHALL BE

#### **KEYNOTE LEGEND**

- 50 ROOF ACCESS HATCH
- 51 FULLY ADHERED ROOFING MEMBRANE OVEROVER TAPERED INSULATION (5" INSULATION AVERAGE).
- 52 ROOF DRAIN, REFER TO ROOF DETAILS AND PLUMBING DOCUMENTS.
- 53 OVERFLOW ROOF DRAIN, REFER TO ROOF DETAILS AND PLUMBING DOCUMENTS.

ISG

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PROJECT

LA CROSSE REGIONAL AIRPORT

CAR RENTAL FACILITY

A CROSSE

WISCONSIN

	REVISION SCHEDULE						
DATE	DATE DESCRIPTION						

PROJECT NO.	19065
FILE NAME	19065 Arch R-17.rvt
DRAWN BY	RRW
DESIGNED BY	KMB
REVIEWED BY	KMB
ORIGINAL ISSUE DATE	03/31/2017
CLIENT PROJECT NO.	


TITLE


CLERESTORY AND ROOF PLAN


SHEET

A1-71



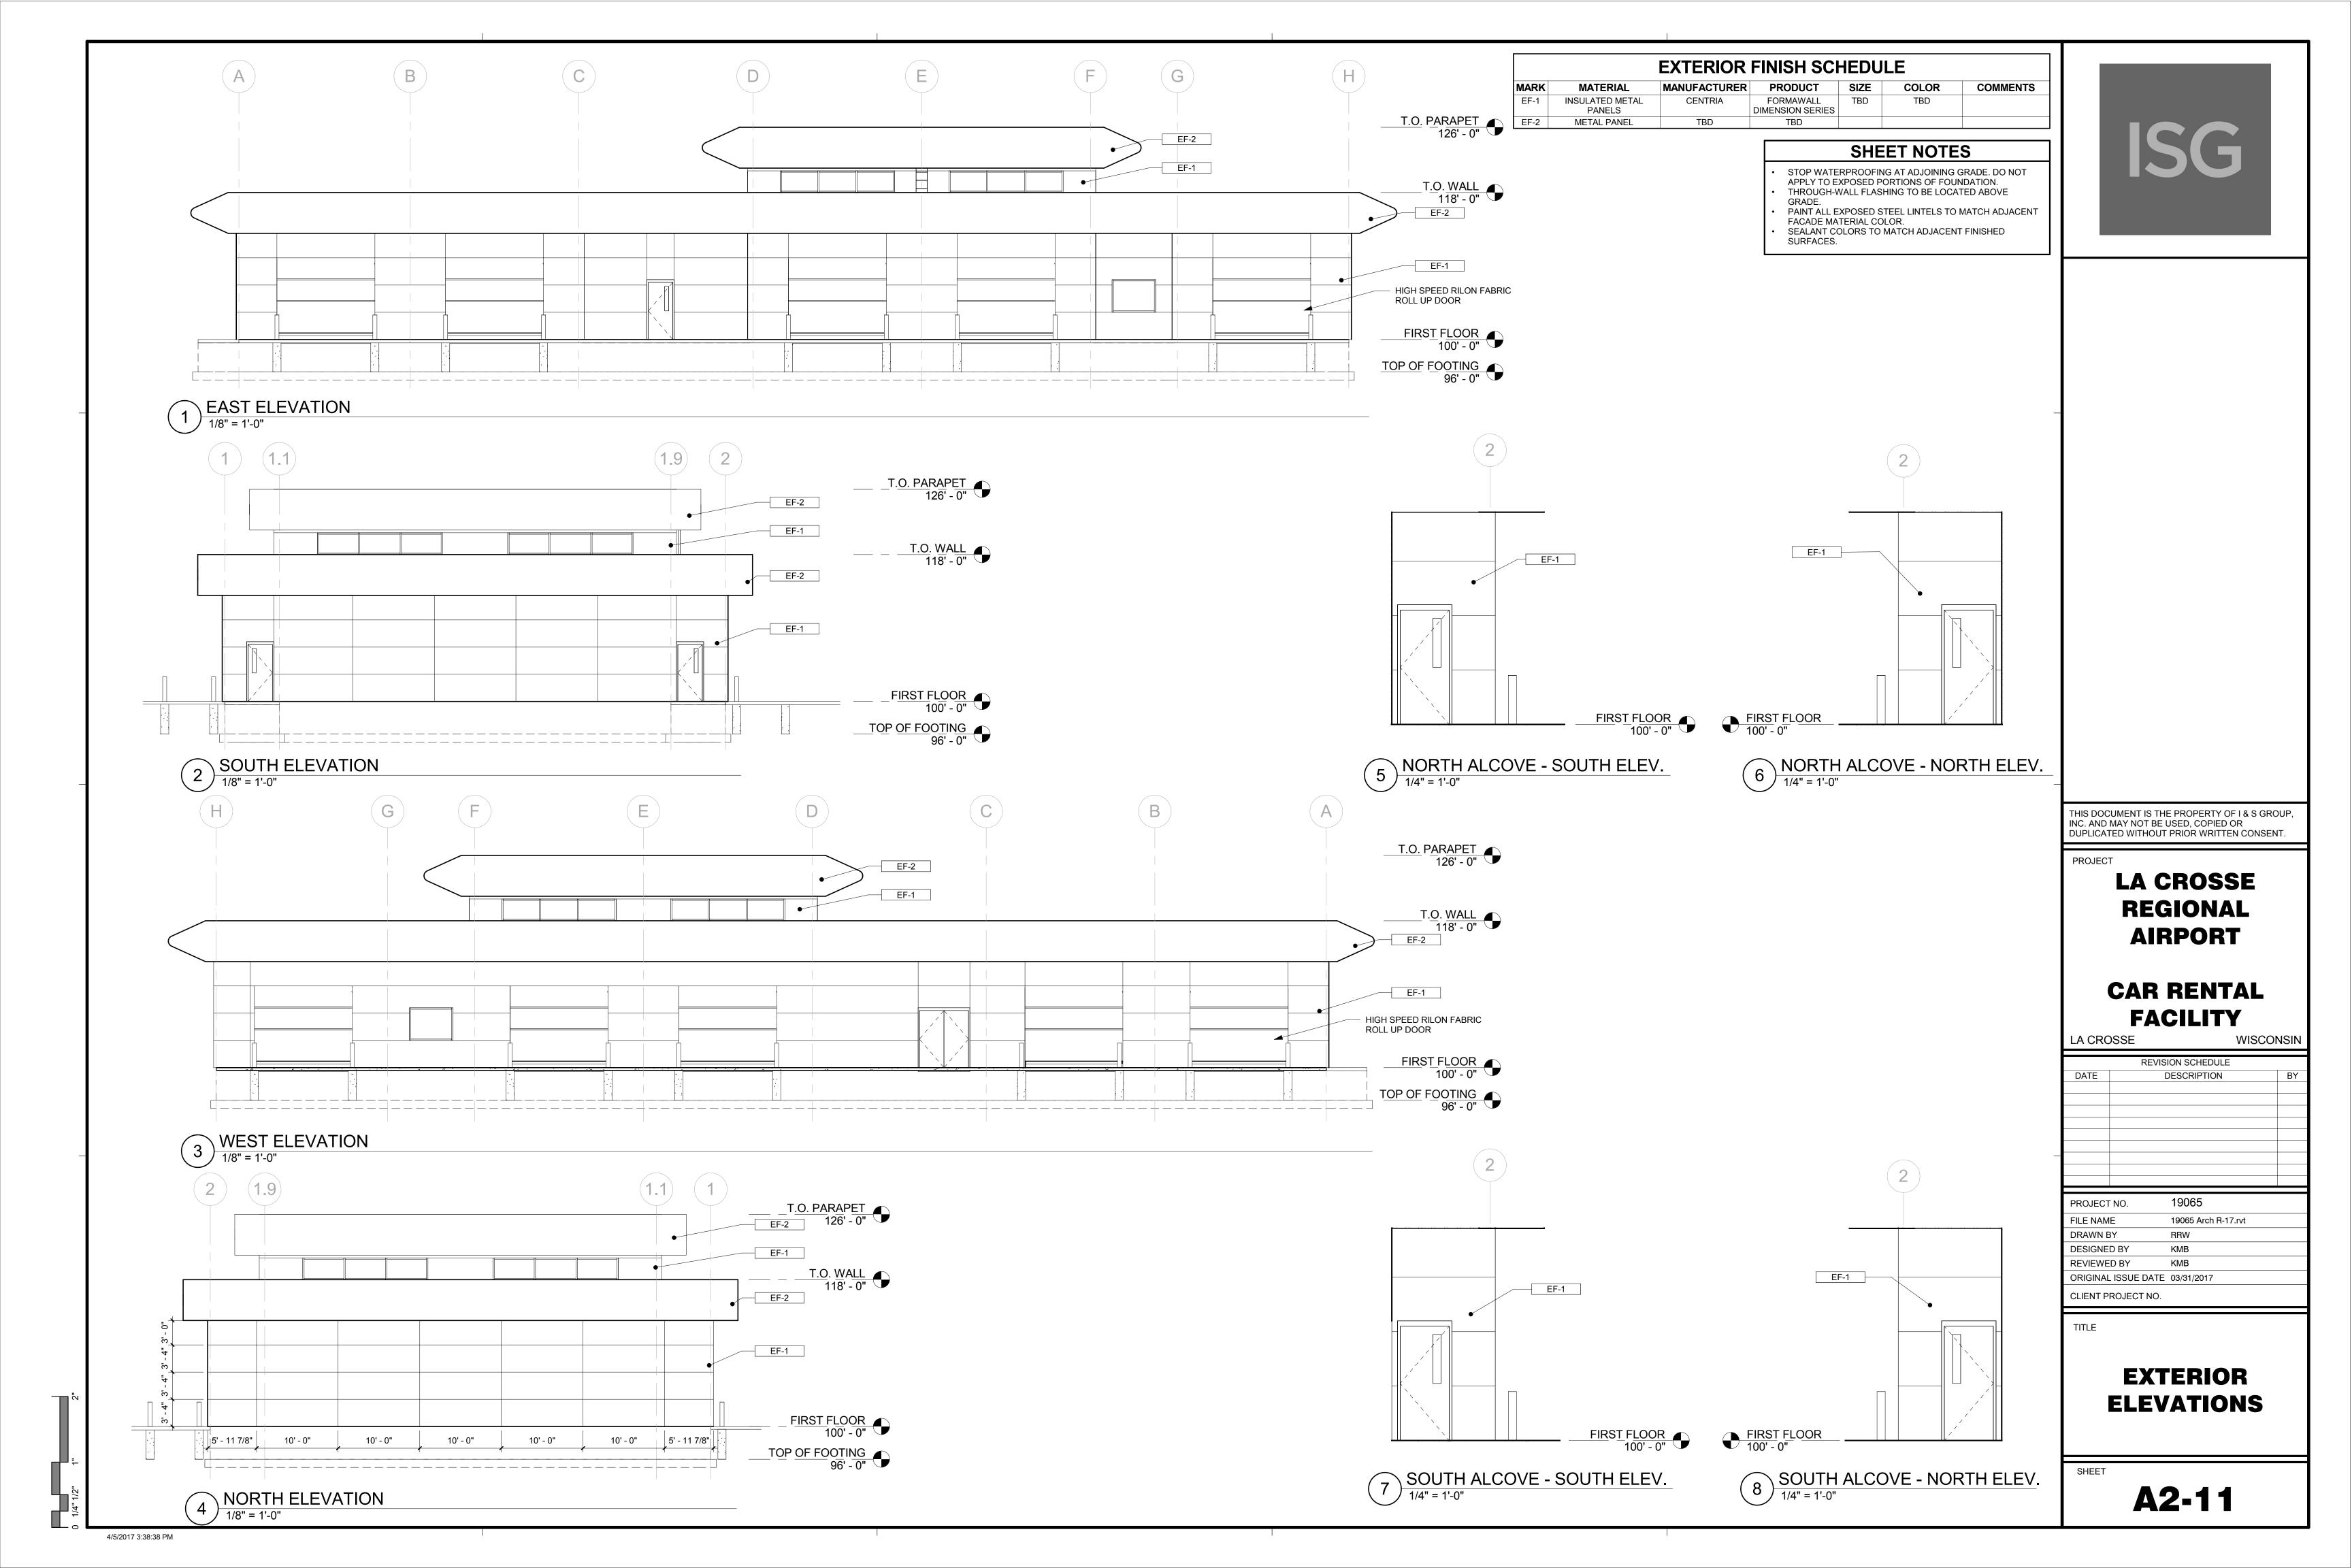

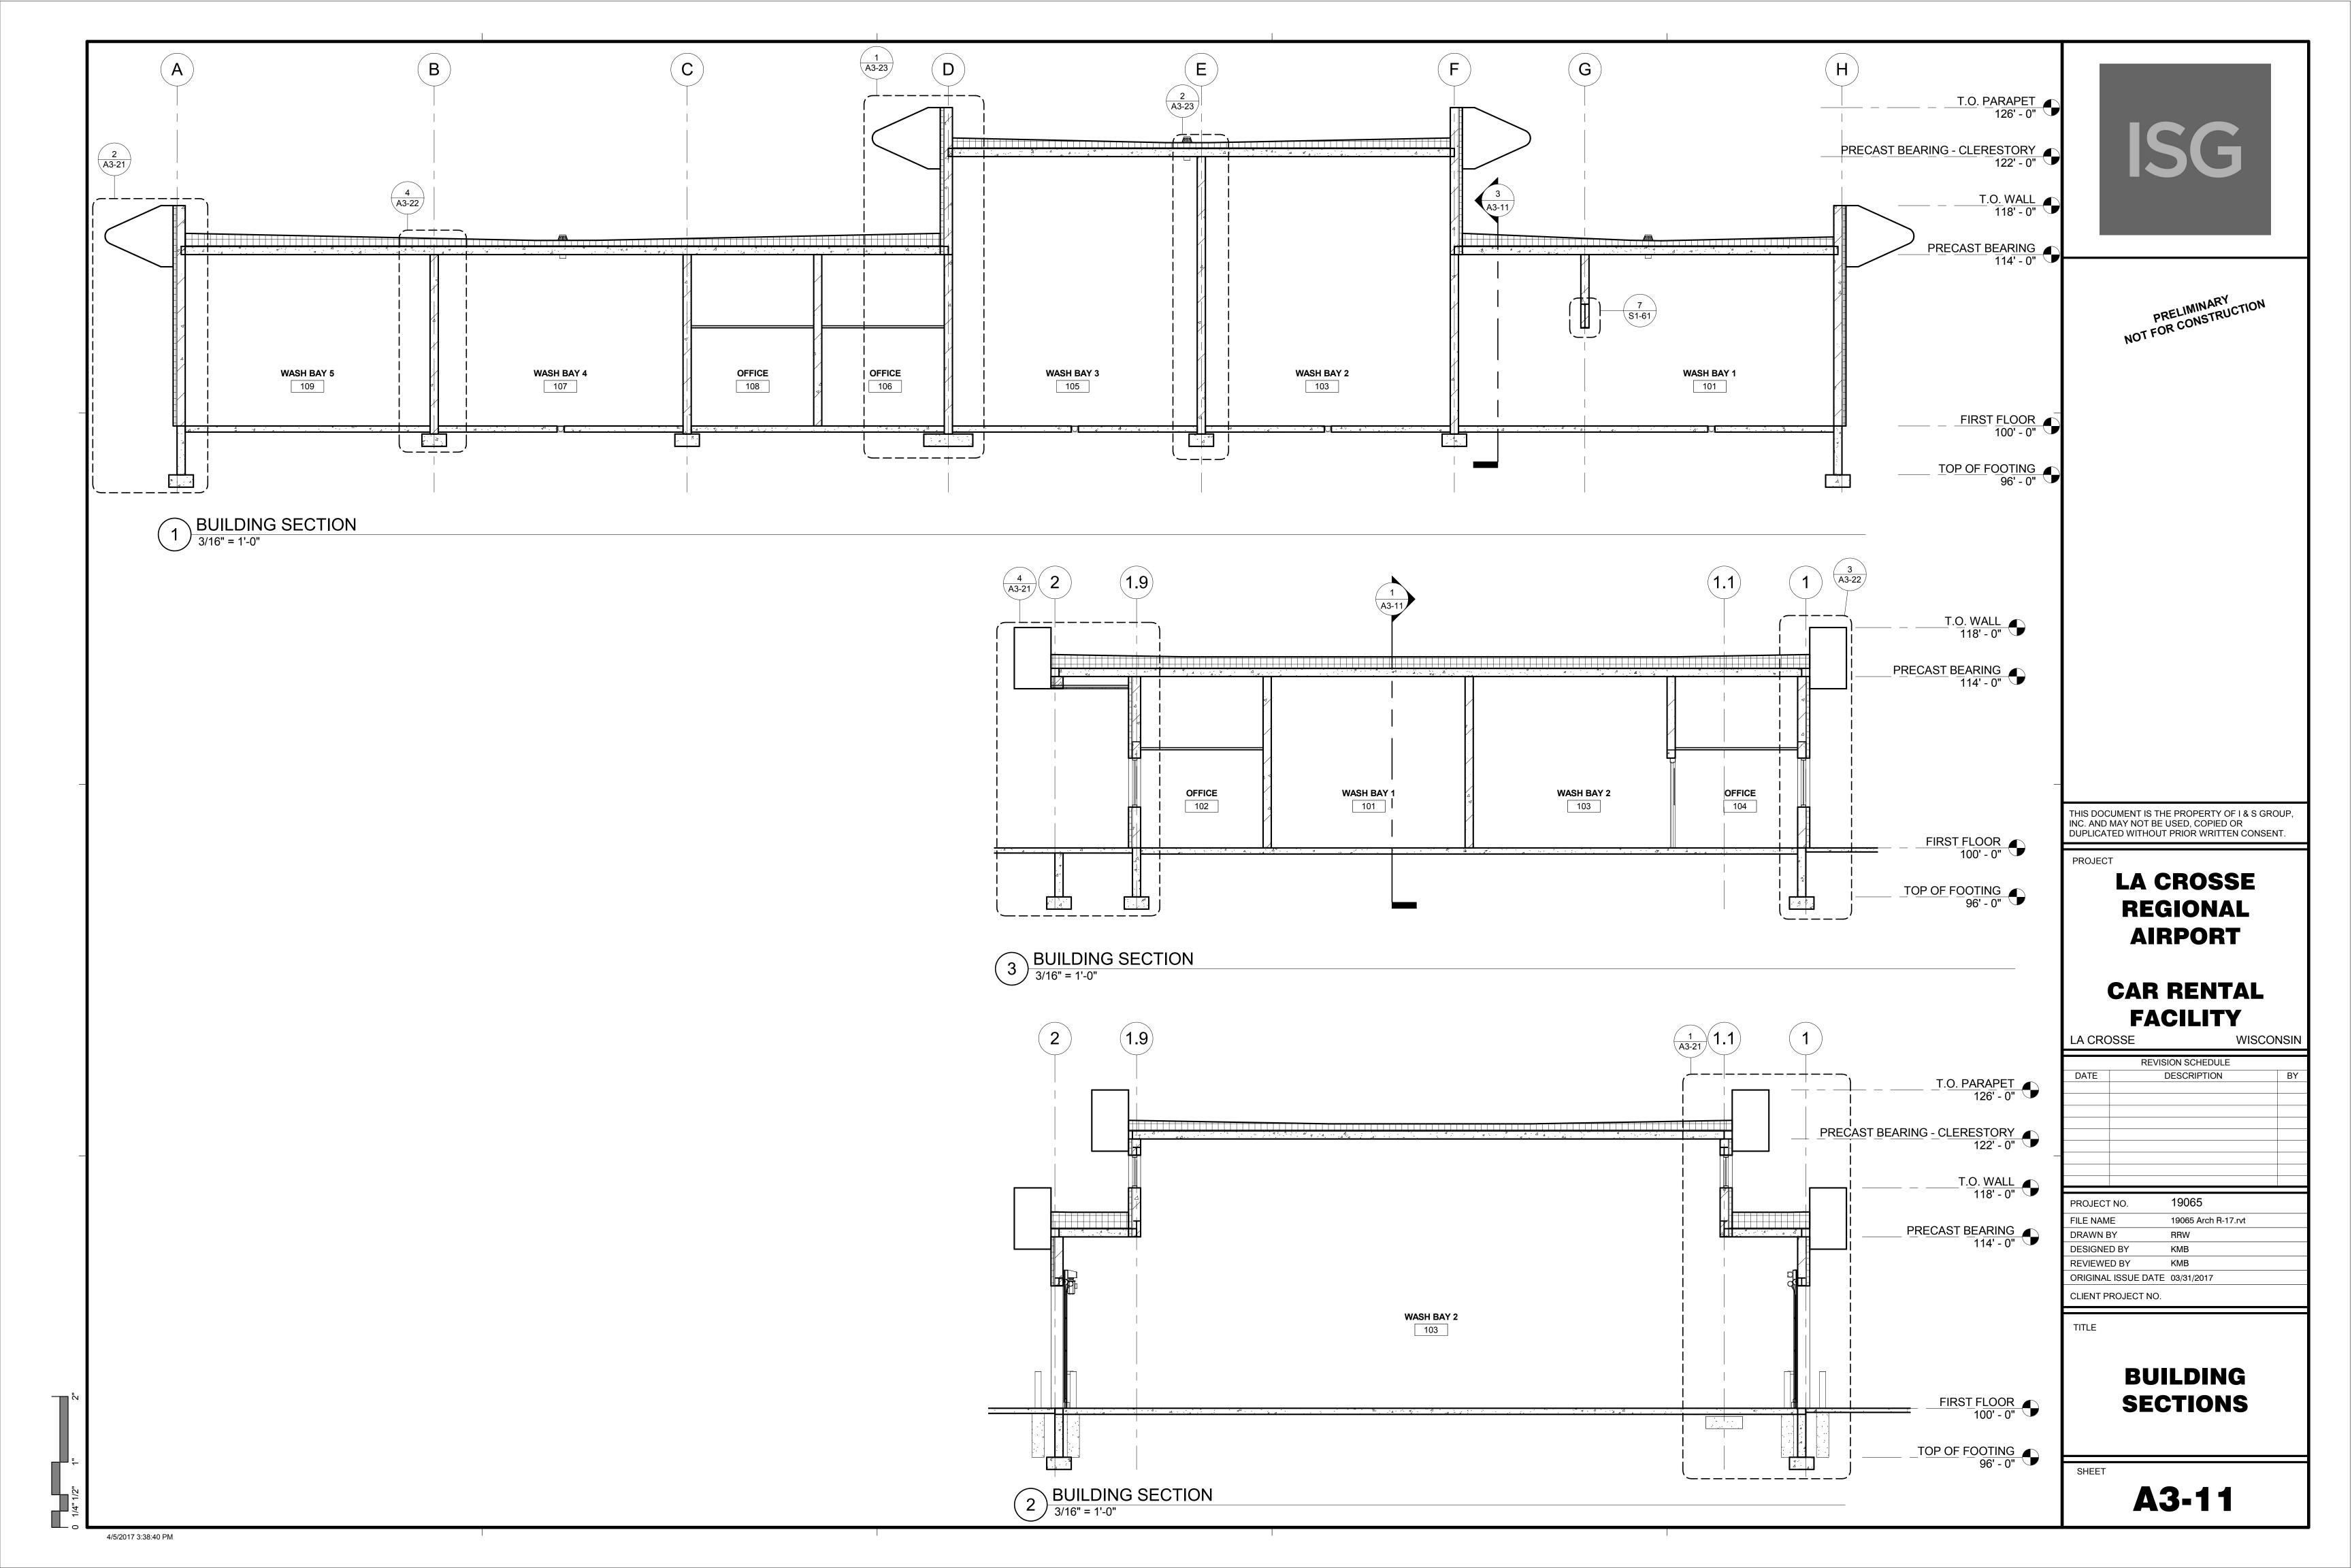

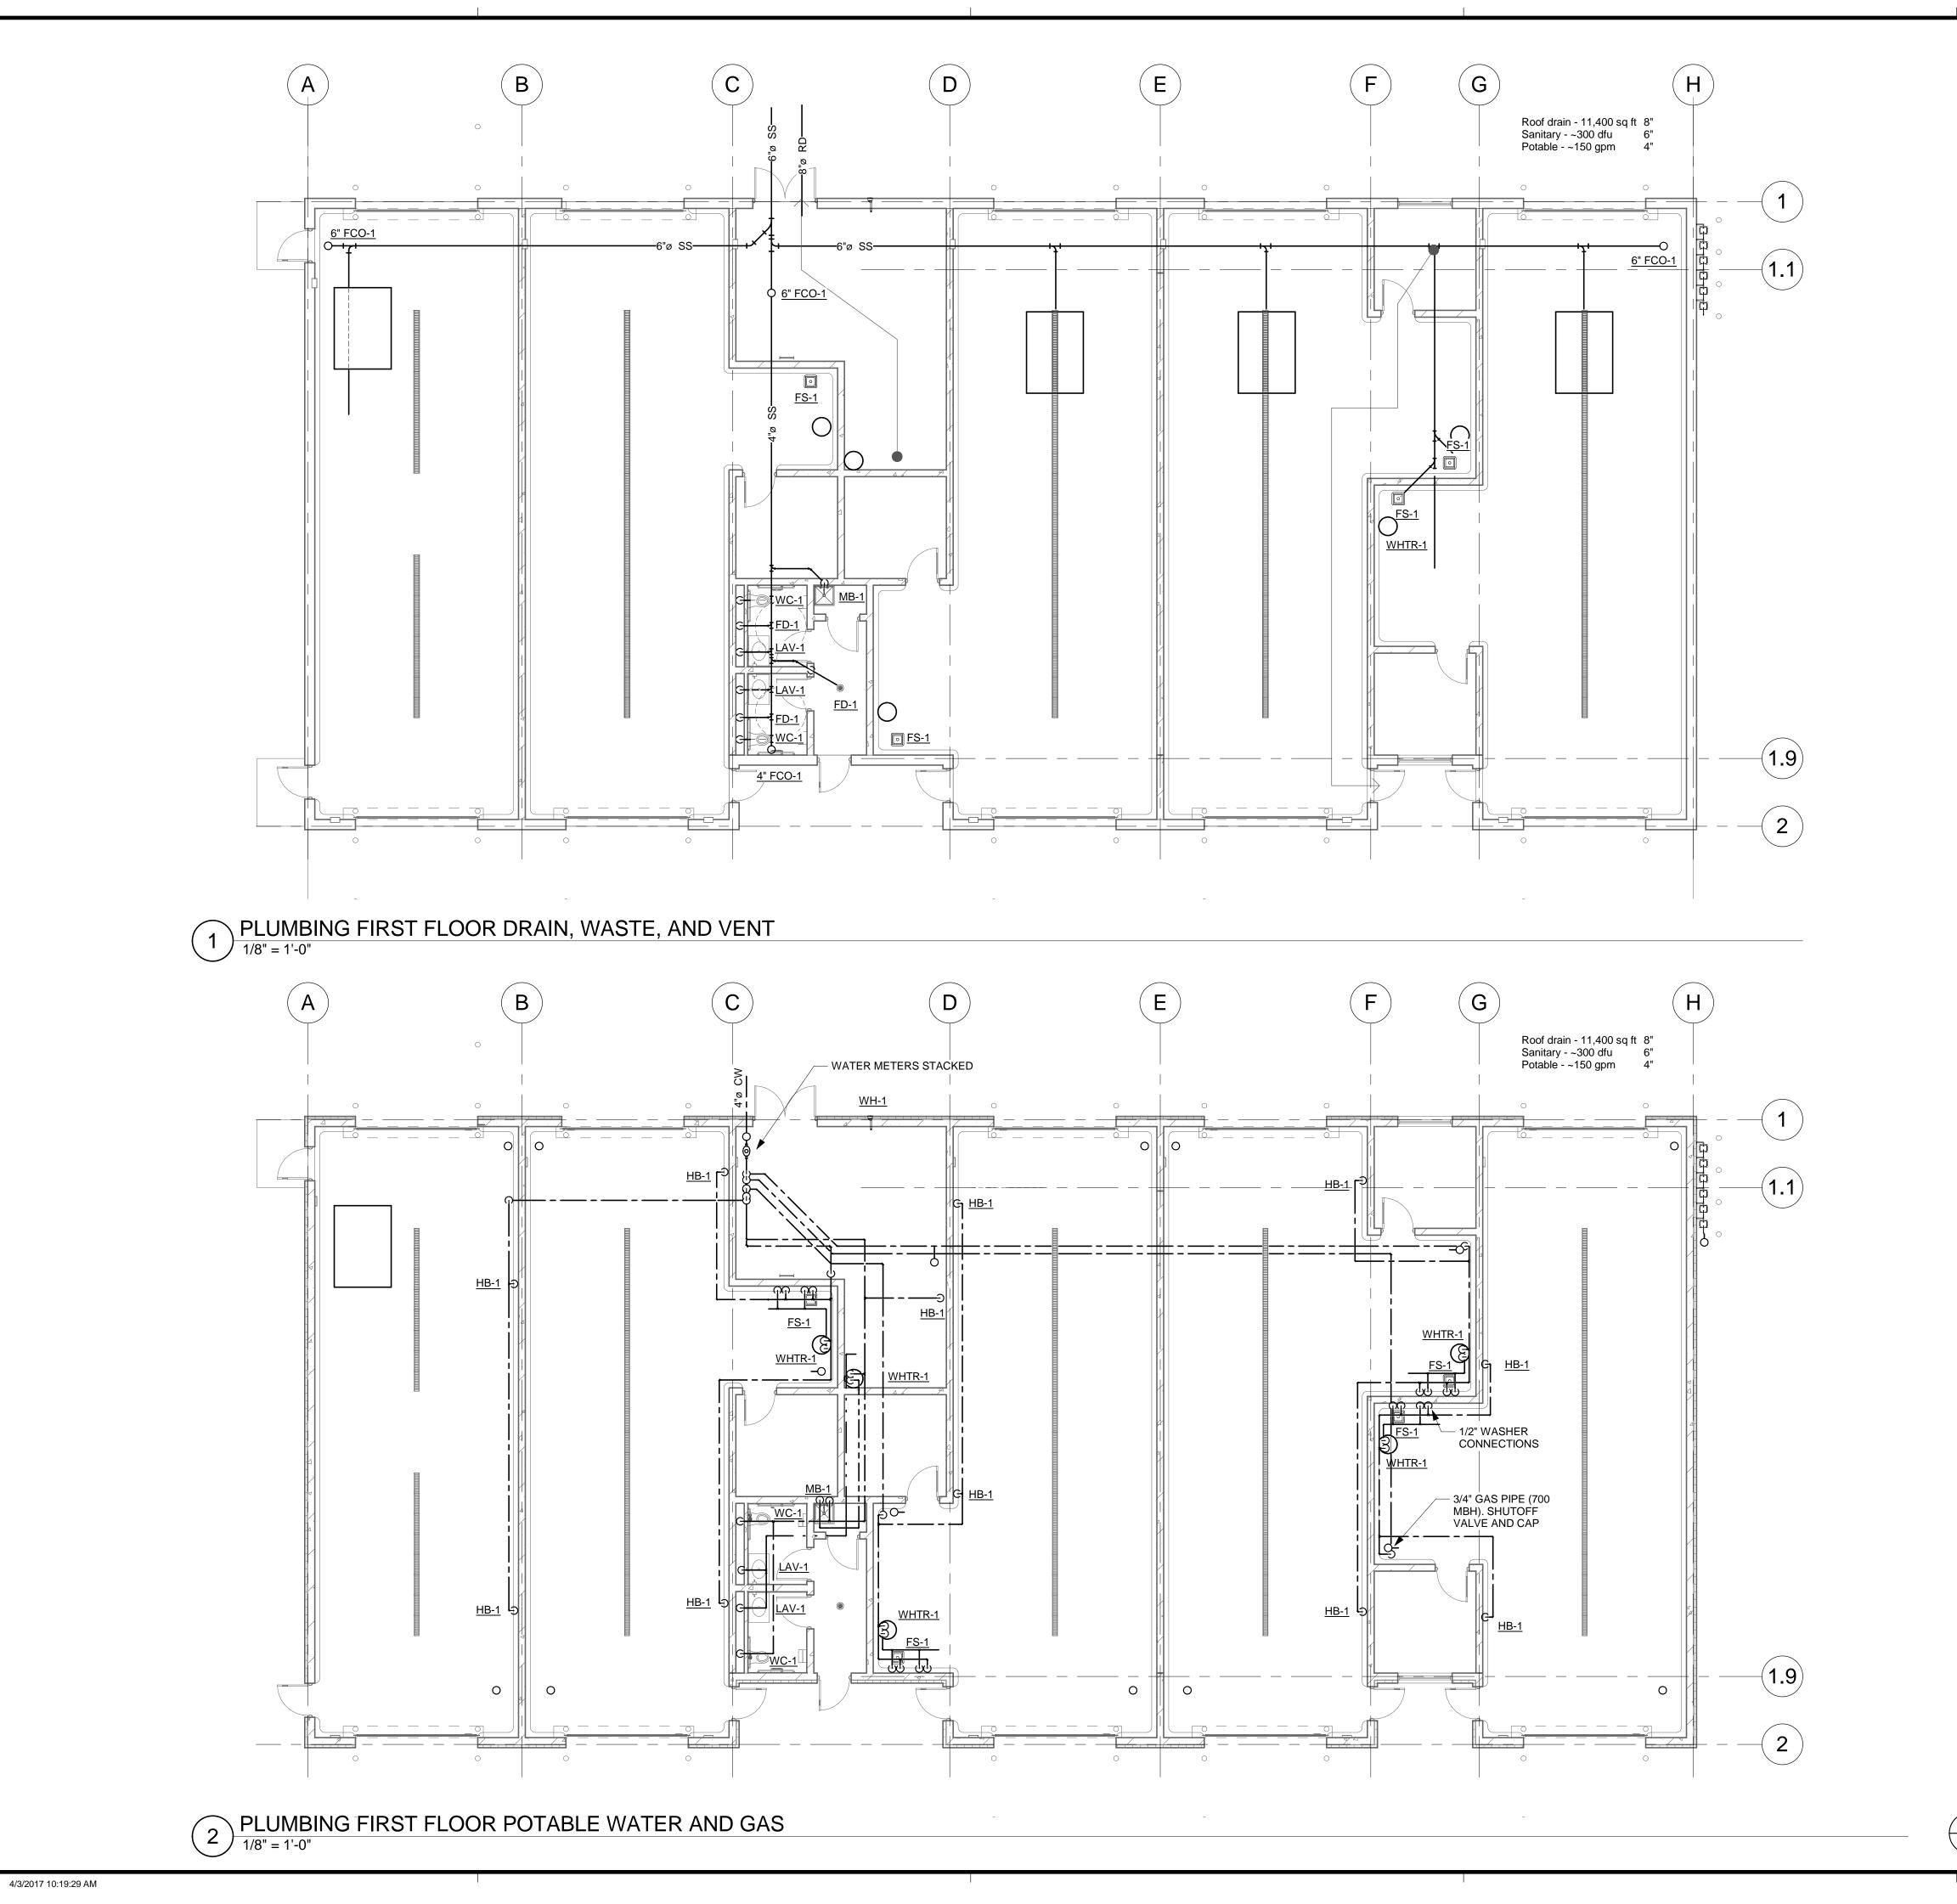

1. ALL DUCTWORK, PIPING, EQUIPMENT, ETC.
INDICATED ON PLANS ARE BASED ON INFORMATION
FROM CONSTRUCTION DOCUMENTS AND FIELD
VERIFICATION OF THE EXISTING BUILDING. FIELD VERIFY
ALL EXISTING CONDITIONS.

**KEYNOTE LEGEND** 



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PROJECT

LA CROSSE **REGIONAL AIRPORT CAR RENTAL FACILITY** 

LA CRC	)55E	WISCOI	NOIN
	REVISION SCHEDULE		
DATE	DESCRIPTION		BY
•		•	
DDO IECT	NO 17-19065		

PROJECT NO. 17-19065 FILE NAME 19065 MECH R17 DRAWN BY JAB **DESIGNED BY** JAB REVIEWED BY AJE ORIGINAL ISSUE DATE 03/31/2017 CLIENT PROJECT NO.

TITLE

**PLUMBING NEW WORK** 

SHEET


M1-21

1. ALL DUCTWORK, PIPING, EQUIPMENT, ETC.
INDICATED ON PLANS ARE BASED ON INFORMATION
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ALL EXISTING CONDITIONS.

#### **KEYNOTE LEGEND**





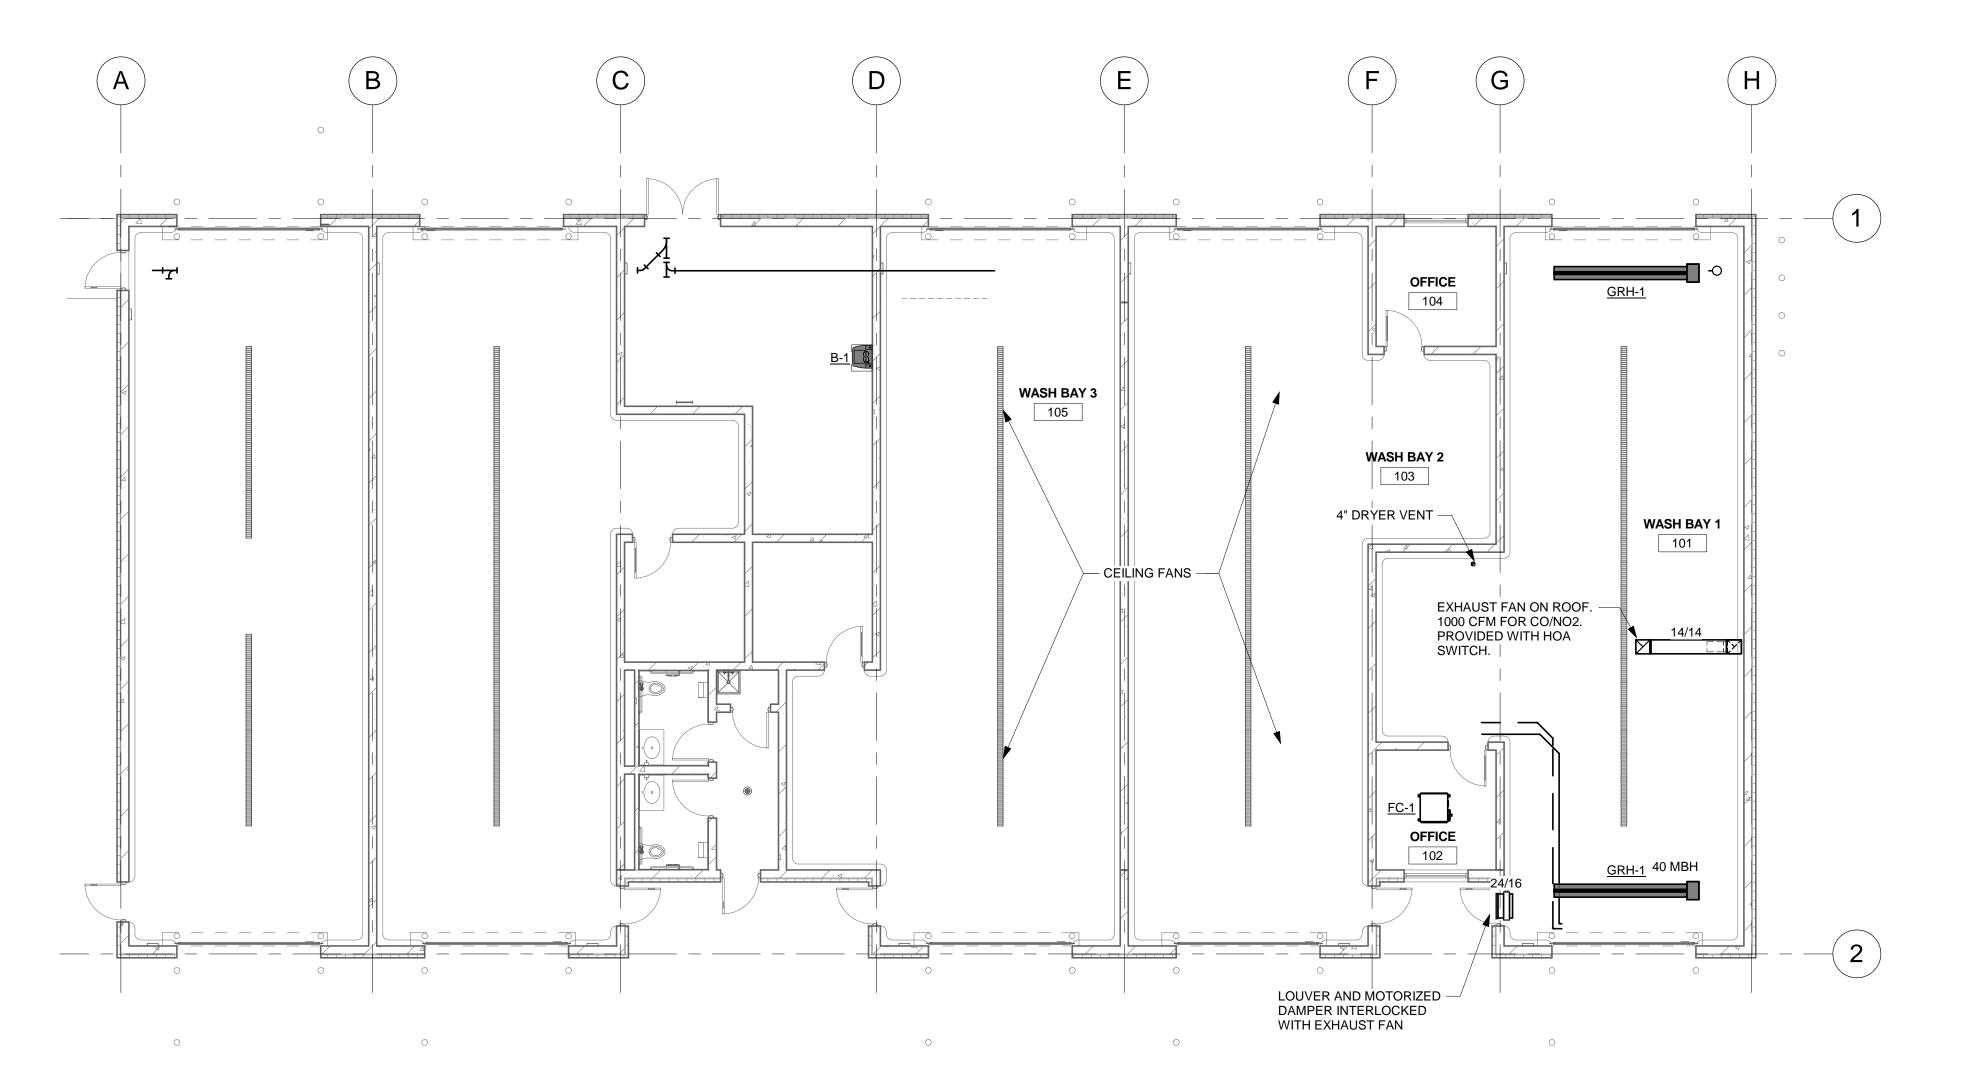

1 HVAC FIRST FLOOR
1/8" = 1'-0"

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PROJECT

LA CROSSE REGIONAL AIRPORT CAR RENTAL FACILITY

LA CROSSE

WISCONSIN

L			
		REVISION SCHEDULE	
-			
	DATE	DESCRIPTION	BY
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PROJECT NO.	17-19065
FILE NAME	19065 MECH R17
DRAWN BY	JAB
DESIGNED BY	JAB
REVIEWED BY	AJE
ORIGINAL ISSUE DATE	03/31/2017
CLIENT PROJECT NO.	

TIT

**HVAC NEW WORK** 

SHEET


**M2-21** 

1. ALL DUCTWORK, PIPING, EQUIPMENT, ETC.
INDICATED ON PLANS ARE BASED ON INFORMATION
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ALL EXISTING CONDITIONS.

#### **KEYNOTE LEGEND**





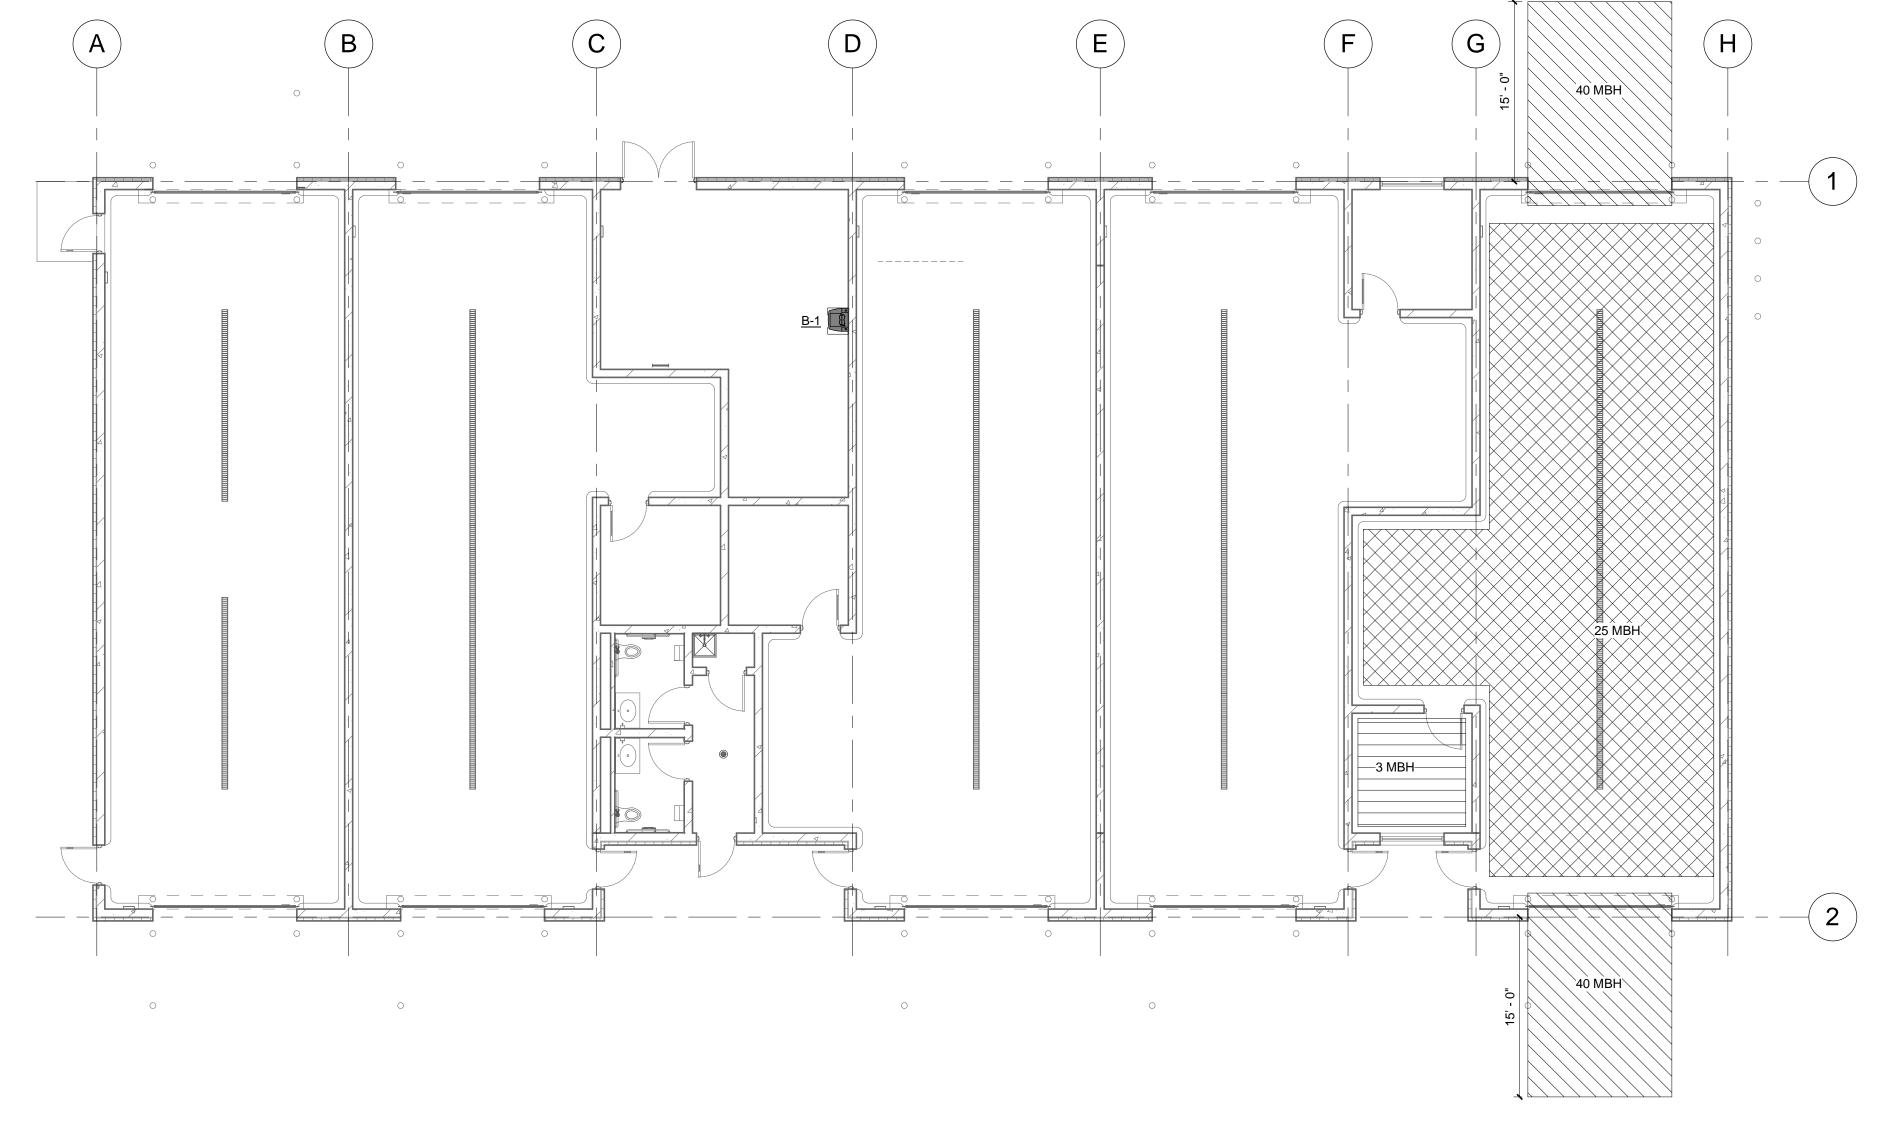

3.01 First Floor Hydronic

1/8" = 1'-0"

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PROJE

LA CROSSE REGIONAL AIRPORT CAR RENTAL FACILITY

LA CROSSE

WISCONSIN

	REVISION SCHEDULE	
DATE	DESCRIPTION	BY

PROJECT NO.	17-19065
FILE NAME	19065 MECH R17
DRAWN BY	JAB
DESIGNED BY	JAB
REVIEWED BY	AJE
ORIGINAL ISSUE DATE	03/31/2017
CLIENT PROJECT NO.	

TITLE

HYDRONIC NEW WORK

SHEET

**M2-22** 

	PUMP SCHEDULE								
	ELECTRICAL								
MARK	MFG	MODEL#	SERVICE	CONN. SIZE	GPM	HEAD LOSS (IN FEET)	HP	VOLTAGE / PH.	RPM

NOTES:

1 INSTALL UNITS AS SHOWN AND AS PER MANUFACTURER'S INSTRUCTIONS

2 UNIT SHALL BE SUPPORTED BY NON-COMBUSTIBLE HANGERS AND BRACKETS.

- 2 VERIFY CONTROL AND POWER BEFORE COMMENCING WORK
- 3 PROVIDE SUPPORT FOR PUMPS AND ADJACENT PIPING. 4 PUMP TO BE SELECTED FOR LOW SPEED OPERATION.
- 5 PERFORMANCE BASED ON 50% PROPYLENE GLYCOL SOLUTION.

GAS-FIRED RADIANT HEATER										
	HEATING ELECTRICAL BU									
MARK	MFG	MODEL	LOCATION	SERVICE	GAS TYPE	INPUT	VOLTAGE / PH.	AMPS	LENGTH	
GRH-1	ROBERTS GORDON	VANTAGE HE-80	CARWASH	CARWASH	NATURAL	80	120/1	5	20 FT	
GRH-1	ROBERTS GORDON	VANTAGE HE-80	CARWASH	CARWASH	NATURAL	80	120/1	5	20 FT	
NOTES:										
1 PRC	1 PROVIDE WALL-MOUNTED DDC TEMPERATURE SENSOR									

						BOILI	ER SCHEI	DULE						
	HEATING							NG					BOILER	
MARK	MFG	MODEL#	LOCATION	INPUT	OUTPUT	EFF. (A.F.U.E.)	GAS TYPE	GAS SIZE	WEIGHT	VENT SIZE	COMB. AIR SIZE	VOLTAGE / PH.	SUPPLY PUMPS	NEUTRALIZATIO N TANK
B-1	Weil-McLain	SERIES 3 ULTRA-105	CARWASH	105	94	94	NATURAL	3/4"	181 lb	3	3	120/1	Yes	Yes

1 INSTALL UNIT AS SHOWN AND AS PER MANUFACTURER'S INSTRUCTIONS.

- 2 PROVIDE SEPARATED EXHAUST AND INTAKE VENTS THROUGH ROOF.
- 3 PROVIDE GAS PIPING TO BOILER CONSISTING OF SHUT-OFF VALVE, 4" DRIP LEG, REGULATOR, AND UNION.
- 4 PROVIDE PRESSURE AND TEMPERATURE GAUGES
- 5 PROVIDE WITH MAIN DISCONNECTAND SINGLE POINT CONNECTION TO BE INSTALLED & WIRED BY ELECTRICAL CONTRACTOR
- 6 PROVIDE WITH NEUTRALIZATION KIT.
- 7 PROVIDE WITH BOILER PUMP.

		E	LECTRIC	RADIANT	HEATER	SCHEDULE
MARK	MFG	MODEL	WATTS	BTU/HR	VOLTAGE / PH.	NOTES

#### **SHEET NOTES**

1. ALL DUCTWORK, PIPING, EQUIPMENT, ETC.
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ALL EXISTING SOURCE. ALL EXISTING CONDITIONS.

#### **KEYNOTE LEGEND**



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LA CROSSE **REGIONAL AIRPORT CAR RENTAL FACILITY** 

LA CROSSE

WISCONSIN


	REVISION SCHEDULE	
DATE	DESCRIPTION	BY


PROJECT NO.	17-19065
FILE NAME	19065 MECH R17
DRAWN BY	JAB
DESIGNED BY	JAB
REVIEWED BY	AJE
ORIGINAL ISSUE DATE	03/31/2017
CLIENT PROJECT NO.	

TITLE

**MECHANICAL SCHEDULES** 

**M2-51** 

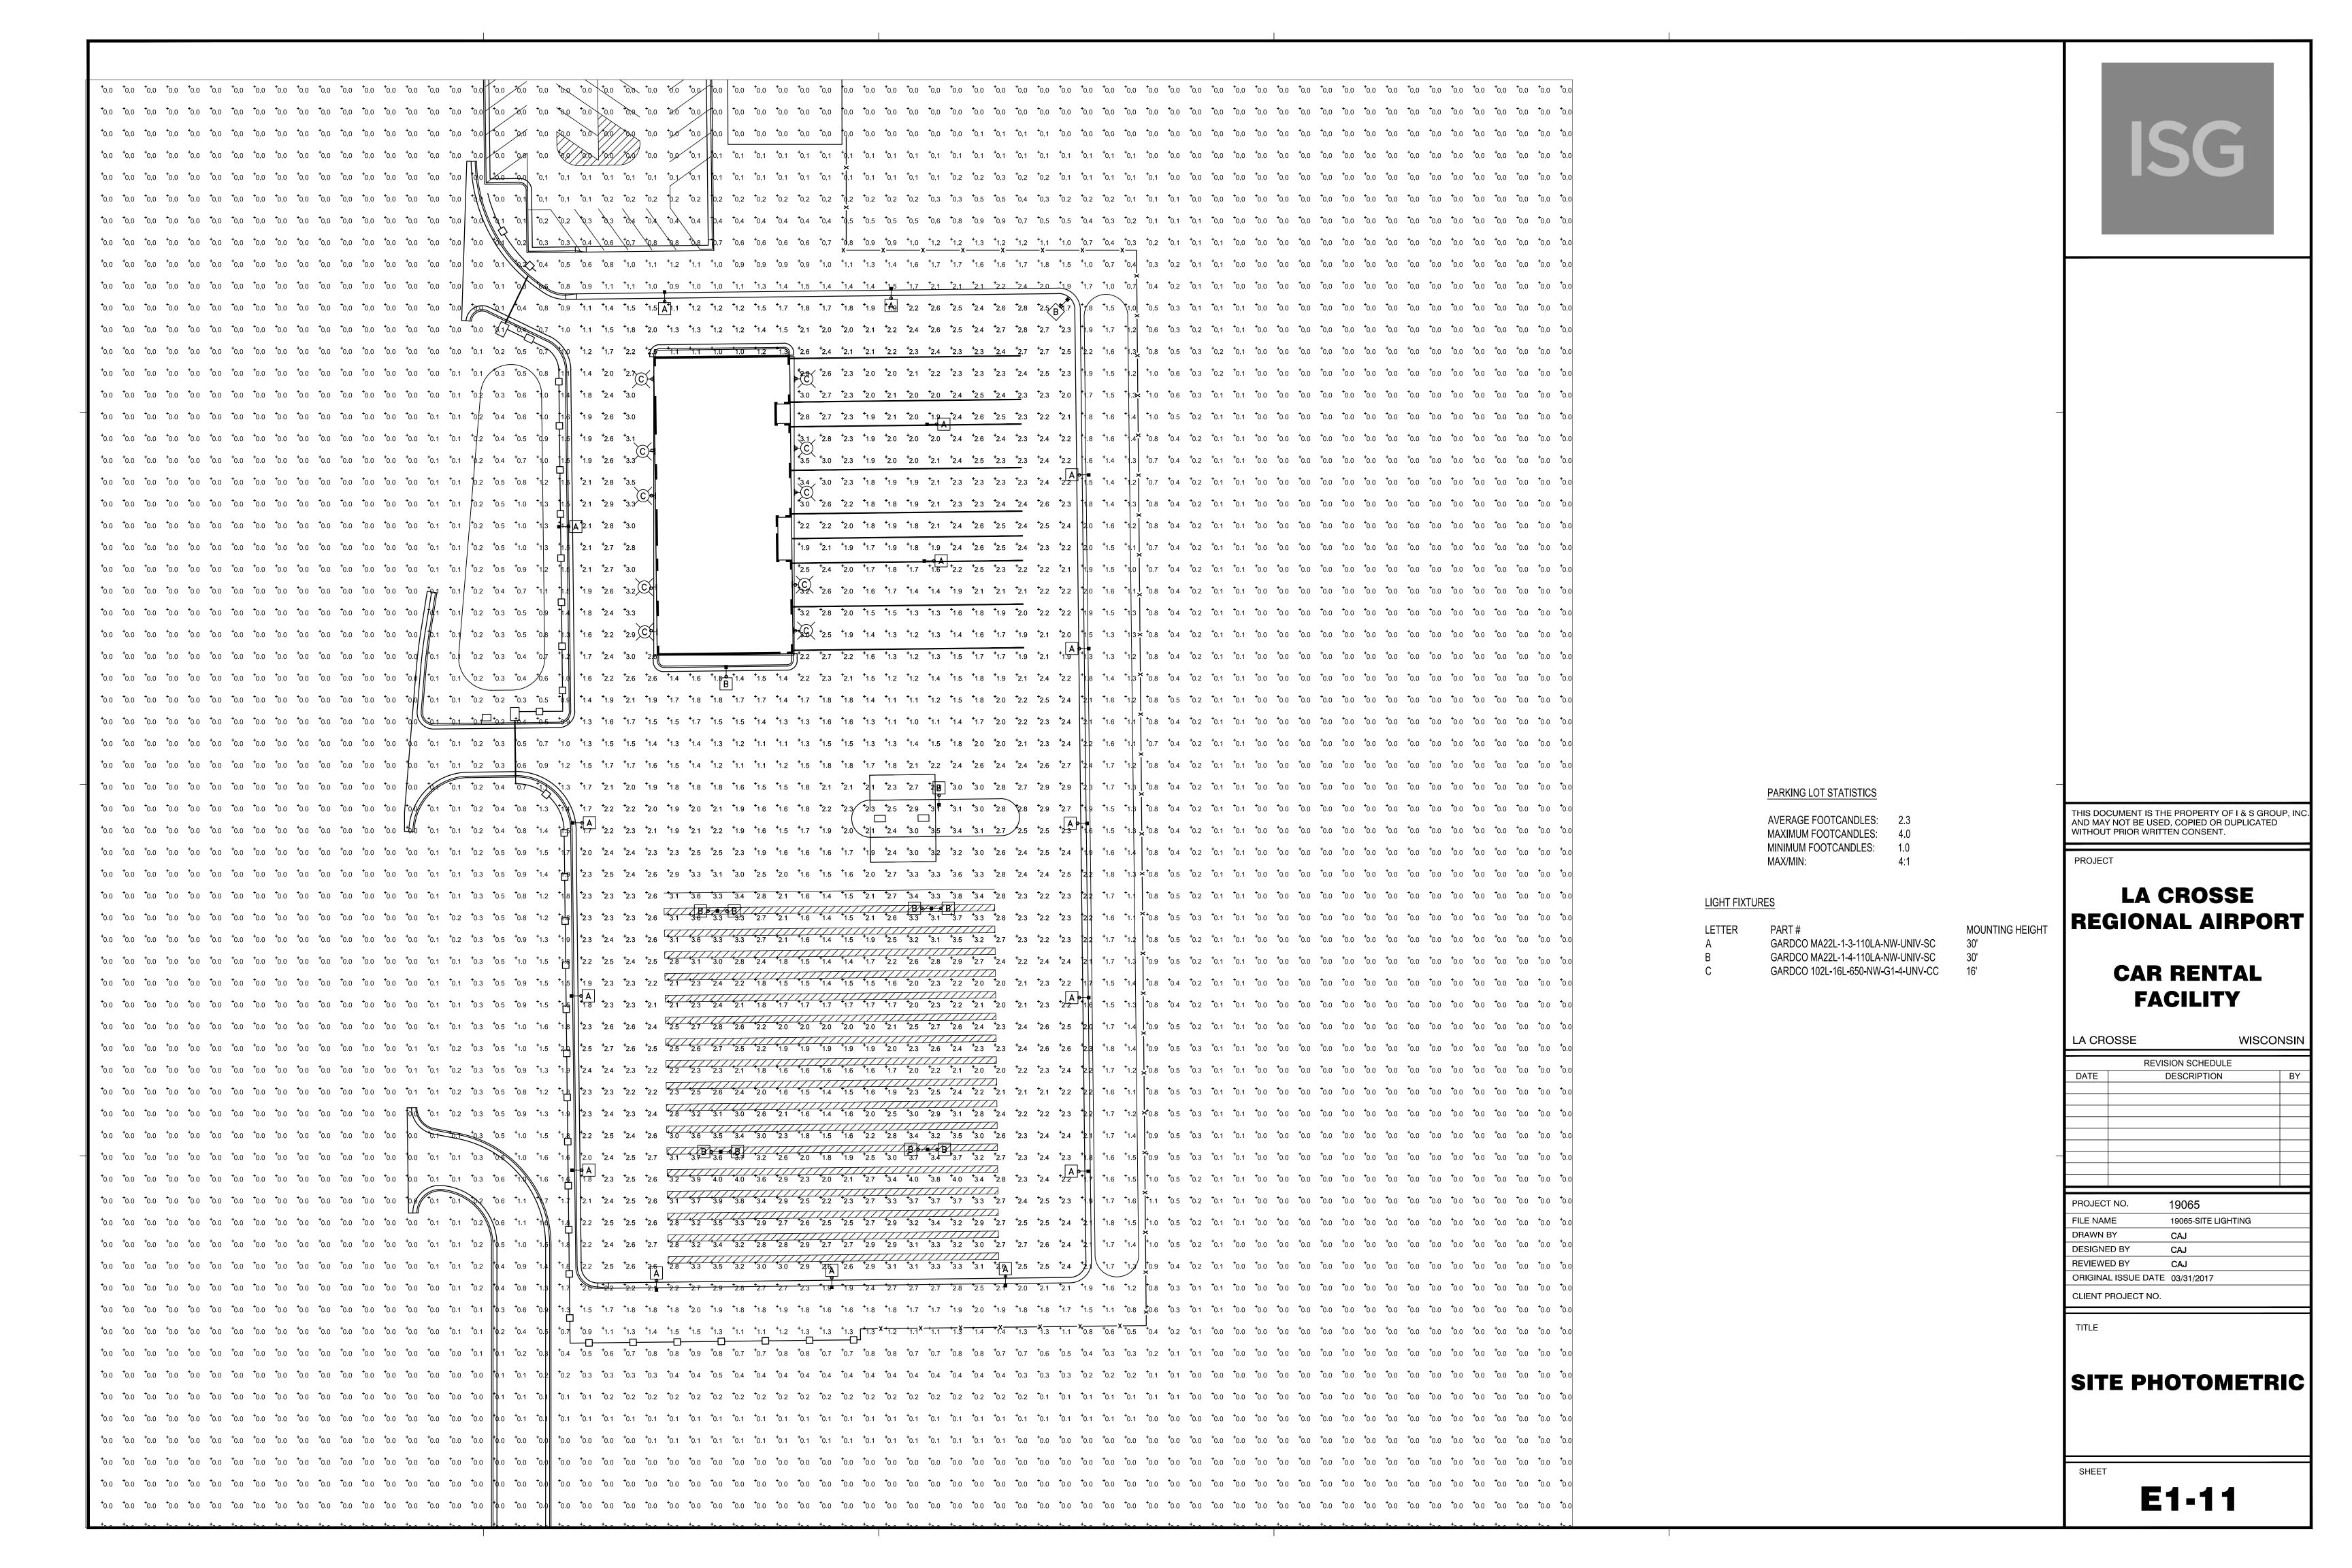

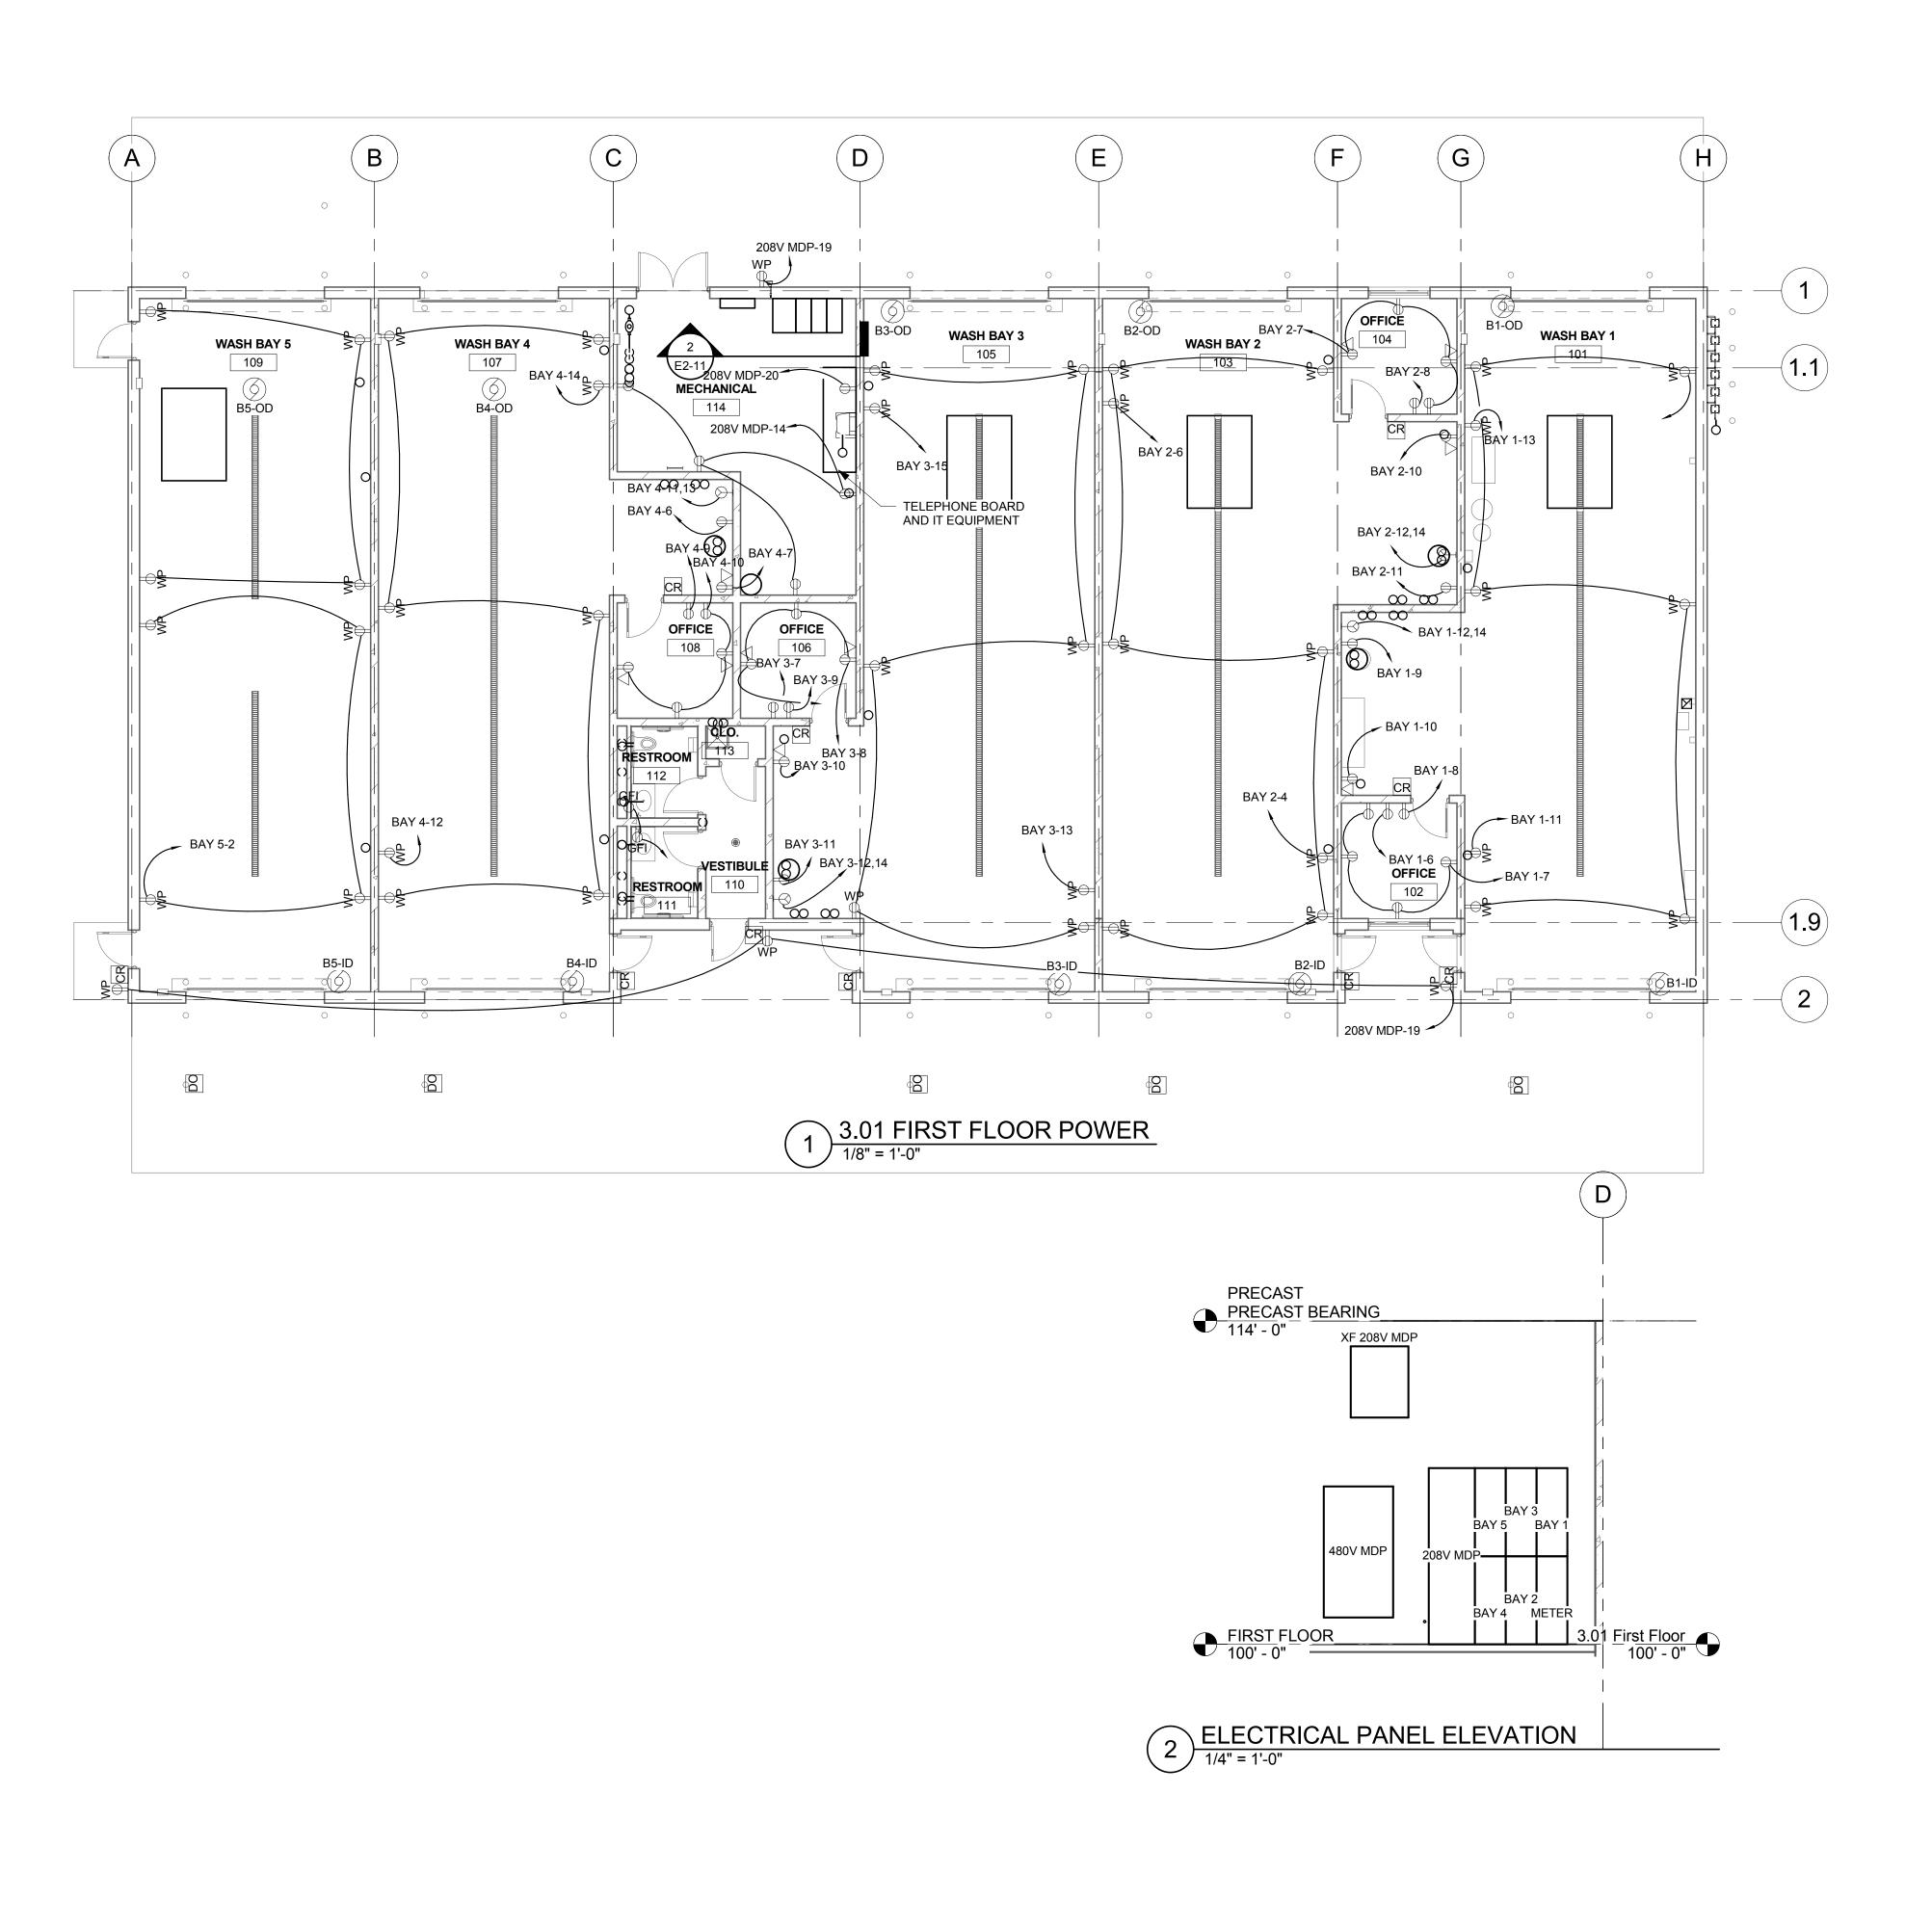





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PROJECT

LA CROSSE REGIONAL AIRPORT

# CAR RENTAL FACILITY

REVISION SCHEDULE

DATE DESCRIPTION BY
02/17/17 Design Development


PROJECT NO.	16-19065
FILE NAME	
DRAWN BY	CAJ
DESIGNED BY	CAJ
REVIEWED BY	CAJ
ORIGINAL ISSUE DATE	03/31/2017
CLIENT PROJECT NO.	

TITI

FIRST FLOOR POWER PLAN

SHEET

**E2-11** 

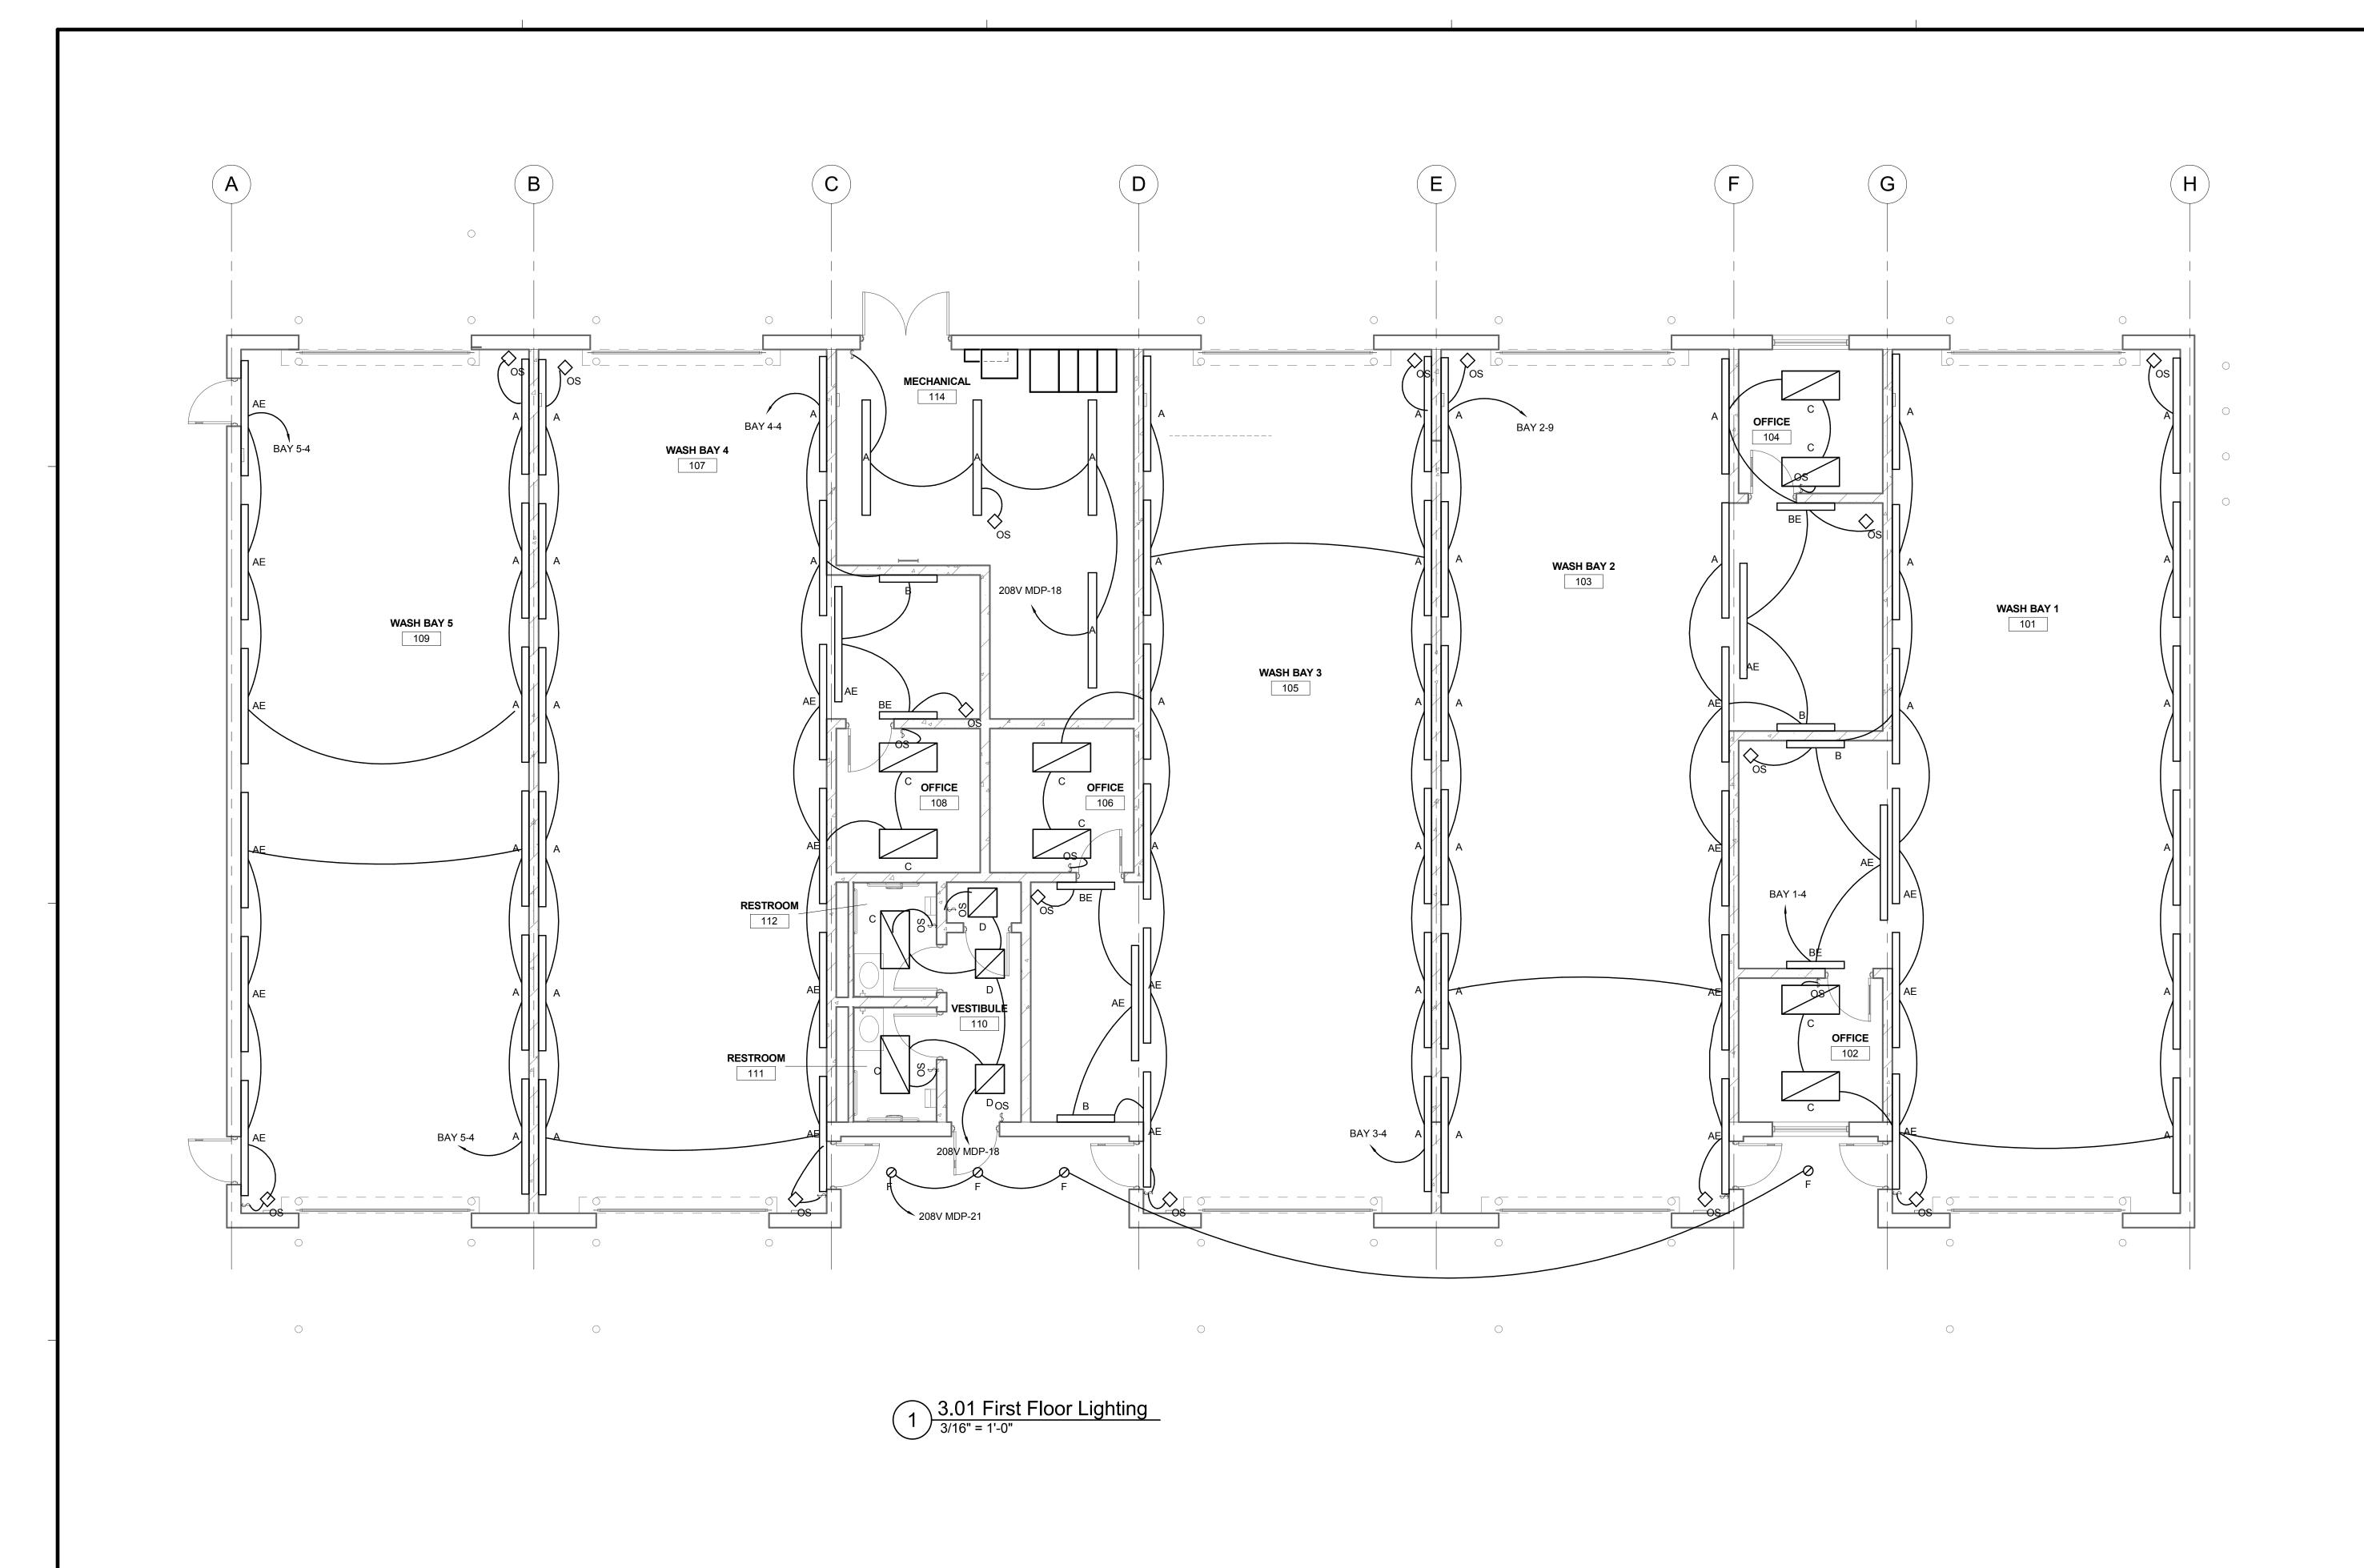

ISG

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LA CROSSE REGIONAL AIRPORT

CAR RENTAL FACILITY

REVISION SCHEDULE

DATE DESCRIPTION BY
02/17/17 Design Development

PROJECT NO. 16-19065

FILE NAME

DRAWN BY CAJ

DESIGNED BY CAJ

REVIEWED BY CAJ

ORIGINAL ISSUE DATE 03/31/2017


CLIENT PROJECT NO.

TITLE

FIRST FLOOR
LIGHTING PLAN

SHEET

E3-11

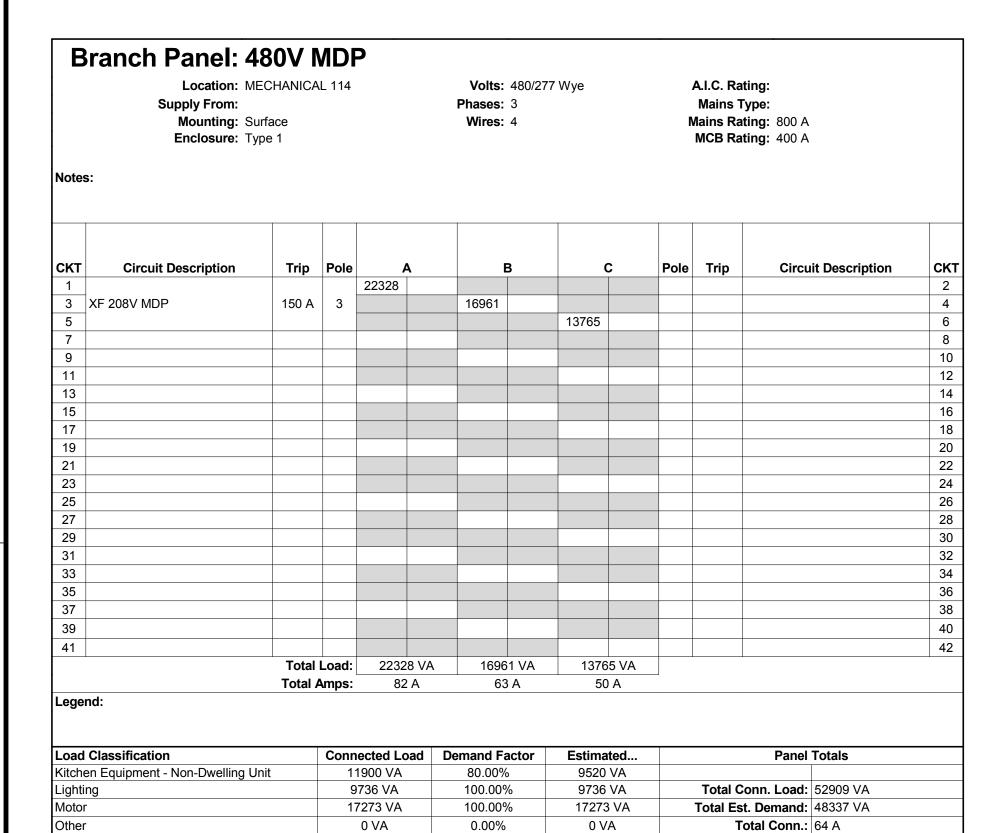

84.72%

12200 VA

Total Est. Demand: 58 A

14400 VA


Note	Supply From: XF Mounting: SU Enclosure: Ty s:	JRFACE	P, 277 \	V/48		Volts: Phases: Wires:		Wye		N		_		
СКТ	Circuit Description	Trip	Pole	ļ			3		2	Pole	Trip	Circu	it Description	СК
1				4799	4619									2
3	BAY 1	100 A	3			3380	3380			3	100 A	BAY 2		4
5								2999	2999					6
7				4619	4079									8
9	BAY 3	100 A	3			3368	3913			3	100 A	BAY 4		10
11								2819	2999					12
13	_			2592	720					1	20 A	Receptacle		14
15	BAY 5	100 A	3			2495	360			1	20 A	Receptacle		16
17								1152	836	1	20 A	Lighting		18
19	Receptacle	20 A	1	720	180					1	20 A	Receptacle		20
21	Lighting	20 A	1			72								22
23 25														24
27														28
29														30
31														32
33														34
35														36
37														38
39														40
41														42
		Total	L	2232			1 VA		5 VA					
		Total A	Amps:	190	) A	14	5 A	11	5 A					
Lege	ena:													
Load	l Classification		Conn	ected Lo	ad D	emand Fa	actor	Estima	ted			Panel	Totals	
	en Equipment - Non-Dwelling U	nit		900 VA		80.00%		9520						
Light				736 VA		100.00%		9736				Conn. Load:		
Moto				273 VA		100.009		17273				st. Demand:		
Othe				0 VA		0.00%		0 V				Total Conn.:		
Rece	eptacle		14	400 VA		84.72%	)	12200	) VA		Total Es	st. Demand:	134 A	

Note	Location: M Supply From: 20 Mounting: Ro Enclosure: Ty	08V MDP ecessed	L 114			Volts: Phases: Wires:		Wye	A.I.C. Rating: Mains Type: Mains Rating: 100 A MCB Rating:						
СКТ	Circuit Description	Trip	Pole		Α	B				Pole	Trip	Circuit Description	СКТ		
1			1 0.0	1152	1080					1	20 A	Receptacle	2		
3	Motor	20 A	3			1152	1911			1	20 A	Lighting	4		
5								1152	180	1	20 A	Receptacle	6		
7	Receptacle	20 A	1	720	180					1	20 A	Receptacle	8		
9	Receptacle	20 A	1			180	180			1	20 A	Receptacle	10		
11	Receptacle	20 A	1					180	1488	2	20 A	Kitchen Equipment -	12		
13	Receptacle	20 A	1	180	1488						20 A	Non-Dwelling Unit	14		
15													16		
17													18		
19													20		
21													22		
23													24		
		Total	Load:	479	9 VA	3380	VA	2999	9 VA						
		Total A	Amps:	40	) A	29	Α	25	5 A						

	Location: MI Supply From: 20 Mounting: Re Enclosure: Ty	8V MDP ecessed	L 114			Volts: Phases: Wires:	-	Wye		A.I.C. Rating: Mains Type: Mains Rating: 100 A MCB Rating:					
Note	s:					T		I				I			
СКТ	Circuit Description	Trip	Pole		A	ı	В		C	Pole	Trip	Circuit Description	СКТ		
1				1152	1080					1	20 A	Receptacle	2		
3	Motor	20 A	3			1152	180			1	20 A	Receptacle	4		
5								1152	180	1	20 A	Receptacle	6		
7	Receptacle	20 A	1	720	180					1	20 A	Receptacle	8		
9	Lighting	20 A	1			1911	180			1	20 A	Receptacle	10		
11	Receptacle	20 A	1					180	1488	2	20 A	Kitchen Equipment -	12		
13					1488							Non-Dwelling Unit	14		
15													16		
17													18		
19													20		
21													22		
23													24		
		Total	Load:	461	9 VA	3380	0 VA	299	9 VA						

В	Location: MI Supply From: 20 Mounting: Re Enclosure: Ty	ECHANICA 8V MDP ecessed				Volts: Phases: Wires:	-	Wye		A.I.C. Rating: Mains Type: Mains Rating: 100 A MCB Rating:						
Note	s:											Т				
СКТ	Circuit Description	Trip	Pole		A		В		С	Pole	Trip	Circuit Description	СКТ			
1	•	-		1152	1080					1	20 A	Receptacle	2			
3	Motor	20 A	3			1152	1719			1	20 A	Lighting	4			
5								1152					6			
7	Receptacle	20 A	1	180	540					1	20 A	Receptacle	8			
9	Receptacle	20 A	1			180	180			1	20 A	Receptacle	10			
11	Receptacle	20 A	1					180	1488	2	20 A	Kitchen Equipment -	12			
13	Receptacle	20 A	1	180	1488						20 /	Non-Dwelling Unit	14			
15	Receptacle	20 A	1			180							16			
17													18			
19													20			
21													22			
23													24			
			Load:		9 VA		8 VA		9 VA							
	nd:	Total A	Amps:	39	9 A	29	9 A	23	3 A							

	Location: ME Supply From: 208 Mounting: Re Enclosure: Type	BV MDP cessed	L 114		120/208 3 4	Wye	A.I.C. Rating: Mains Type: Mains Rating: 100 A MCB Rating:						
Note	s:					T						Т	
СКТ	Circuit Description	Trip	Pole	,	4	В	<b>;</b>	(	3	Pole	Trip	Circuit Description	СК
1	-	-		1152	1080					1	20 A	Receptacle	2
3	Motor	20 A	3			1152	1911			1	20 A	Lighting	4
5								1152	180	1	20 A	Receptacle	6
7	Receptacle	20 A	1	180									8
9	Receptacle	20 A	1			180	720			1	20 A	Receptacle	10
11	Kitchen Equipment -	20 A	2					1488	180	1	20 A	Receptacle	12
13	Non-Dwelling Unit	20 A		1488	180					1	20 A	Receptacle	14
15													16
17													18
19													20
21													22
23													24
		Total	L		9 VA	3913			9 VA				
		Total A	Amps:	35	5 A	34	Α	25	iΑ				

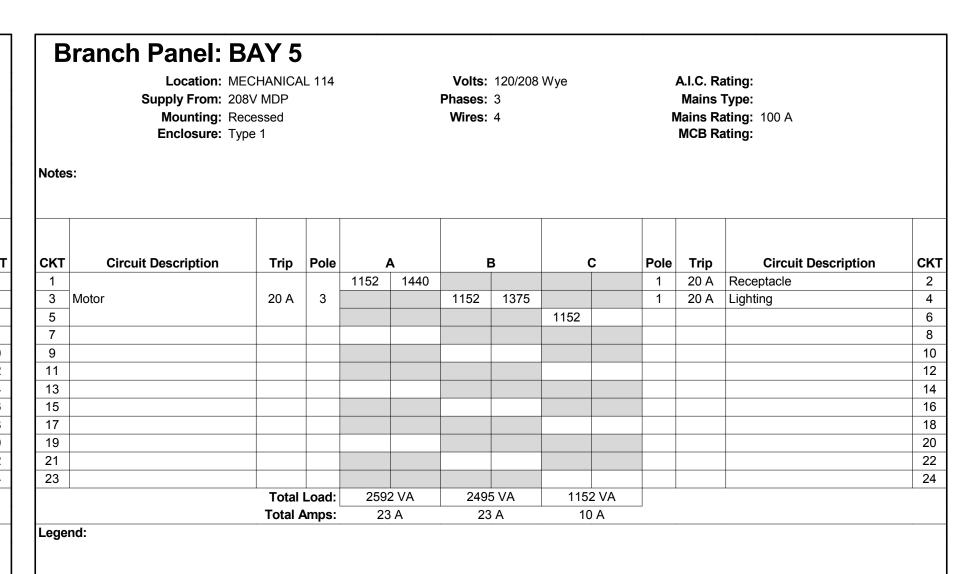



SHEET NOTES

1. IT IS THE CONTRACTORS RESPONSIBILITY TO ENSURE

COMPATIBLE LIGHTING CONTROL DEVICES ARE SUPPLIED.

**ELECTRICAL KEYNOTE LEGEND** 

**KEYNOTE TEXT** 

2. x

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LA CROSSE REGIONAL AIRPORT

CAR RENTAL FACILITY

REVISION SCHEDULE

DATE DESCRIPTION BY
02/17/17 Design Development

PROJECT NO. 16-19065

FILE NAME

DRAWN BY CAJ

DESIGNED BY CAJ

REVIEWED BY CAJ

ORIGINAL ISSUE DATE 03/31/2017

CLIENT PROJECT NO.

TITLE

ELECTRICAL PANEL SCHEDULES

SHEET

E5-11

Receptacle

							ELECTRICAL SYM	BOLS	LEGEND						
	RECEPTACLES		SWITCHES	М	ISC. POWER SYMBOLS	FIR	E PROTECTION SYSTEM	N	IURSE CALL SYSTEM	СО	MMUNICATIONS		SECURITY	ELE	CTRICAL PANELS
$\ominus$	SIMPLEX	\$	SINGLE POLE		DISCONNECT	FACP	FIRE ALARM CONTROL PANEL	NCP	NURSE CONTROL PANEL	$\triangleleft$	DATA JACK	DAA	DOOR ALARM ANNUNCIATOR	P1 F	LUSH MOUNT PANELBOARD
$\oplus$	DUPLEX	\$ <sub>2</sub>	DOUBLE POLE	<b>%</b>	FAN	FAAP	FIRE ALARM ANNUNCIATOR PNL	)N)	DOME LIGHT		FLOOR DATA JACK	→	ADA DOOR OPERATOR		SURFACE MT PANELBOARD
IG ⊕	ISOLATED GROUND	\$3	3-WAY			(S)	SMOKE DETECTOR	ND	DUTY STATION		DATA/VOICE JACK		CAMERA	PHONE	PHONE SYSTEM
TR ⊕	TAMPER RESISTANT	\$4	4-WAY	M	ELECT. CONTROLLED VALVE			(Z)	ZONE LIGHT	•	TELEPHONE JACK	CR	CARD READER - ELECTRONIC		
WP⊖	WEATHER PROOF W/GFI	\$ <sub>E</sub>	EMERGENCY	F	FUSESTAT	1	HEAT DETECTOR	SS	STAFF STATION			SEC	DOOR SECURITY MONITOR		
GFI⊕	GROUND FAULT INTERRUPT	\$ <sub>F</sub>	FAN	0	HAND DRYER	F	☐ HORN STROBE	N	NURSE/TOILET STATION	TV	TELEVISION JACK	К	KEY CARD PAD		
CTR	COUNTERTOP RECEPTACLE	\$ <sub>K</sub>	KEY OPERATED	(H)	HAIR DRYER	H	HORN ONLY			S	SPEAKER - CEILING	P	PUSH BUTTON		
USB⊖	COMBO RECEPTACLE / USB	\$ <sub>LV</sub>	LOW VOLTAGE	Н	HEATER	Ø	STROBE ONLY			\s	SPEAKER - WALL	DO	DOOR OPENER		
<del>-</del>	HIGH VOLTAGE	\$ <sub>P</sub>	PILOT LIGHT	J	JUNCTION BOX	<u>(S)</u>	SPEAKER STROBE			©	CLOCK	R	AREA OF RESCUE-CALL		
$\rightarrow$	SPLIT WIRE	\$ <sub>T</sub>	TIMER	(O)-1	MOTOR	FH	EXTERIOR HORN W/ STROBE			ВО	BELL	DL	ELECTRIC LOCK		
<b>⊕</b>	DOUBLE DUPLEX	\$ <sub>CB</sub>	CIRCUIT BREAKER	ΘĘ.	MOTOR WITH DISCONNECT	M	MINI HORN				BUZZER	lacktriangle	SECURITY ALARM HORN		
$\Rightarrow$	220 VOLT	\$ <sub>D</sub>	DIMMER	R	RELAY	Α	ANSUL TIE			IC	INTERCOM				
$\otimes$ H	SPECIAL PURPOSE	\$ <sub>H</sub>	ILLUMINATED HANDLE	□Ю	SOLENOID VALVE	TS	SPRINKLER TAMPER SWITCH			M	MICROPHON				
$\Rightarrow$	CEILING MOUNTED RECPT	\$ <sub>M</sub>	MOTOR			FS	SPRINKLER FLOW SWITCH				SPEAKER/CLOC				
=>=	CEILING MOUNTED SP RECPT	\$ <sub>sc</sub>	SPEED CONTROLLER	⊠ <sub>1</sub>	COMBINATION STARTER & DISC	HWS	WALL SPEAKER - FIRE			TC	TIME CLOCK				
		\$w	SPRING WOUND TIMER	$\bowtie$	MOTOR STARTER	(cs)	F CEILING SPEAKER - FIRE								
	FLOOR BOX RECEPTACLE	\$ <sub>MC</sub>	MOMENTARY CONTACT	T	THERMOSTAT	H	MAGNETIC DOOR HOLDER								
		\$ <sub>WP</sub>	WEATHER PROOF			F	MANUAL PULL STATION								
		\$ <sub>os</sub>	OCCUPANCY SENSOR-WALL	SD-	DUCT-TYPE SMOKE DETECTOR	OAIN	ADDRESSABLE INPUT MODULE								
		<b>♦</b> os	OCCUPANCY SENSOR-CLG	<b>-</b>	USB CHARGING STATION	Оао	ADDRESSABLE OUTPUT MOD.								
		<b>♦</b> PP	OCC SENSOR-POWER PACK			$\longrightarrow$	ABORT SWITCH								
		РС	PHOTO CELL			Ω°	BELL-CHIME								
		•••	3-BUTTON SWITCH			EOLD	END OF LINE RESISTOR								
						□(F/:	S FIRE/SMOKE DAMPER								
						□(s	SMOKE DAMPER								

1. IT IS THE CONTRACTORS RESPONSIBILITY TO ENSURE COMPATIBLE LIGHTING CONTROL DEVICES ARE SUPPLIED.

**ELECTRICAL KEYNOTE LEGEND KEYNOTE TEXT** 



VISUAL APPLIANCE MOUNTING HEIG  1. MIN DISTANCE IN SLEEPING ROC OF LENS FOR 110cd STROBES W  2. 177cd STROBES, USED IN SLEEPI 24" MINIMUM DISTANCE FROM THE IS TO COMPENSATE FOR A POSS	MS IS 24" FROM CEILING TO TOP ITHIN 16' OF PILLOW NG ROOMS, CAN BE WITHIN THE HE CEILING, THE HIGHER INTENSIT		EXIT FIXTURE-CEILING — MOUNTED  TURE-END MOUNTED —  FIXTURE —	A/C	1	CEILING MOUNTED SMOKE/HEAT DETECTOR  0" MIN	NEVER INSTALL HEAT
FOR CEILING HEIGHTS LESS THAN 86" — THE VISUAL LENS MOUNTING HEIGHT SHALL BE WITHIN 6" OF THE CEILING.	CEILING	NFPA 72 AUDIBLE APPI 6" MIN BEL FINISHED CE	LIANCE OW	SUPPI DIFFUS	EXIT FIX MOUNT	TURE-BACK ED M OF EXIT SIGN TO	IN SHADED AREA
BC)	AUDIO/VISUAL & VISUAL ONLY DEVICES	AUDIBLE ONLY	MAGNETIC DOOR HOLDER —	DOOR WIDTH LESS 3	BE 4" AE FRAME	WALL MOUNTED SMOKE/HEAT DETECTOR	
AUDIBLE 80" MIN ( 90" MAX (BC) ABOVE FINISHED FI	SYNCHRONIZE MORE THAN TWO APPLIANCES IN ANY FIELD OF VIEW.	90" MIN ABOVE FINISHED FLOOR OR APPROVED FROM AHJ 7-6" (MIN.)-8'-6" (MAX.)	MANUAL PULL STATION  FIRE PHONE JACK	48" MAX (NFPA, ADA) 42" MIN (NFPA) TOP OF PULL XVA TOP OF PULL AVA TOP OF PULL	0		→ FINISHED WALL

LIGHT FIXTURE SCHEDULE					
TYPE	DESCRIPTION	MANUFACTURER	MODEL	LAMP	TYPE COMMENTS
Α	8' VAPORTITE INDUSTRIAL	EATON	8VT2-LD4-12-DR-W-UNV-L840-CD2-WL	114.6W LED	MOUNT 10' AFF ON WALLS
AE					
В	4' VAPORTITE INDUSTRIAL	EATON	4VT2-LD4-6-DR-W-UNV-L840-CD1-WL	56W LED	MOUNT 10' AFF ON WALLS
BE					
С	2X4 LENSED TROFFER	EATON	24GR-LD4-48-F1-UNV-L840-CD1	43W LED	
D	2X2 LENSED TROFFER	EATON	22GR-LD4-32-F1-UNV-L840-CD1	33W LED	
F	6" LED CAN LIGHT	EATON	PD6-20-ED010-PDM6A-840-W	20.78W LED	

CONTRACTOR IS RESPONSIBLE FOR:

ALL SECONDARY WORK AND SITE RESTORATION WORK. PROVIDING TWO HOLE SPADES FOR THE TRANSFORMER SECONDARY.

TO ARRANGE FOR ALL OUTAGES AND COORDINATION.
TO INSTALL GROUND GRID (INCLUDE COST FROM UTILITY)

NEW TRANSFORMER PAD.

PROVIDING AND INSTALLING METER SOCKET (PURCHASE FROM UTILITY)
1" CONDUIT FROM METER TO C/T COMPARTMENT (LOCKABLE)

PROVIDING AND INSTALLING SECONDARY CABLES FROM TRANSFORMER TO C/T CABINET INCLUDING ALL FEES FROM UTILITY COMPANY IN BIDS.

- 1"C, 4#3's #8 GND 3.5"C, (4)600 MCM's, – 1.25"C, (3) 1/0's, #6 GND #3 GND PROPOSED METER AND METER SOCKET -MOUNTED ON C/T CABINET VERIFY ALL REQUIREMENTS WITH LOCAL UTILITY **208V MDP 480V MDP** XF 208V MDP BAY 2 BAY 3 800 AMP 112.5KVA 400 AMP 100 AMP 100 AMP 100 AMP MAIN BREAKER TRANSFORMER MAIN BREAKER MAIN BREAKER MAIN BREAKER MAIN BREAKER 480-208Y/120 VOLT 208Y/120 VOLT 208Y/120 VOLT 208Y/120 VOLT 480Y/277 VOLT 208Y/120 VOLT 3 PHASE, 4W DRY TYPE 3 PHASE, 4W 3 PHASE, 4W 3 PHASE, 4W 3 PHASE, 4W **NEW UTILITY** SURFACE MT SURFACE MT SURFACE MT SURFACE MT SURFACE MT TRANSFORMER PROPOSED UTILITY TRANSFORMER I-LINE 24 SPACES **42 SPACES** 24 SPACES 24 SPACES VERIFY ALL REQUIREMENTS WITH C/T CABINET W LOCAL UTILITY 480Y/277 VOLT 800A C/T'S 3 PHASE SECONDARY AND METER **METERS** BAY 5 1"C, 4#3's #8 GND 100 AMP 100 AMP - (2) 4"C, 4# MAIN BREAKER MAIN BREAKER 800 AMP SERVICE 600 MCM's 208Y/120 VOLT 208Y/120 VOLT 480Y/277 VOLT 3 PHASE 3 PHASE, 4W 3 PHASE, 4W (2) 4"PVC C, 4#600 MCM's SURFACE MT SURFACE MT 24 SPACES 24 SPACES

> TWO GROUNDING ELECTRODES SHALL BE INSTALLED OUTSIDE THE BUILDING WITH PROVISIONS OF ARTICLE 250 OF THE NEC. CONNECTION SHALL BE MADE FROM GROUNDING ELECTRODE TO GROUNDED SERVICE CONDUCTOR IN SERVICE CABINET, CONTINUING TO THE CUSTOMERS WATER SERVICE.

2 TYPICAL MOUNTING HEIGHTS
12" = 1'-0"

3 ELECTRICAL RISER DIAGRAM
1/8" = 1'-0"

3/0 COPPER GROUNDING ELECTRODE TO ANY GROUNDING ELECTRODE AVAILABLE

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LA CROSSE **REGIONAL AIRPORT** 

## **CAR RENTAL FACILITY**

LA CROSSE

REVISION SCHEDULE DESCRIPTION 02/17/17 Design Development

WISCONSIN

16-19065 PROJECT NO. FILE NAME DRAWN BY CAJ CAJ DESIGNED BY CAJ REVIEWED BY ORIGINAL ISSUE DATE 03/31/2017 CLIENT PROJECT NO.

TITLE

**ELECTRICAL SCHEDULES AND DETAILS** 

SHEET

E5-12