



 $\frac{1}{1/8"} = 1'-0"$ 

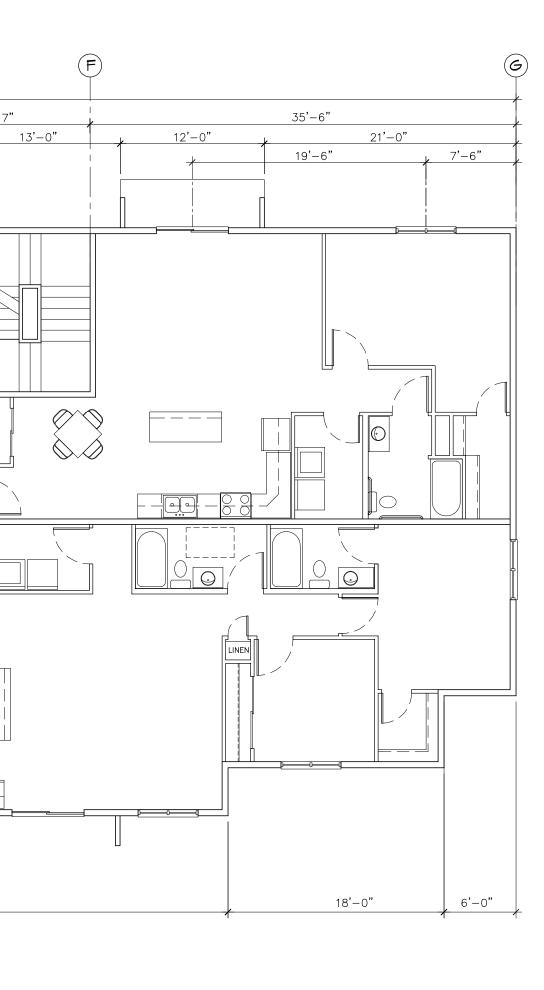

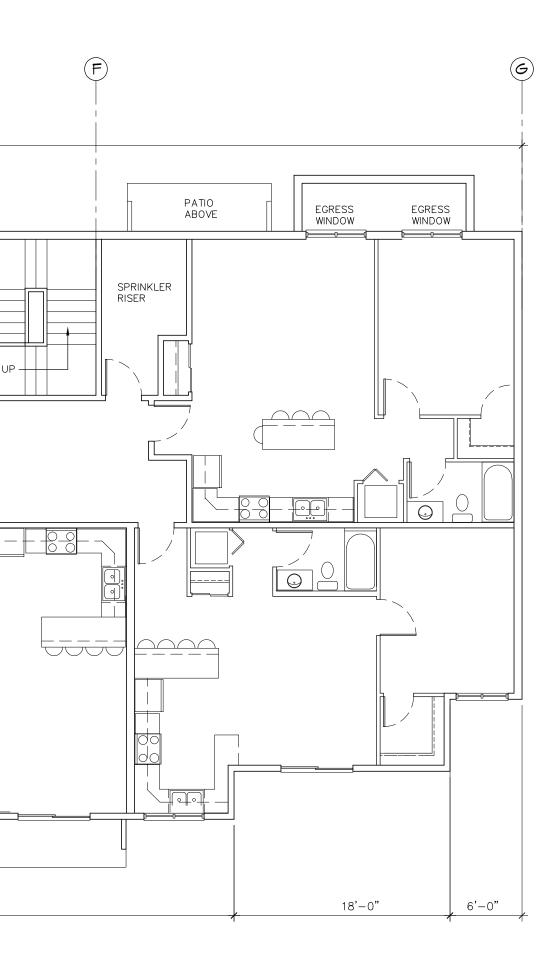


PROJECT TITLE:	20 UNIT APART, MENT Interior Remodel PROJECT LOCATION: ST HWY 16 LaCrosse, WI 54601
PR	OJECT NO:
DR	AWING DATE:
12/	/20/18
DR. SS	AWN BY: K
	T TYPE: RELIMINARY
<b>RE</b> ' NO.	VISIONS DATE
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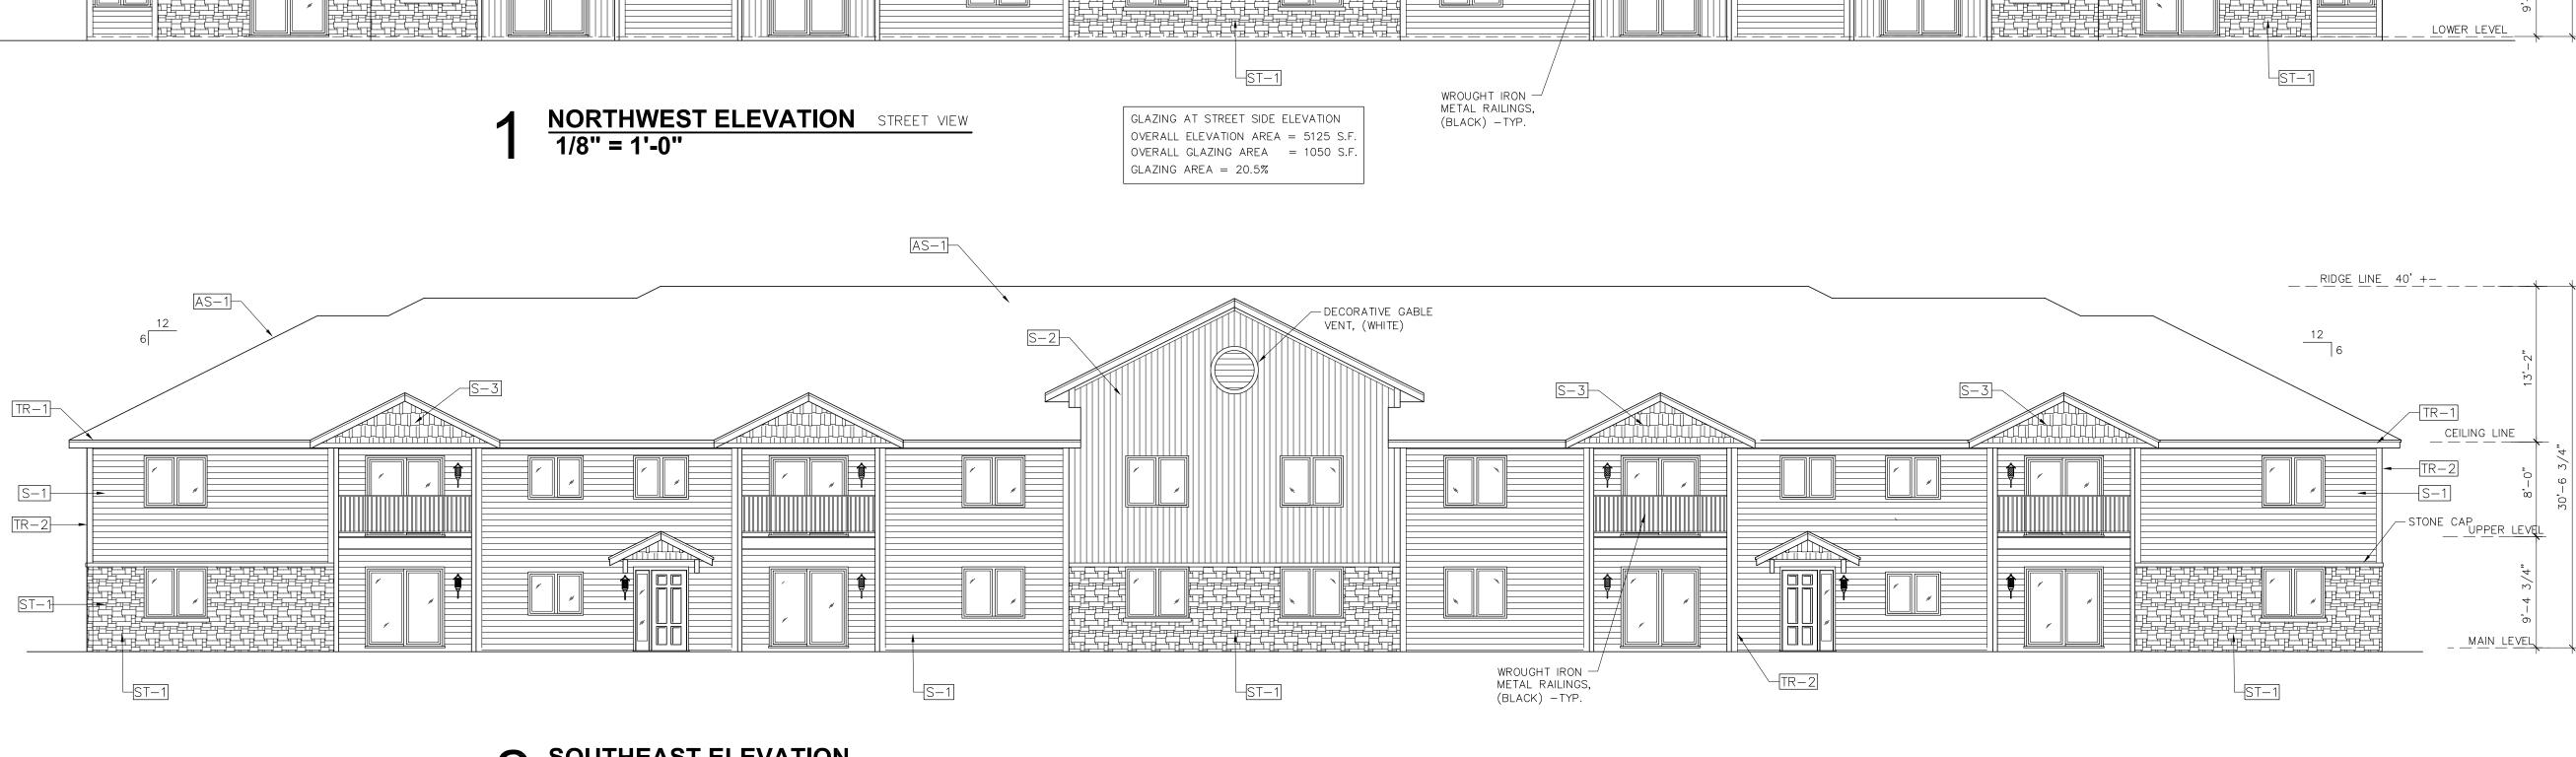
SHEET TITLE FLOOR PLAN









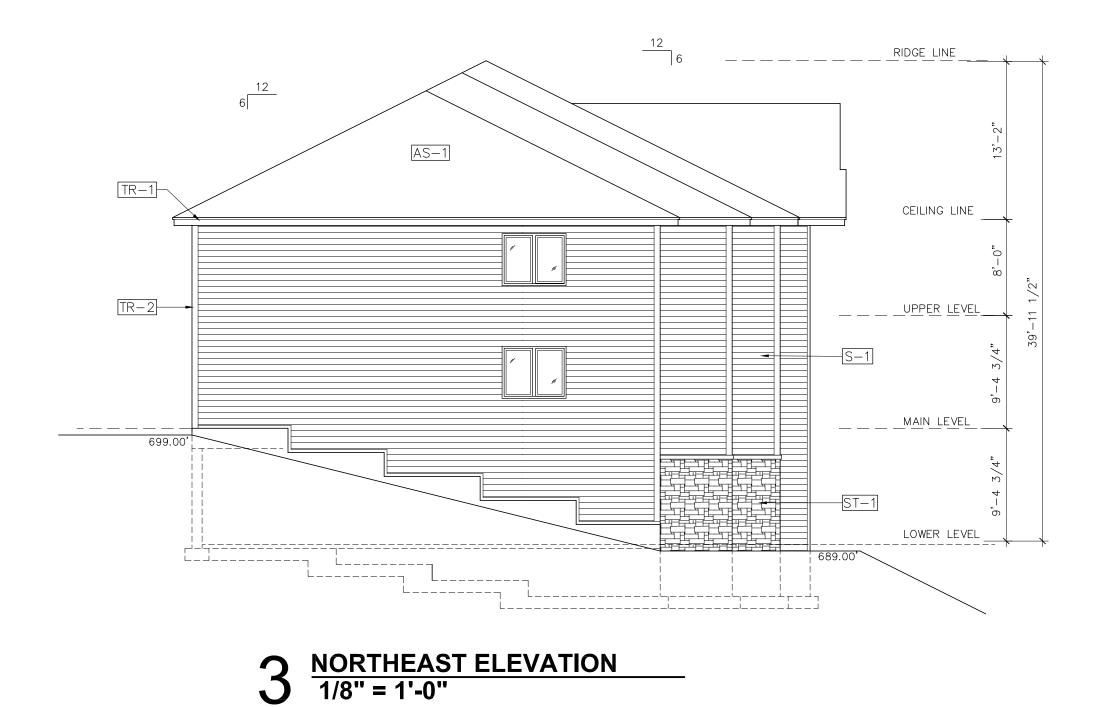



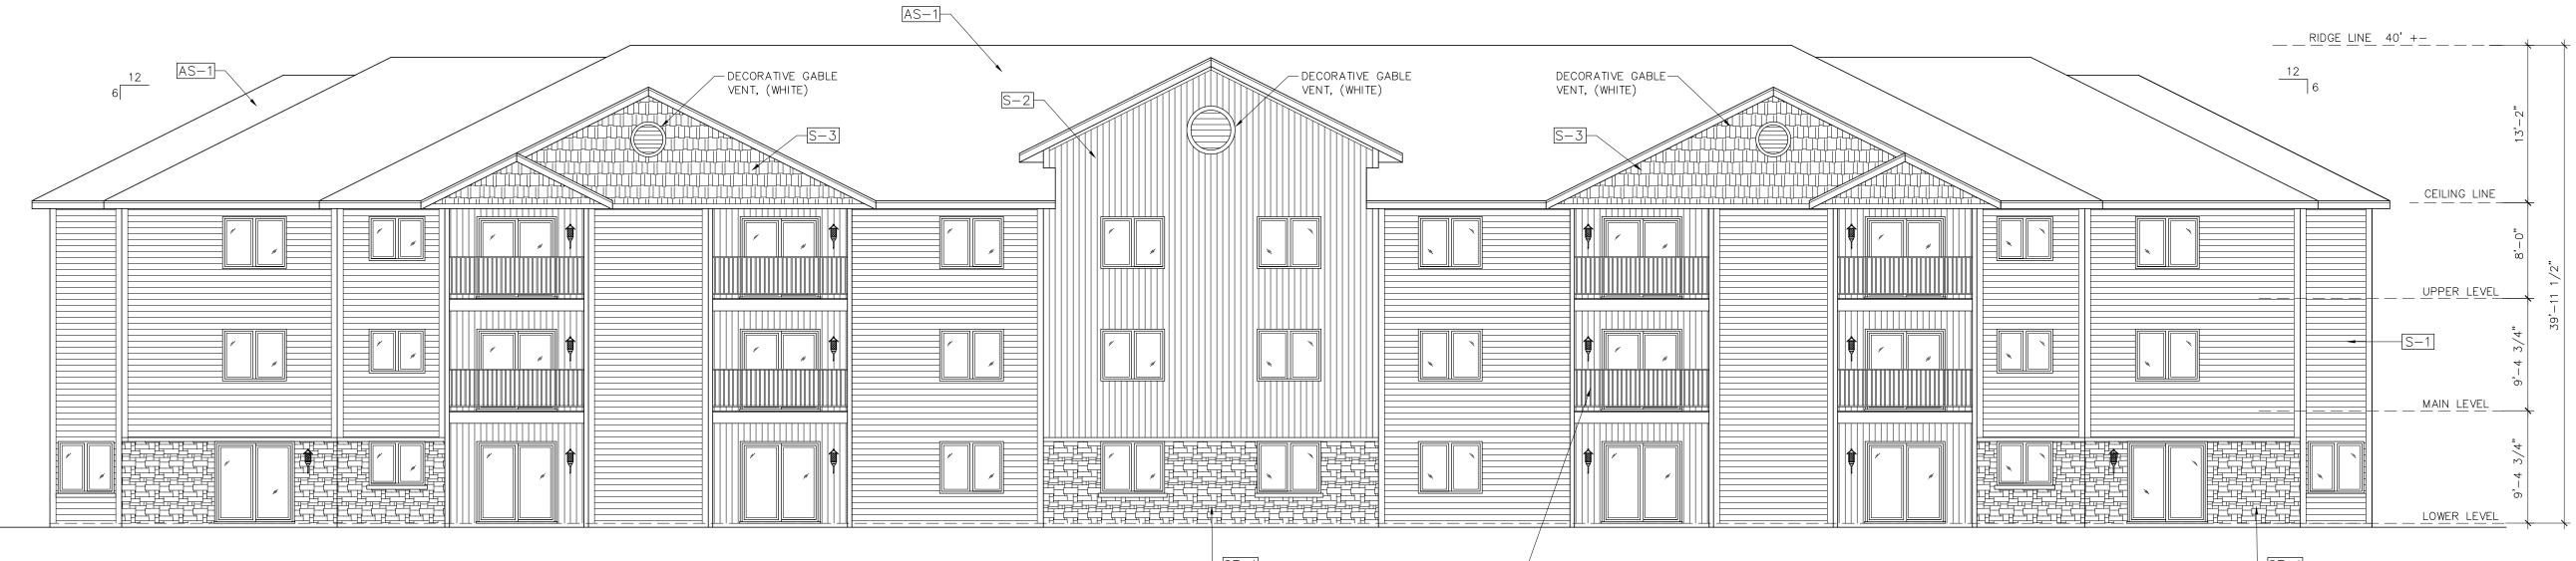

SOUTHWEST ELEVATION
1/8" = 1'-0"

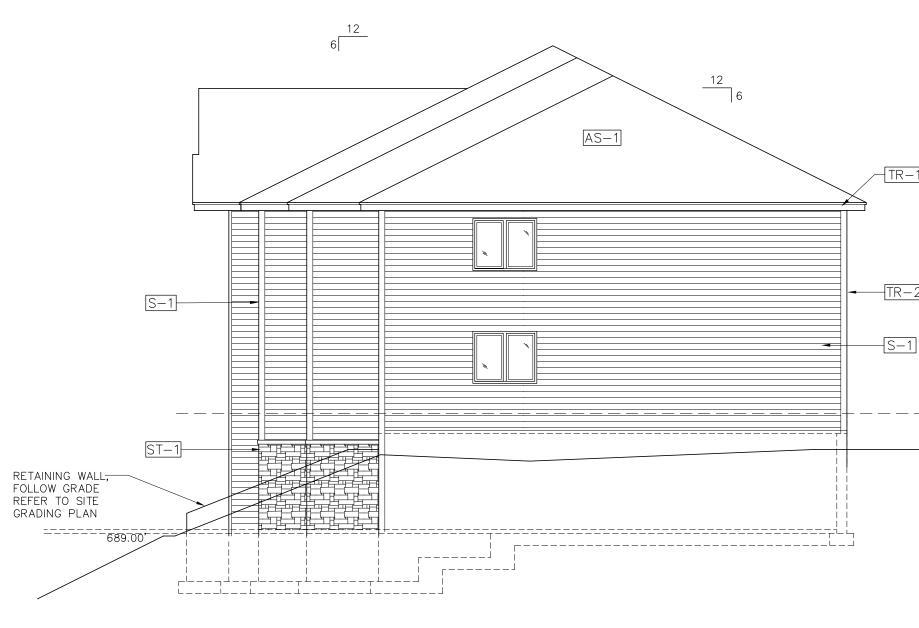

MARK	MATERIAL	COLOR	MFR.	NOTES
S-1	SIDING – HORIZ. 6" LAP COMPOSITE SIDING	SAGE MEDIUM BROWN	LP	
S-2	SIDING VERT. 6" EXPOSURE COMPOSITE SIDING	SAGE LIGHT BROWN	LP	
S-3	SIDING – SHAKES COMPOSITE SIDING	SAGE LIGHT BROWN	LP	
TR-1	TRIM BOARD - FASCIA	WHITE	LP	
TR-2	TRIM BOARD - CORNERS	WHITE	LP	
ST-1	CAST STONE – STACK EXTERIOR STONE VENEER	BROWN BLEND	TBD	
AS-1	ARCHITECTURAL SHINGLES ASPHALT / FIBERGLASS	BROWN BLEND	TBD	

# ARTMENT 54601 K Re 24 UNI Interior R PROJECT ST HWY LaCrosse

PROJECT NO:


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# DRAWING DATE: 12/20/18

DRAWN BY: SSK

SET TYPE: PRELIMINARY


## REVISIONS

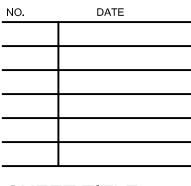


SHEET TITLE FLOOR PLAN



A101 Scale: As indicated COPYRIGHT© 2017 VANTAGE ARCHITECTS, INC.

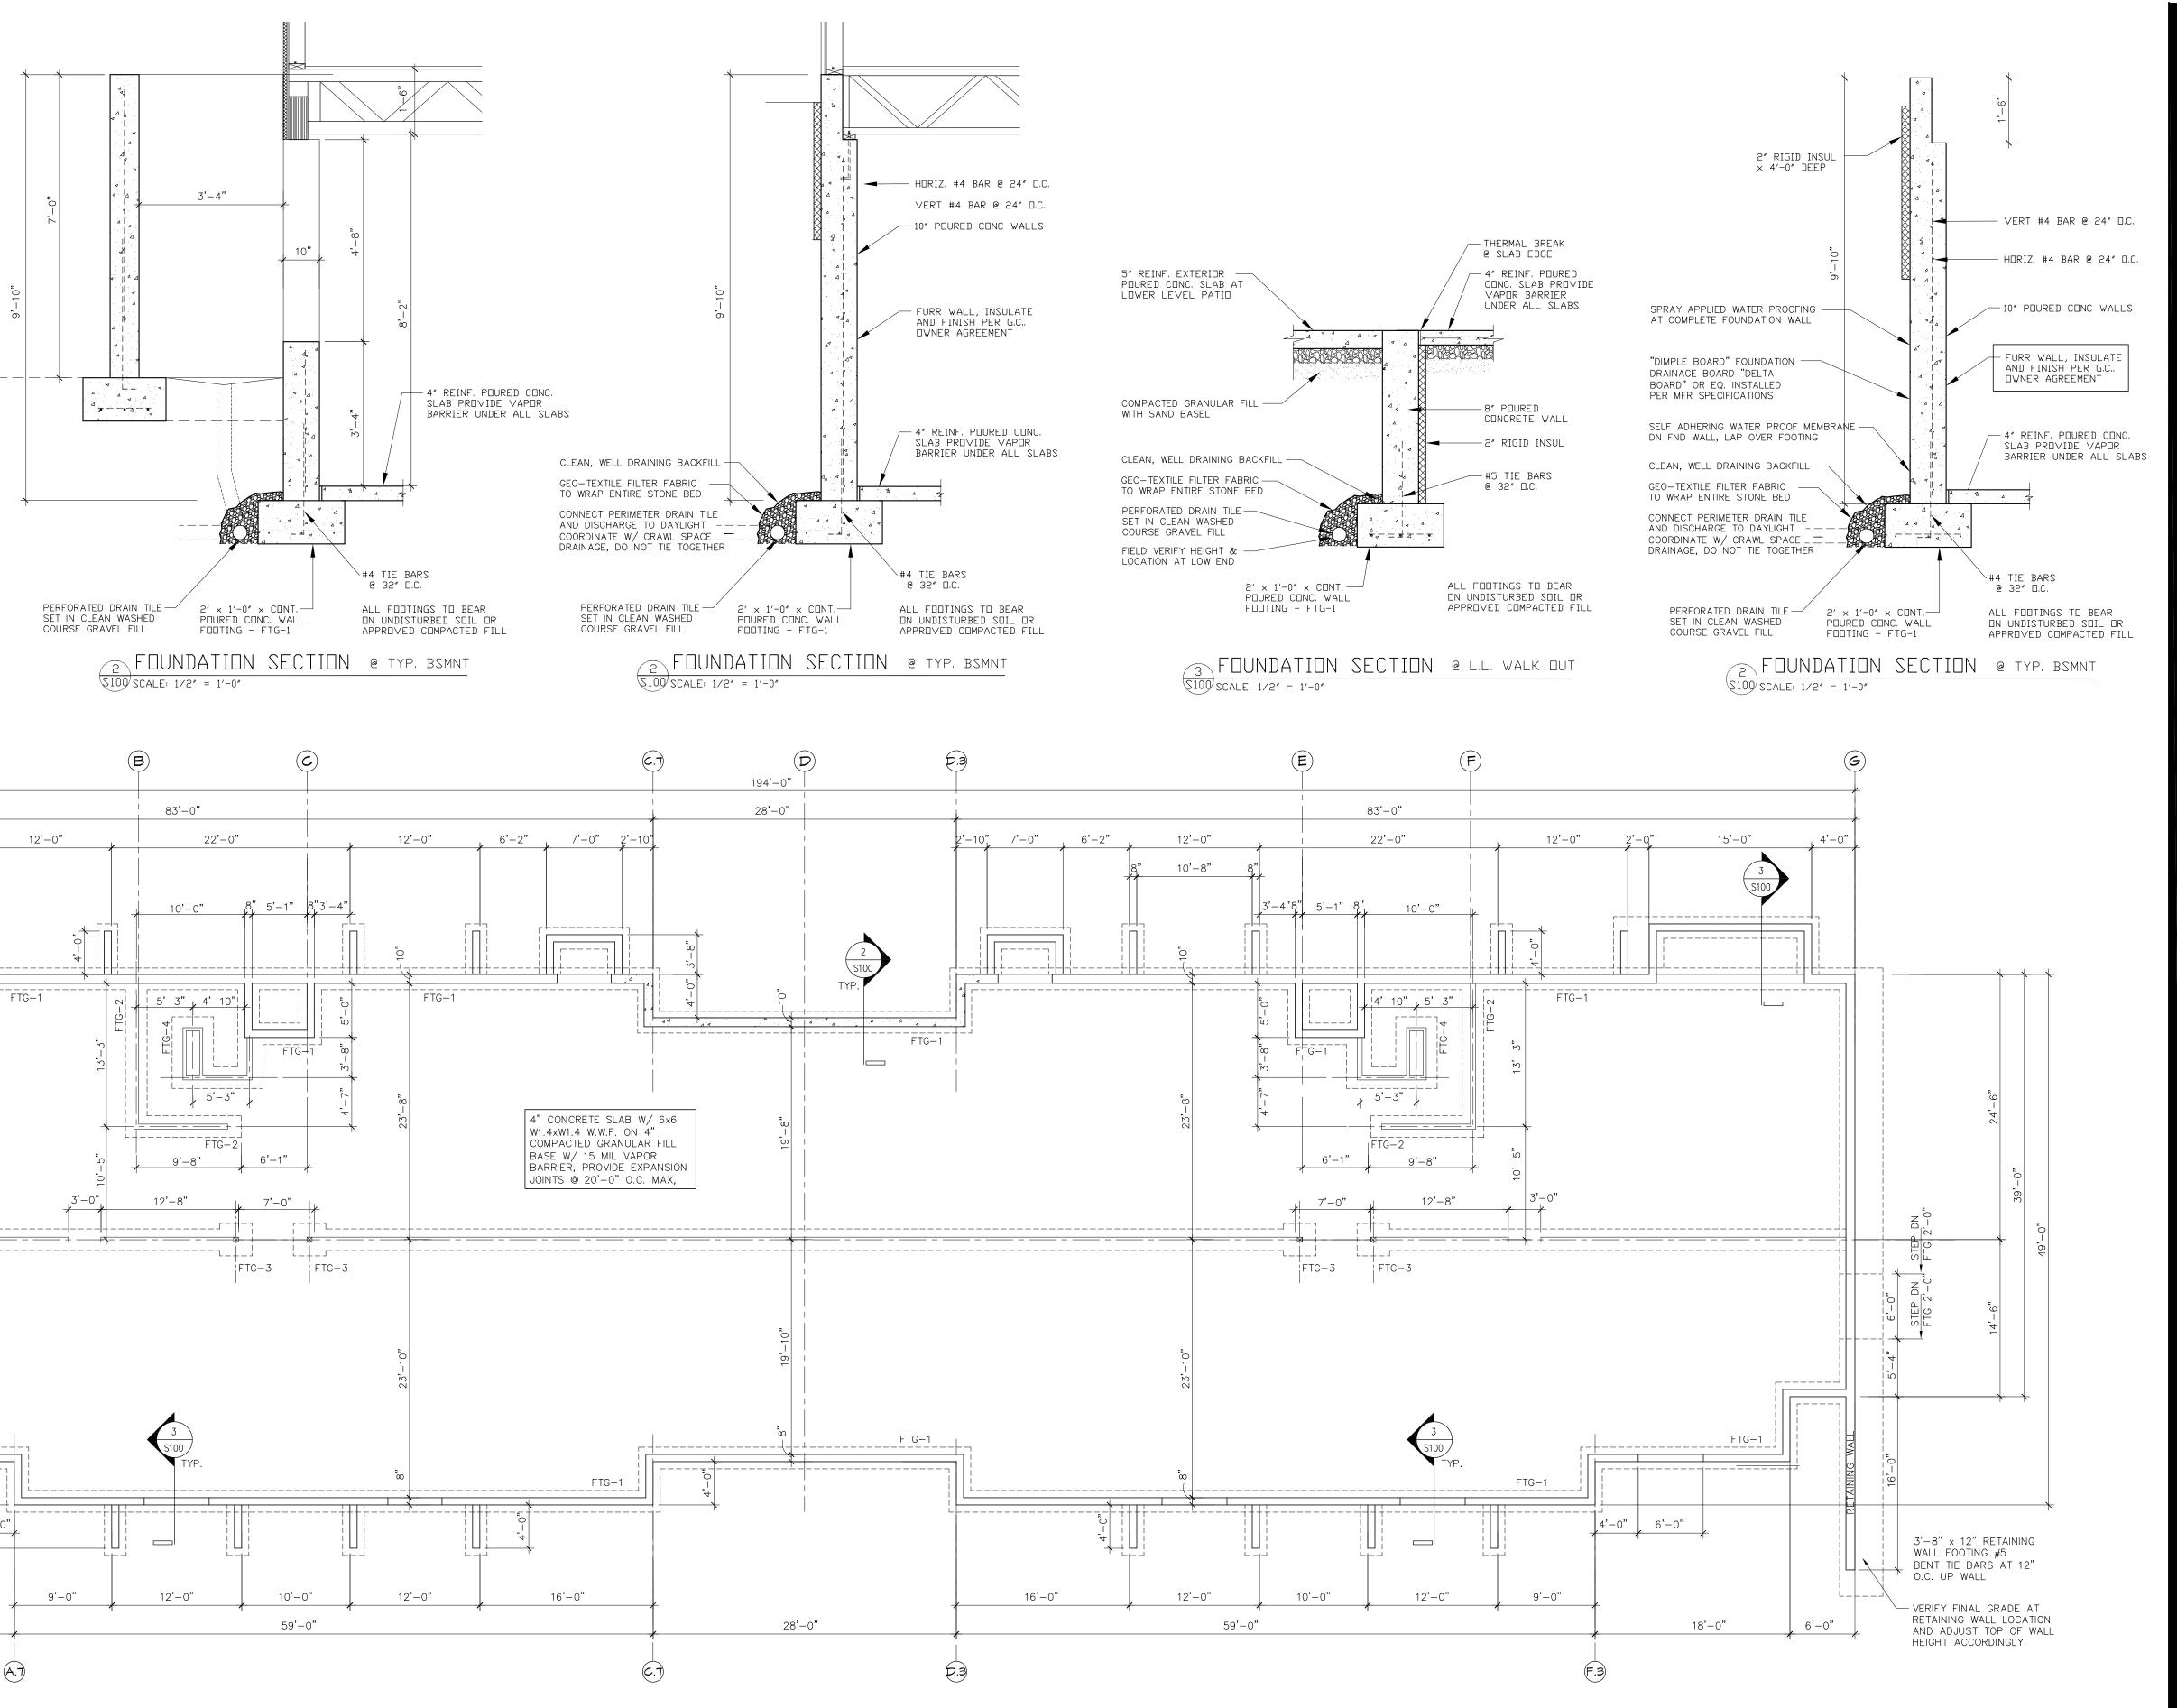

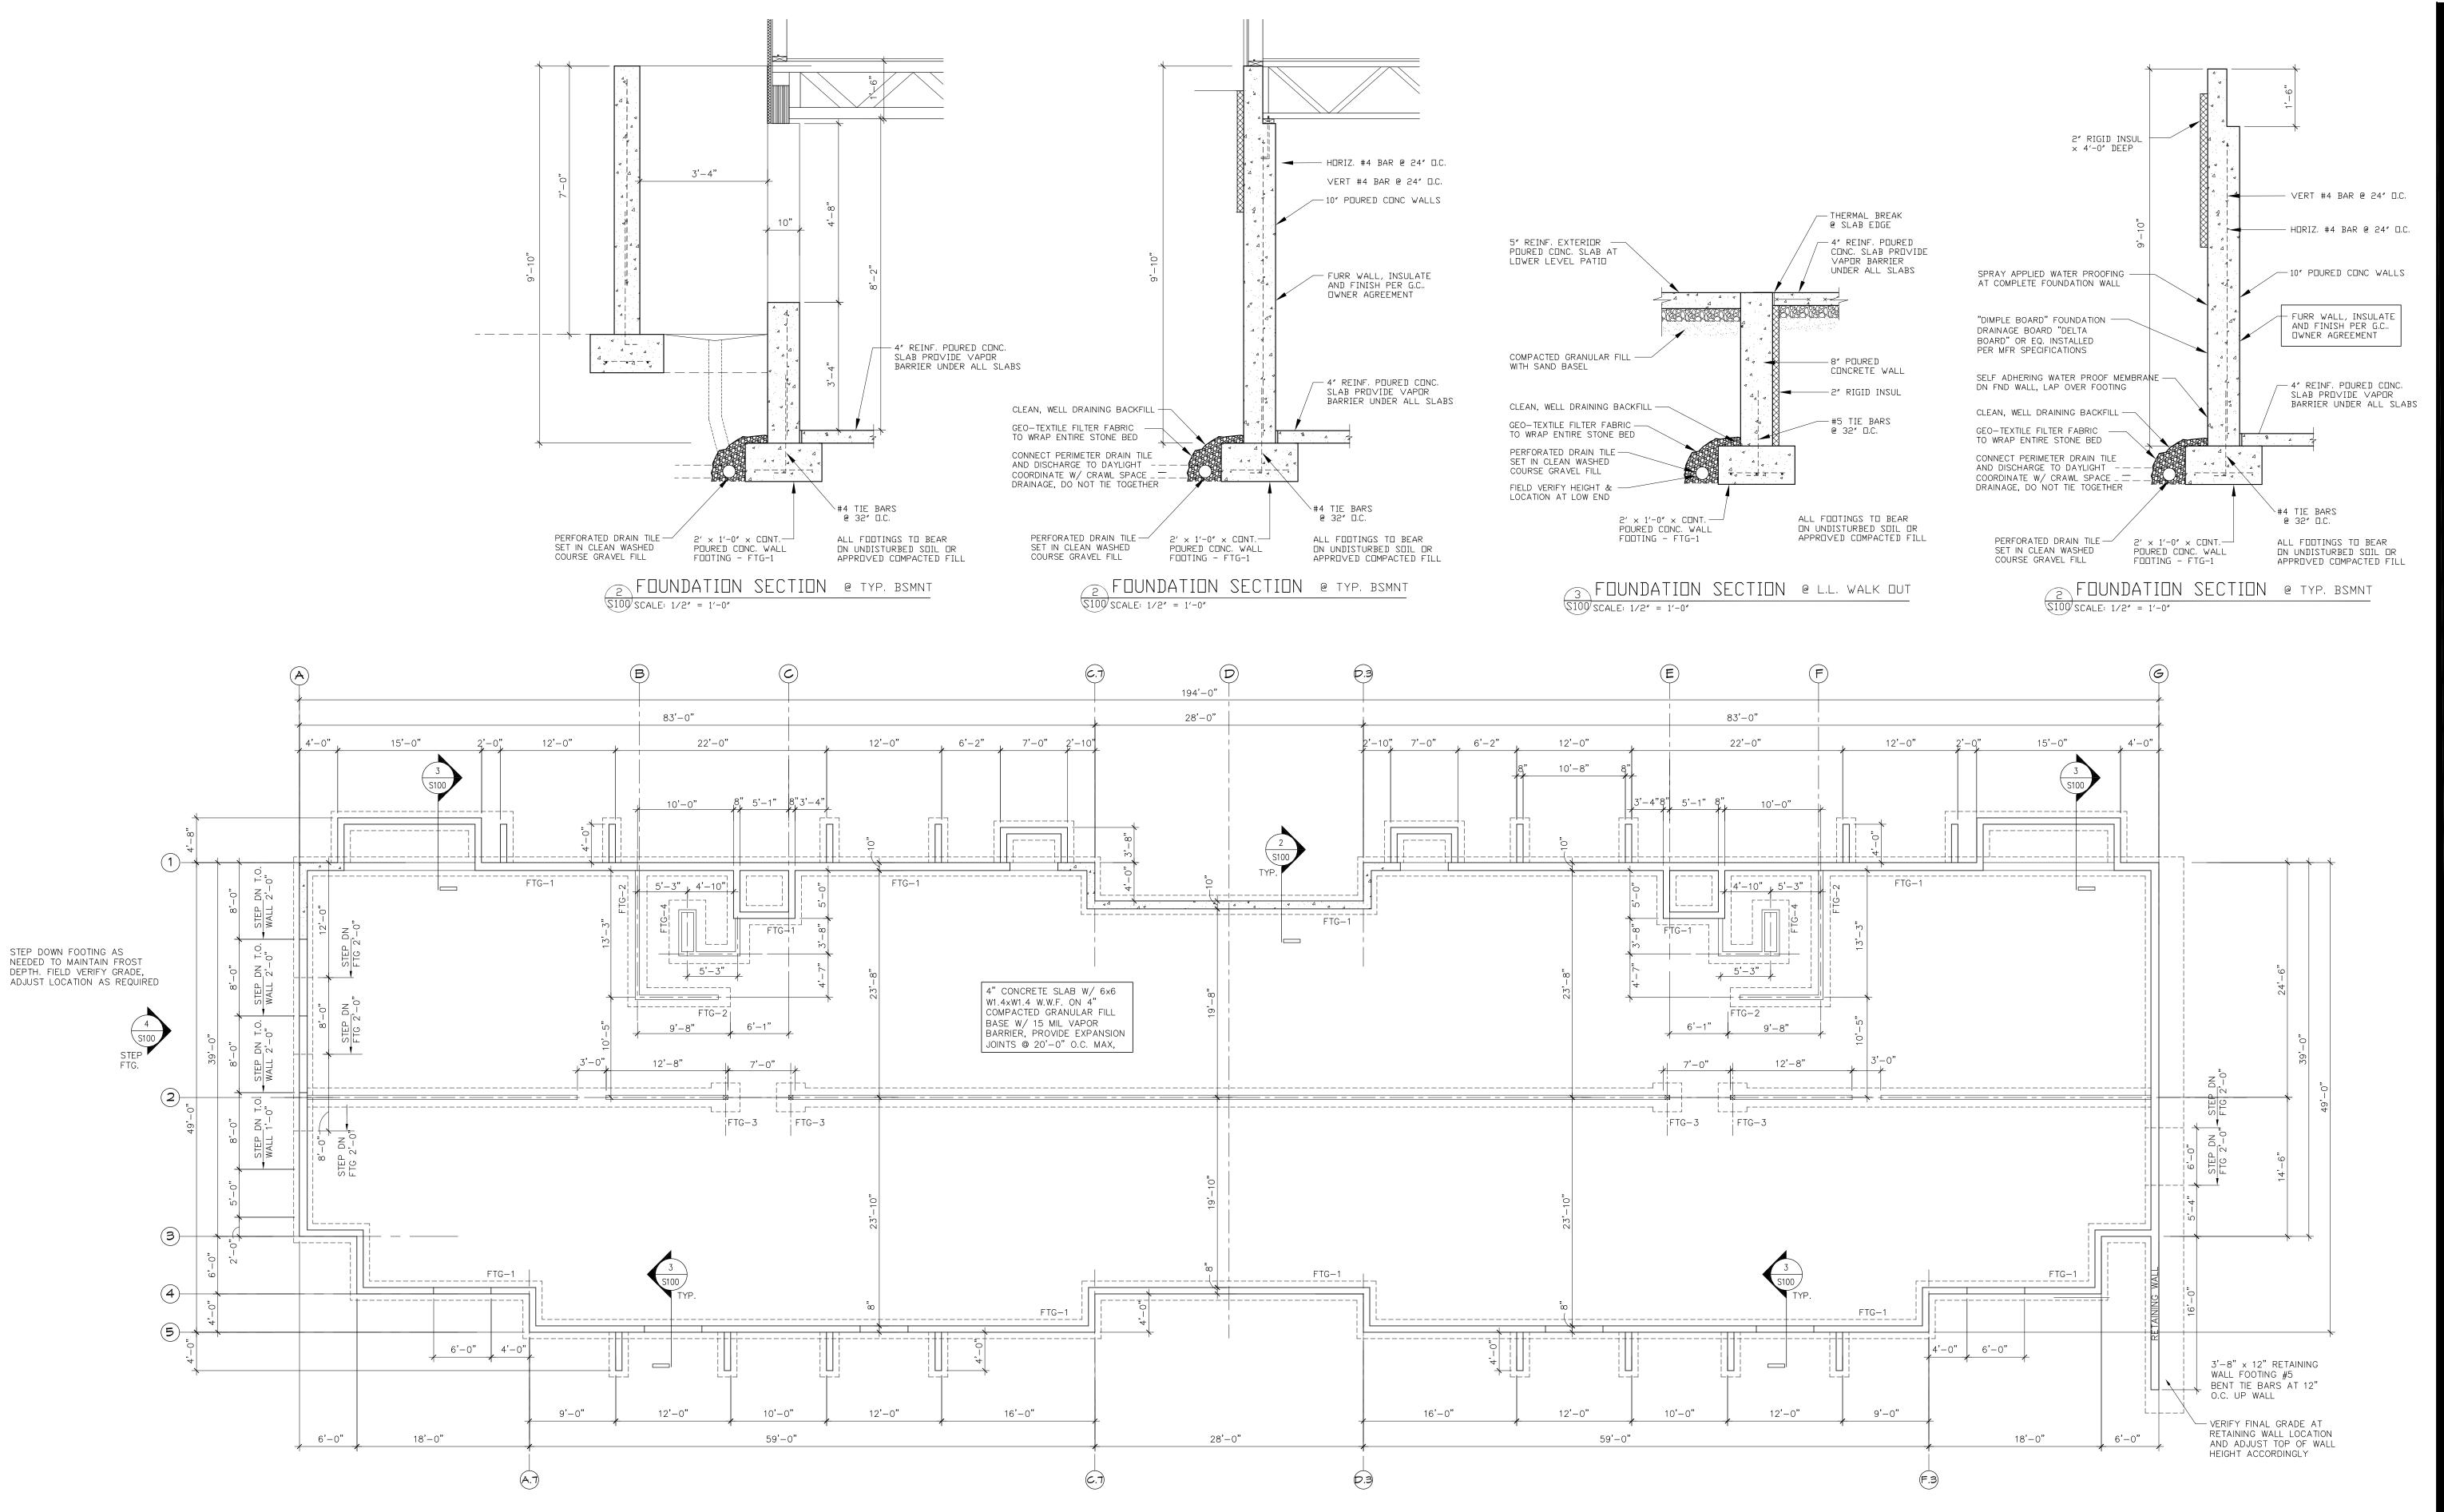

FOU	NE	<u>)</u> A	Τ
1/8"		1'	-0

		COLUI	MN SCHEDULE		
7		MARK	SIZE	ΒA	SE PL
	(2.6k)	C-1	3 1/2" DIA. PIPE COL.		10"x10"x
		C-2	4" DIA. PIPE COL.		10"x10"x
		PIER	SCHEDULE / REI	ΓΑIΝ	NING
		MARK	SIZE		REINF.
		P-1	2'-0" x 2'-0"x 4'-0" ⊦	HIGH	(4) #5
		P-2	2'-8" x 2'-8"x 4'-0" ⊦	HIGH	(4) #5
		R-1	2'-0" x 2'-0"x 4'-0" +	HIGH	(3) #4

90% 94%


89%

87%

FOOTI	NG SCHEDULE			
MARK	SIZE	REINF.	LOAD	MAX LOA
FTG-1	2'-0"x 1'-0"x CONT.	(3) #4	3.6k	4000 PLF
FTG-2	2'-0"x 1'-0"x CONT.	(2) #4	14.2k	15.1k
FTG-3	3'-0"x 3'-0"x 1'-0"	(5) #5 E.W.		18k
FTG-4	3'-4"x 3'-4"x 1'-0"	(5) #5 E.W.	19.9k	22.3k

FTG-5 4'-0"x 4'-0"x 1'-0" (7) #5 E.W. 24.2k 32k

# TION PLAN

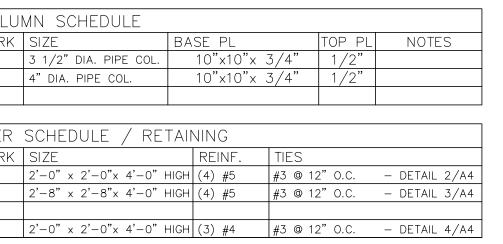

## FOUNDATION GENERAL NOTES

- 1. CONTINUOUS WALL FOOTINGS ARE TO HAVE (3) #4 CONT. FOOTING REINF. CONTINUOUS AT CORNERS. LAP FOOTING REINF. MIN 15" AT SPLICES AND STAGGER SPLICES.
- 2. FOOTING /WALL TIE BARS PROVIDE #4 BENT DOWELS @ 48" O.C. CAST INTO FOOTING - ALT. DIRECTION OF BEND AND EXTEND 28" MIN. ABOVE FOOTING.
- 3. PROVIDE (1) 1/2" DIA. x 7" MIN. CONC. EMBEDMENT ANCHOR BOLT @ 72" O.C. MAX. (MIN. 2 BOLTS PER WALL) AND WITHIN 12" OF EACH END.
- 4. PROVIDE #4 CONT. VERT. REBAR @ 24" O.C. FROM FOOTING TO -3" FROM TOP OF WALL. PLACE VERTS 5" FROM EARTH FACE ON 8" WALL. TIE HORIZ. BARS TO VERTS ON INTERIOR SIDE. MAINTAIN 1 1/2" OF CONC. COVER ON WALL REINF.
- 5. PROVIDE #4 HORIZ. REBAR @ 24" O.C. IN FOUNDATION WALL-TIE TO VERTS AS NOTED.
- FOUNDATION WALL. COORDINATE LOCATIONS WITH WALL LAYOUT.
- 7. PROVIDE SPRAYED MEMBRANE WATER PROOFING TO COMPLETE FOUNDATION WALL EXTERIOR TO 6" ABOVE GRADE. MEMBRANE TO COVER FND WALL/ FOOTING INTERSECTION, FIELD VERIFY SLOPE OF GRADE.
- 8. ALL READY MIX CONCRETE SHALL BE 3500 PSI FOR FLOOR SLABS AND 3000 PSI FOR ALL OTHER CONCRETE PLACEMENT.
- 9. PROVIDE TREATED 2x6 SILL PLATE W/ CONT. SILL SEALER. DRILL HOLES IN PLATE TO MATCH ANCHOR BOLT LAYOUT (MIN. 2 BOLTS PER PLATE) AND SECURE TO FOUNDATION WALL W/ WASHER AND NUT.ALL LUMBER IN CONTACT WITH CONCRETE OR MASONRY IS TO BE TREATED FOR SUCH.
- 10. SAWN STRUCTURAL LUMBER USED FOR POSTS AND COLUMNS IS TO BE HEM-FIR #1 GRADE OR BETTER. SEE PLANS FOR SIZES.


- 6. PROVIDE 1/2" DIA THREADED ROD AT HOLD DOWN LOCATIONS W/12" MIN EMBED INTO 11. G.C. TO DETERMINE NUMBER, WIDTH AND LOCATION OF ALL FOOTING AND/OR WALL STEPS.
  - 12. ALL FOUNDATION FOOTINGS SHALL BEAR ON UNDISTURBED SOIL AT A MINIMUM DEPTH OF 4'-0" BELOW GRADE
  - 13. ALL REBAR USED SHALL BE CLEAN AND FREE OF OIL, DIRT OR OTHER CONTAMINANTS THAT WILL PREVENT COMPLETE BONDING TO THE CONCRETE.

14. DESIGN STRESSES: fp = 2,000 P.S.F. ASSUMED ALLOWABLE SOIL BEARING PRESSURE f'c = 4,000 P.S.I. (@28 DAYS) AIR ENTRAINED CONCRETE FOR ALL EXTERIOR PLATFORMS, SIDEWALKS, EXTERIOR CONCRETE WALLS, EXTERIOR STOOPS AND STAIRS f'c = 3,000 P.S.I. (@ 28 DAYS) FOR FOOTINGS fy = 60,000 P.S.I. A615 GRADE 60 REINF. STEEL


# APTS ATION: 460 Õ 9 16 16 HWY PROJE HWY LaCro PROJECT NO: 18-04 DRAWING DATE: 12/20/18 DRAWN BY: ESKAY LLC SET TYPE: Prelim REVISIONS SHEET TITLE FOUNDATION PLAN

## SHEET NO.



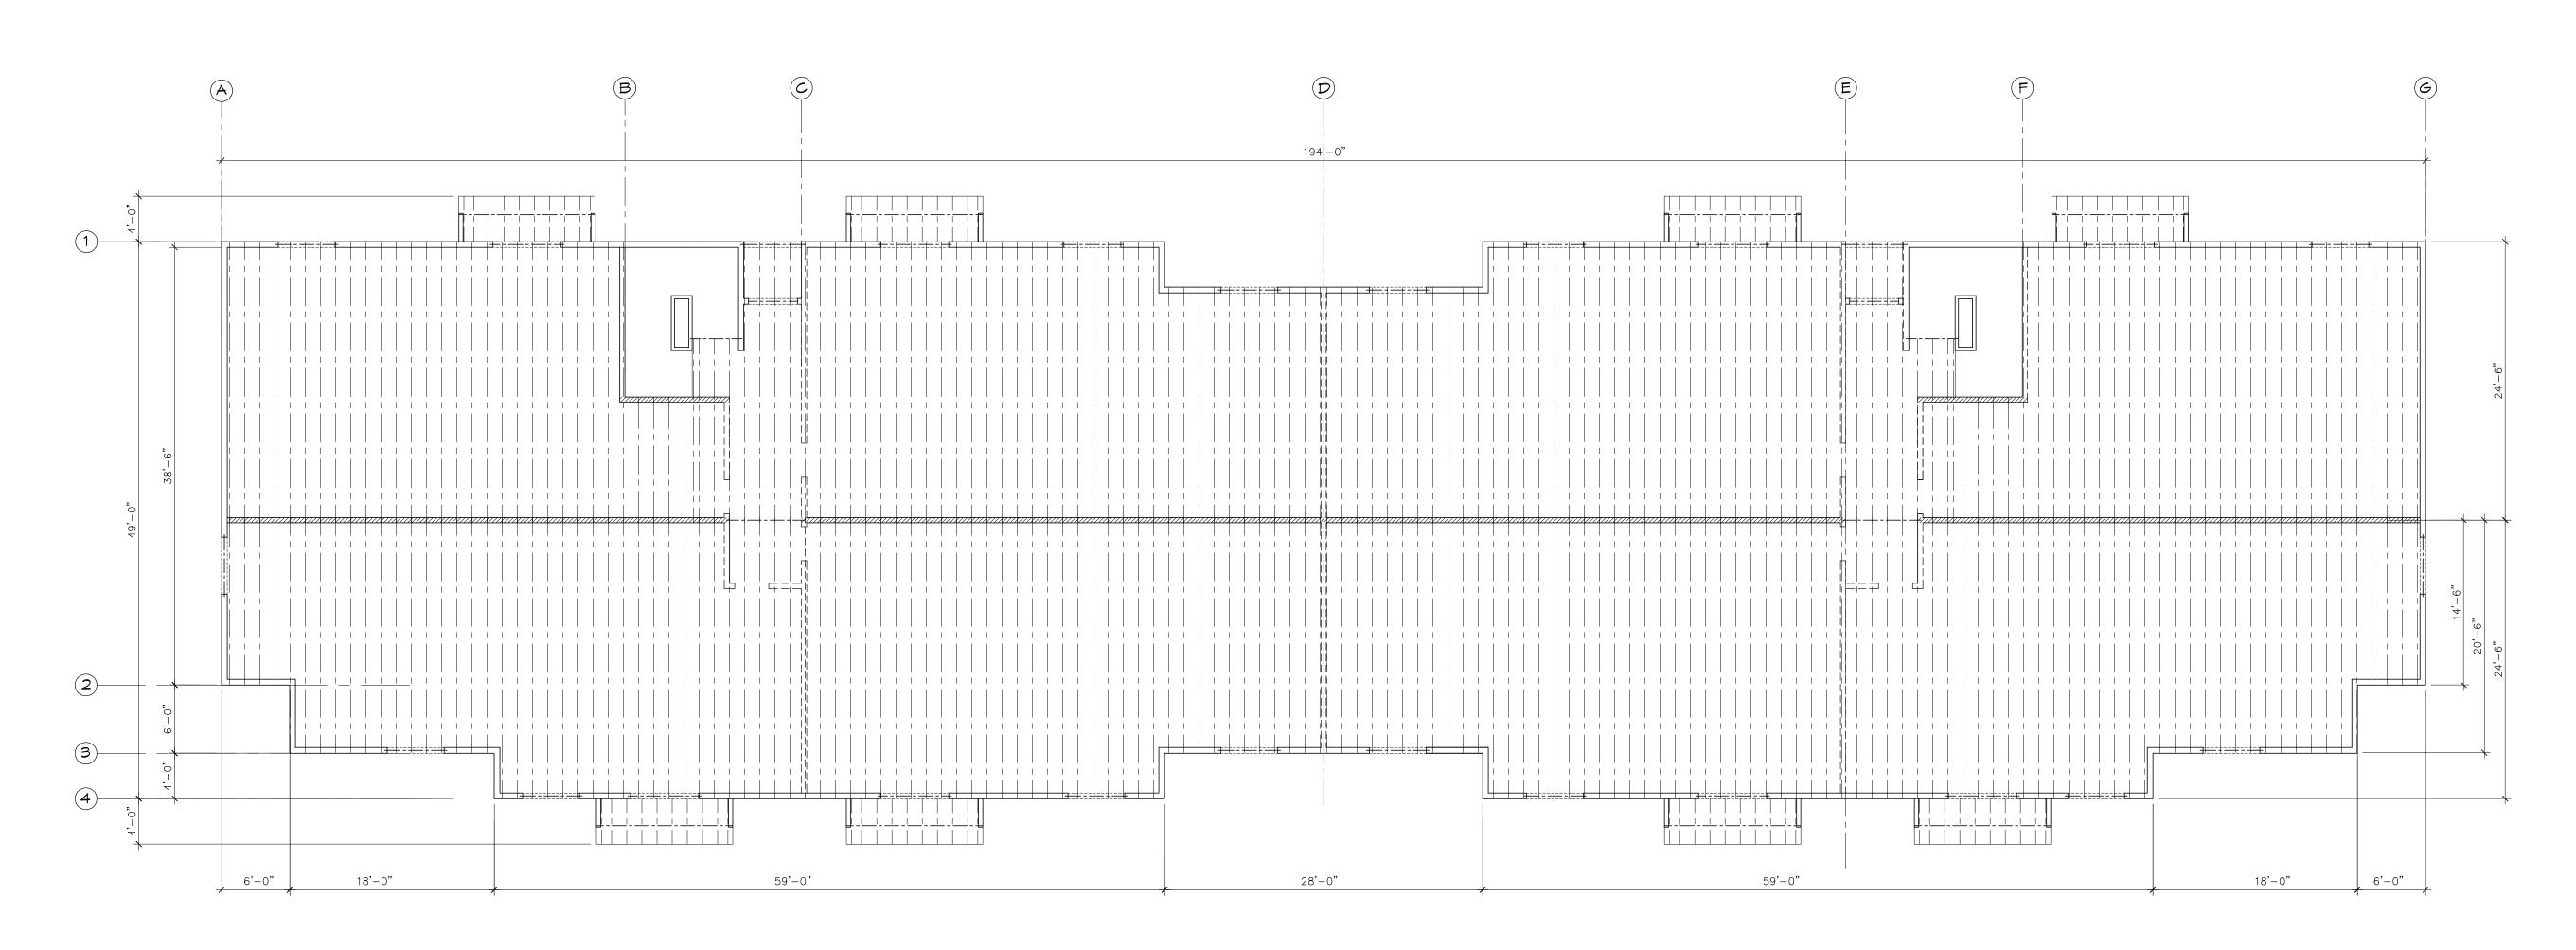

# 2 SECOND FLOOR FRAMING PLAN 1/8" = 1'-0"

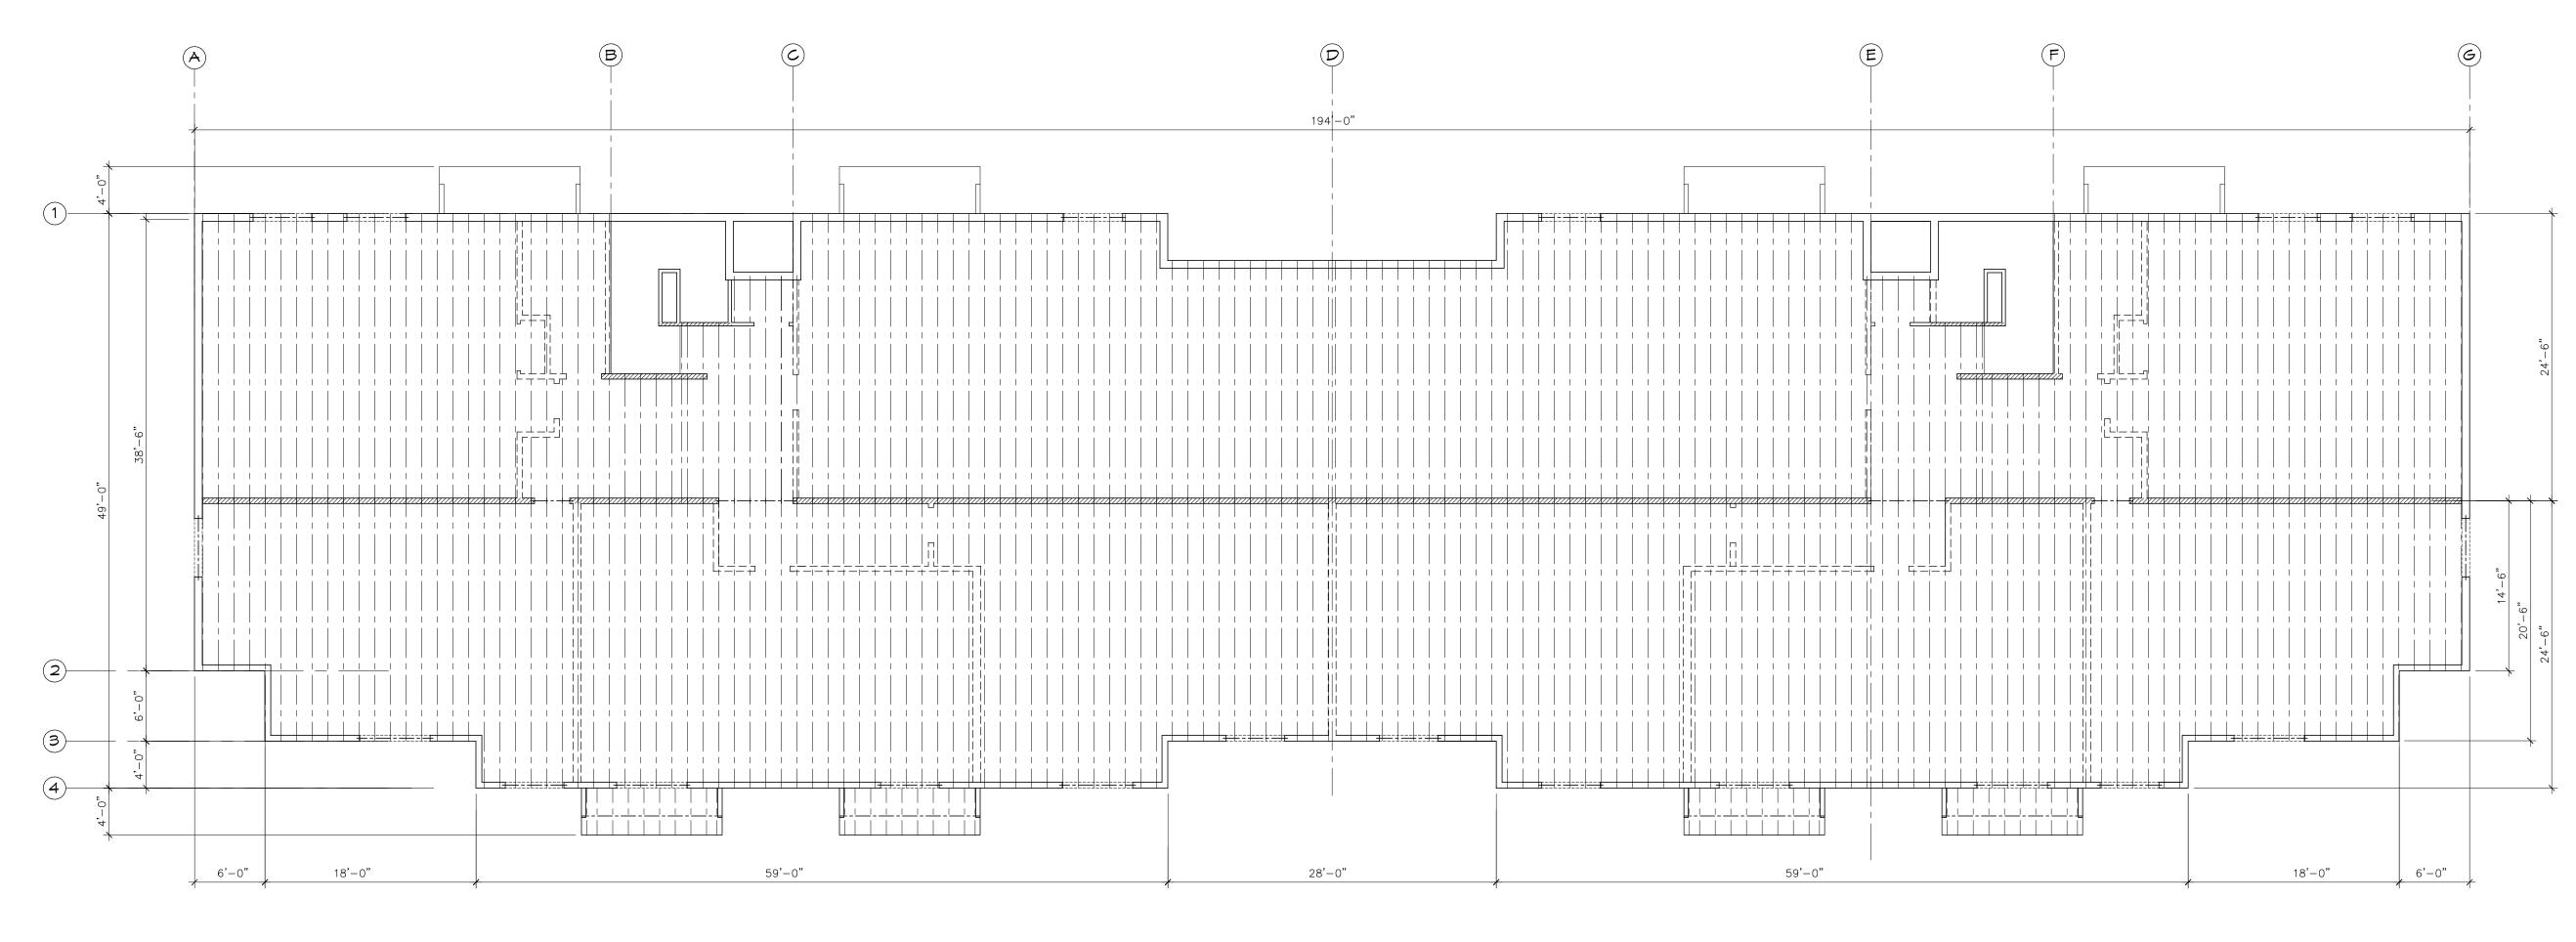



APTS 60 2 E 0 19 HWY PROJE HWY LaCrc PROJECT NO: 18-04 DRAWING DATE: 12/20/18 DRAWN BY: ESKAY LLC SET TYPE: Prelim REVISIONS SHEET TITLE FLOOR FRAMING PLANS






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	san — san — san — gan	1000 SF RECREATIO	OF DN SPACE
	EA EA		
		en e	COUP,
			es es

OWNER CT REAL EST INVESTMENT,	=				
PROJECT ADE 1440 STATE					
PROPOSED U	NING: TND GENERAI SE: TND SPECIFIC I NG AREA: 12,570	MULTI-FA	MILY RES	IDENTIAL	
EXISTING	IMPERVIOUS P 0.18 ACRE 0 0.59 ACRE 0	.73 ACRE	E 0.91	<u>AL</u> ACRE ACRE	
ADJACENT SOUTH WEST NORTH EAST	STH 16 RESIDENTIAL	L			
OFF-STREET ADA PARKIN	PARKING REQUIREI PARKING PROVIDEI G PROVIDED RKING PROVIDED	D 36 2			
	CREATIONAL SPACE CREATIONAL SPACE		1000 SF 1000 SF		




HAWK'S NEST SUNSET COURT ONALASKA, WI

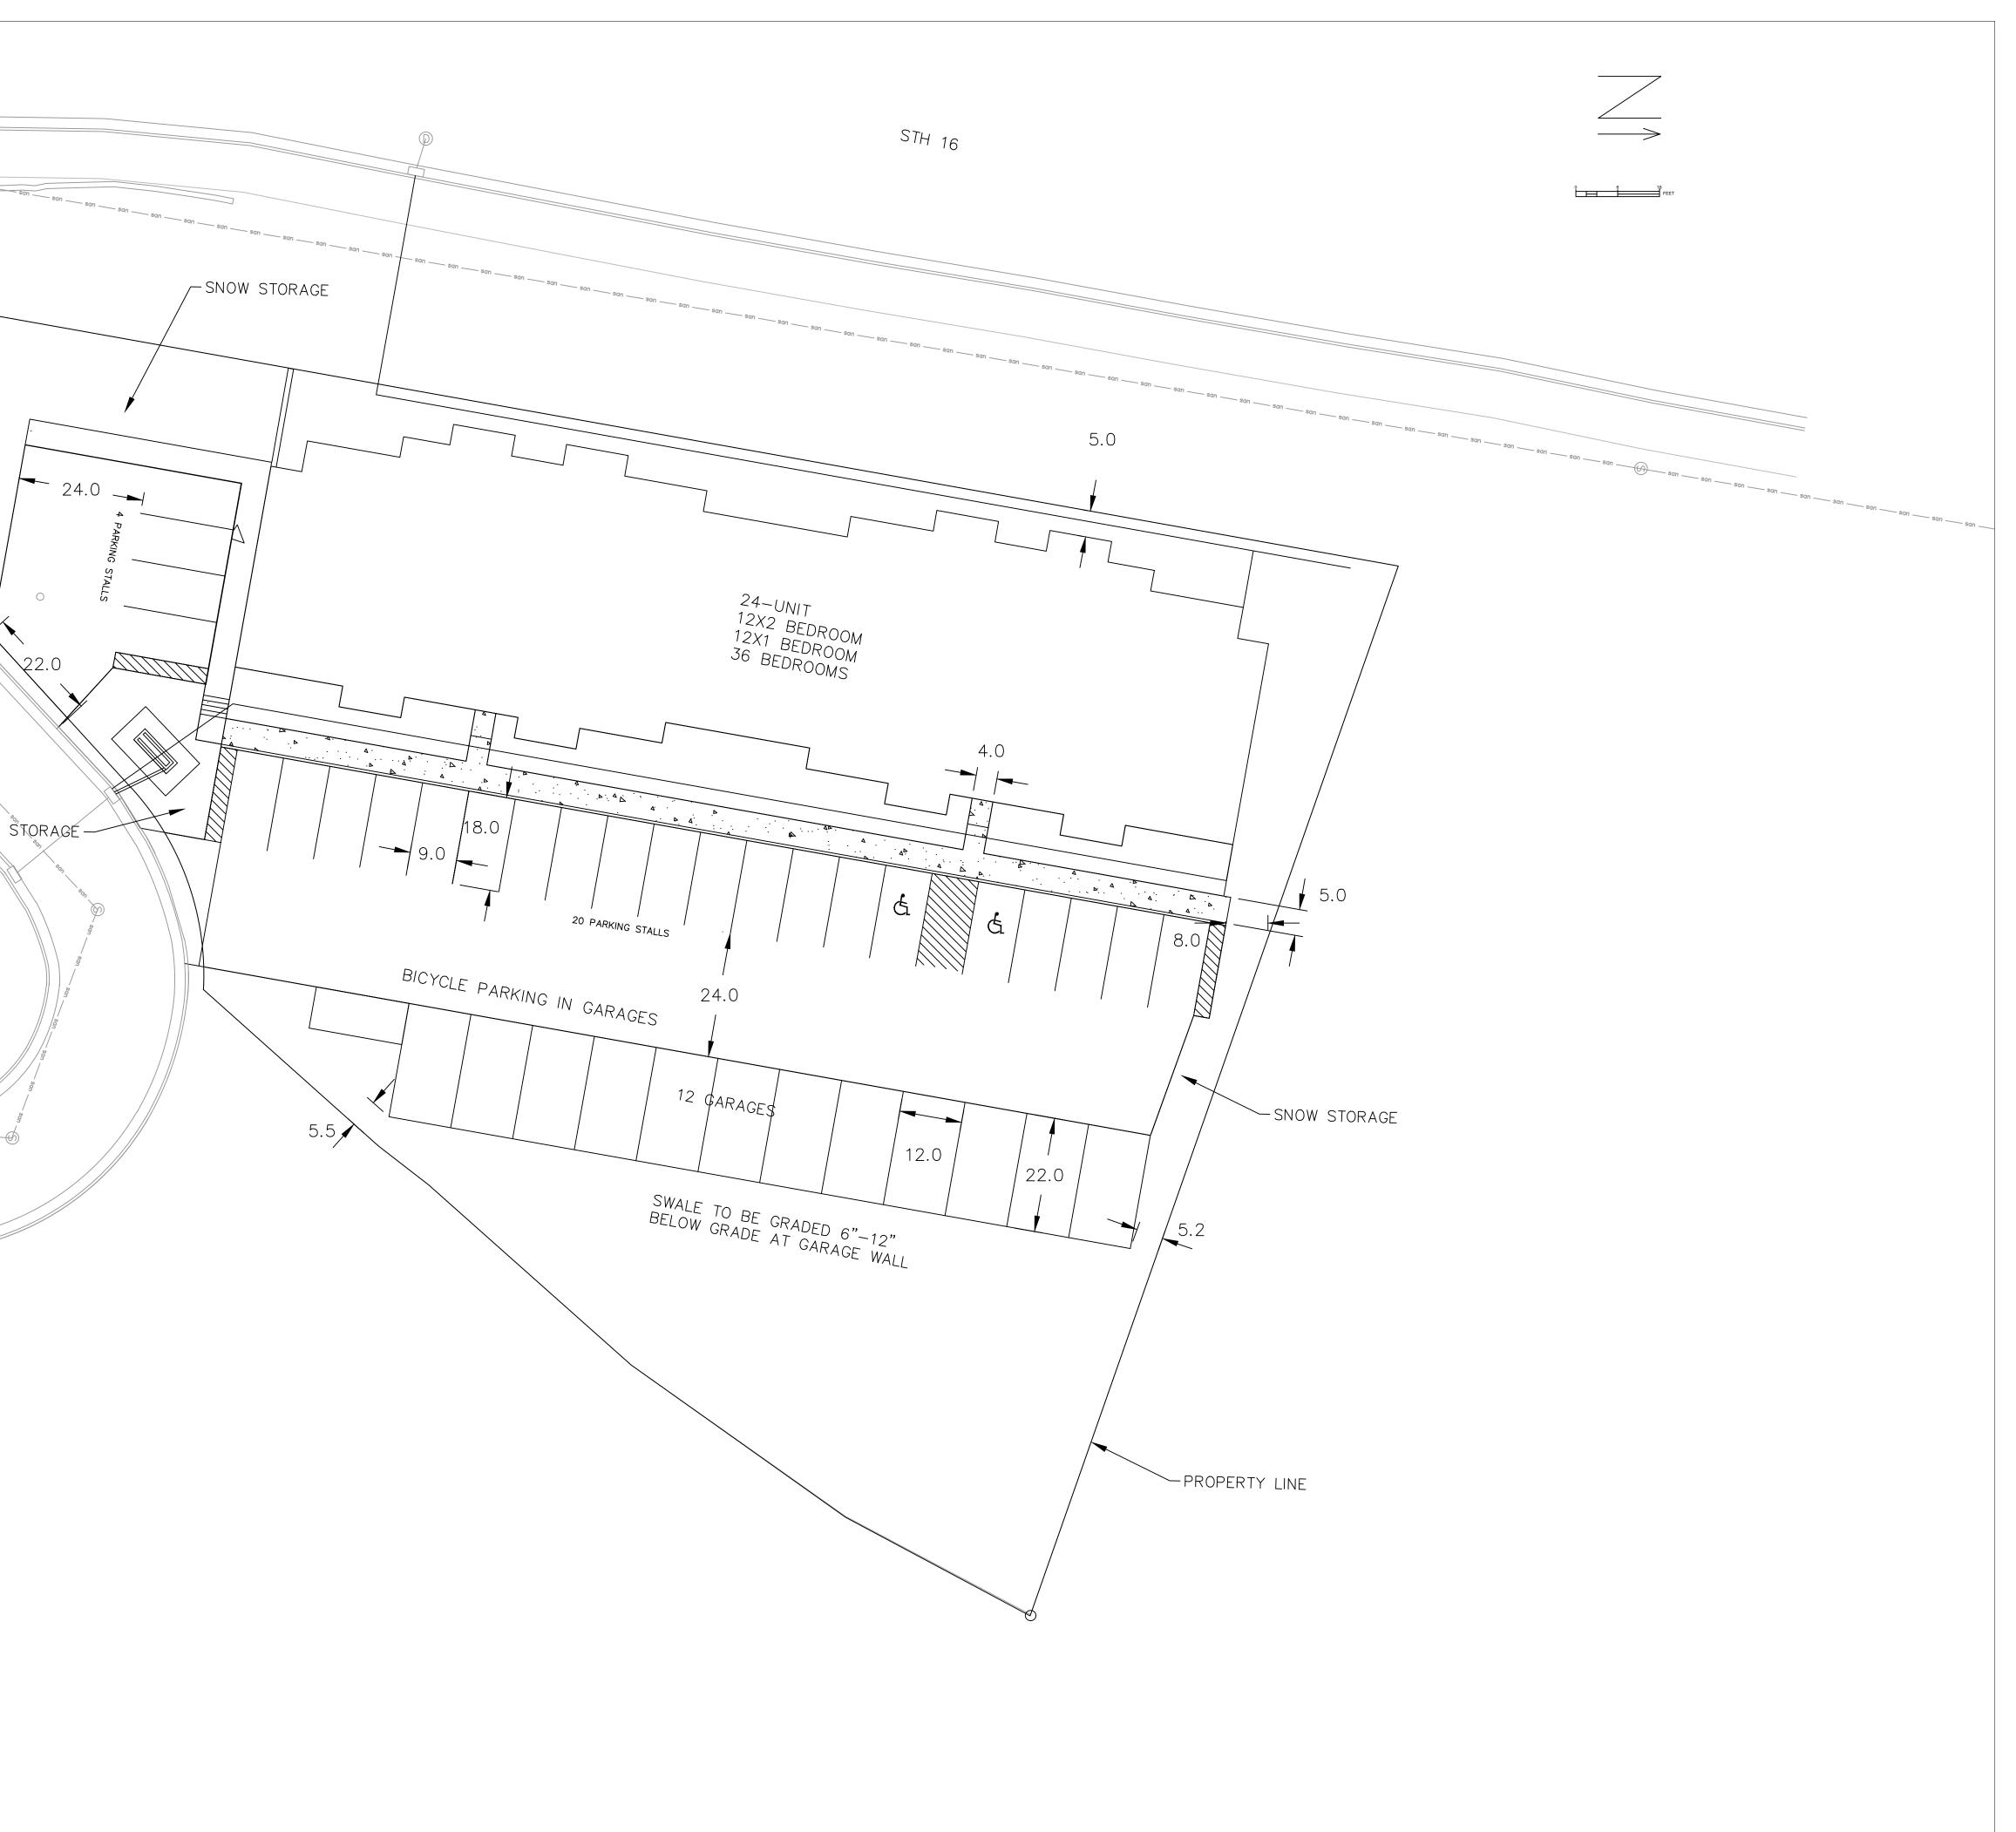

SITE PLAN

 1			
DATE	REVISION	DESCR.	
			C101

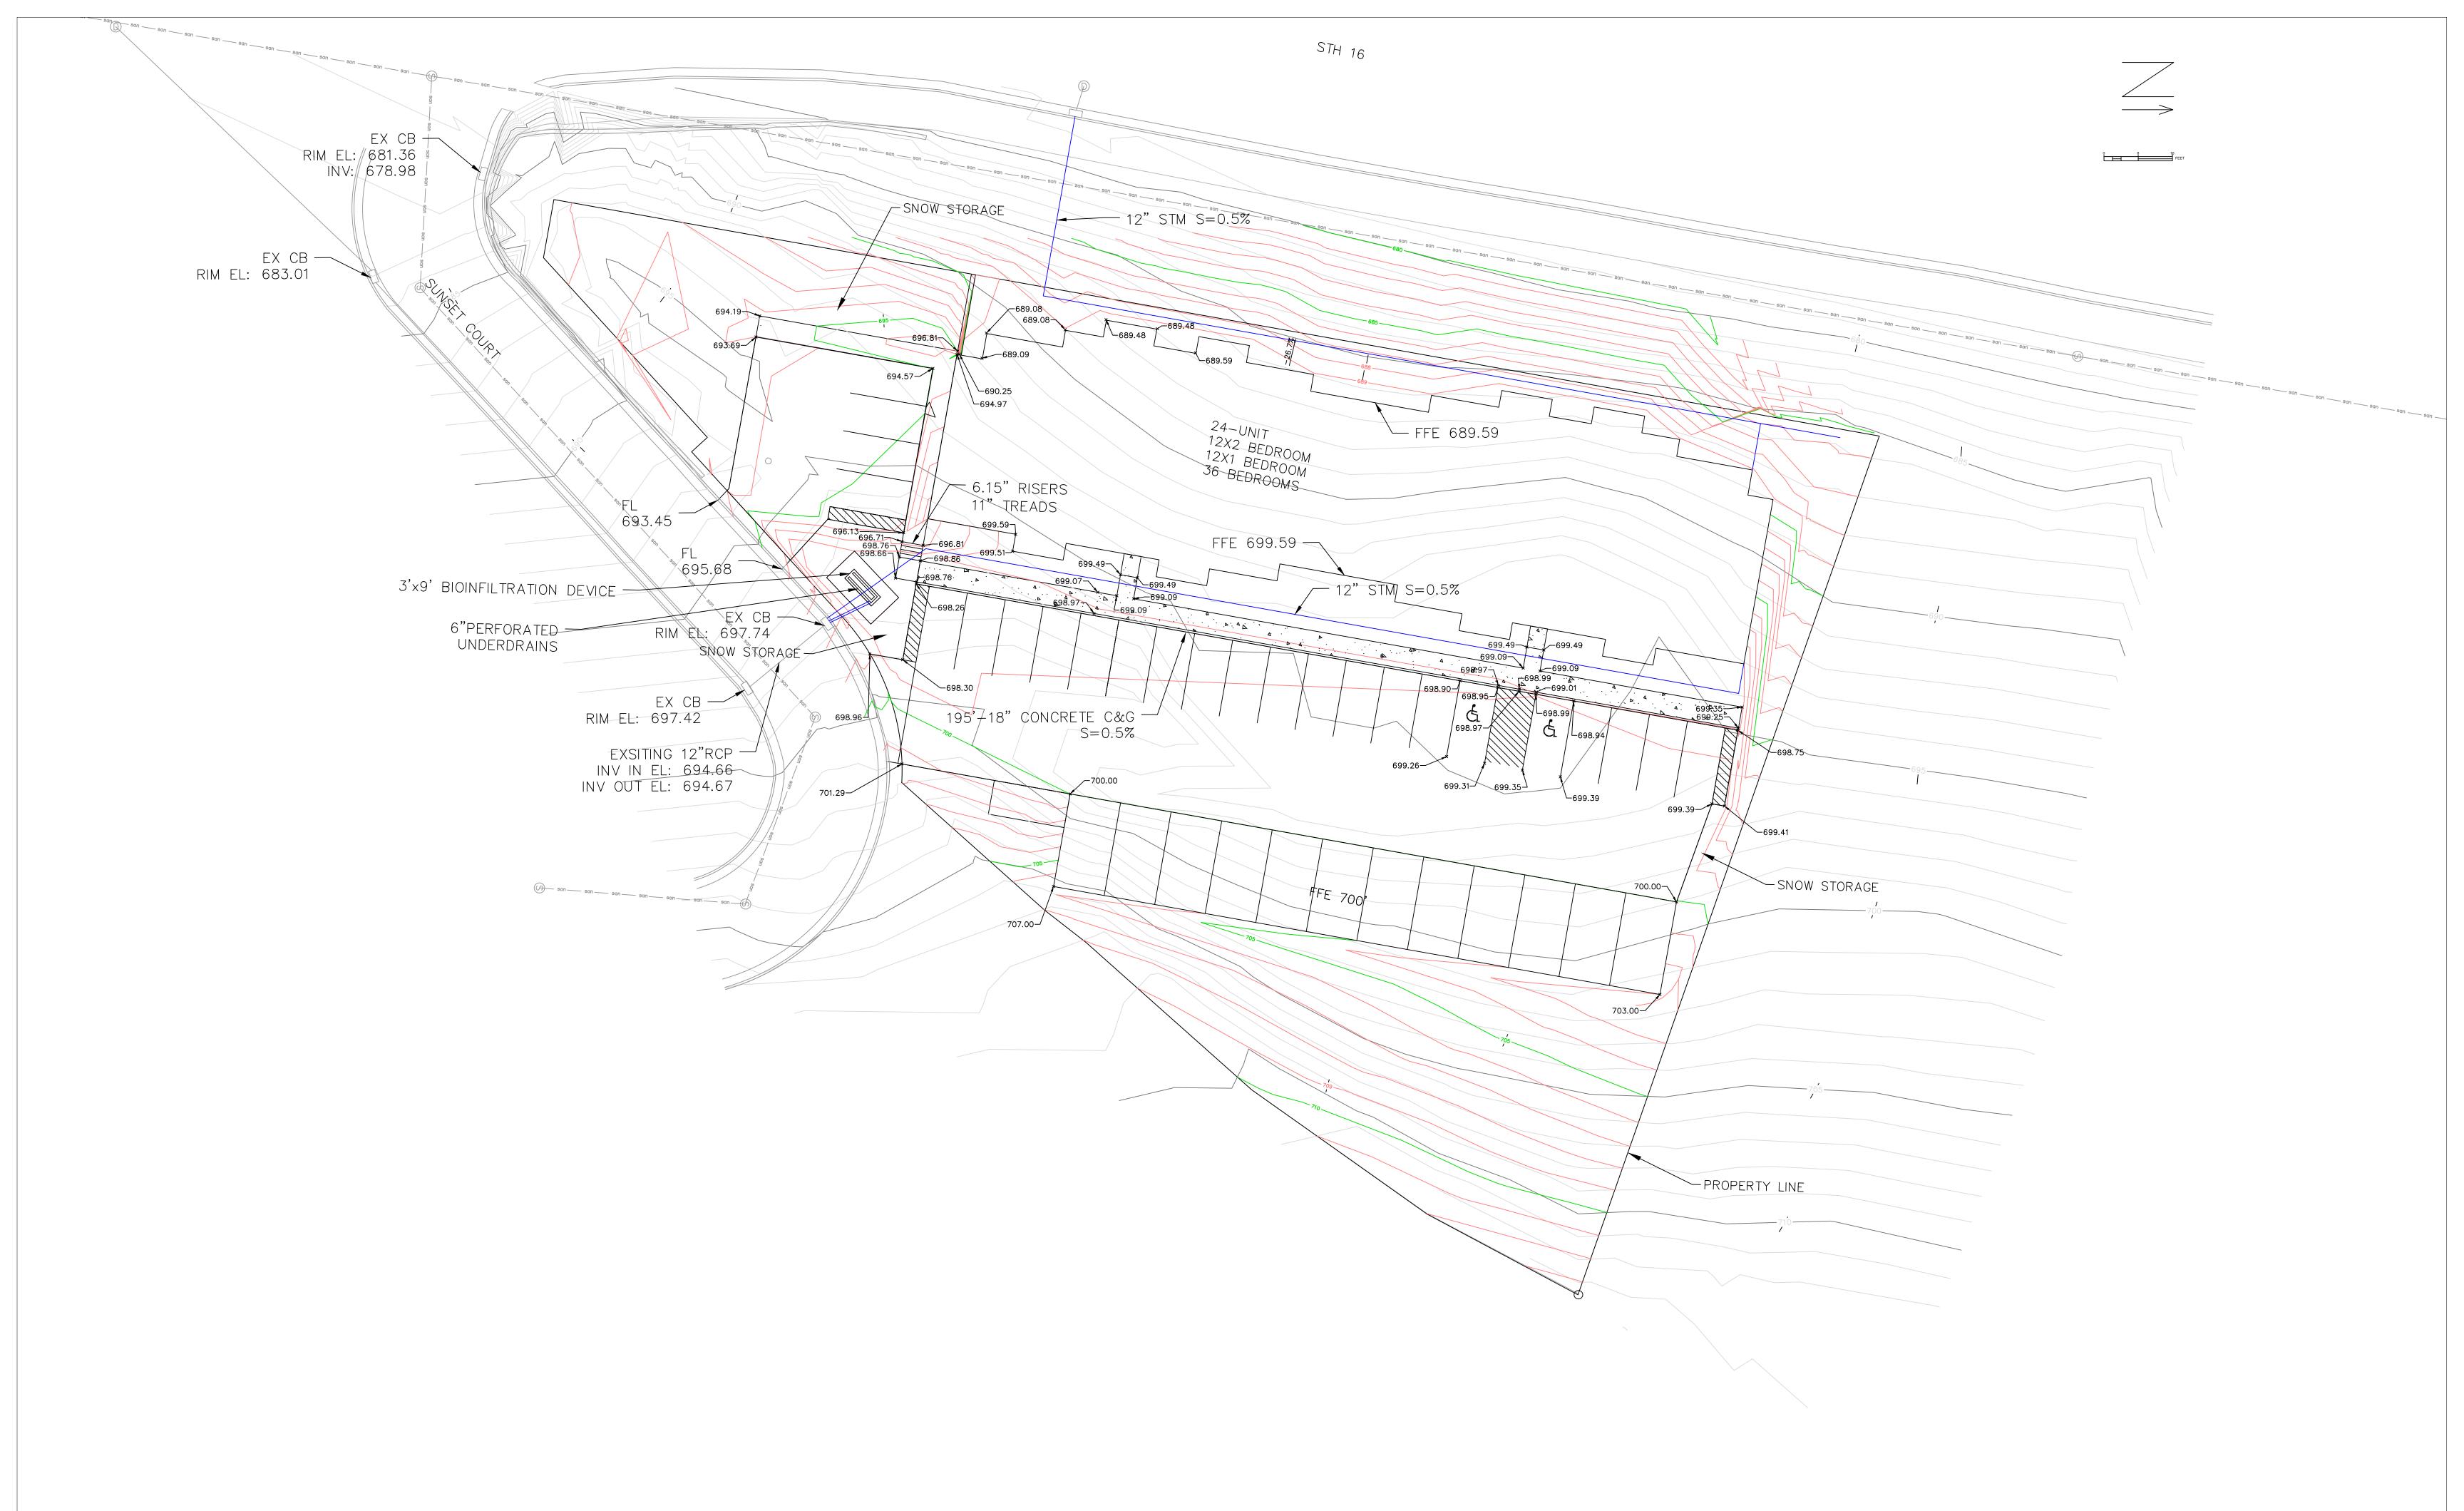



HAWK'S NEST SUNSET COURT ONALASKA, WI



12/20/2018

GRADING PLAN

DAIL	REVISION	DESCR.	
			C102


### INLET PROTECTION -----

# <u>Plan sheet legend</u>

•	SILT FENCE (DNR TECH. STD. 1056)
+         +         +         +           +         +         +         +         +           +         +         +         +         +           +         +         +         +         +	SEED, MULCH, FERTILIZE W/ LAWN MIX (DNR TECH. STD. 1058, 1059)
	DITCH CHECK (DNR TECH. STD. 1062)
	INLET PROTECTION (DNR TECH. STD.1060)
	CONSTRUCTION ENTRANCE (DNR TECH. STD.1057)

EROSION CONTROL & GRADING NOTES

- 1. THE PROJECT IS GREATER THAN ONE ACRE. AN NPDES PERMIT IS REQUIRED. . EROSION CONTROL SHALL MEET CITY OF LA CROSSE STANDARDS.
- 3. THIS EROSION CONTROL PLAN HAS BEEN PREPARED AS A GUIDE. ADDITIONAL EROSION CONTROL MEASURES MAY BE REQUIRED. CONTRACTOR SHALL MAINTAIN, MODIFY, AND IMPLEMENT AN ALTERNATE EROSION CONTROL PLAN BASED ON THEIR MEANS & METHODS, 4. DOWN-SLOPE SEDIMENT CONTROLS SHALL BE INSTALLED PRIOR TO ANY LAND DISTURBANCE OR
- GRADING, AND SHALL REMAIN AND BE MAINTAINED TO ENSURE PROPER FUNCTION UNTIL SLOPED AREAS ARE STABILIZED AND SITE IS 100% VEGETATED. . CONTRACTOR SHALL ADJUST THE APPROPRIATE STRUCTURAL AND NON-STRUCTURAL BMP'S
- BASED ON CONSTRUCTION PROGRESS. CONTRACTOR SHALL PROVIDE APPROPRIATE PLANNING AND MEASURES TO PREVENT POLLUTION FROM CONSTRUCTION SITE OPERATIONS INCLUDING BUT NOT LIMITED TO MATERIALS, STAGING, WASTE, WASHOUT AREAS, EQUIPMENT FUELING AND MAINTENANCE, AND SPILL PREVENTION AND CONTROL.
- 6. A COPY OF THIS EROSION CONTROL PLAN SHALL BE KEPT ON-SITE DURING ALL LAND DISTURBING CONSTRUCTION ACTIVITIES. 7. STOCKPILES SHALL BE STABILIZED WITH COVER CONTROL AND PERIMETER PROTECTION WITHIN 7
- DAYS. 8. ALL EXPOSED SOILS SHALL BE STABILIZED WITHIN 7 DAYS OF GRADING COMPLETION.
- 9. ADJACENT STREETS AND ROADWAYS SHALL BE SWEPT TO KEEP THEM FREE OF SEDIMENT. ANY SEDIMENT DEPOSITED ON PUBLIC STREETS, ORIGINATING FROM THE PROJECT SITE, SHALL BE REMOVED IMMEDIATELY.
- 10. TEMPORARY COVER ON DISTURBED AREAS SHALL INCLUDE SEED MIX COVER CROP AND MID-TERM STABILIZATION SEED FROM WISDOT STANDARD SPECIFICATIONS. ALL SLOPES >200' OR >5% SHALL INCLUDE DISK ANCHORED MULCH. 11. PIPE OUTLETS MUST INCLUDE ENERGY DISSIPATION DEVICES WITHIN 24 HOURS OF BEING PUT
- INTO SERVICE. 12. THE NORMAL WETTED PERIMETER OF ANY TEMPORARY OR PERMANENT DRAINAGE DITCH OR SWALE THAT DRAINS WATER FROM ANY PORTION OF THE CONSTRUCTION SITE, OR DIVERTS WATER AROUND THE SITE, MUST BE STABILIZED WITHIN 200 LINEAR FEET FROM THE PROPERTY
- EDGE, OR FROM THE POINT OF DISCHARGE INTO ANY SURFACE WATER WITHIN 24 HOURS AFTER CONNECTING TO A SURFACE WATER. 13. UNLESS INDICATED OTHERWISE, ALL DISTURBED AREAS WHICH ARE NOT FINISHED WITH ASPHALT,
- CONCRETE, BIOFILTER PLANTING, OR OTHER PLANTS AS INDICATED ON THE LANDSCAPE PLAN SHALL BE FINISHED WITH LAWN TURF. PERMANENT LAWN COVER SHALL INCLUDE MINIMUM 4" TOPSOIL, SEED MIX AND MULCH SHALL BE PER WISDOT STANDARD SPECIFICATIONS. 14. SLOPES STEEPER THAN 3:1 SHALL BE SEEDED AND PROTECTED WITH EROSION CONTROL BLANKETS. BLANKETS SHALL MEET WISCONSIN PALS LIST.
- 15. ALL PROPOSED SURFACE ELEVATIONS SHOWN ARE TO FINISHED GRADE UNLESS NOTED OTHERWISE. PROPOSED ELEVATIONS ARE PROVIDED TO PROMOTE POSITIVE DRAINAGE TOWARD INLETS AND BIOFILTERS. CONTRACTOR SHALL MAINTAIN POSITIVE DRAINAGE TOWARD INLETS.
- 16. IF EROSION MATTING WILL BE USED FOR THIS PROJECT, USE THE FOLLOWING MATTING (OR SOMETHING SIMILAR): AMERICAN EXCELSIOR "FIBRENET" OR "NETFREE" PRODUCTS; EAST COAST EROSION BIODEGRADABLE JUTE PRODUCTS; EROSION TECH BIODEGRADABLE JUTE PRODUCTS; EROSIONCONTROLBLANKET.COM BIODEGRADABLE LENO WEAVE PRODUCTS; NORTH AMERICAN GREEN S75BN, S150BN, SC150BN OR C125BN; OR WESTERN EXCELSIOR "ALL NATURAL" PRODUCTS

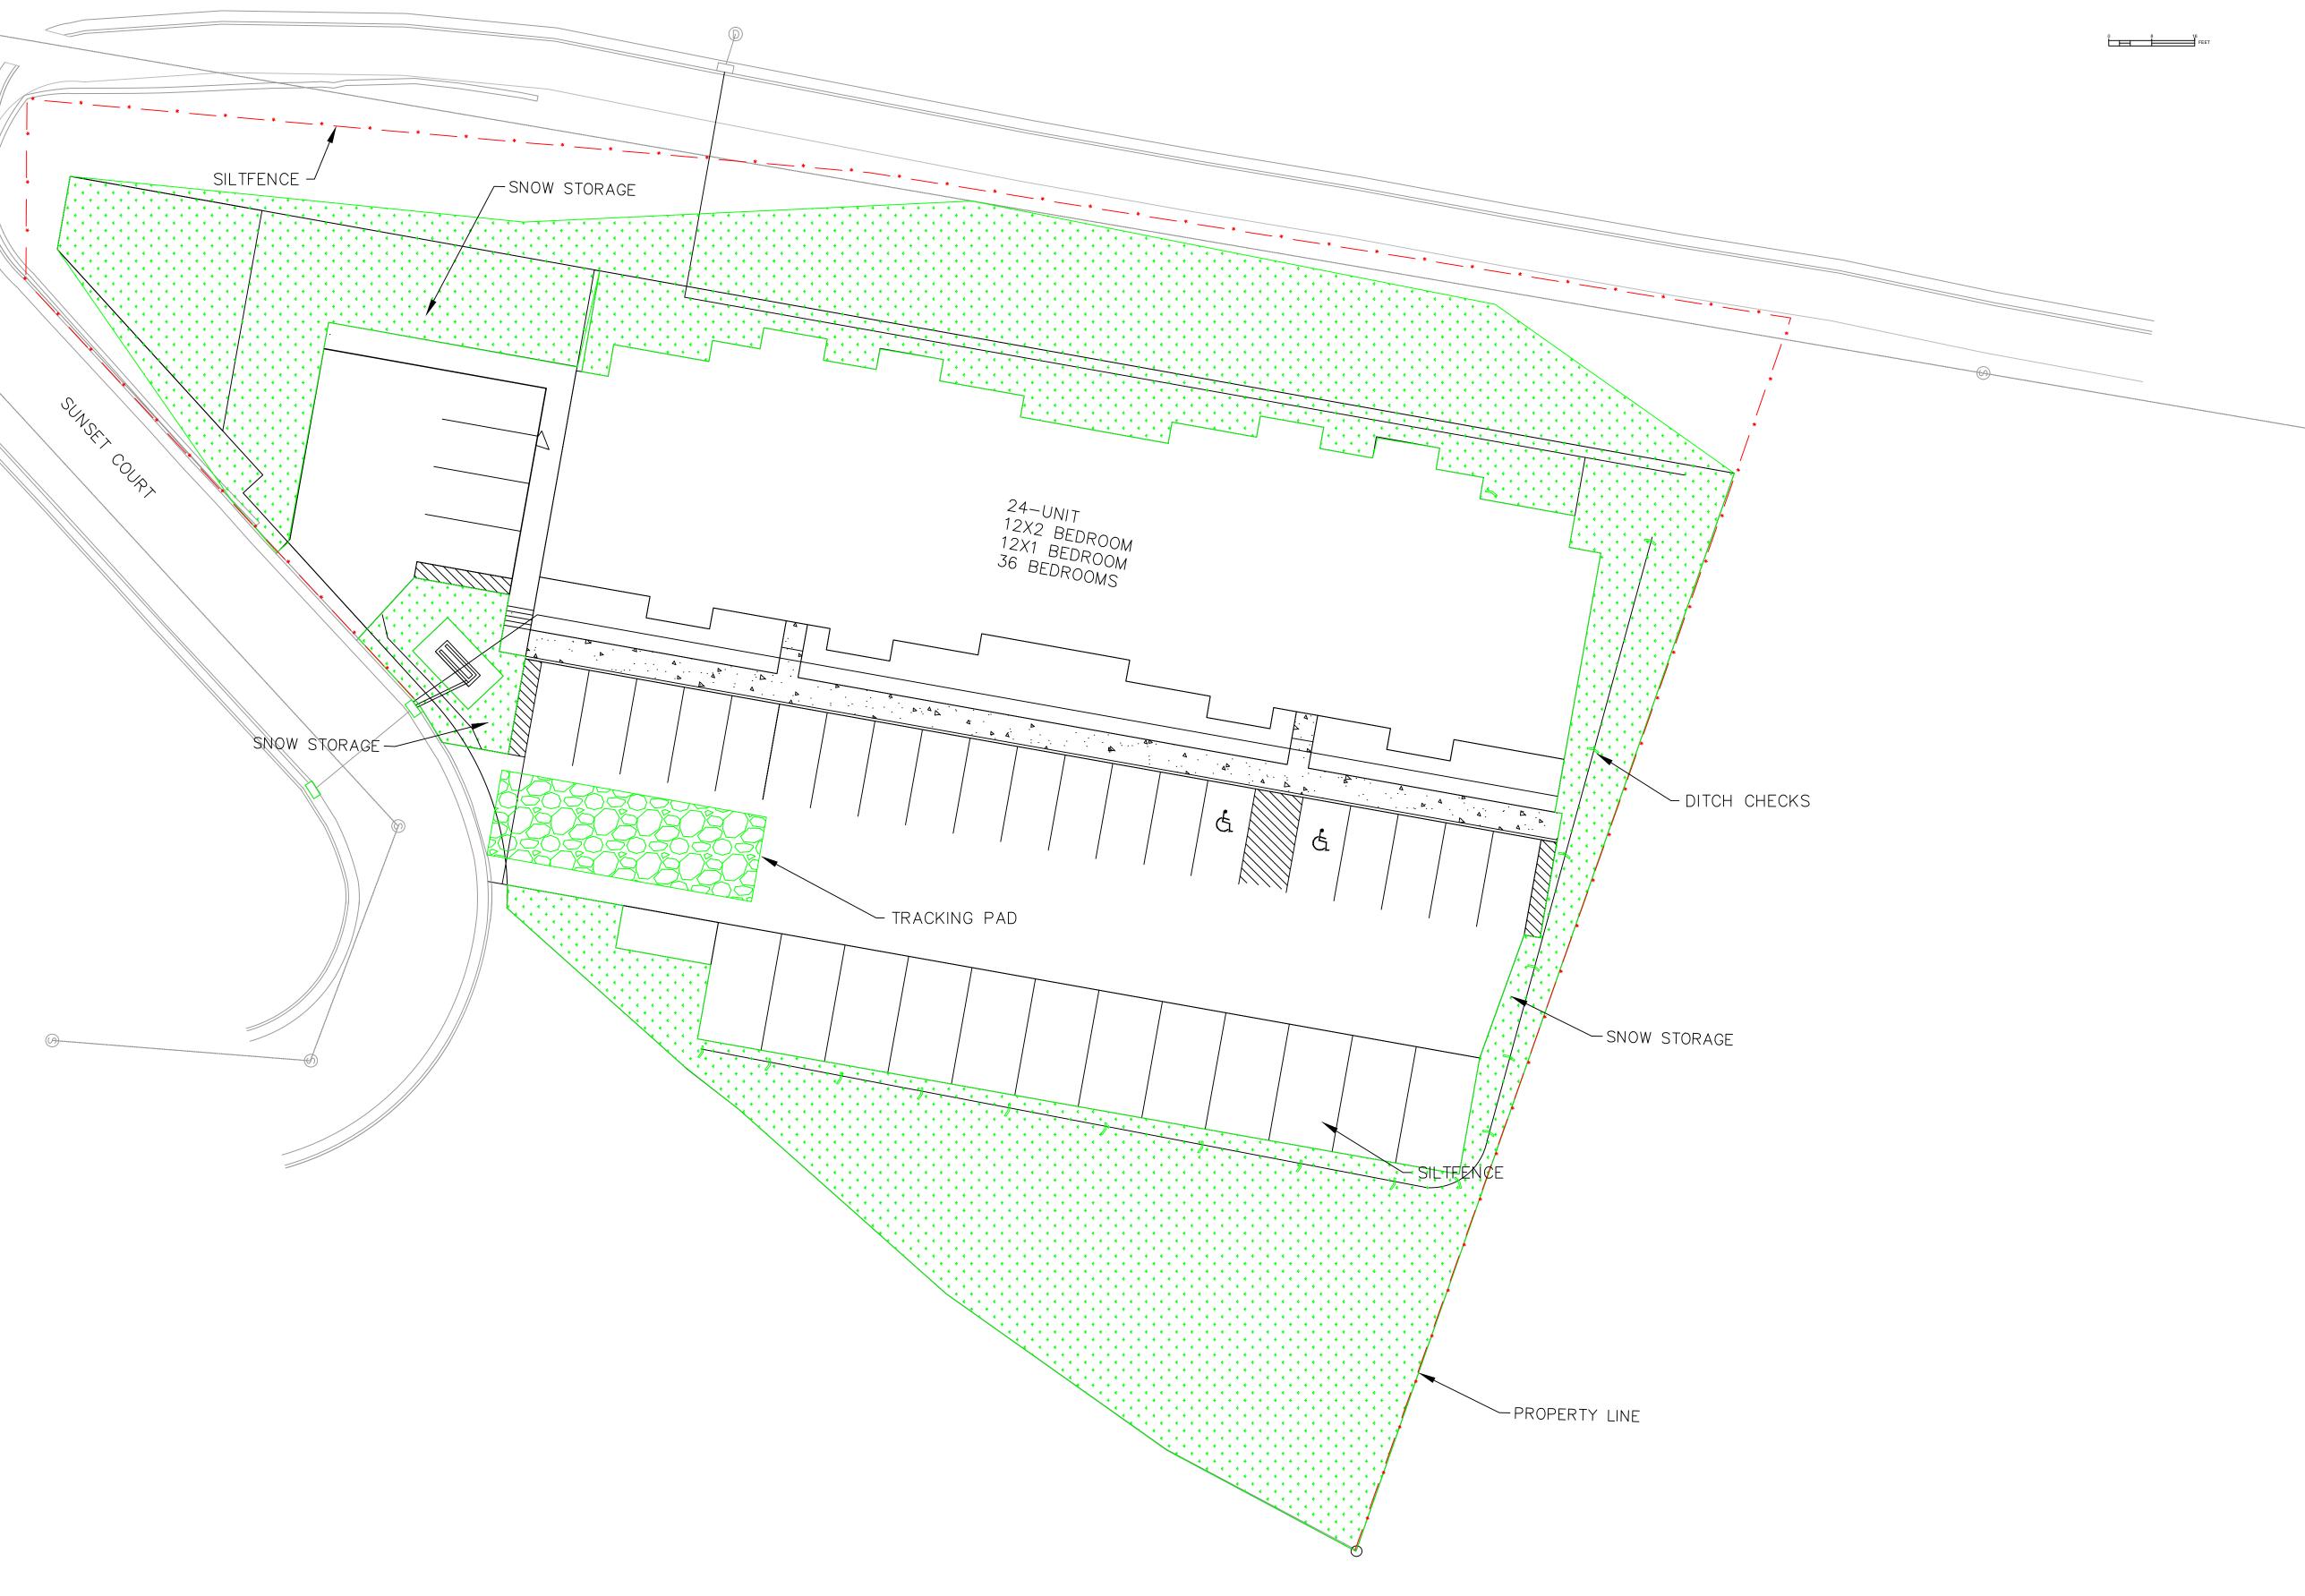





ONALASKA, WI 54650 608.797.1025


HAWK'S NEST SUNSET COURT ONALASKA, WI



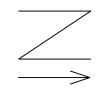

	DATE REVISION DESCR	•
EROSION CONTROL PLAN		C103

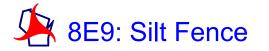

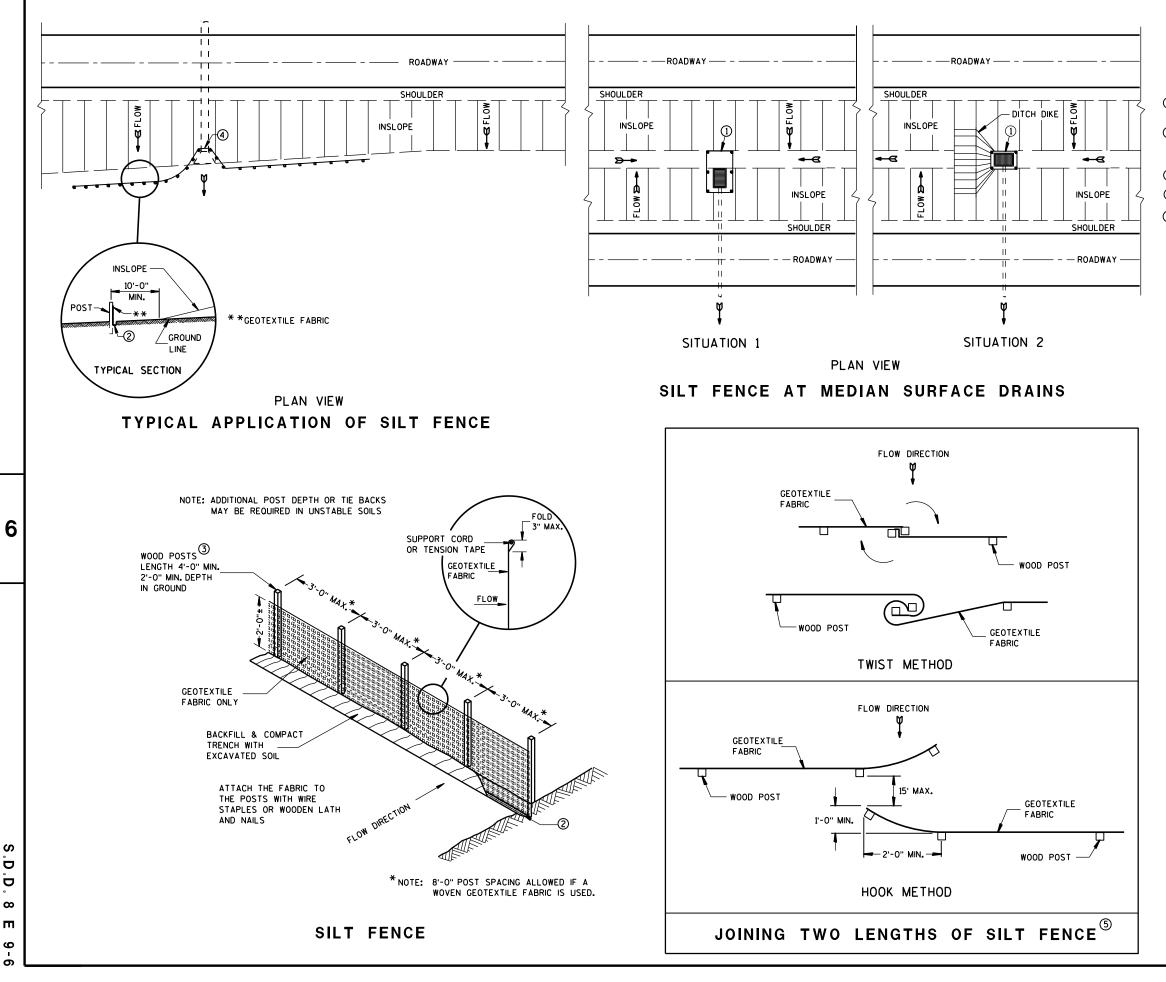


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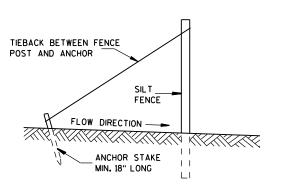
### **GENERAL NOTES**

DETAILS OF CONSTRUCTION NOT SHOWN ON THIS DRAWING SHALL CONFORM TO THE PERTINENT REQUIREMENTS OF THE STANDARD SPECIFICATIONS AND APPLICABLE SPECIAL PROVISIONS.

- () HORIZONTAL BRACE REQUIRED WITH 2" X 4" WOODEN FRAME OR EQUIVALENT AT TOP OF POSTS.
- (2) FOR MANUAL INSTALLATIONS THE TRENCH SHALL BE A MINIMUM OF 4" WIDE & 6" DEEP TO BURY AND ANCHOR THE GEOTEXTILE FABRIC. FOLD MATERIAL TO FIT TRENCH AND BACKFILL & COMPACT TRENCH WITH EXCAVATED SOIL.
- (3) WOOD POSTS SHALL BE A MINIMUM SIZE OF  $1\frac{1}{8}$ " X  $1\frac{1}{8}$ " OF OAK OR HICKORY.
- (4) SILT FENCE TO EXTEND ACROSS THE TOP OF THE PIPE.
- (5) CONSTRUCT SILT FENCE FROM A CONTINUOUS ROLL IF POSSIBLE BY CUTTING LENGTHS TO AVOID JOINTS. IF A JOINT IS NECESSARY USE ONE OF THE FOLLOWING TWO METHODS; A) OVERLAP THE END POSTS AND TWIST, OR ROTATE, AT LEAST 180 DEGREES, B) HOOK THE END OF EACH SILT FENCE LENGTH.



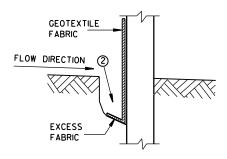




### SILT FENCE TIE BACK (WHEN REQUIRED BY THE ENGINEER)

	SILT FENCE	9 - 0
DEPA	STATE OF WISCONSIN RTMENT OF TRANSPORTATION	L a
APPROVED		1,
4-29-05	/S/ Beth Cannestra	-
DATE	CHIEF ROADWAY DEVELOPMENT ENGINEER	2
FHWA		J u

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# 8E10: Inlet Protection Type A, B, C and D

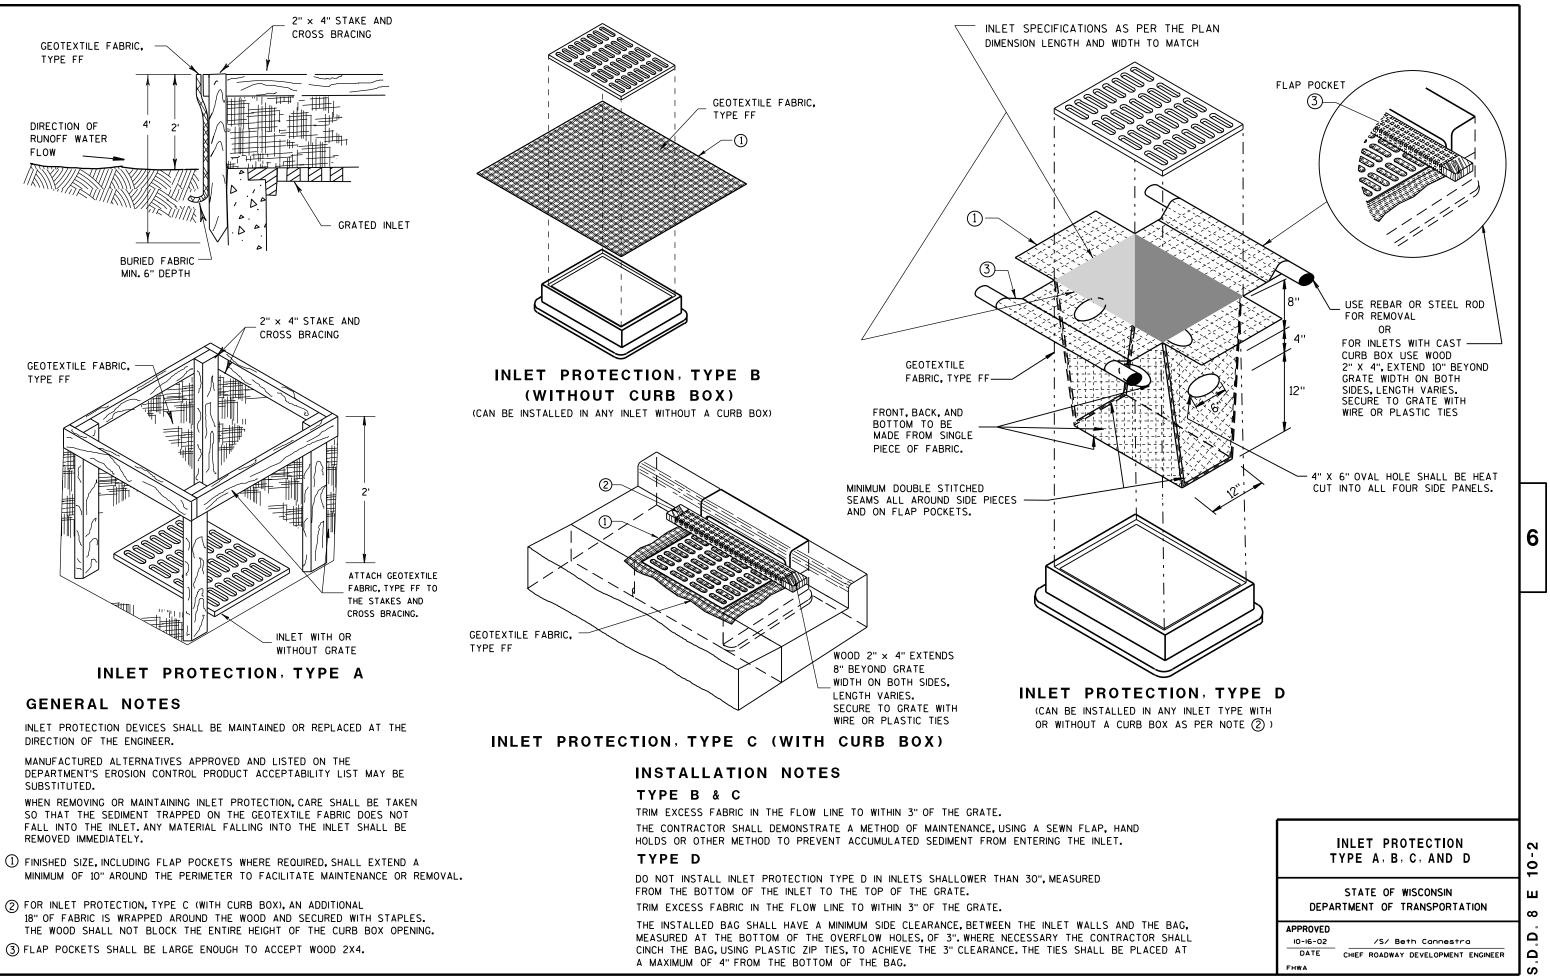


S.D.D. 8 E 10

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# 8E14: Tracking Pad



S D D ω m 14

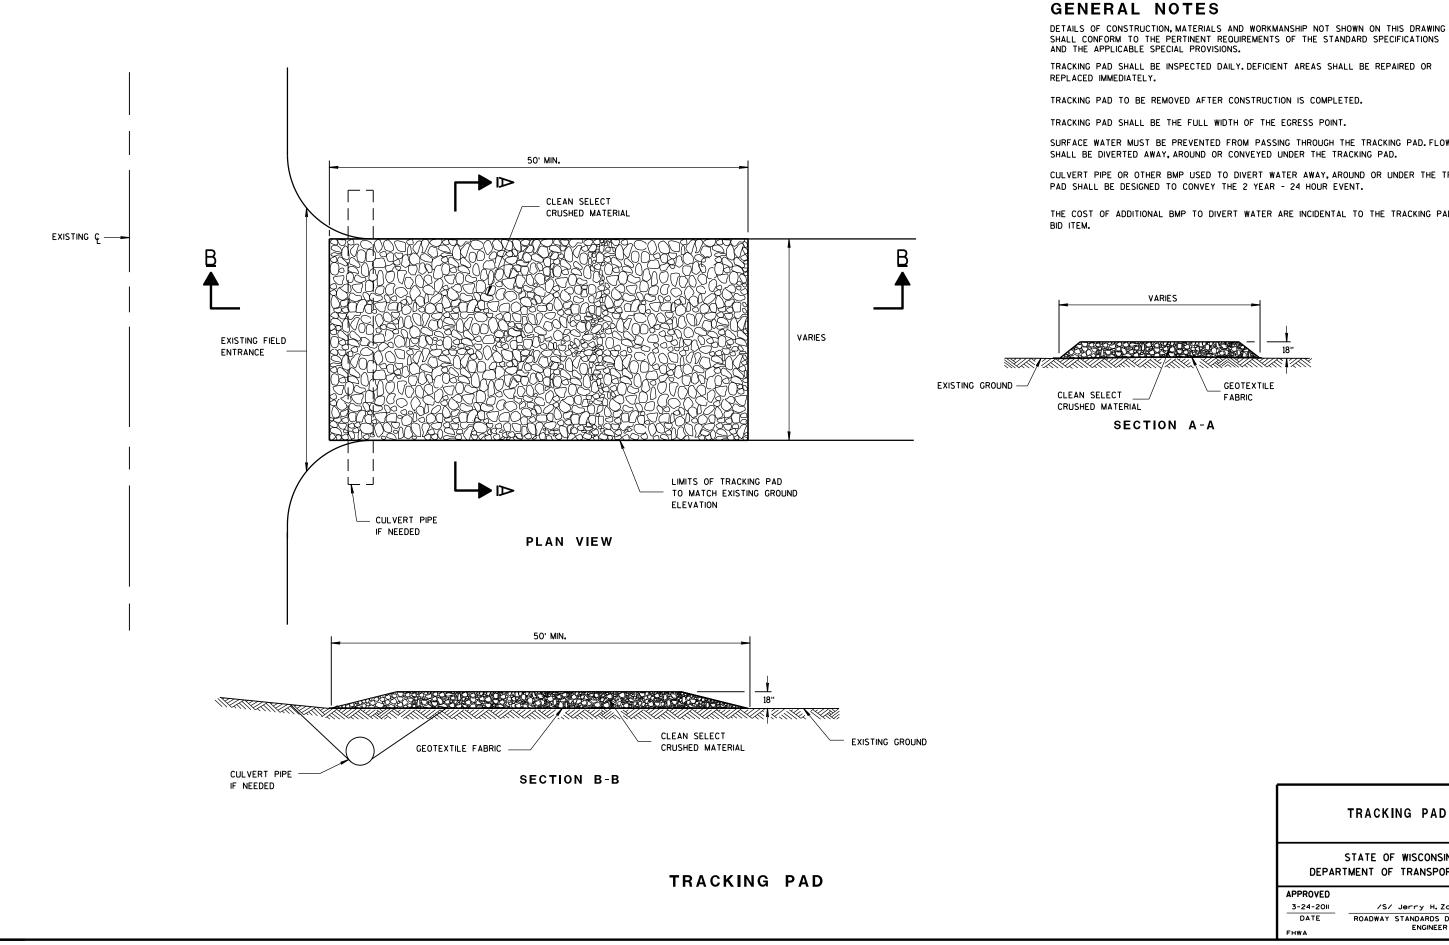6

SHALL CONFORM TO THE PERTINENT REQUIREMENTS OF THE STANDARD SPECIFICATIONS AND THE APPLICABLE SPECIAL PROVISIONS.

SURFACE WATER MUST BE PREVENTED FROM PASSING THROUGH THE TRACKING PAD. FLOWS

CULVERT PIPE OR OTHER BMP USED TO DIVERT WATER AWAY, AROUND OR UNDER THE TRACKING

THE COST OF ADDITIONAL BMP TO DIVERT WATER ARE INCIDENTAL TO THE TRACKING PAD

6

# TRACKING PAD STATE OF WISCONSIN


DEPARTMENT OF TRANSPORTATION

3-24-2011 DATE

/S/ Jerry H.Zogg ROADWAY STANDARDS DEVELOPMENT ENGINEER

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KEY	QTY.	BOTANICAL NAME	COMMON NAME	SIZE	ROOT
A	2	Acer fremanii 'Autumn Blaze'	AUTUMN BLAZE MAPLE	3"	BB
В		Acer saccharum 'Bailsta'	FALL FIESTA SUGAR MAPLE	311	BB
С		Quercis bicolor	SWAMP WHITE OAK	311	BB
Þ		Quercis macrocarpa	BUR OAK	3"	BB
Ш	2	Quercis rubra	NORTHERN RED OAK	3"	BB
۴		Buxus 'Green Velvet'	GREEN VELVET BOXWOOD	5 GAL.	CONT,
G	2	Hydrangea paniculata 'Limelight'	LIMELIGHT HYDRANGEA	5 GAL.	CONT.
Н	6	Spirea 'Mertyann'	DAKOTA GOLDCHARM SPIREA	5 GAL.	CONT,
	6	Spirea betulifolia 'Tor'	TOR BIRCHLEAF SPIREA	5 GAL.	CONT.
J	6	Spirea betulifolia 'Tor Gold'	GLOW GIRL SPIREA	5 GAL.	CONT.
K	2	Syringa meyeri 'Paliban'	DWARF KOREAN LILAC	5 GAL.	CONT.
L	6	Thuja occidentalis 'Bobozam'	MR. BOWLINGBALL ARORBORVITAE	5 GAL.	CONT,
Μ	7	Thuja occidentalis 'Nigra'	AMERICAN DARK GREEN ARBORVIYTAE	5'	BB
Ν		Weiqela florida 'Alexandra'	WINE & ROSES WEIGELA	5 GAL.	CONT.

## PLANT LIST
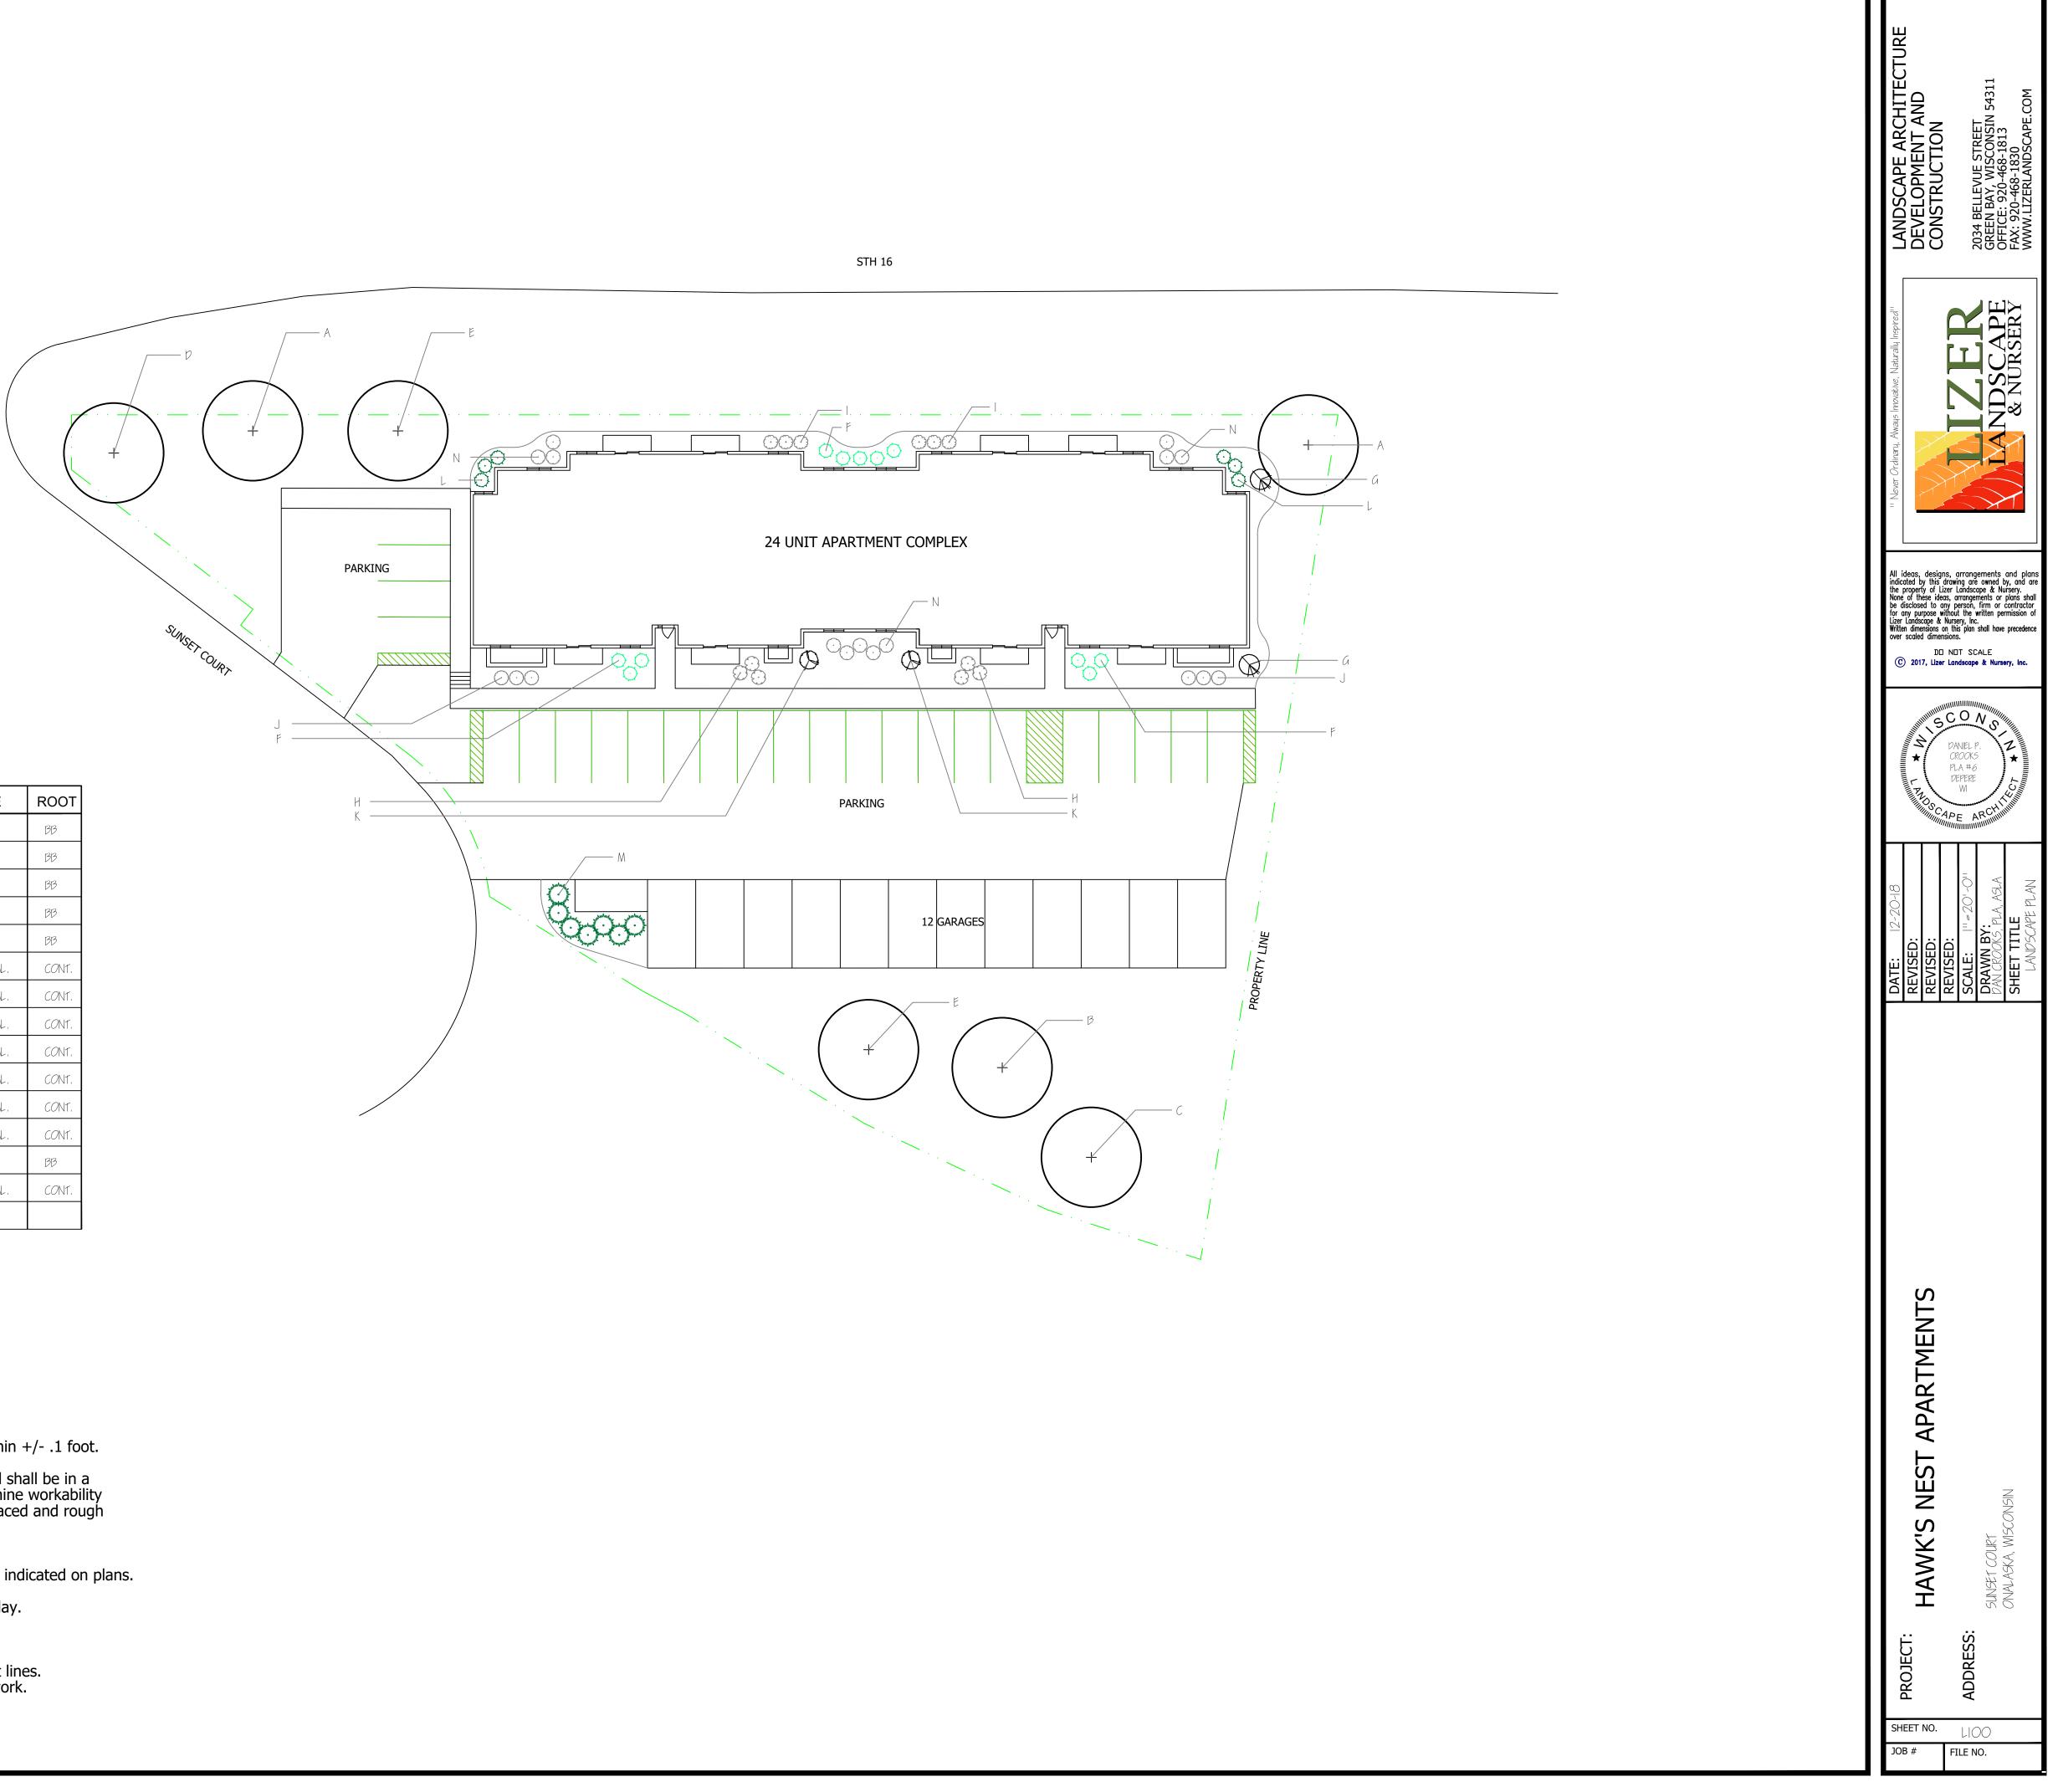
### LANDSCAPE NOTES

- Topsoil shall be provided by and rough graded by owner. Rough grading to be completed within +/- .1 foot.
- Any imported topsoil must be a loose, pulverized, sandy mixture free of excess debris. Topsoil shall be in a
  workable condition for landscape contractor. Landscape contractor shall inspect site to determine workability
  and should take necessary measures to correct any potential discrepancies. Once topsoil is placed and rough
  graded, no constuction equipment or vehicles shall be allowed to drive on area.
- Landscape contractor shall seed, fertilize and mulch all disturbed areas as indicated on plans.
   Landscape contractor shall provide all trees, shrubs, plantings, edgings and mulch material as indicated on plans.
- All planting beds to mulched with 1 1//2" Mississippi river rock with Typar weed barrier underlay.
- All planting beds to edged with Cobra commercial grade vinyl edging.
- Landscape contractor to be responsible for restoring all damaged turf within construction limit lines.
   Landscape contractor shall verify construction limits with general contractor prior to start of work.