# LA CROSSE REGIONAL AIRPORT CAR WASH FACILITY

LA CROSSE, WISCONSIN





#### PROJECT GENERAL NOTES

- 1. ALL WORK SHALL CONFORM TO THE CONTRACT DOCUMENTS, WHICH INCLUDE, BUT ARE NOT LIMITED TO, THE OWNER CONTRACTOR AGREEMENT, THE PROJECT MANUAL (WHICH INCLUDES GENERAL AND SUPPLEMENTARY CONDITIONS AND SPECIFICATIONS), DRAWINGS OF ALL DISCIPLINES AND ALL ADDENDA, MODIFICATIONS AND CLARIFICATIONS ISSUED BY THE ARCHITECT / FNGINEFR.
- CONTRACT DOCUMENTS SHALL BE ISSUED TO ALL SUBCONTRACTORS BY THE GENERAL CONTRACTOR IN COMPLETE SETS IN ORDER TO ACHIEVE THE FULL EXTENT AND COMPLETE COORDINATION OF ALL WORK. CONTRACTOR IS RESPONSIBLE FOR COORDINATING AND CORRELATING QUANTITIES AND DIMENSIONS.
- 3. WRITTEN DIMENSIONS TAKE PRECEDENCE OVER SCALED DIMENSIONS. NOTIFY
  ARCHITECT/ENGINEER OF ANY DISCREPANCIES OR CONDITIONS REQUIRING
  INFORMATION OR CLARIFICATION REFORE PROCEEDING WITH THE WORK
- FIELD VERIFY ALL EXISTING CONDITIONS AND DIMENSIONS. NOTIFY ARCHITECT ENGINEER OF ANY DISCREPANCIES OR CONDITIONS REQUIRING INFORMATION OR CLARIFICATION BEFORE PROCEEDING WITH THE WORK.
- OF DETAILS SHOWN ARE INTENDED TO BE INDICATIVE OF THE PROFILES AND TYPE OF DETAILING REQUIRED THROUGHOUT THE WORK. DETAILS NOT SHOWN ARE SIMILAR IN CHARACTER TO DETAILS SHOWN. WHERE SPECIFIC DIMENSIONS, DETAILS OR DESIGN INTENT CANNOT BE DETERMINED, NOTIFY ARCHITECT / ENGINEER BEFORE PROCEEDING WITH THE WORK.
- ALL MANUFACTURED ARTICLES, MATERIALS AND EQUIPMENT SHALL BE APPLIED, INSTALLED, CONNECTED, ERECTED, CLEANED AND CONDITIONED ACCORDING TO MANUFACTURERS' INSTRUCTIONS. IN CASE OF DISCREPANCIES BETWEEN MANUFACTURERS' INSTRUCTIONS AND THE CONTRACT DOCUMENTS, NOTIFY ARCHITECT / ENGINEER BEFORE PROCEEDING WITH THE WORK.
- 7. LARGE-SCALE, MORE SPECIFIC DETAILS TAKE PRECEDENCE OVER SMALLER-SCALE, LESS SPECIFIC DETAILS AND INFORMATION. MORE STRINGENT REQUIREMENTS FOR CODE, PRODUCTS AND INSTALLATION TAKE PRECEDENCE OVER LESS STRINGENT REQUIREMENTS. NOTIFY ARCHITECT/ENGINEER OF ANY DISCREPANCIES OR CONDITIONS REQUIRING INFORMATION OR CLARIFICATION BEFORE PROCEEDING WITH THE WORK.
- PROVIDE CONTINUOUS SEALANT AROUND ALL MATERIALS AT EXTERIOR WALL PENETRATIONS. REFER TO SPECIFICATIONS FOR APPROPRIATE SEALANT.
   ALL DISSIMILAR METALS SHALL BE EFFECTIVELY ISOLATED FROM EACH OTHER TO AVOID GALVANIC CORROSION.
- 10. SEAL ALL OPENINGS IN WALLS, FLOORS, CEILINGS, AND ROOFS, AROUND DUCTS, PIPES, VENTS, TRAPS, CONDUIT AND ALL OTHER PENETRATIONS WITH FIRE STOPPING AS SPECIFIED AND REQUIRED BY CODES.
- 11. PROVIDE SOLID WALL BACKING WITH METAL OR FIRE-RETARDANT WOOD BLOCKING BEHIND DOOR HARDWARE SUCH AS WALL STOPS, BUMPERS, HOLD OPENS, ETC.

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PROJECT

LA CROSSE REGIONAL AIRPORT

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CAR WASH FACILITY

REVISION SCHEDULE

DATE DESCRIPTION BY

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PROJECT NO.	18-21496
FILE NAME	21496 Arch R18.rvt
DRAWN BY	SJR
DESIGNED BY	KMB
REVIEWED BY	KMB
ORIGINAL ISSUE DATE	01/14/2019

TTLE

TITLE SHEET, SHEET INDEX, PROJECT GENERAL NOTES

SHEET

**G1-10** 

# PROJECT INDEX:

OWNER:


LA CROSSE REGIONAL AIRPORT 2850 AIRPORT ROAD LA CROSSE, WISCONSIN 54603 **PROJECT ADDRESS:** 

LA CROSSE REGIONAL AIRPORT CAR WASH FACILITY 2840 AIRPORT ROAD LA CROSSE, WISCONSIN 54603 MANAGING OFFICE:

OFFICE

LA CROSSE OFFICE

201 MAIN STREET
SUITE 1020
LA CROSSE, WISCONSIN 54601
PHONE: 608.789.2034
PROJECT MANAGER: MIKE HANSEN
EMAIL: mike.hansen@is-grp.com

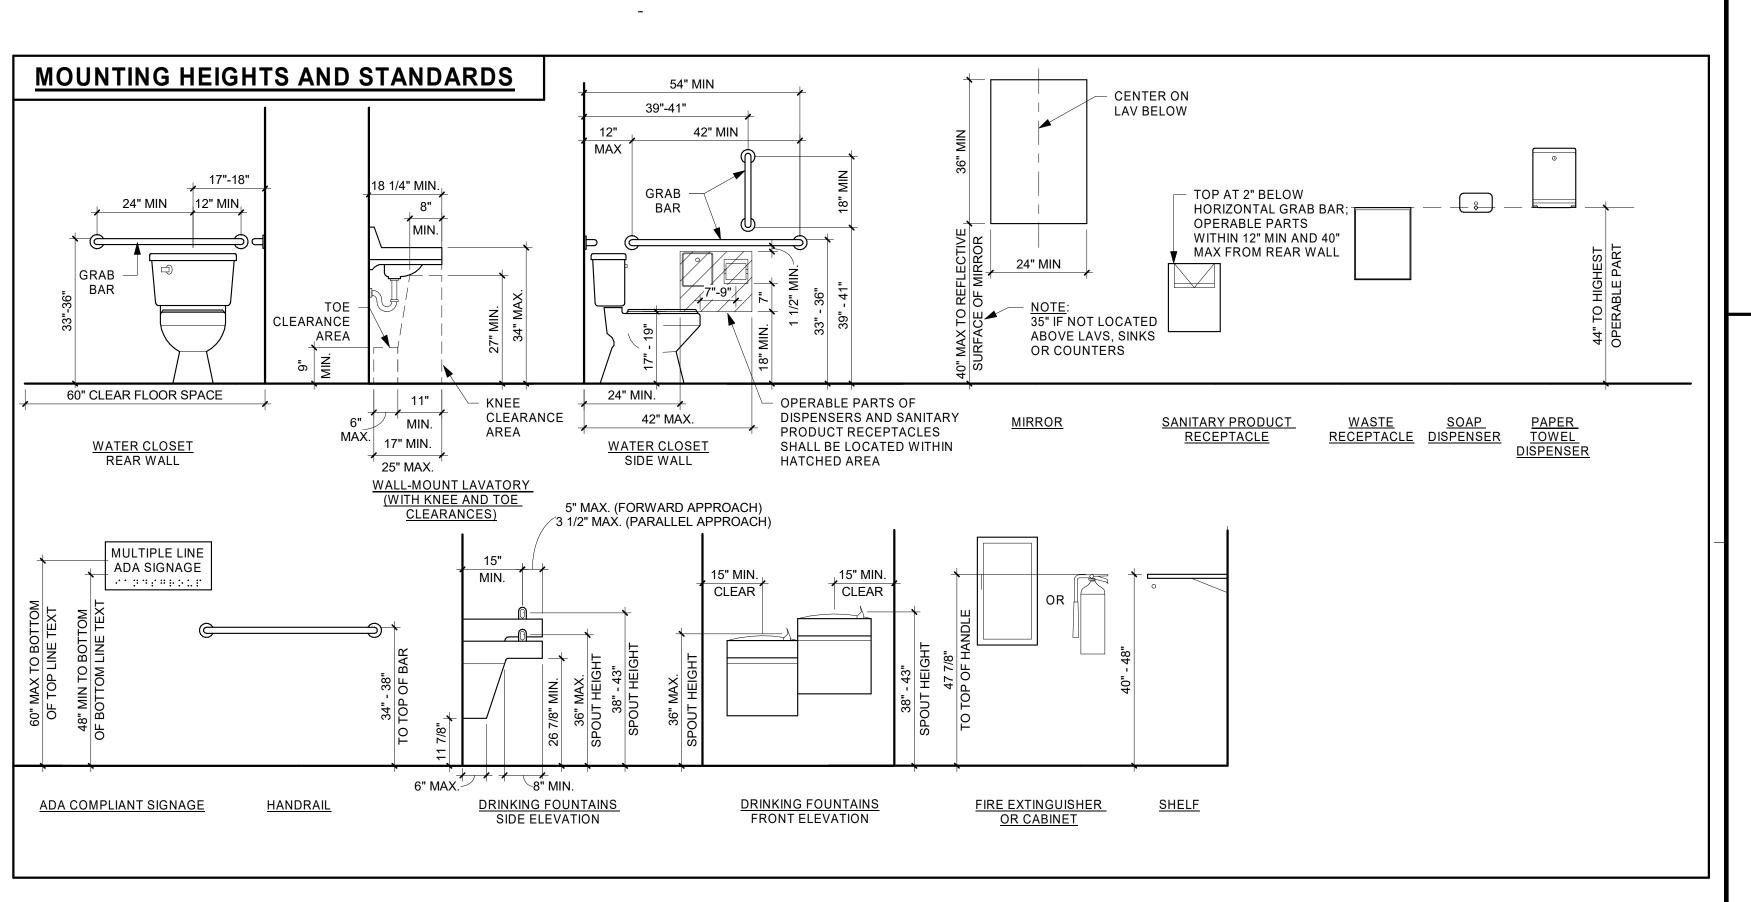



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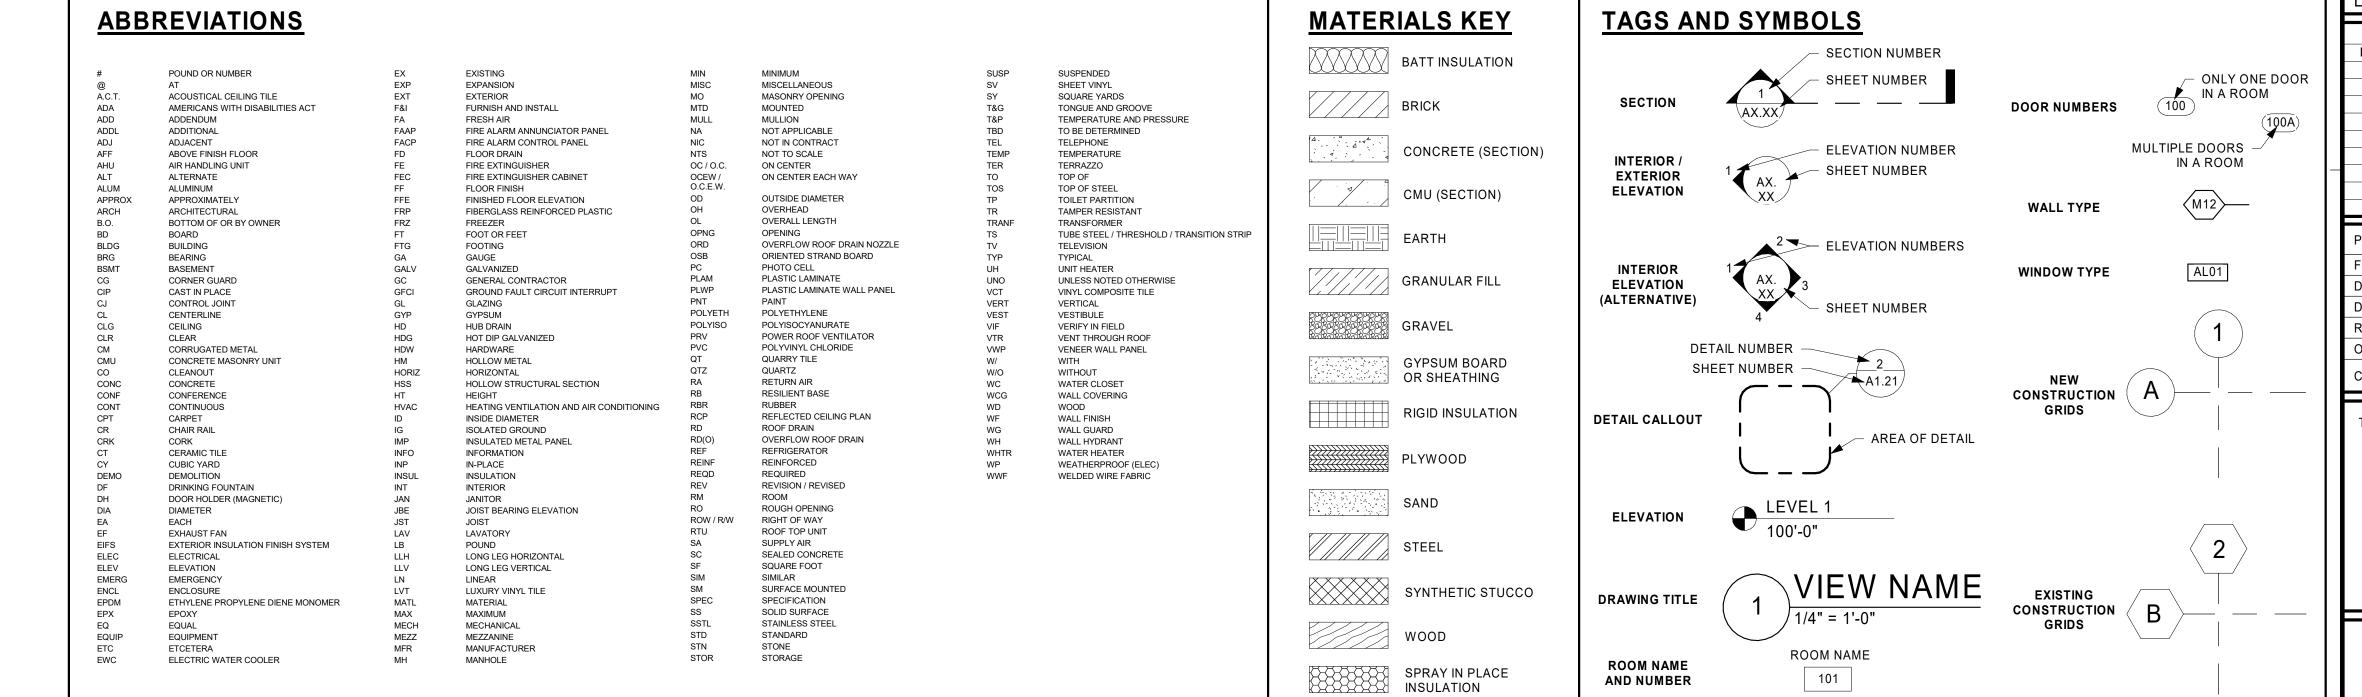
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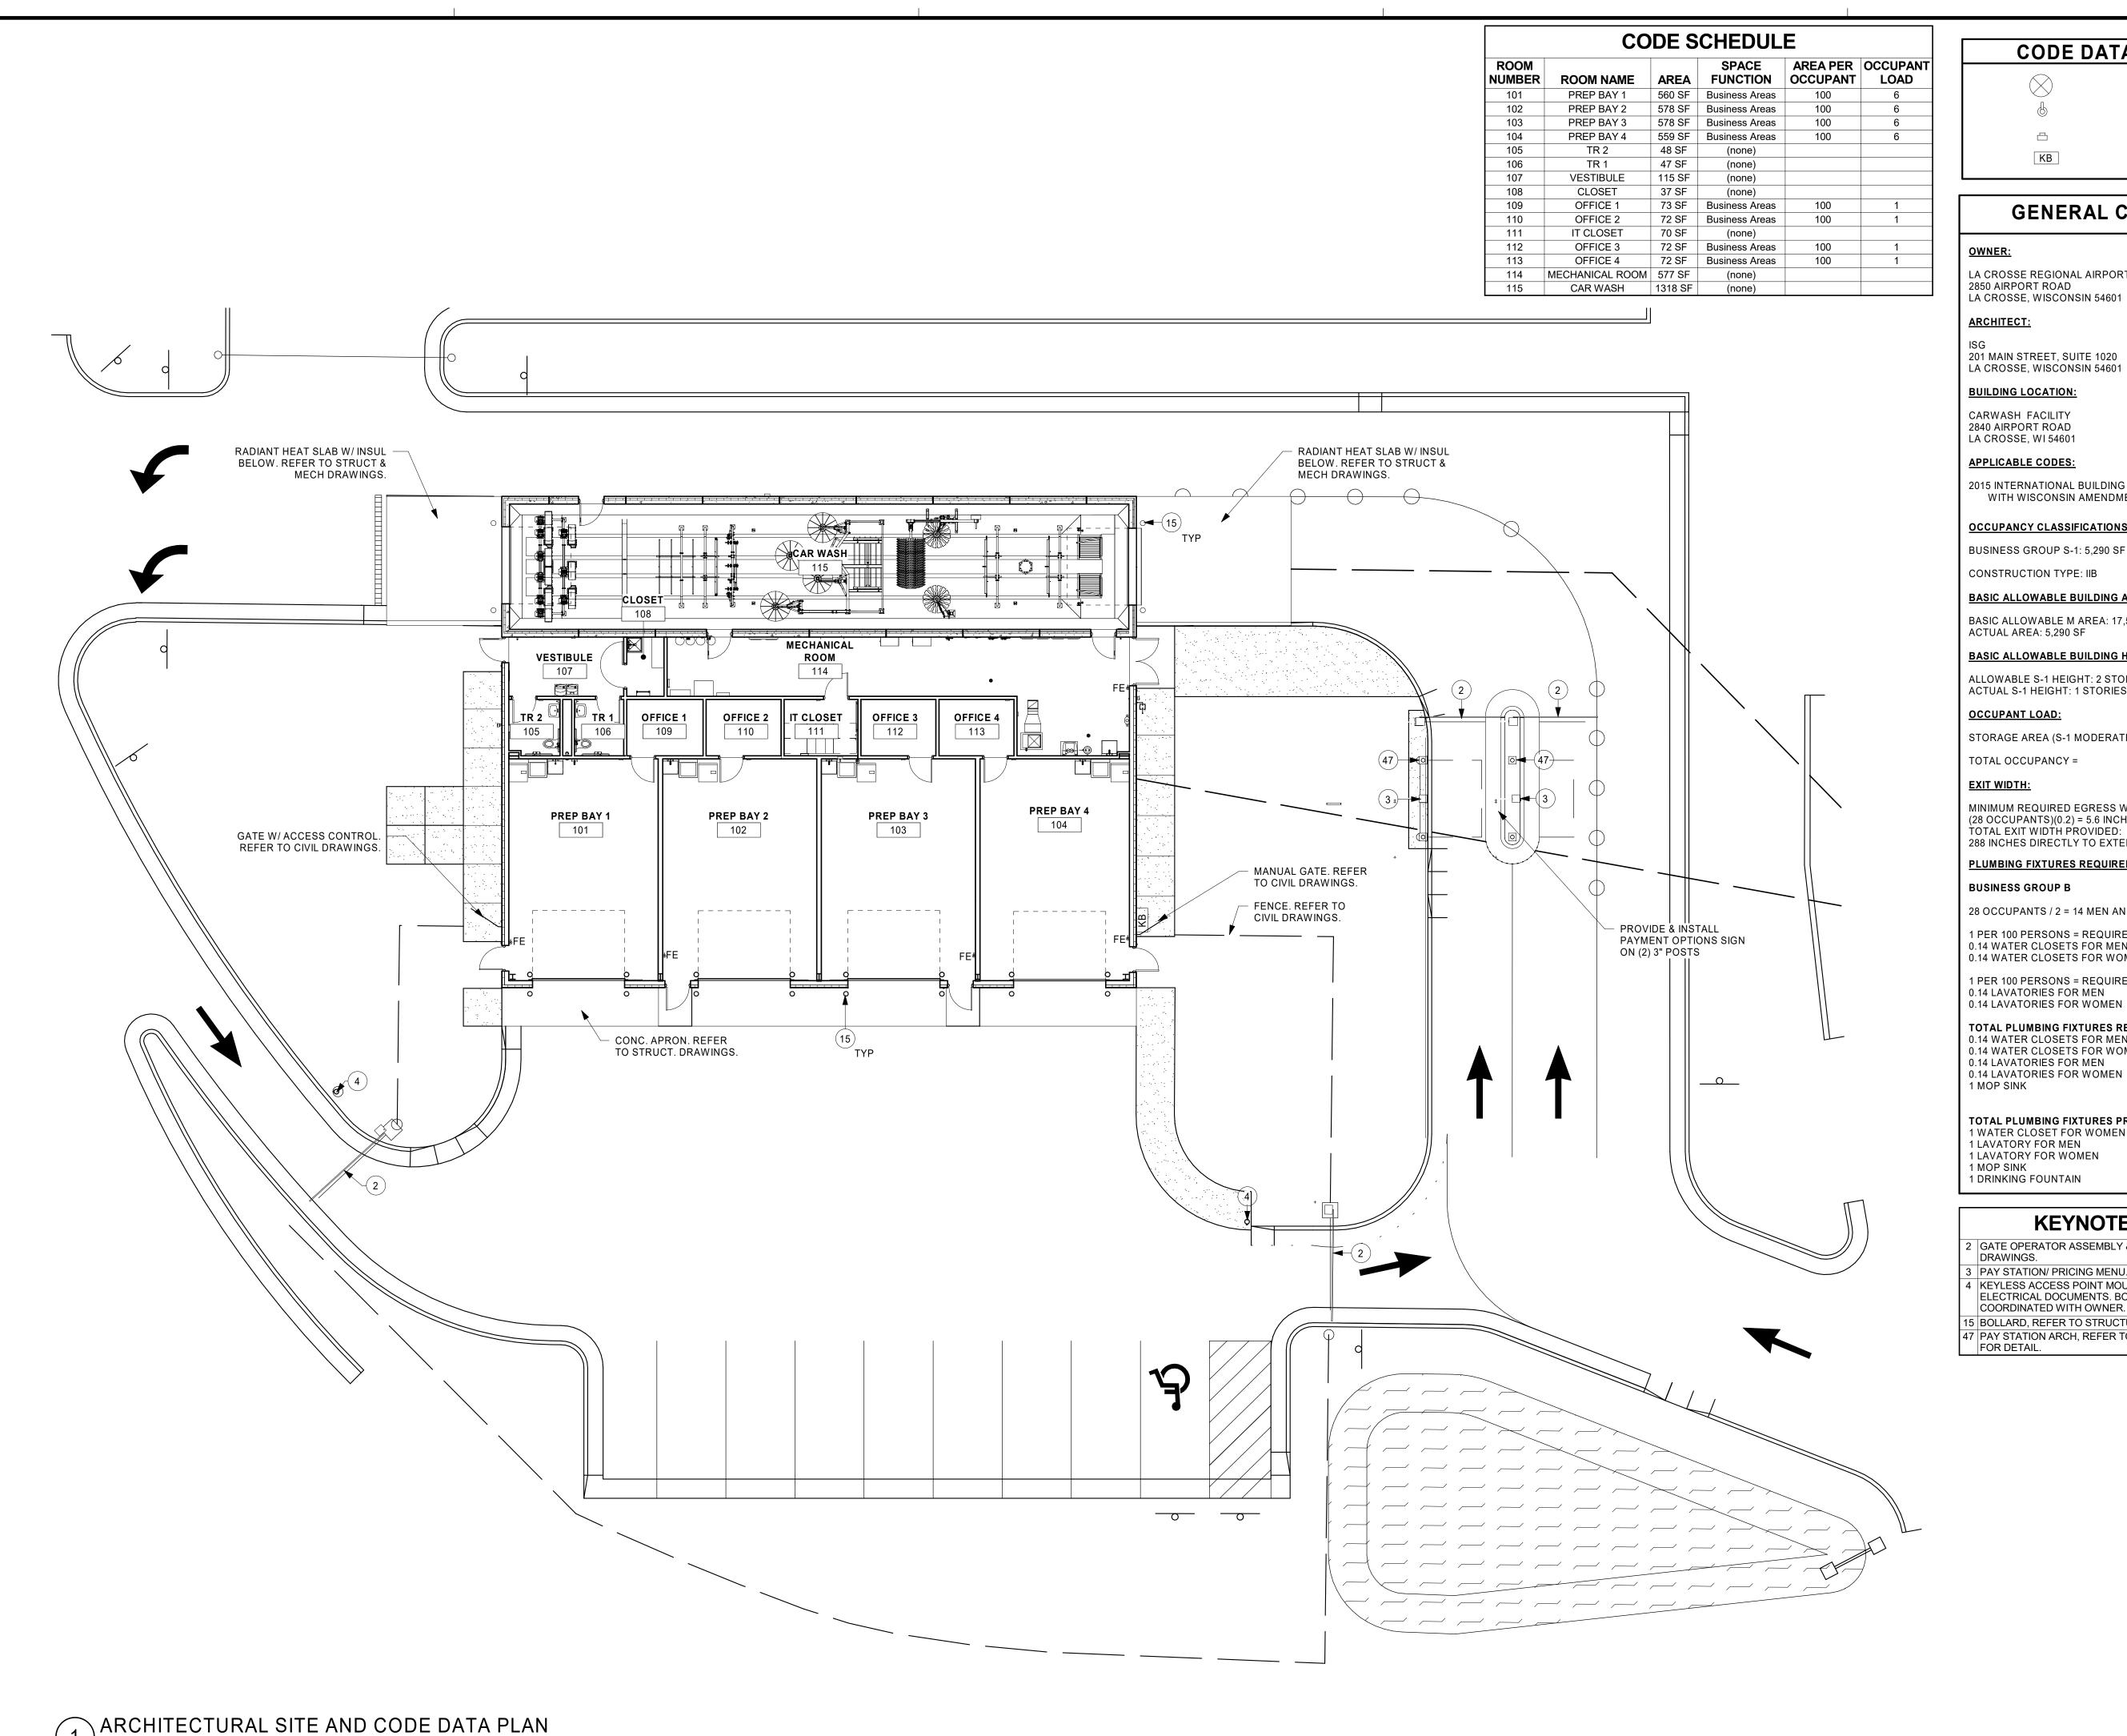
**CAR WASH FACILITY** 

LA CROSSE WISCONSIN REVISION SCHEDULE DATE DESCRIPTION 18-21496 PROJECT NO. FILE NAME 21496 Arch R18.rvt SJR DRAWN BY DESIGNED BY KMB KMB REVIEWED BY ORIGINAL ISSUE DATE CLIENT PROJECT NO. LIMINA

MOUNTING **HEIGHTS AND** STANDARDS, **ABBREVIATIONS AND SYMBOLS** 

**G1-11** 





**CODE DATA PLAN KEY** 

KB

FIRE EXTINGUISHER FIRE EXTINGUISHER CABINET

KNOX BOX

#### **GENERAL CODE DATA**

#### **OWNER:**

LA CROSSE REGIONAL AIRPORT 2850 AIRPORT ROAD LA CROSSE, WISCONSIN 54601

#### **ARCHITECT:**

201 MAIN STREET, SUITE 1020 LA CROSSE, WISCONSIN 54601

#### **BUILDING LOCATION:**

2840 AIRPORT ROAD LA CROSSE, WI 54601

#### **APPLICABLE CODES:**

2015 INTERNATIONAL BUILDING CODE (IBC) WITH WISCONSIN AMENDMENTS

#### **OCCUPANCY CLASSIFICATIONS:**

CONSTRUCTION TYPE: IIB

#### **BASIC ALLOWABLE BUILDING AREA (IBC SECTION 503):**

BASIC ALLOWABLE M AREA: 17,500 SF ACTUAL AREA: 5,290 SF

#### BASIC ALLOWABLE BUILDING HEIGHT (IBC SECTION 503):

ALLOWABLE S-1 HEIGHT: 2 STORIES / 55 FEET ACTUAL S-1 HEIGHT: 1 STORIES / 21 FEET

#### OCCUPANT LOAD:

STORAGE AREA (S-1 MODERATE HAZARD):

TOTAL OCCUPANCY = 28 OCCUPANTS

MINIMUM REQUIRED EGRESS WIDTH: (28 OCCUPANTS)(0.2) = 5.6 INCHES TOTAL EXIT WIDTH PROVIDED: 288 INCHES DIRECTLY TO EXTERIOR (8) 36" DOORS

#### PLUMBING FIXTURES REQUIRED:

#### **BUSINESS GROUP B**

28 OCCUPANTS / 2 = 14 MEN AND 14 WOMEN 1 PER 100 PERSONS = REQUIRED WATER CLOSETS

0.14 WATER CLOSETS FOR MEN 0.14 WATER CLOSETS FOR WOMEN

1 PER 100 PERSONS = REQUIRED LAVATORIES 0.14 LAVATORIES FOR MEN 0.14 LAVATORIES FOR WOMEN

# TOTAL PLUMBING FIXTURES REQUIRED: 0.14 WATER CLOSETS FOR MEN

0.14 WATER CLOSETS FOR WOMEN 0.14 LAVATORIES FOR MEN 0.14 LAVATORIES FOR WOMEN

## TOTAL PLUMBING FIXTURES PROVIDED: 1 WATER CLOSET FOR WOMEN

1 LAVATORY FOR MEN 1 LAVATORY FOR WOMEN 1 MOP SINK 1 DRINKING FOUNTAIN

#### **KEYNOTE LEGEND**

2 GATE OPERATOR ASSEMBLY & GATE. REFER TO CIVIL DRAWINGS.

3 PAY STATION/ PRICING MENU. 4 KEYLESS ACCESS POINT MOUNTED ON BOLLARD, REFER TO ELECTRICAL DOCUMENTS. BOLLARD LOCATION TO BE COORDINATED WITH OWNER.

5 BOLLARD, REFER TO STRUCTURAL DRAWINGS.

7 PAY STATION ARCH, REFER TO ARCHITECTURAL DRAWINGS



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PROJECT

## LA CROSSE **REGIONAL AIRPORT**

**CAR WASH FACILITY** 

LA CROSSE

REVISION SCHEDULE DESCRIPTION

WISCONSIN

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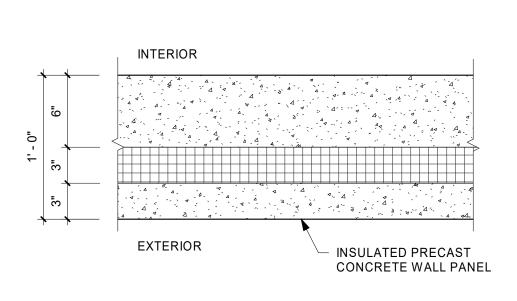
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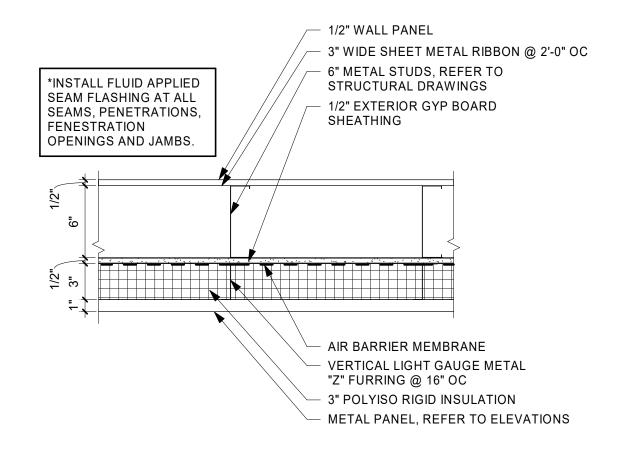
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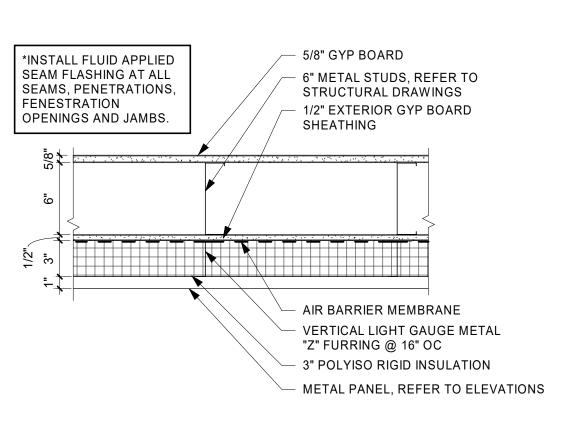
DATE

ARCHITECTURAL SITE AND CODE **DATA PLAN** 

G1-21









1 EXTERIOR WALL TYPE-EW1

2 EXTERIOR WALL TYPE - EW2


3 EXTERIOR WALL- EW3

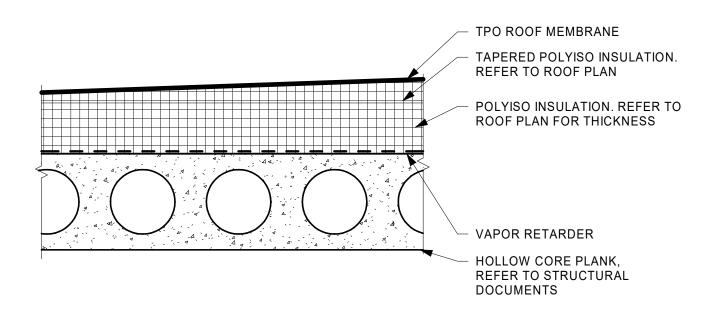


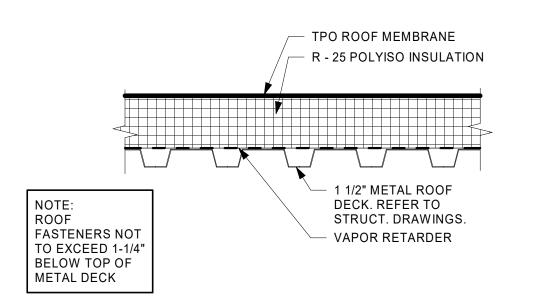

ROOF ASSEMBLY - R1

5 ROOF ASSEMBLY - R2

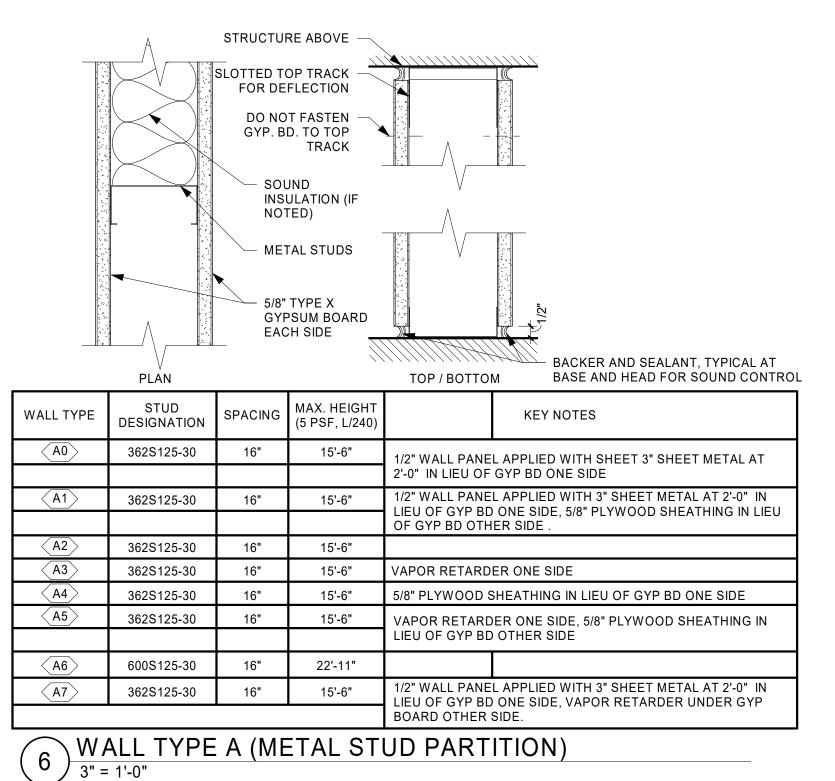

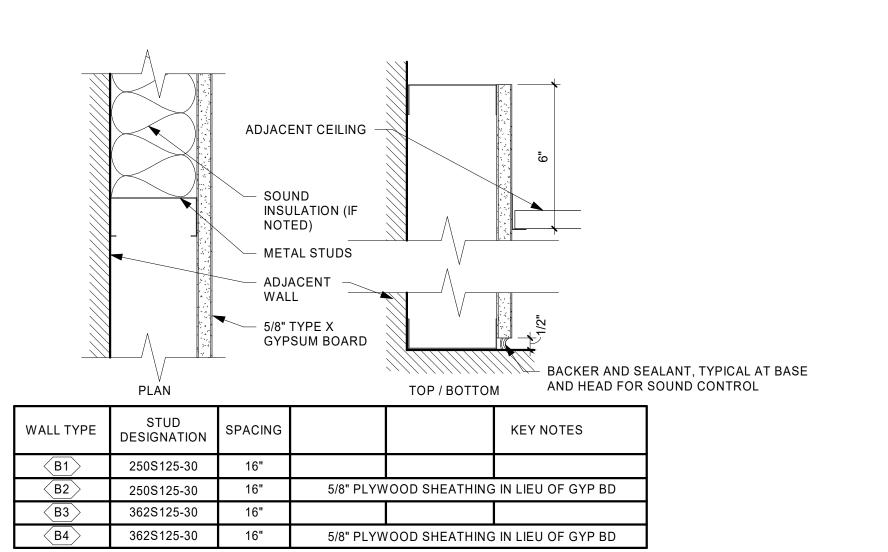

7 WALL TYPE B (METAL STUD FURRING)

#### **GENERAL INTERIOR PARTITION NOTES:**

1. NOT ALL WALL TYPES LISTED APPLY TO THIS PROJECT. REFER TO FLOOR PLAN FOR LOCATIONS AND ADDITIONAL NOTES.

2. LIGHT GAUGE STEEL FRAMING MEMBER DESIGNATION SYSTEM: (REFER TO STRUCTURAL NOTES)

MEMBER DEPTH (1/100 INCHES): EXAMPLE - 600 = 6"

1/2" BELOW LINE OF STRUCTURE AND SEAL AS REQUIRED.

- IN ALL WET AREAS SUCH AS SHOWERS AND TUBS, INSTALL CEMENT-BASED BACKER BEHIND AREAS SCHEDULED TO RECEIVE TILE FINISH.
- ON ALL RESTROOM WALLS AND OTHER AREAS SCHEDULED TO RECEIVE FRP OR TILE FINISH, PROVIDE A MINIMUM OF 5/8" PLYWOOD.
- ALL PARTITIONS CONTAINING PLUMBING OR HAVING AN EXTERIOR FACE SHALL BE INSULATED.
- WHERE GYPSUM BOARD EXTENDS TO UNDERSIDE OF STRUCTURE ABOVE, STOP GYPSUM BOARD
- REFERENCE FLOOR FINISH PLANS AND WALL FINISH PLANS FOR ADDITIONAL FINISHES NOT INDICATED ON PARTITION TYPES.
- . REFER TO MECHANICAL AND ELECTRICAL DRAWINGS FOR LOCATIONS OF WALL PENETRATIONS. SEAL ALL OPENINGS WITH ACOUSTICAL SEALANT.
- 9. PROVIDE FIRE-TREATED WOOD OR STEEL BACKING FOR ALL WALL-MOUNTED FINISH CARPENTRY, ARCHITECTURAL WOODWORK, TOILET PARTITIONS, ACCESSORIES AND OTHER SIMILAR ITEMS.

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LA CROSSE REGIONAL AIRPORT

CAR WASH FACILITY

REVISION SCHEDULE

DATE DESCRIPTION BY

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FILE NAME 21496 Arch R18.rvt


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REVIEWED BY KMB
ORIGINAL ISSUE DATE 01/14/2019

CLIENT PROJECT NO.

TITLE

CONSTRUCTION ASSEMBLIES & PARTITION TYPES

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PROJECT

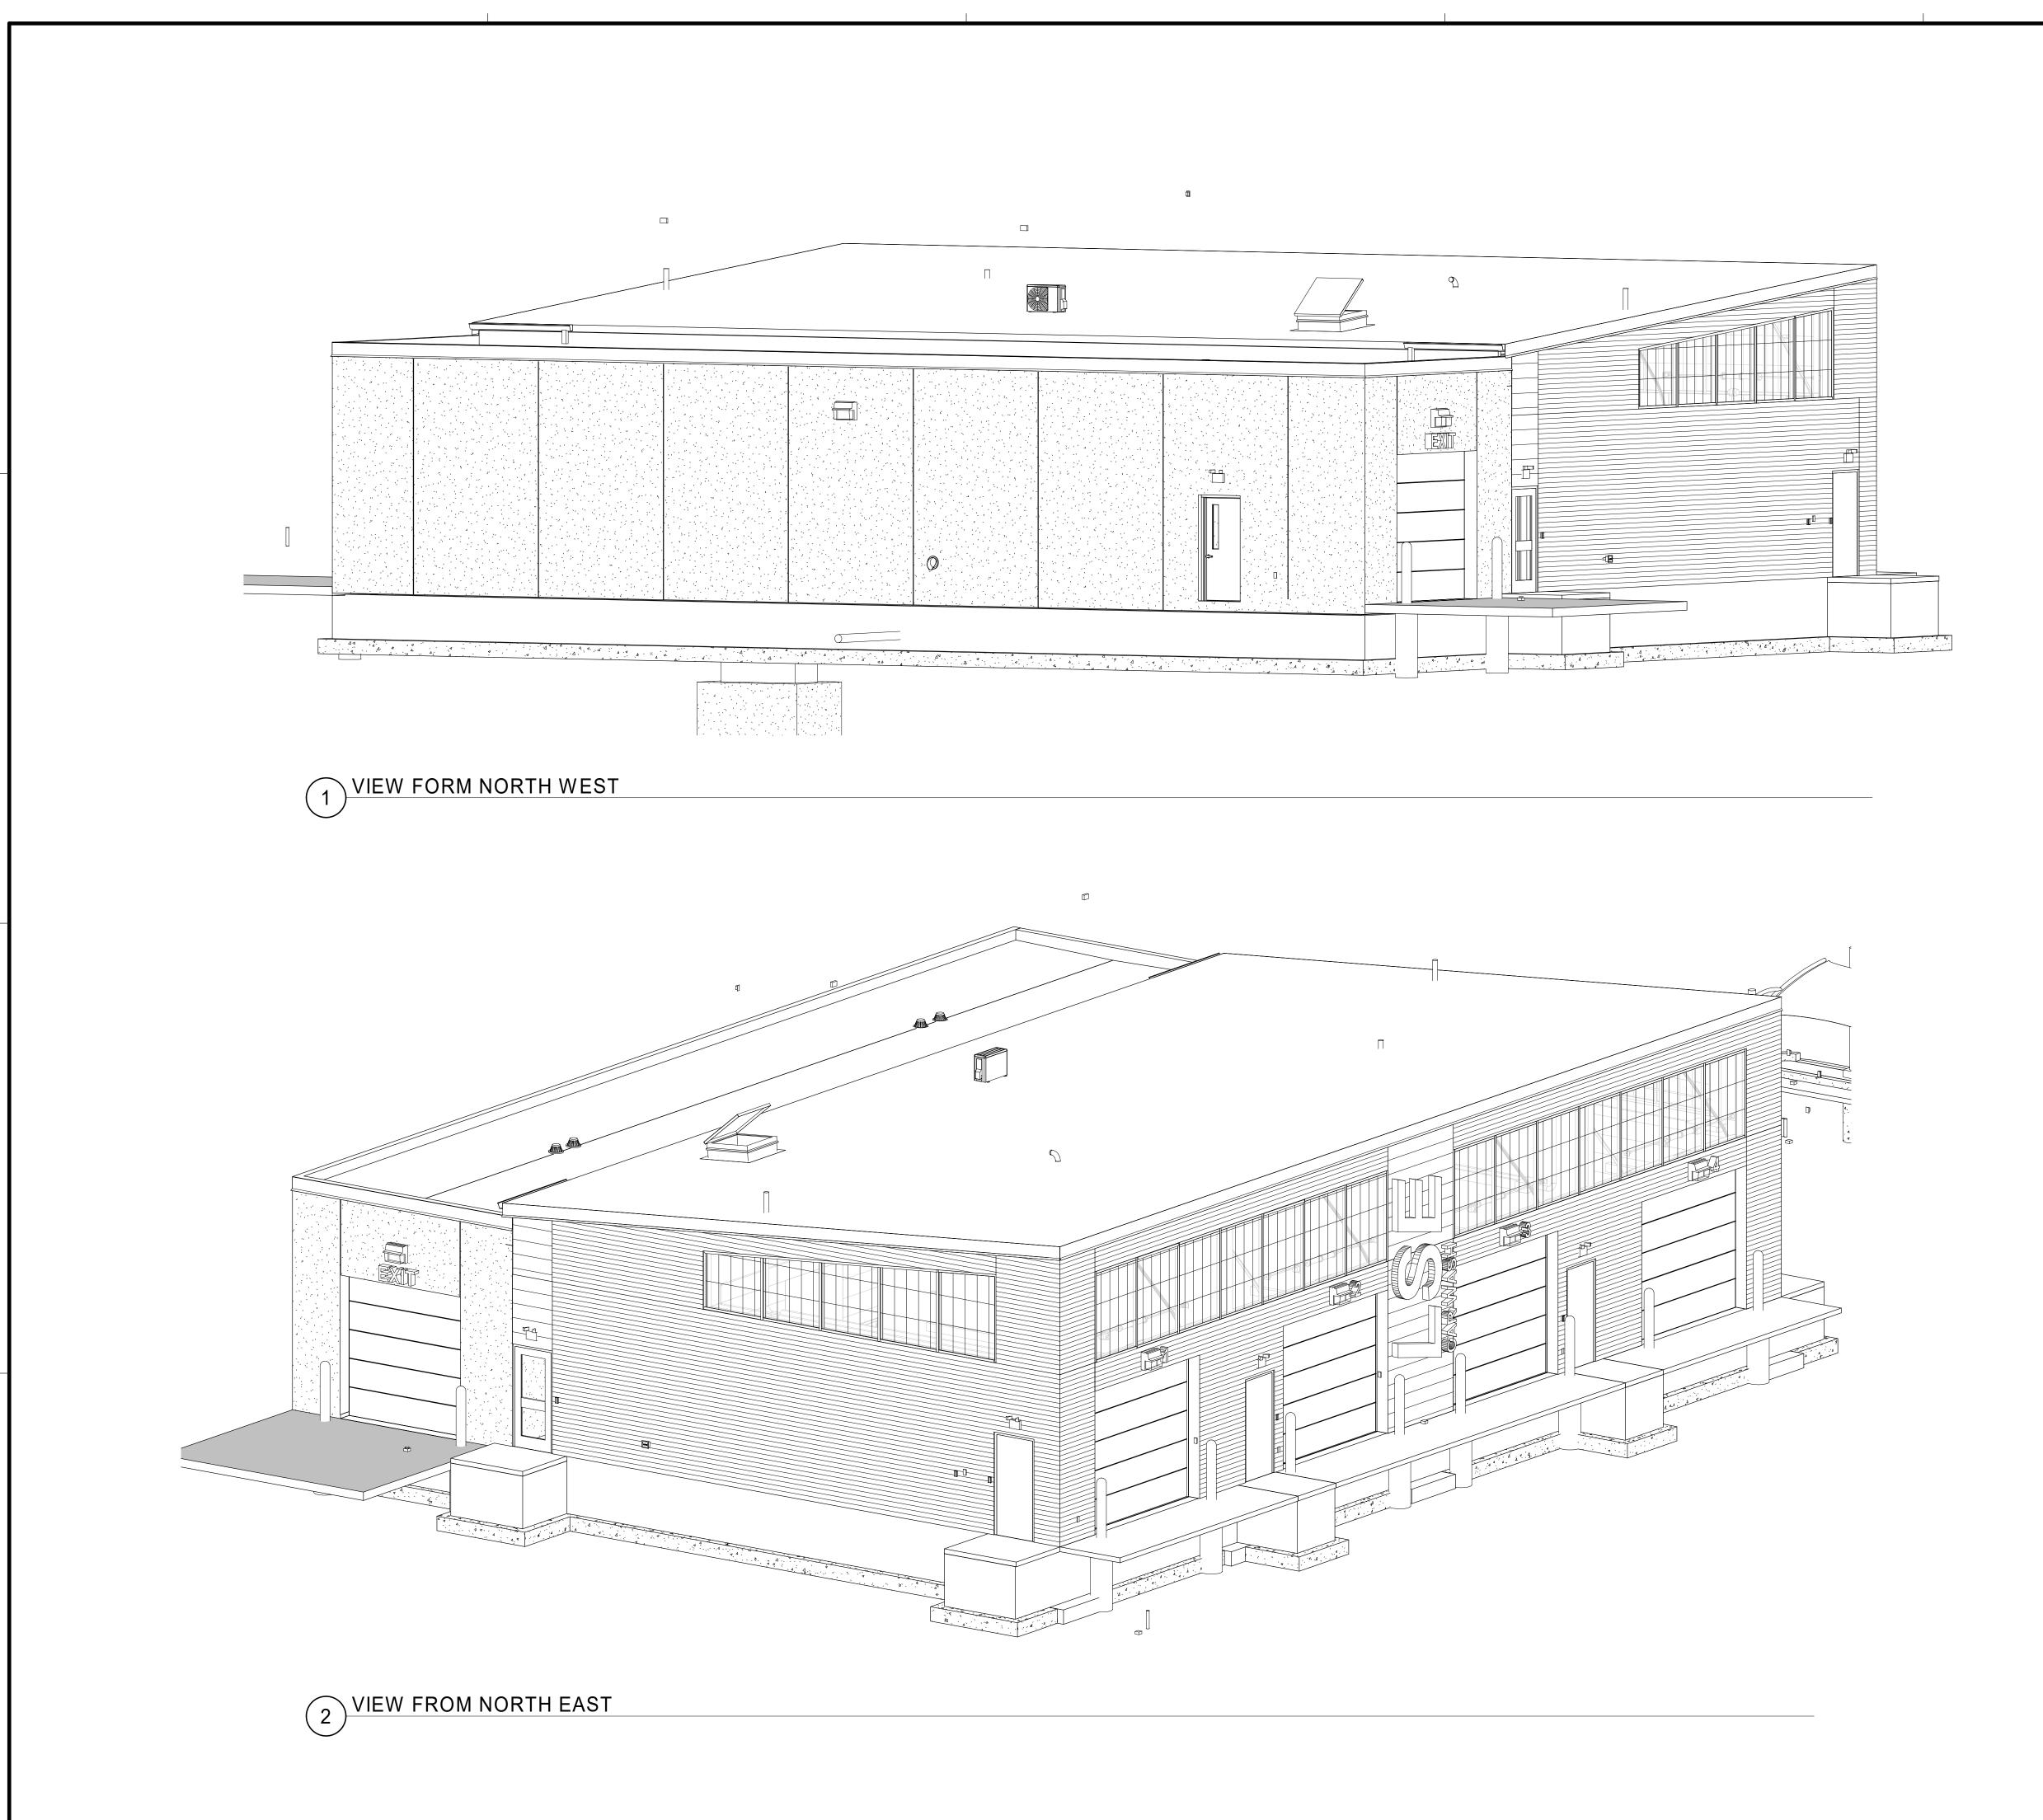LA CROSSE REGIONAL AIRPORT

CAR WASH FACILITY

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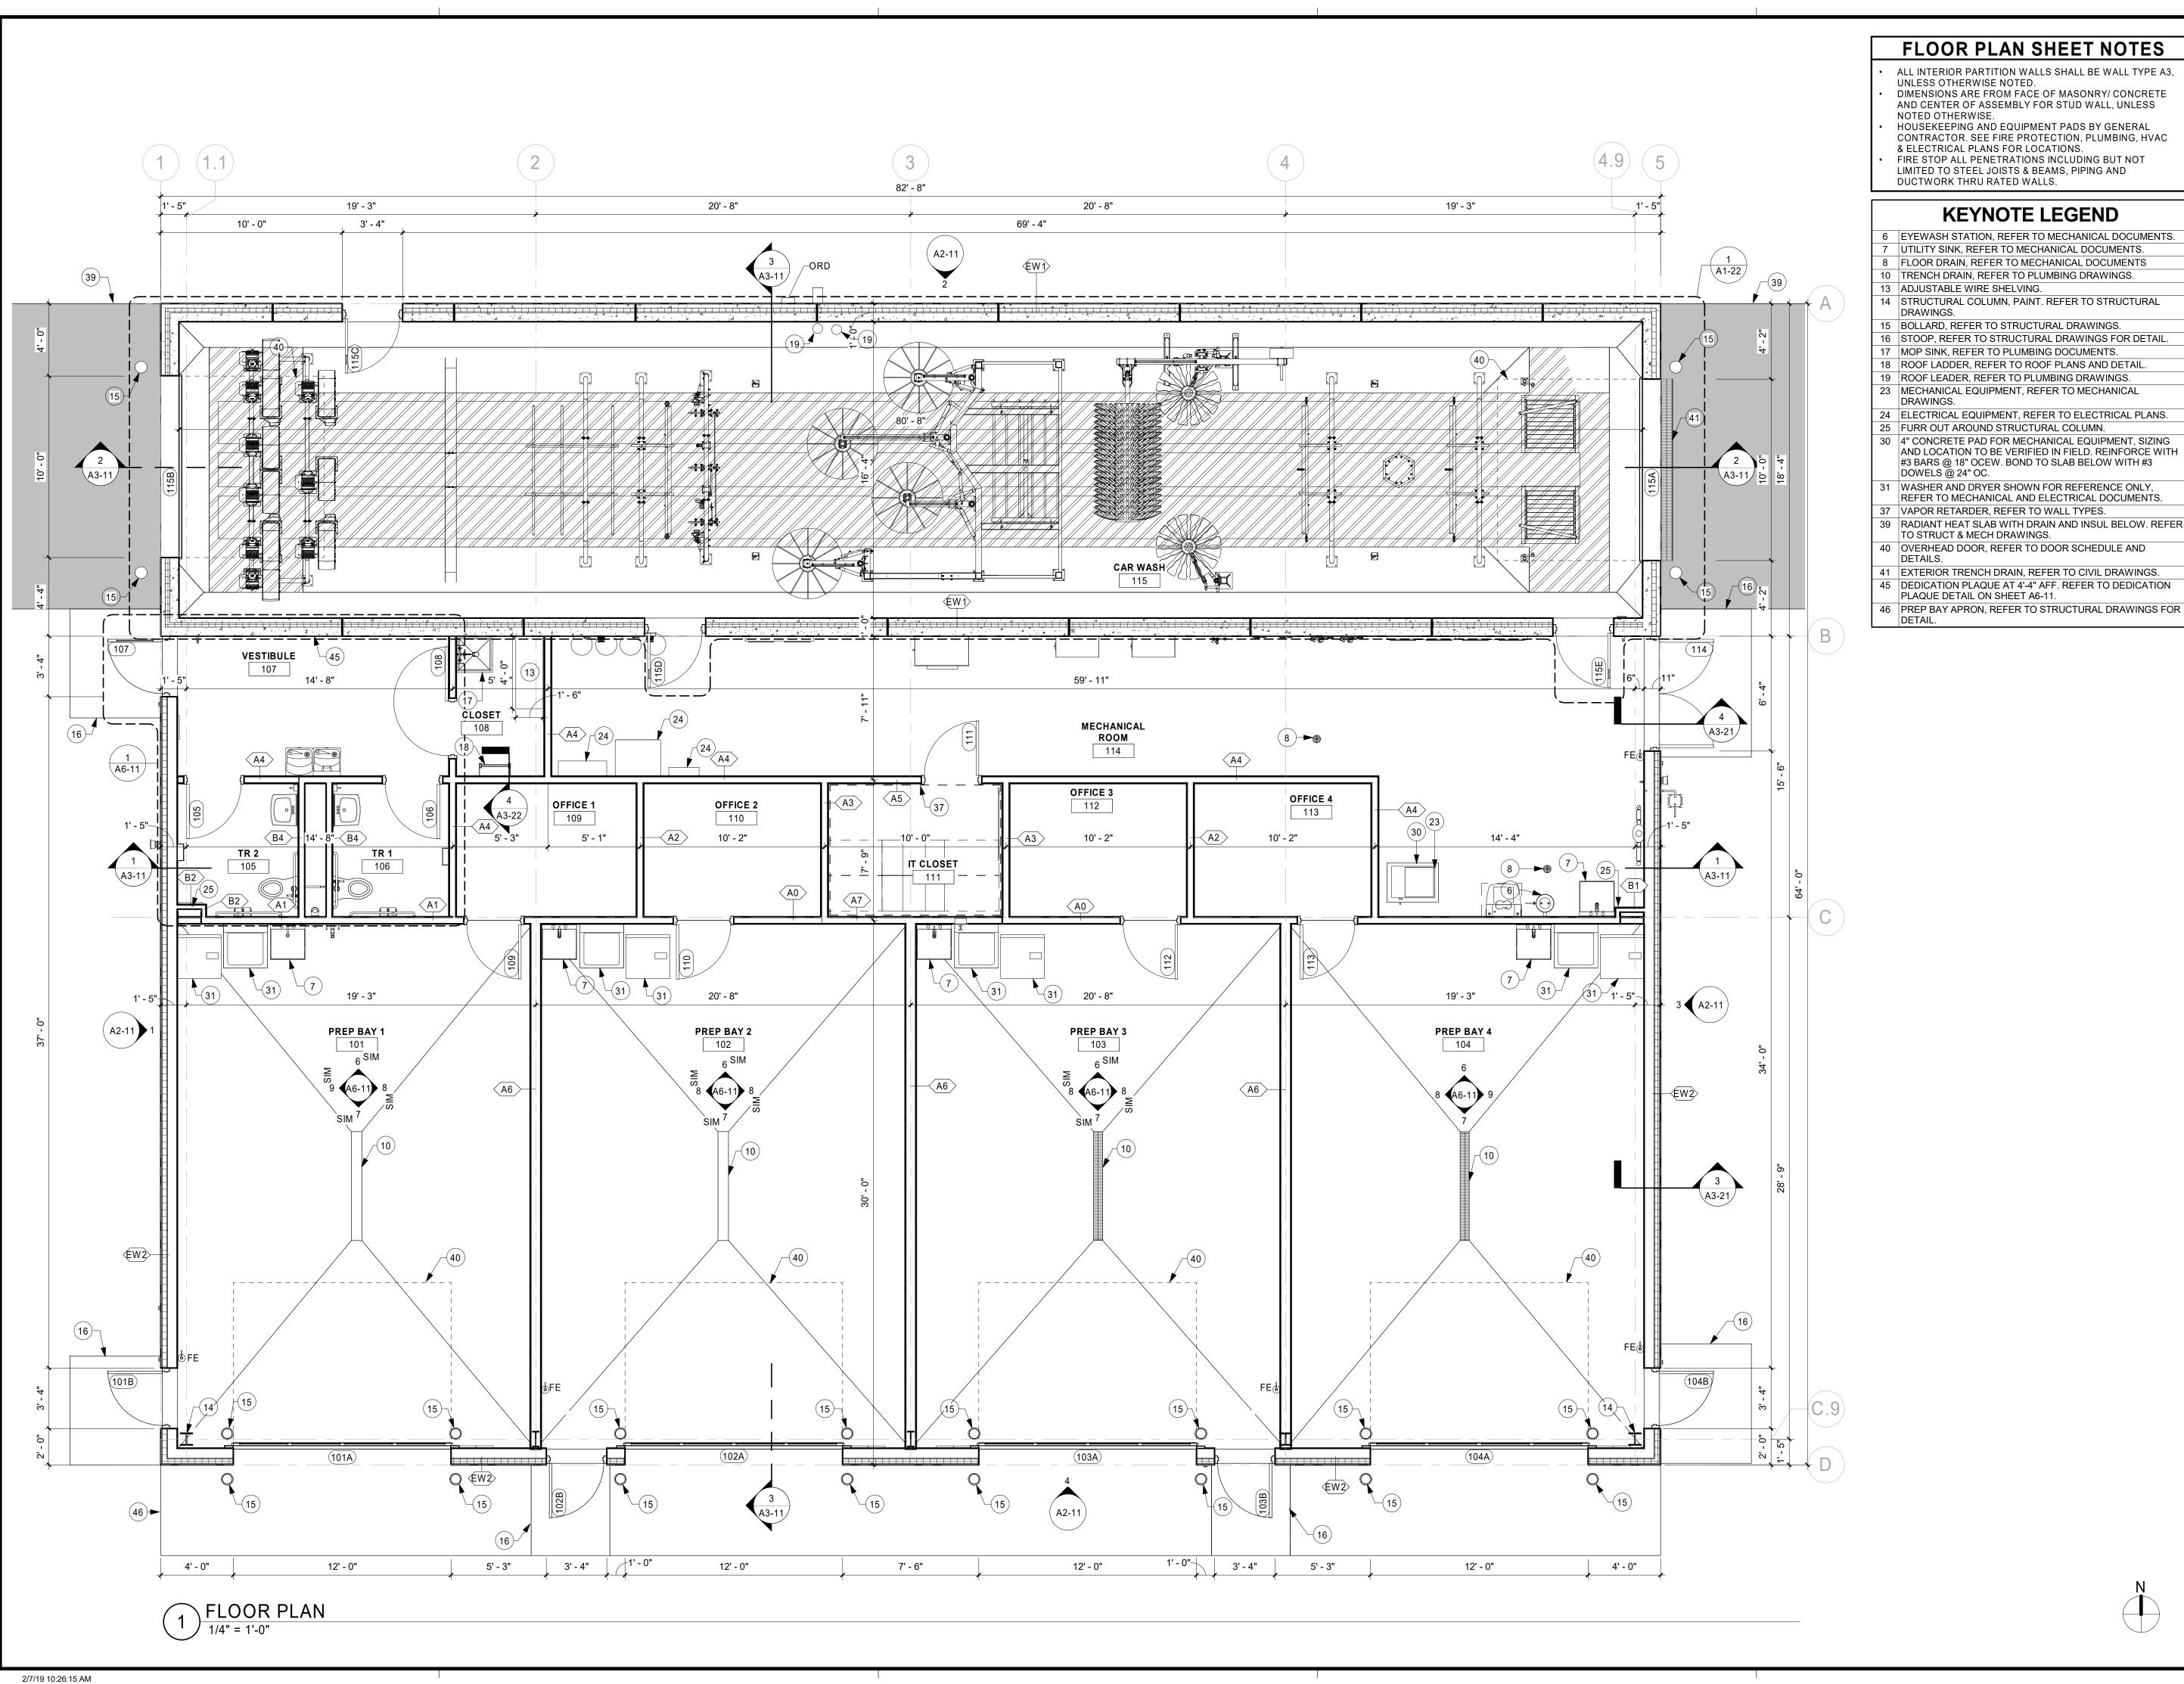
CLIENT PROJECT NO.

TITLE

**3D VIEWS** 

PRELIMINA

SHEET



#### FLOOR PLAN SHEET NOTES

- ALL INTERIOR PARTITION WALLS SHALL BE WALL TYPE A3, UNLESS OTHERWISE NOTED. DIMENSIONS ARE FROM FACE OF MASONRY/ CONCRETE AND CENTER OF ASSEMBLY FOR STUD WALL, UNLESS
- NOTED OTHERWISE. HOUSEKEEPING AND EQUIPMENT PADS BY GENERAL
- FIRE STOP ALL PENETRATIONS INCLUDING BUT NOT LIMITED TO STEEL JOISTS & BEAMS, PIPING AND DUCTWORK THRU RATED WALLS.

#### **KEYNOTE LEGEND**

- 6 EYEWASH STATION. REFER TO MECHANICAL DOCUMENTS. 7 UTILITY SINK, REFER TO MECHANICAL DOCUMENTS.
- 8 FLOOR DRAIN, REFER TO MECHANICAL DOCUMENTS
- 10 TRENCH DRAIN, REFER TO PLUMBING DRAWINGS. 13 ADJUSTABLE WIRE SHELVING.
- 14 STRUCTURAL COLUMN, PAINT. REFER TO STRUCTURAL
- 5 BOLLARD, REFER TO STRUCTURAL DRAWINGS.
- 17 MOP SINK, REFER TO PLUMBING DOCUMENTS.
- 18 ROOF LADDER, REFER TO ROOF PLANS AND DETAIL. 19 ROOF LEADER, REFER TO PLUMBING DRAWINGS.
- 23 MECHANICAL EQUIPMENT, REFER TO MECHANICAL
- 25 FURR OUT AROUND STRUCTURAL COLUMN.
- 30 4" CONCRETE PAD FOR MECHANICAL EQUIPMENT, SIZING AND LOCATION TO BE VERIFIED IN FIELD. REINFORCE WITH #3 BARS @ 18" OCEW. BOND TO SLAB BELOW WITH #3
- 1 WASHER AND DRYER SHOWN FOR REFERENCE ONLY,
- 7 VAPOR RETARDER, REFER TO WALL TYPES. 39 RADIANT HEAT SLAB WITH DRAIN AND INSUL BELOW. REFER
- TO STRUCT & MECH DRAWINGS.
- 40 OVERHEAD DOOR, REFER TO DOOR SCHEDULE AND
- 41 EXTERIOR TRENCH DRAIN, REFER TO CIVIL DRAWINGS.
- 45 DEDICATION PLAQUE AT 4'-4" AFF. REFER TO DEDICATION PLAQUE DETAIL ON SHEET A6-11.



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LA CROSSE **REGIONAL AIRPORT** 

**CAR WASH FACILITY** 

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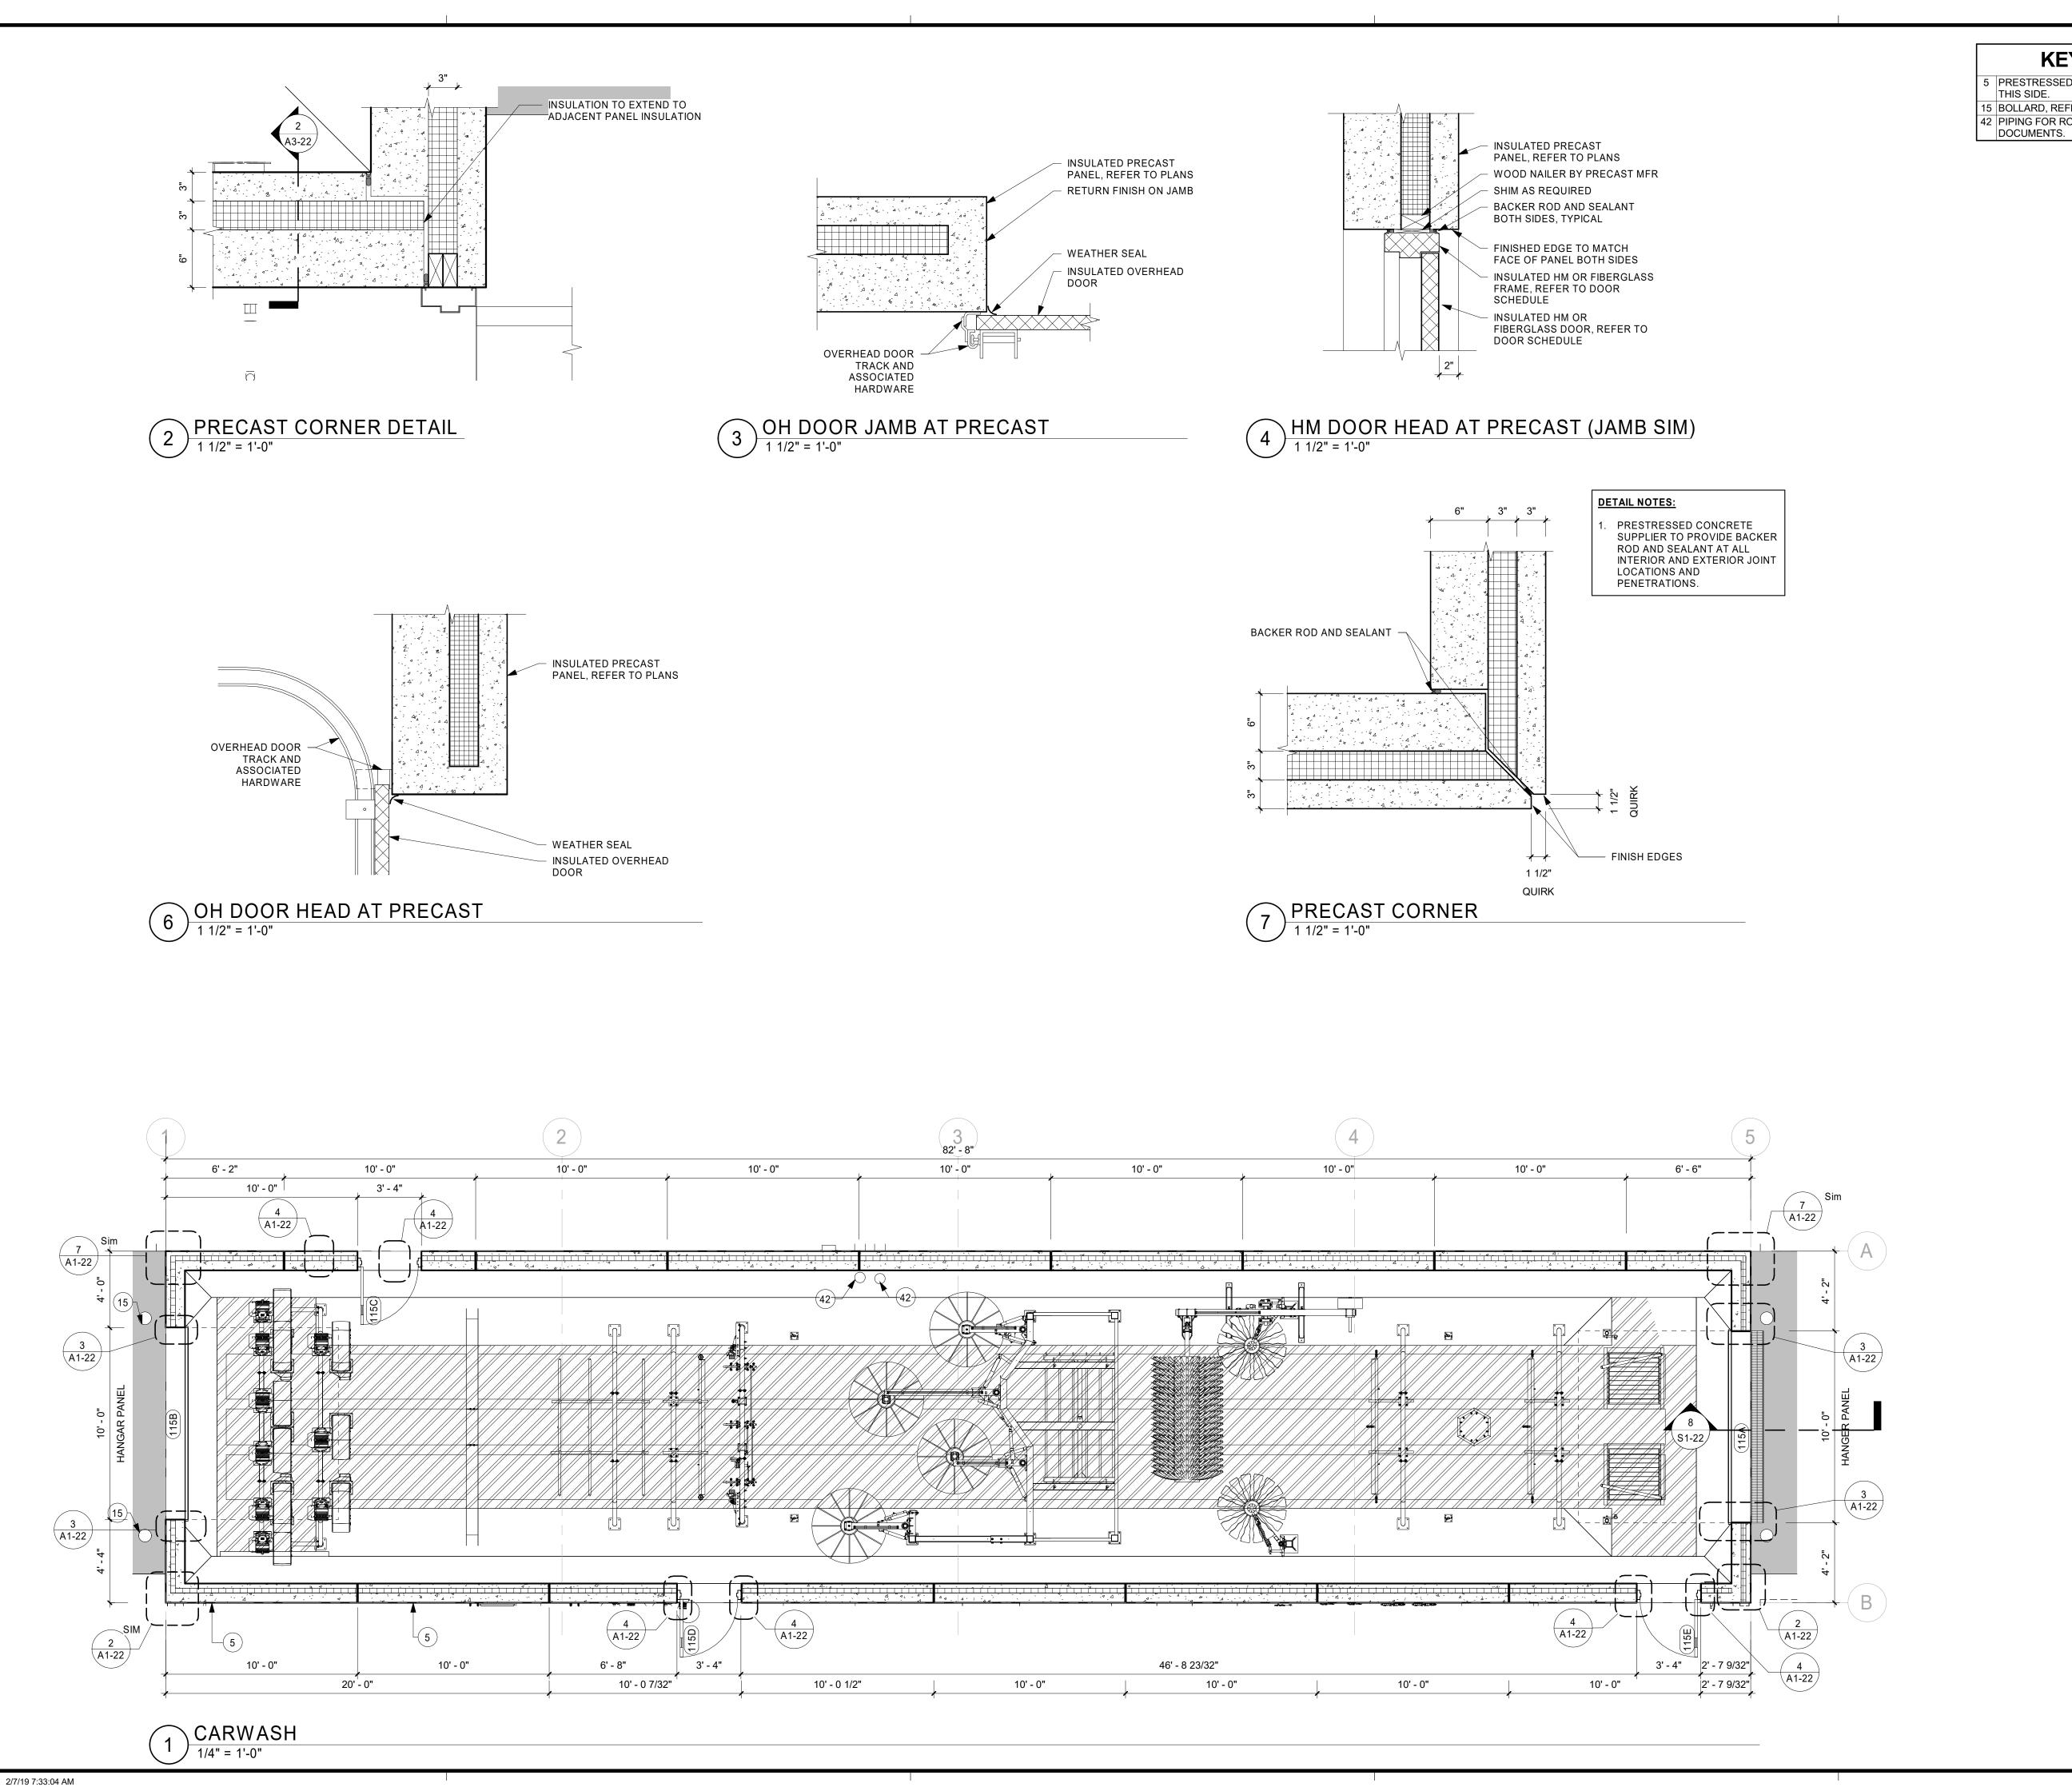
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WISCONSIN LA CROSSE REVISION SCHEDULE DATE DESCRIPTION 18-21496 PROJECT NO. 21496 Arch R18.rvt FILE NAME DRAWN BY DESIGNED BY REVIEWED BY ORIGINAL ISSUE DATE 01/14/2019

TITLE

CLIENT PROJECT NO.

**FLOOR PLAN** 



#### **KEYNOTE LEGEND**

PRESTRESSED CONCRETE TO HAVE ACID ETCH FINISH THIS SIDE.

15 BOLLARD, REFER TO STRUCTURAL DRAWINGS. 42 PIPING FOR ROOF DRAIN, REFER TO MECHANICAL



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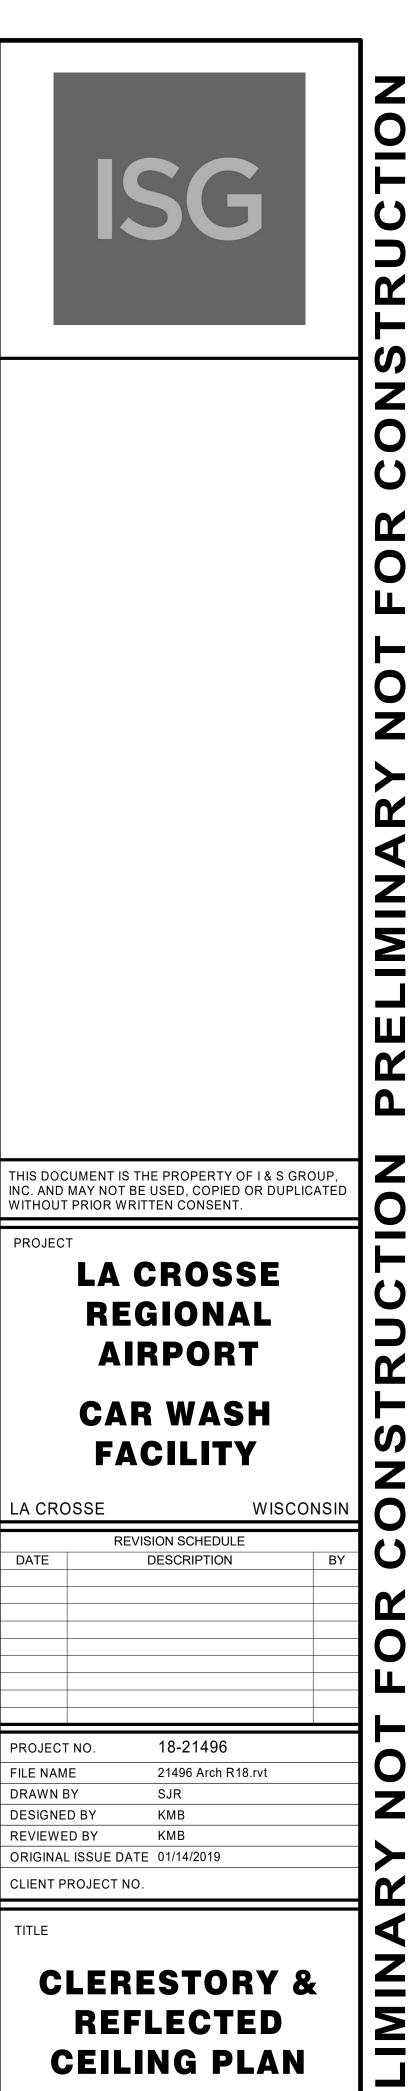
**CAR WASH FACILITY** 

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DESIGNED BY KMB REVIEWED BY KMB ORIGINAL ISSUE DATE 01/14/2019 CLIENT PROJECT NO.

TITLE

PRECAST PLAN





ALL INTERIOR PARTITION WALLS SHALL BE WALL TYPE A3, UNLESS OTHERWISE NOTED.
DIMENSIONS ARE FROM FACE OF MASONRY/ CONCRETE AND CENTER OF ASSEMBLY FOR STUD WALL, UNLESS NOTED OTHERWISE.

HOUSEKEEPING AND EQUIPMENT PADS BY GENERAL CONTRACTOR. SEE FIRE PROTECTION, PLUMBING, HVAC & ELECTRICAL PLANS FOR LOCATIONS. FIRE STOP ALL PENETRATIONS INCLUDING BUT NOT LIMITED TO STEEL JOISTS & BEAMS, PIPING AND DUCTWORK THRU RATED WALLS.

#### REFLECTED CEILING PLAN **SHEET NOTES**

COORDINATE WITH MECHANICAL, PLUMBING, AND ELECTRICAL FOR EXACT LOCATIONS OF CEILING FIXTURES, DIFFUSERS, SPRINKLER HEADS, ETC.
RECESSED LIGHT FIXTURES, SPEAKERS, EXIT LIGHTS, SMOKE DETECTORS, ETC. TO BE LOCATED IN THE EXACT CENTER OF CEILING TILES.

REFER TO HVAC PLANS FOR THE LOCATION OF ANY AND ALL PLENUM CEILING SPACES. ALL WALLS AND SOFFITS CREATING THE PLENUM SHALL EXTEND TO THE UNDERSIDE OF STRUCTURE ABOVE AND BE SEALED.

CEILING FINISH SCHEDULE								
MARK	MATERIAL TYPE	MANUFACTURER	MODEL	SIZE	COLOR	GRID	COMMENTS	
ACT-1	ACOUSTICAL CEILING TILE	ARMSTRONG	DUNE - SQUARE LAY-IN	24" X 24" X 7/8"	WHITE	15/16" PRELUDE-WHITE		
ACT-2 GYPSUM BOARD ARM		ARMSTRONG	CLEAN ROOM VL	24" X 24" X 7/8"	WHITE	15/16" CLEAN ROOM-WHITE		
PNT-1	DRYFALL	SHERWINN WILLIAMS	SILVERPOINTE 7653 239 - C1	SATIN	SATIN FINISH		GENERAL COLOR UNLESS OTHERWISE NOTED	

#### **KEYNOTE LEGEND**

- 9 EPOXY PAINT FINISH ON UNDERSIDE OF PRESTRESSED HOLLOW-CORE PLANK. ALL PANEL JOINTS TO HAVE A BACKER AND SEALANT.
- 20 EXPOSED TO STRUCTURE.
- 1 LIGHT FIXTURE, REFER TO ELECTRICAL DRAWINGS, TYP. 22 MECHANICAL DIFFUSERS, REFER TO MECHANICAL DRAWINGS
- 24 ELECTRICAL EQUIPMENT, REFER TO ELECTRICAL PLANS. 26 MECHANICAL EQUIPMENT MOUNTED ON UNDERSIDE OF PRECAST HOLLOW-CORE PLANK. REFER TO MECHANICAL
- DRAWINGS.

28 ROOF DRAIN, REFER TO MECHANICAL DRAWINGS.

PROJECT LA CROSSE

**CAR WASH** 


LA CROSSE DATE PROJECT NO. FILE NAME DRAWN BY DESIGNED BY


TITLE

**CLERESTORY &** REFLECTED **CEILING PLAN** 

A1-31

PR

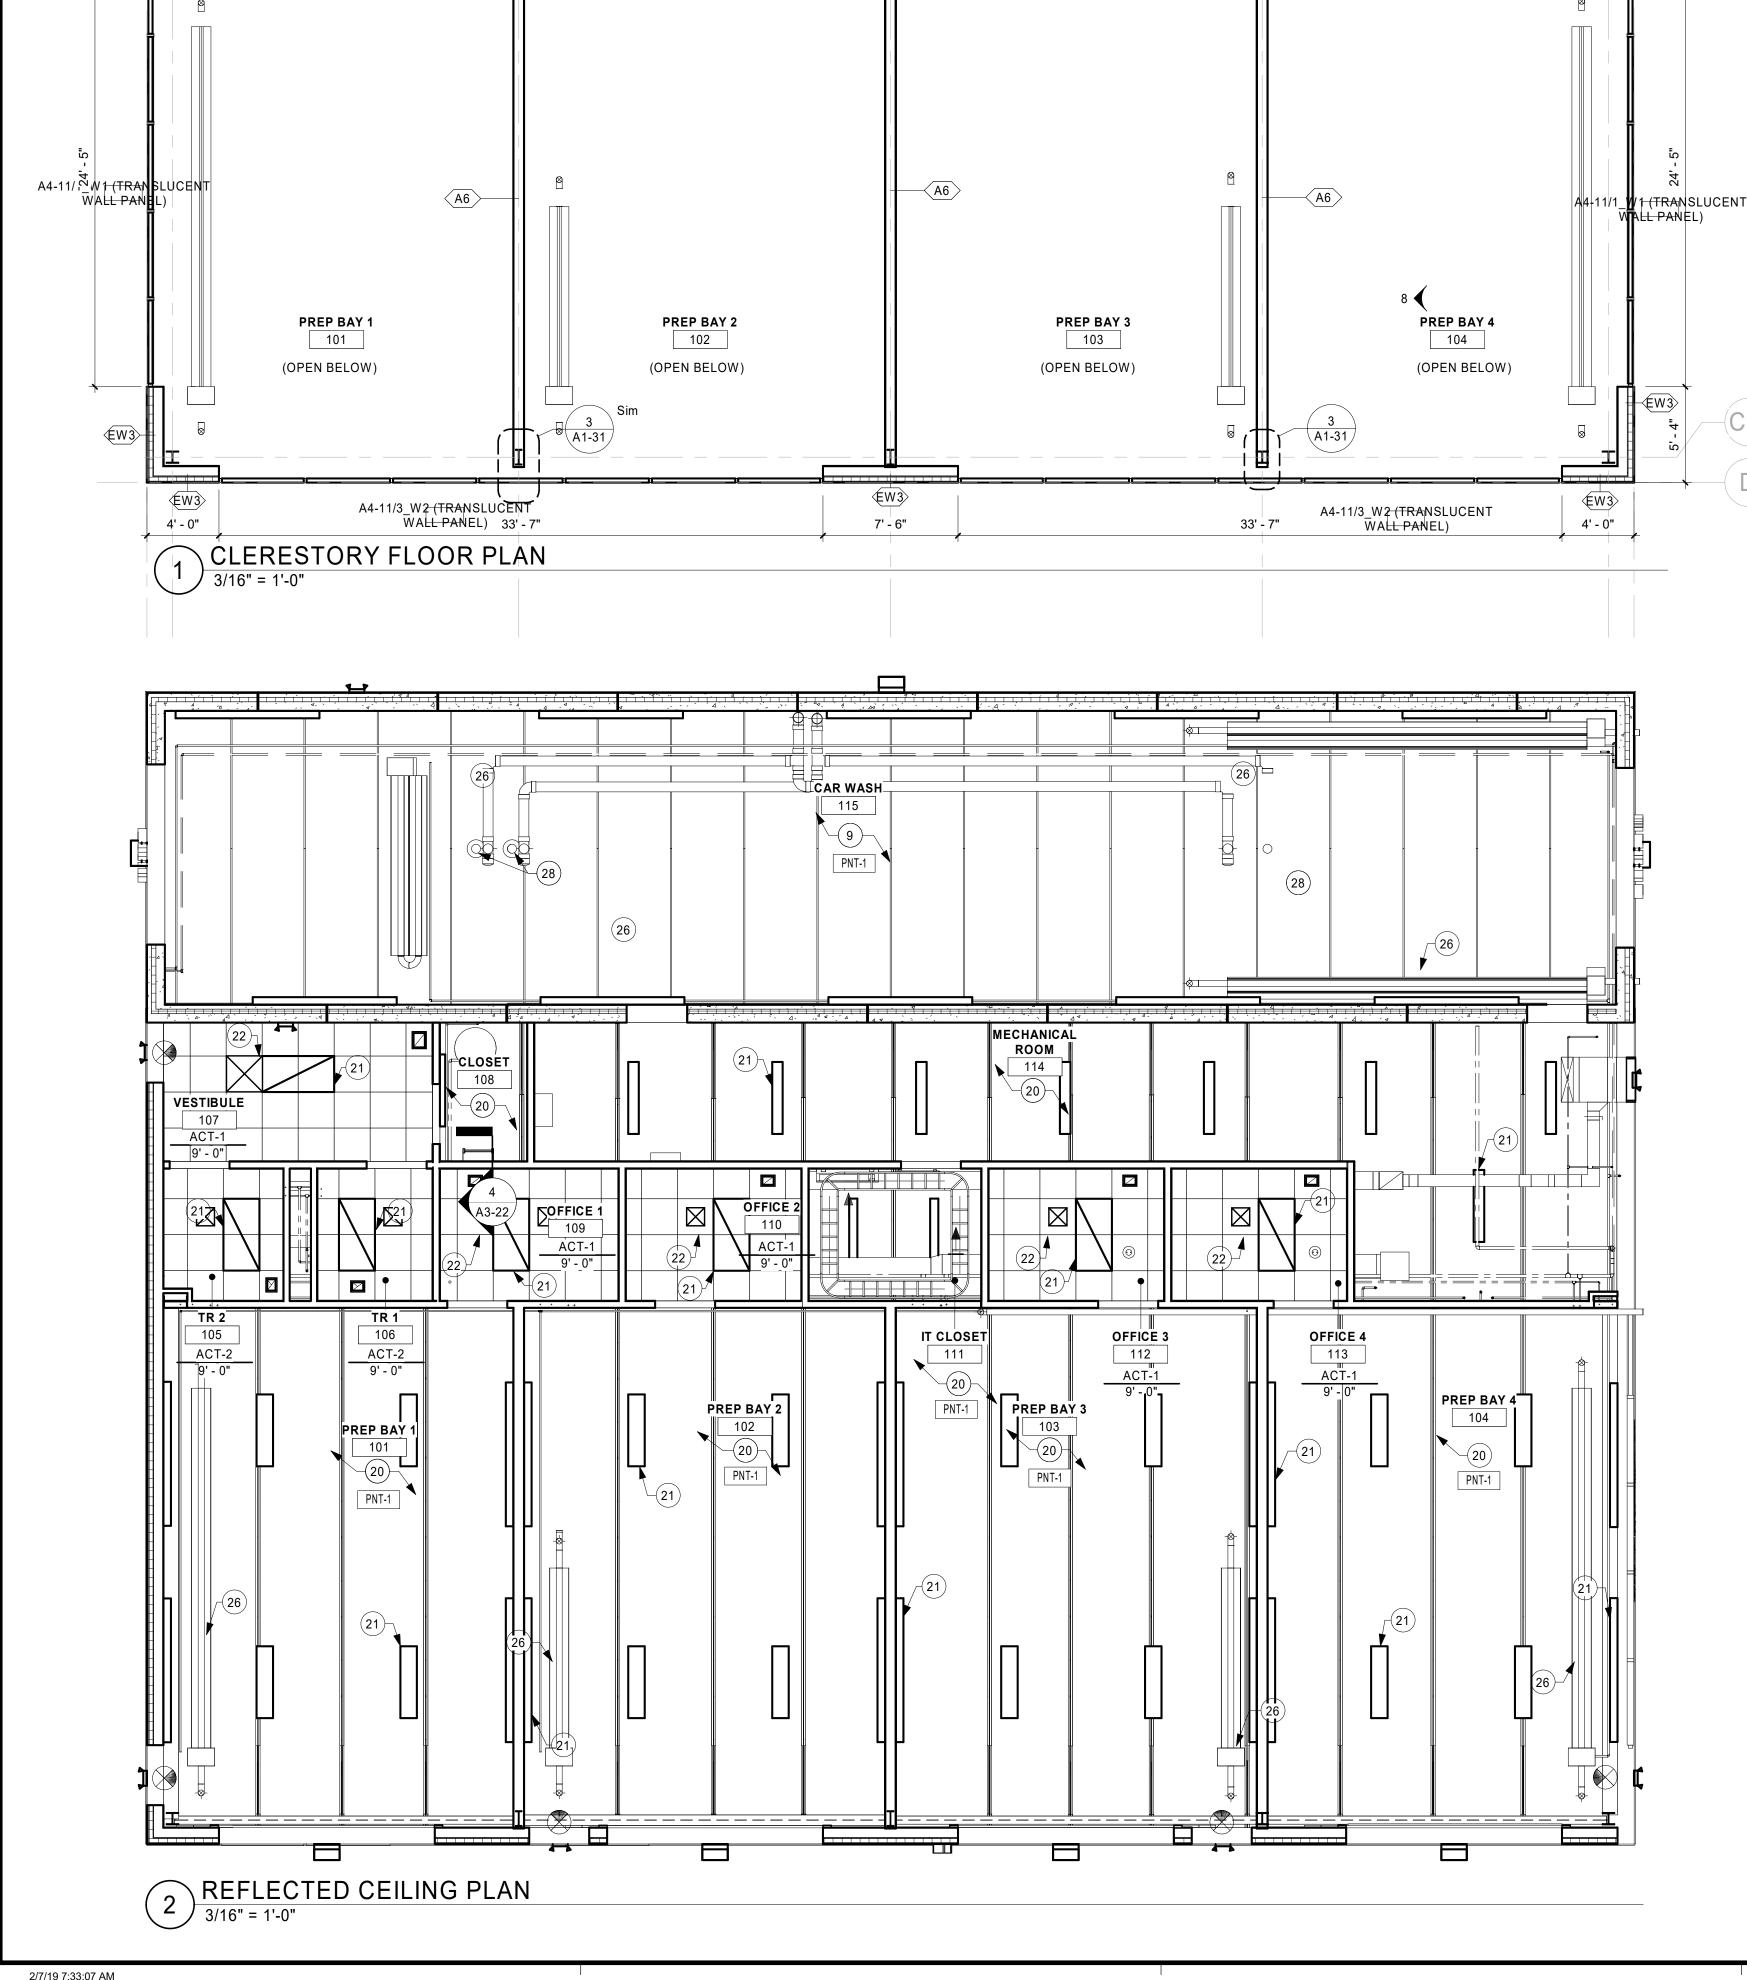

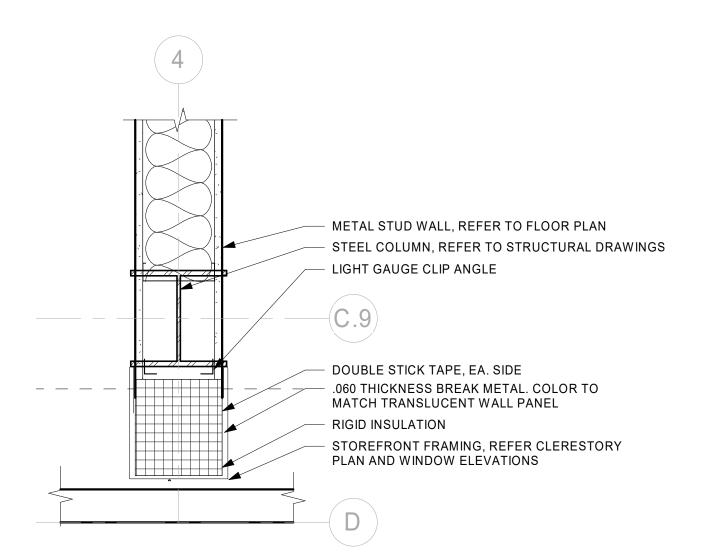

3 STUD WALL TO GLAZING -DETAIL
1 1/2" = 1'-0"

\FINISH PLAN

PROJECT FINISH NOTES

SOME SPECIFIED PRODUCTS AND FINISHES MAY HAVE SUBSTANTIAL LEAD TIMES. THE CONTRACTOR SHALL BE RESPONSIBLE FOR PLACING ORDERS IN A MANNER TO ENSURE THEIR TIMELY ARRIVAL. THE CONTRACTOR SHALL BE RESPONSIBLE FOR EXPENSES, INCLUDING DESIGN FEES, RELATED TO ANY RESELECTIONS REQUIRED DUE TO FAILURE TO ORDER PRODUCTS IN A TIMELY MANNER.

ALL FINISH WORK SHALL BE PERFORMED IN COMPLIANCE WITH DRAWINGS AND SPECIFICATIONS, SHOP DRAWINGS, SAMPLES, AND PRODUCT DATA SHALL BE SUBMITTED TO THE ARCHITECT FOR THEIR REVIEW PRIOR TO BEGINNING WORK.

WOOD DOORS, FRAMES, BASE MOLDING TO BE FILLED, STAINED, SEALED AND SHOP FINISHED TO MATCH ARCHITECT'S SAMPLE. WORK SHOULD BE PERFORMED IN A DUST FREE ENVIRONMENT.

4. UNLESS OTHERWISE INDICATED, PROVIDE PRODUCTS OF QUALITY SPECIFIED BY AWI/AWMAC/WI ARCHITECTURAL WOODWORK STANDARDS FOR CUSTOM GRADE.

INSTALL FIRE TREATED BLOCKING AS REQUIRED IN ALL PARTITIONS TO RECEIVE COUNTERS, SHELVING, MARKER BOARDS, ETC.

ALL UPPER CABINETS TO BE 14" OUTSIDE DIMENSION, UNLESS NOTED

OTHERWISE.

ALL EXPOSED ENDS OF CABINETS TO HAVE FINISHED END PANELS.

8. VERIFY GROMMET LOCATIONS WITH OWNER.

IN-WALL OR WALL SUPPORT BRACKETS TO BE PAINTED TO MATCH WALL FINISH, UNLESS NOTED OTHERWISE.
 TELEVISIONS TO BE SUPPLIED BY OWNER AND INSTALLED BY CONTRACTOR; REFER TO ELEC DOCUMENTS FOR MOUNTING HEIGHTS.

APPLIANCES PROVIDED BY OWNER, INSTALLED BY CONTRACTOR.
 ALL WALLS TO RECEIVE PNT-1 & B-1, UNLESS NOTED OTHERWISE.
 EXTEND ALL FLOORING UNDER FURNITURE, DESKS AND COUNTERS, UNLESS NOTED OTHERWISE. EXTEND ONLY TILE FLOORING UNDER CASEWORK, UNLESS NOTED OTHERWISE.

ALL TRANSITIONS TO BE CENTERED UNDER DOOR IN CLOSED POSITION, UNLESS NOTED OTHERWISE.

 ALL CARPET-TO-CARPET TRANSITIONS TO BE ADHERED SEAMS, UNLESS

NOTED OTHERWISE.

16. REFER TO THE INSTALLATION SYMBOL FOR FLOORING INSTALLATION DIRECTION.

17. HATCH PATTERNS ON FLOOR FINISH PLAN INDICATE LOCATIONS OF DIFFERENT FLOORING TYPES.

18. CARPET INSTALLATION SHALL USE LOCK RELEASE GLUE, UNLESS NOTED OTHERWISE.

#### **KEYNOTE LEGEND**

85 OMIT FLASH COVE AT MOP SINK.86 PROVIDE FRP-1 TO 4'-0" A.F.F. ON WALLS ADJACENT TO MOP SINK.

PREP BAY 1

PREP BAY 2

PREP BAY 3

PREP BAY 3

PREP BAY 3

PREP BAY 3

PREP BAY 4

PREP BAY 3

PREP BAY 4

PREP BAY 3

PREP BAY 3

PREP BAY 4

PREP BAY 3

PREP B

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PROJECT

LA CROSSE REGIONAL AIRPORT CAR WASH FACILITY

CONSIN	LA CROSSE WISCONSIN							
	REVISION SCHEDULE							
BY	DESCRIPTION	DATE						
	10.01100							
	18-21496	PROJECT NO.						
	21496 Arch R18.rvt	FILE NAME						
	DRAWN BY							
		DESIGNED BY						
	REVIEWED BY							
	ГЕ	ORIGINAL ISSUE						


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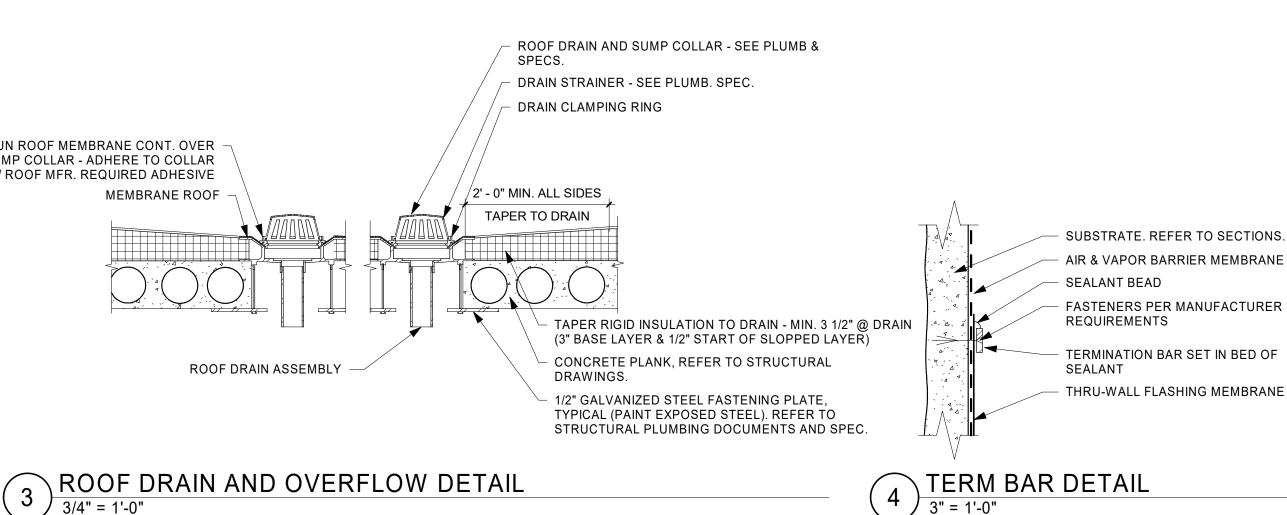
FINISH PLAN AND FINISH LEGENDS


SHEET

**A1-41** 

2/7/19 7:33:10 AM



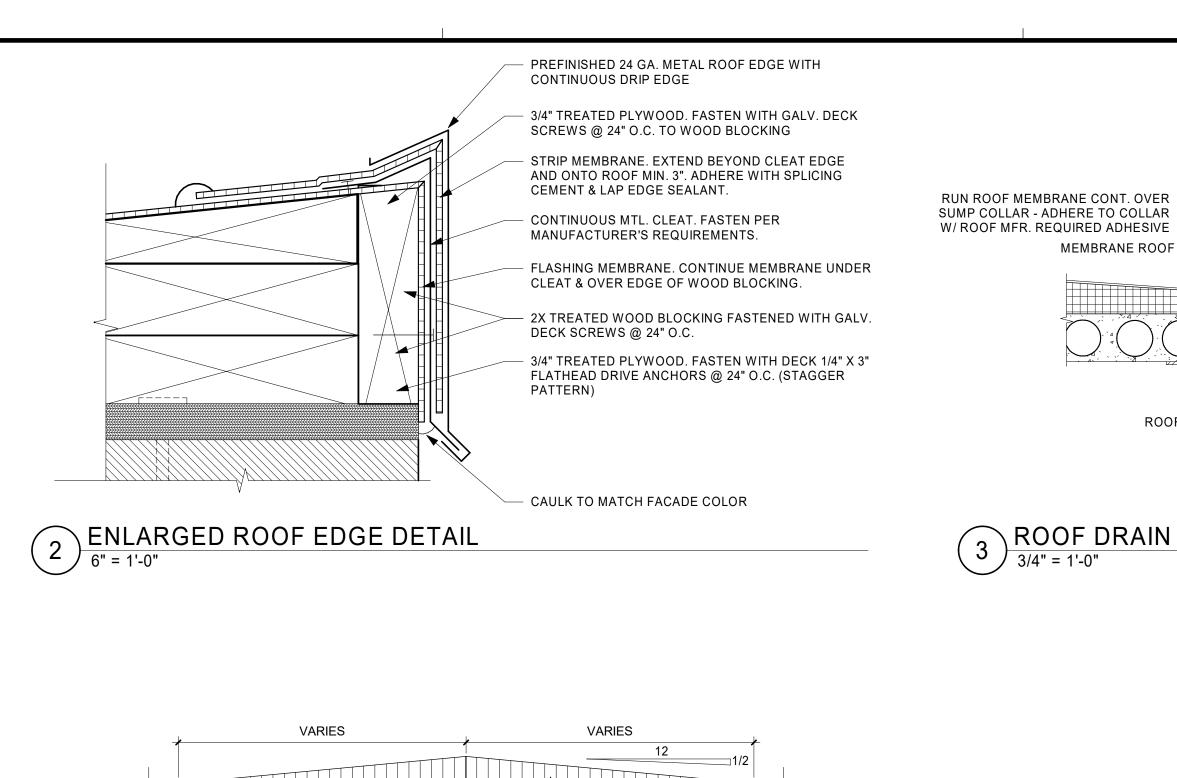

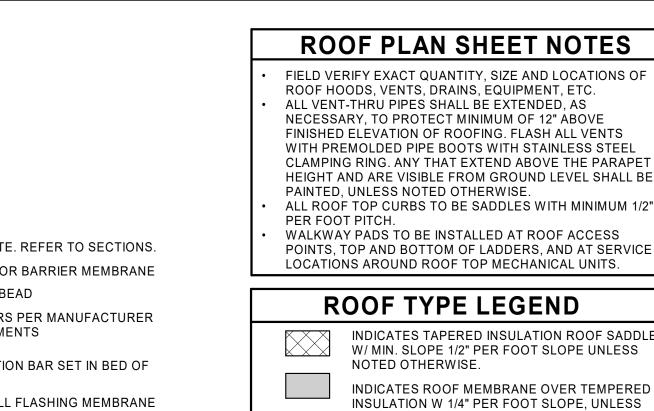

ALL VENT-THRU PIPES SHALL BE EXTENDED, AS NECESSARY, TO PROTECT MINIMUM OF 12" ABOVE FINISHED ELEVATION OF ROOFING. FLASH ALL VENTS WITH PREMOLDED PIPE BOOTS WITH STAINLESS STEEL CLAMPING RING. ANY THAT EXTEND ABOVE THE PARAPET HEIGHT AND ARE VISIBLE FROM GROUND LEVEL SHALL BE PAINTED, UNLESS NOTED OTHERWISE. ALL ROOF TOP CURBS TO BE SADDLES WITH MINIMUM 1/2" PER FOOT PITCH.

WALKWAY PADS TO BE INSTALLED AT ROOF ACCESS POINTS, TOP AND BOTTOM OF LADDERS, AND AT SERVICE LOCATIONS AROUND ROOF TOP MECHANICAL UNITS.

### **ROOF TYPE LEGEND**

NOTED OTHERWISE.

INDICATES TAPERED INSULATION ROOF SADDLE W/ MIN. SLOPE 1/2" PER FOOT SLOPE UNLESS NOTED OTHERWISE. INDICATES ROOF MEMBRANE OVER TEMPERED INSULATION W 1/4" PER FOOT SLOPE, UNLESS


#### **KEYNOTE LEGEND**

- 27 VENT PIPE, REFER TO MECHANICAL DRAWINGS. R1 ROOF TYPE R1, FULLY ADHERED ROOFING MEMBRANE OVER TAPERED INSULATION, REFER TO SHEET A1-01 CONSTRUCTION ASSEMBLIES.
- R2 ROOF TYPE R2 REFER TO SHEET A1-01 CONSTRUCTION ASSEMBLIES.
- R5 DOWNSPOUT, REFER TO DETAIL.
- R6 ROOF ACCESS HATCH, REFER TO ROOF ACCESS DETAIL.

R7 GUTTER, REFER TO DETAIL.


TAPERED RIGID INSULATION ROOF SADDLE (MAINTAIN 1/2" PER FT. SLOPE FROM LEVEL SURFACE) RIGID INSULATION BASE PER ROOF SYSTEM (LEVEL ROOF DECK)

ROOF SADDLE DETAIL 1 1/2" = 1'-0"

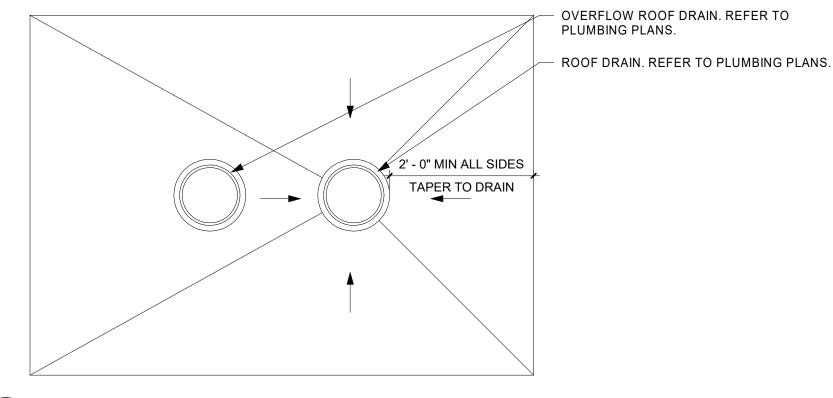


ROOF DRAIN AND OVERFLOW PLAN DETAIL

3/4" = 1'-0"

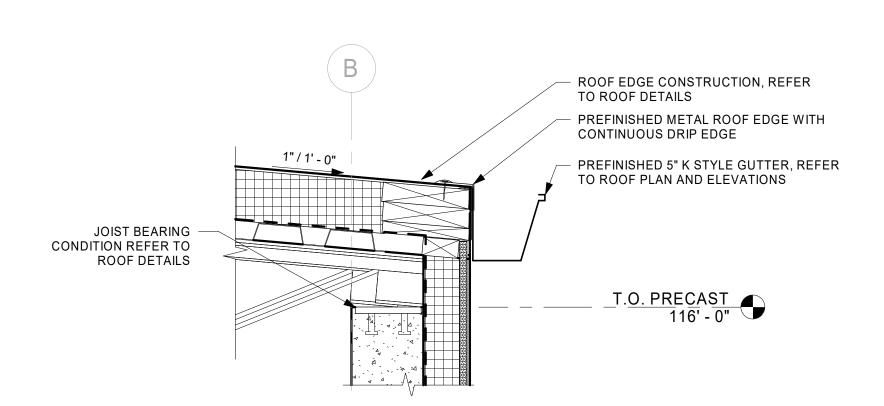

7 ROOF GUTTER DETAIL
1 1/2" = 1'-0"

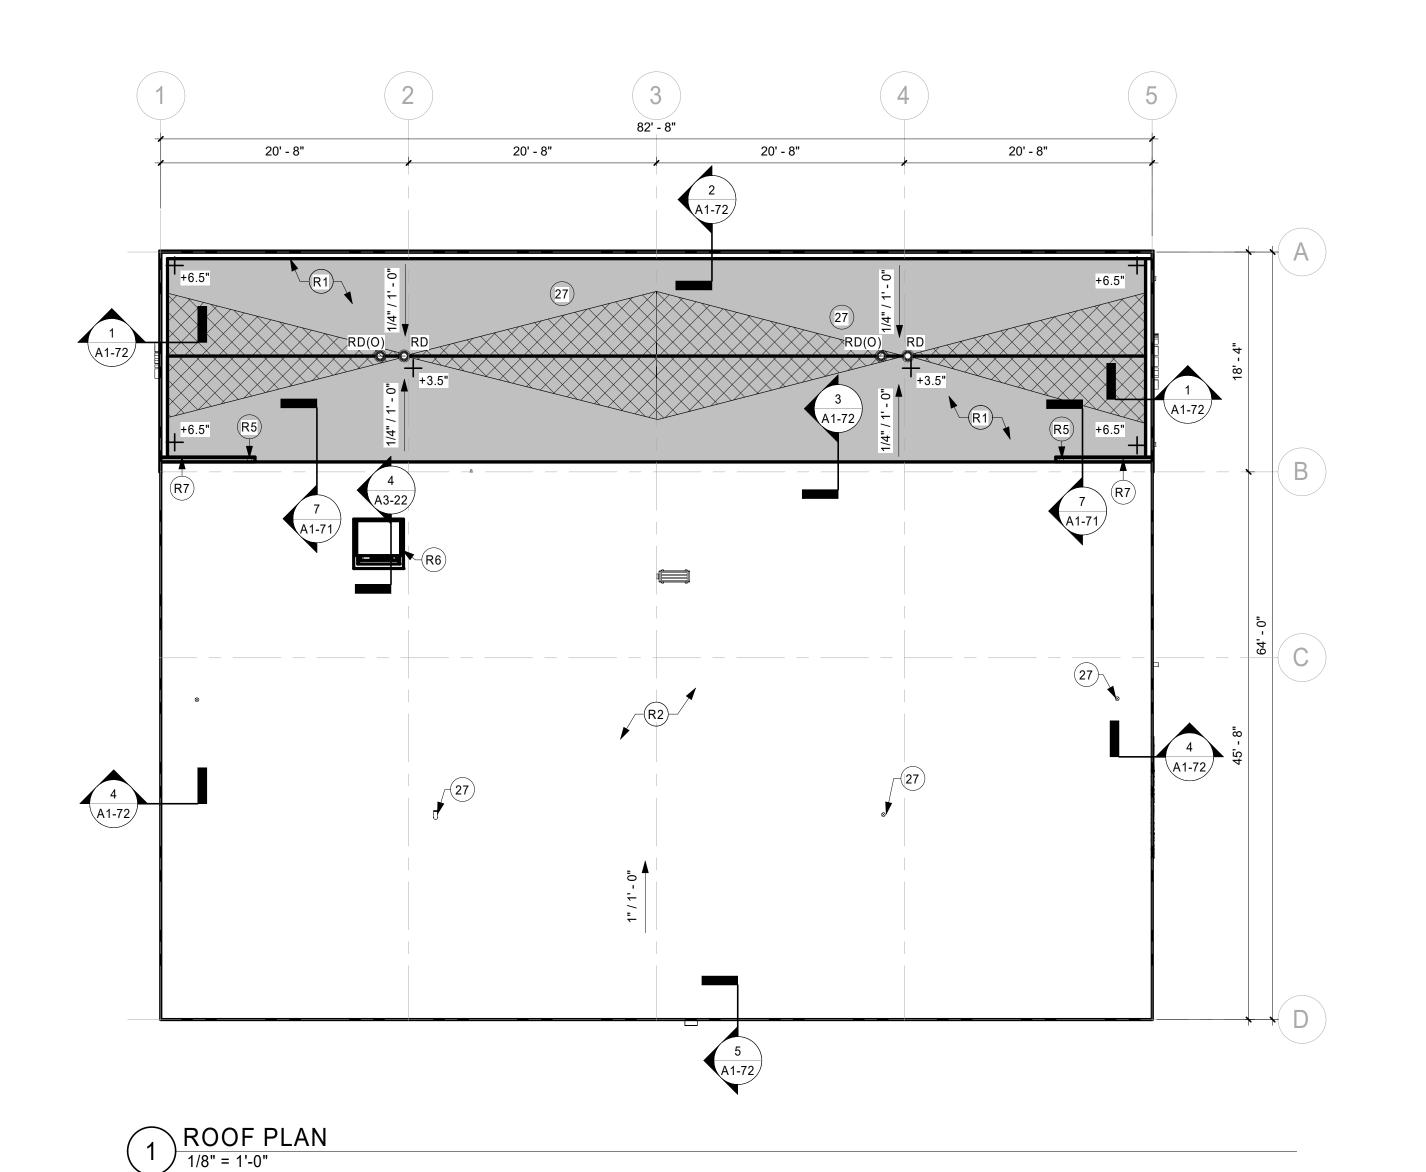

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LA CROSSE **REGIONAL AIRPORT CAR WASH FACILITY** 

WISCONSIN LA CROSSE REVISION SCHEDULE DATE DESCRIPTION 18-21496 PROJECT NO. FILE NAME 21496 Arch R18.rvt DRAWN BY DESIGNED BY KMB REVIEWED BY KMB

TITLE

CLIENT PROJECT NO.

ORIGINAL ISSUE DATE 01/14/2019

**ROOF PLAN AND DETAILS** 

A1-71

2/7/19 7:33:13 AM

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\PRECAST ROOF AT BEARING DETAIL

3/4" PLYWOOD. FASTEN WITH 1/4" X 3"

5/8" EXTERIOR GRADE PLYWOOD

WITH 3" RIGID INSULATION

(STAGGER PATTERN)

RECOMMENDATIONS

STRUCTURAL PLANS

SEALANT AT ALL JOINTS

DOWEL INTO PC WALL

INSULATION

FLATHEAD DRIVE ANCHORS @ 24" O.C.

VAPOR RETARDER. CONTINUE OVER WALL.

SHEATHING ON WOOD FURRING @ 16" O.C.

FLASHING MEMBRANE UP & OVER WALL.

MANUFACTURER'S REQUIRED ADHESIVE

FLASHING MEMBRANE - MIN. 3" ONTO FIELD. ADHERE TO ROOF MEMBRANE WITH SPLICING

**CEMENT - SEAL EDGE WITH LAP SEALANT** 


FILL VOID WITH CLOSED- CELL SPRAY-FOAM

ADHERE TO WALL & BLOCKING WITH

CONFIRM WITH MANUFACTURER'S

PRECAST PLANK ROOF, REFER TO

PRECAST ROOF AT NON-BEARING DETAIL 1 1/2" = 1'-0"

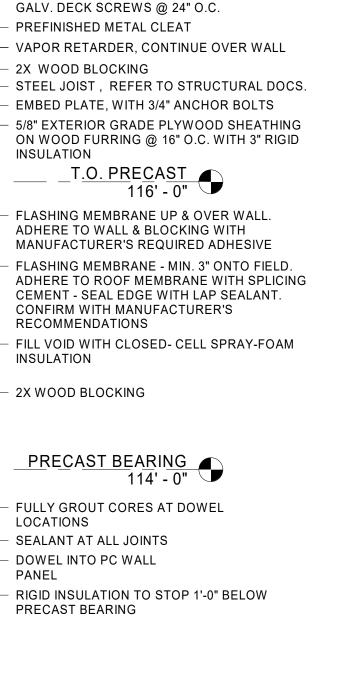

TPO ROOFING MEMBRANE


CONTINUOUS DRIP EDGE

PREFINISHED METAL ROOF EDGE WITH


2X TREATED WOOD BLOCKING FASTENED WITH

ROOF EDGE WITH JOIST SEAT - PRECAST
1 1/2" = 1'-0"

A1-01

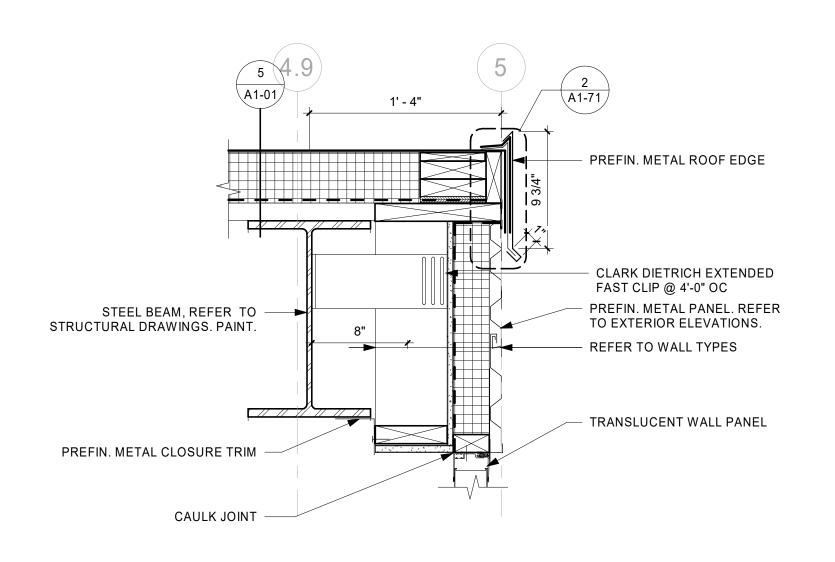

ROOF EDGE DETAIL - EAST/WEST WALL

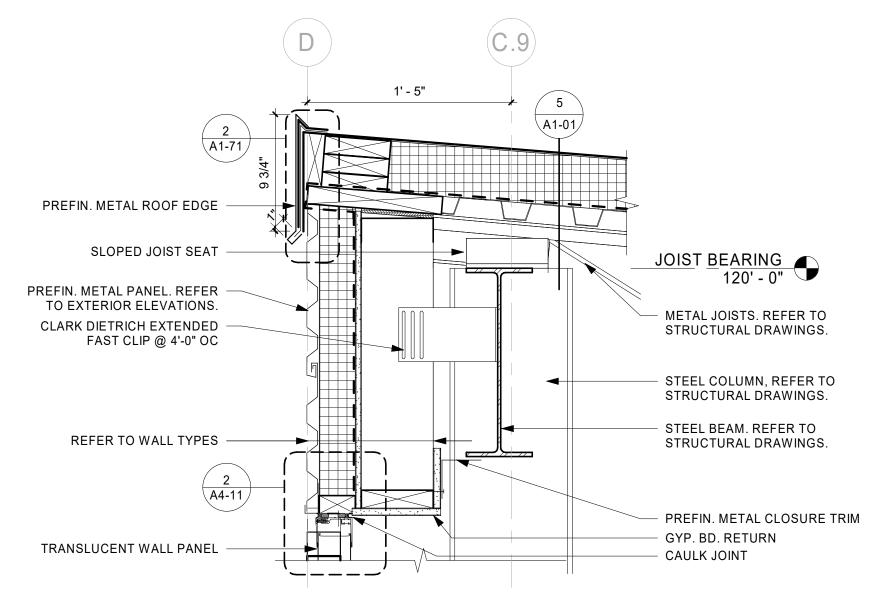

800F EDGE DETAIL - SOUTH WALL

1 1/2" = 1'-0"



2X PLATE. RIP FOR SLOPPED

T.O. PRECAST

116' - 0"

PREFIN. METAL ROOF EDGE

- EXTENSION OF PRECAST

- FILL VOID W/ RIGID INSUL.

PRECAST WALL. REFER TO

WALL PANEL

2X WD BLKG

PRECAST BEARING 114' - 0"

WALL TYPES.

TRUC

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PROJECT

LA CROSSE **REGIONAL AIRPORT CAR WASH** 

STRUC **FACILITY** LA CROSSE WISCONSIN REVISION SCHEDULE DATE DESCRIPTION 0 18-21496 PROJECT NO.

FILE NAME 21496 Arch R18.rvt SJR DRAWN BY DESIGNED BY KMB KMB REVIEWED BY ORIGINAL ISSUE DATE 01/14/2019 CLIENT PROJECT NO.

TITLE

**ROOF DETAILS** 

**A1-72** 

PR

2/7/19 7:33:14 AM

	SHEET NOTES
•	THROUGH-WALL FLASHING TO BE LOCATED ABOVE GRADE.
•	PAINT ALL EXPOSED STEEL LINTELS TO MATCH ADJACENT FACADE MATERIAL COLOR.
•	SEALANT COLORS TO MATCH ADJACENT FINISHED SURFACES.

	EXTERIOR FINISH SCHEDULE								
ARK	MATERIAL TYPE	MANUFACTURER	SERIES	SIZE	COLOR	COMMENTS			
F-01	PRECAST CONCRETE	TBD			LIGHT GRAY	ACID ETCH FINISH			
F-02	METAL PANEL	FIRESTONE	OMEGA VR CLASSIC	4"	CITYSCAPE	HORIZONTAL			
F-03	METAL PANEL	FIRESTONE	UC-500	12"	CHARCOAL GRAY	HORIZONTAL			
F-04	METAL FLASHING	FIRESTONE	METAL TRIM		CHARCOAL GRAY				


	EXTERIOR FINISH SCHEDULE								
ARK	MATERIAL TYPE	MANUFACTURER	SERIES	SIZE	COLOR	COMMENTS			
F-01	PRECAST CONCRETE	TBD			LIGHT GRAY	ACID ETCH FINISH			
F-02	METAL PANEL	FIRESTONE	OMEGA VR CLASSIC	4"	CITYSCAPE	HORIZONTAL			
F-03	METAL PANEL	FIRESTONE	UC-500	12"	CHARCOAL GRAY	HORIZONTAL			
F-04	METAL FLASHING	FIRESTONE	METAL TRIM		CHARCOAL GRAY				


<b>KEYNOTE LEGEND</b>	
LLARD, REFER TO STRUCTURAL DRAWINGS.	_


BOLLARD, REFER TO STRUCTURAL DRAWINGS.
 KNOX BOX.VERIFY LOCATION WITH LOCAL FIRE DEPARTMENT.


43 12" H. EXTERIOR SIGNAGE. REFER TO SPEC.

44 EXTERIOR SIGN. REFER TO SPEC.
R5 DOWNSPOUT, REFER TO DETAIL.
R6 ROOF ACCESS HATCH, REFER TO ROOF ACCESS DETAIL.
R7 GUTTER, REFER TO DETAIL.

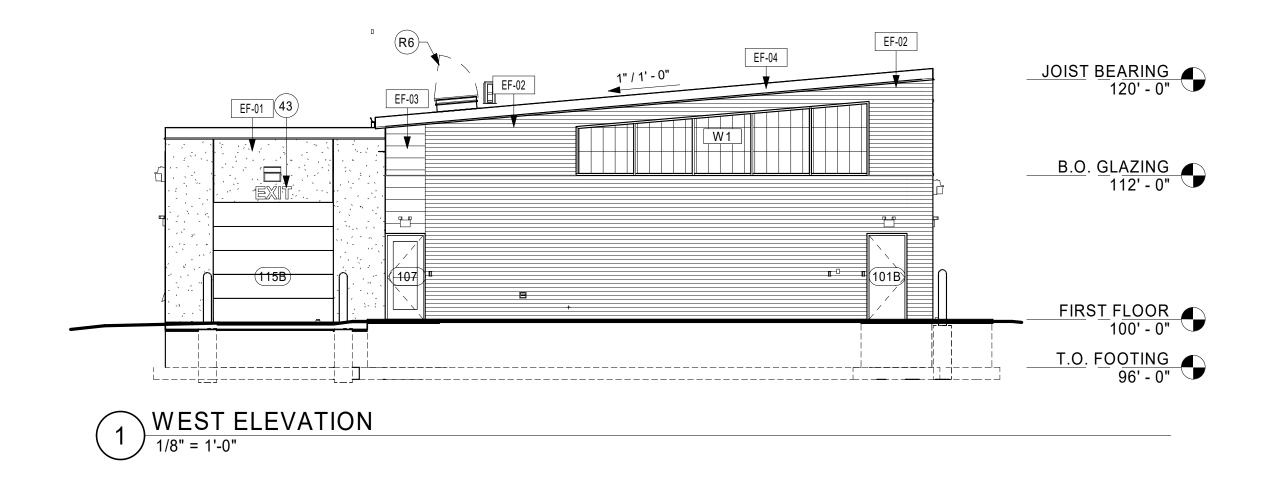

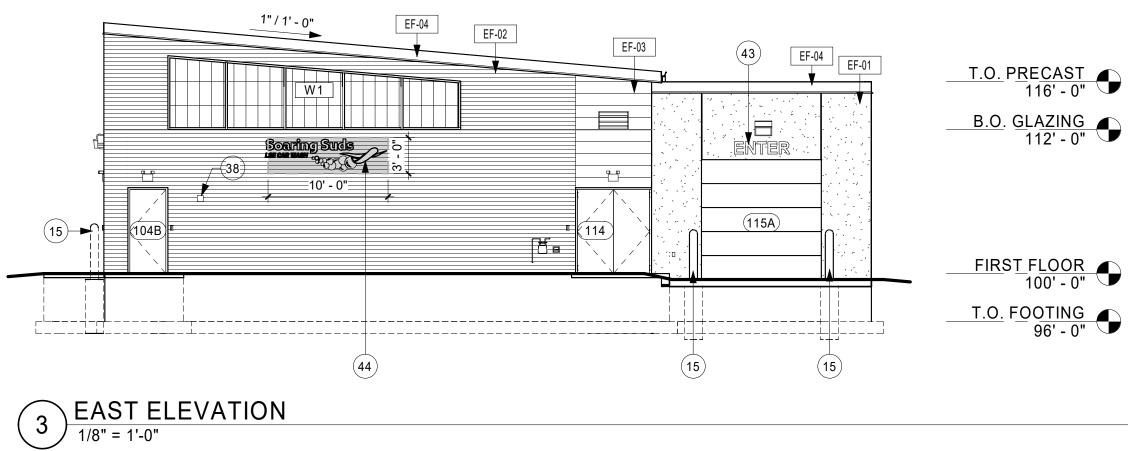

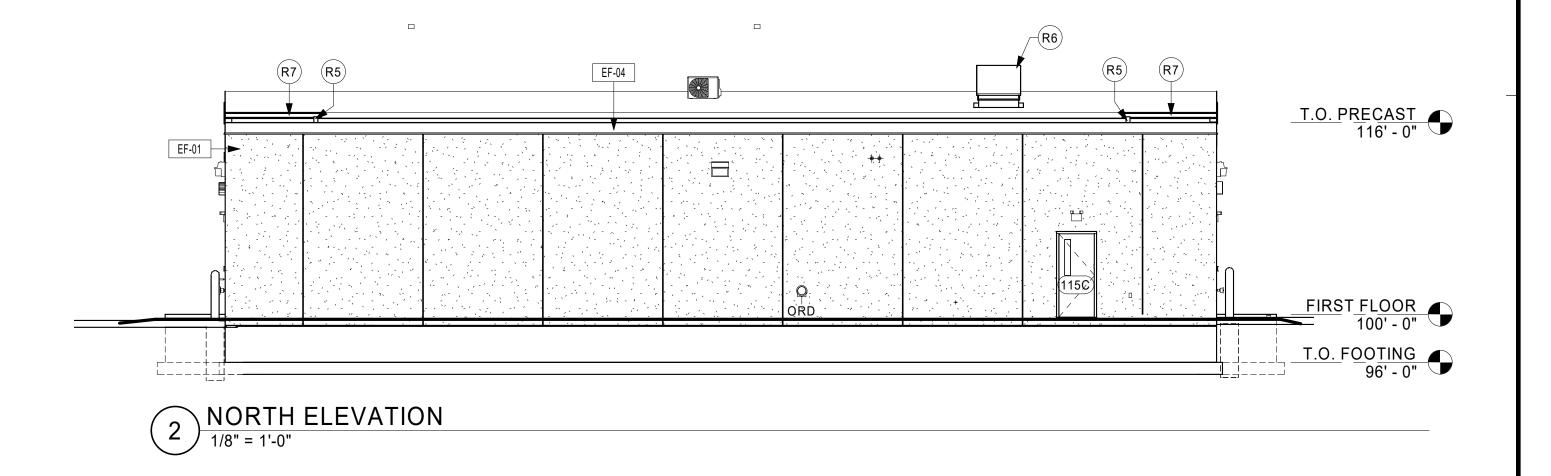

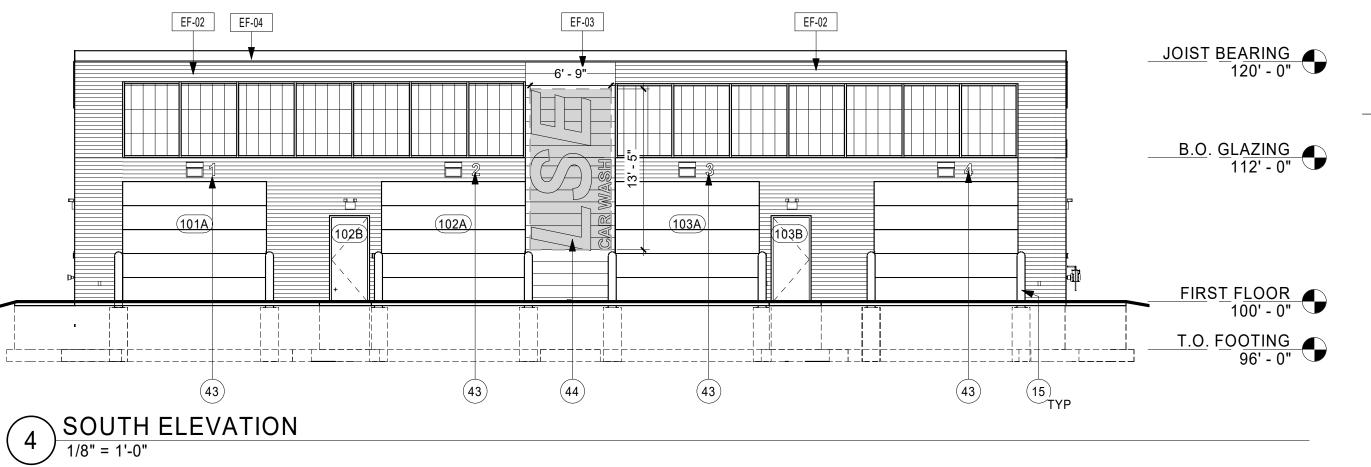

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PROJECT

LA CROSSE **REGIONAL AIRPORT** 

**CAR WASH FACILITY** 

WISCONSIN LA CROSSE REVISION SCHEDULE DATE DESCRIPTION **O** R 18-21496 PROJECT NO. 21496 Arch R-18.rvt FILE NAME DRAWN BY


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CLIENT PROJECT NO.

TITLE

**EXTERIOR ELEVATIONS** 

**A2-11** 

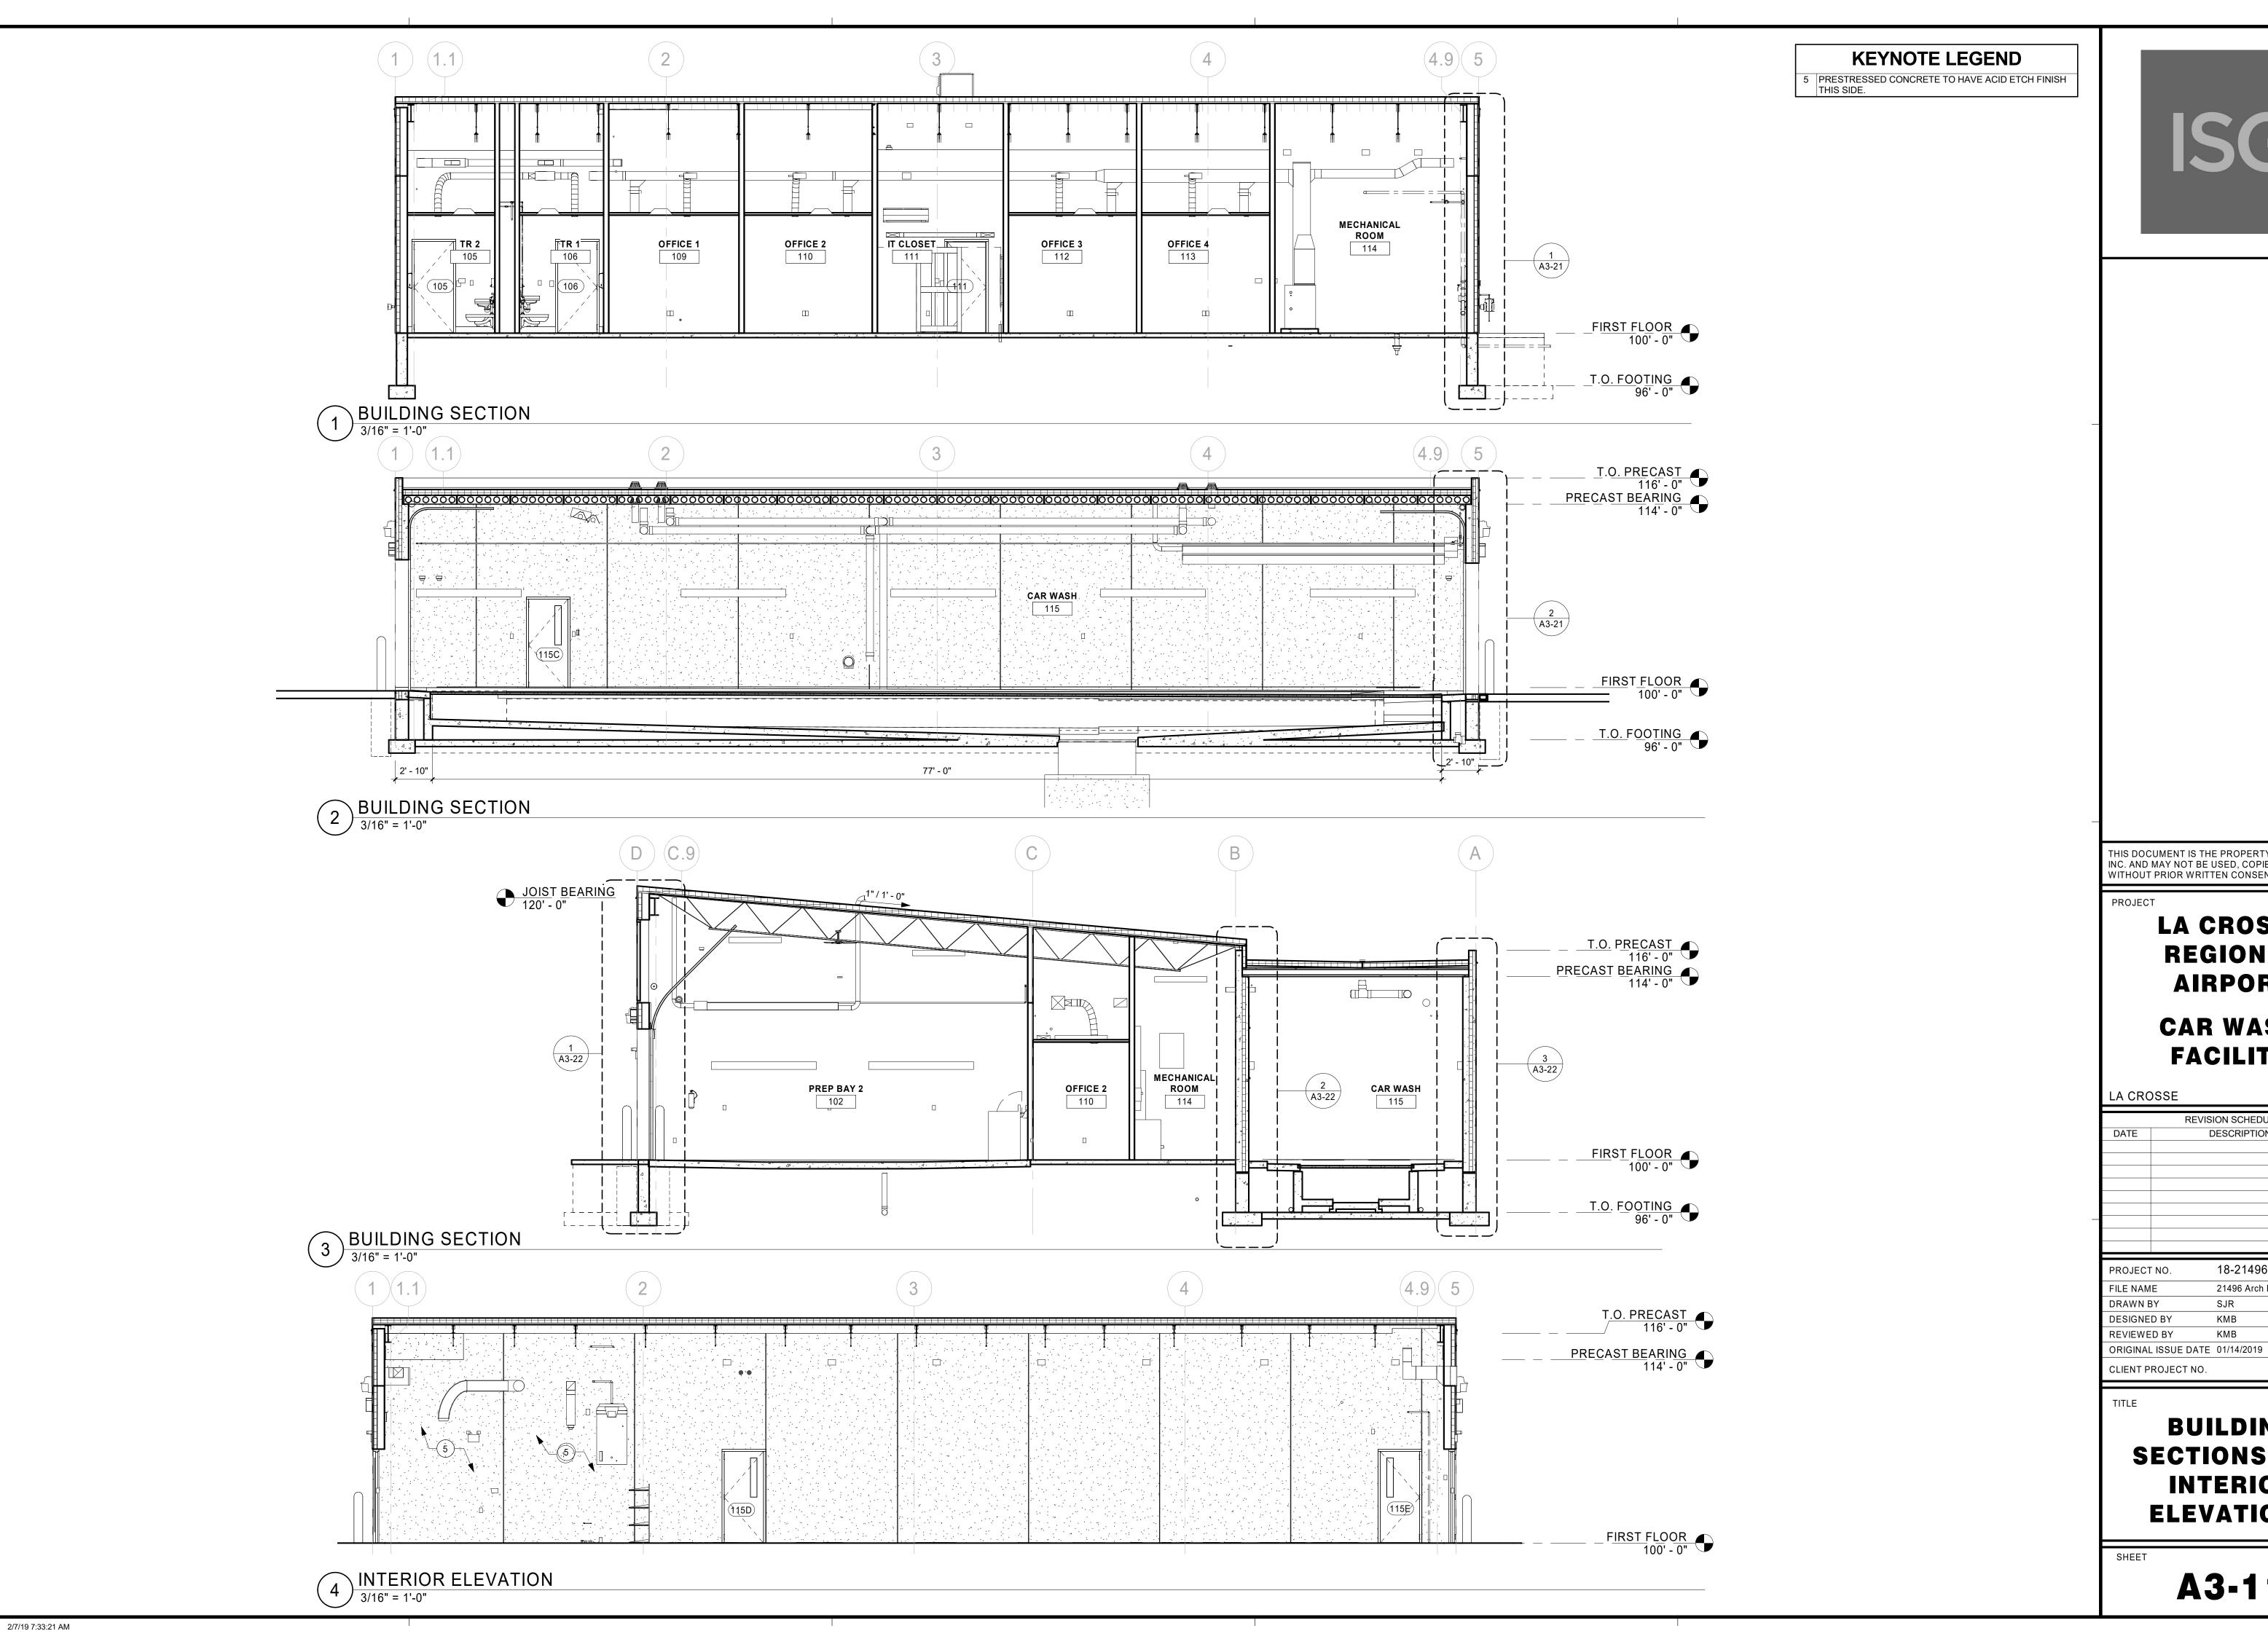

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LA CROSSE **REGIONAL AIRPORT** 


**CAR WASH FACILITY** 

ONSTRUC WISCONSIN REVISION SCHEDULE DESCRIPTION OR 18-21496 21496 Arch R18.rvt KMB

**BUILDING SECTIONS AND** INTERIOR **ELEVATIONS** 

PRELIMINAR

KMB

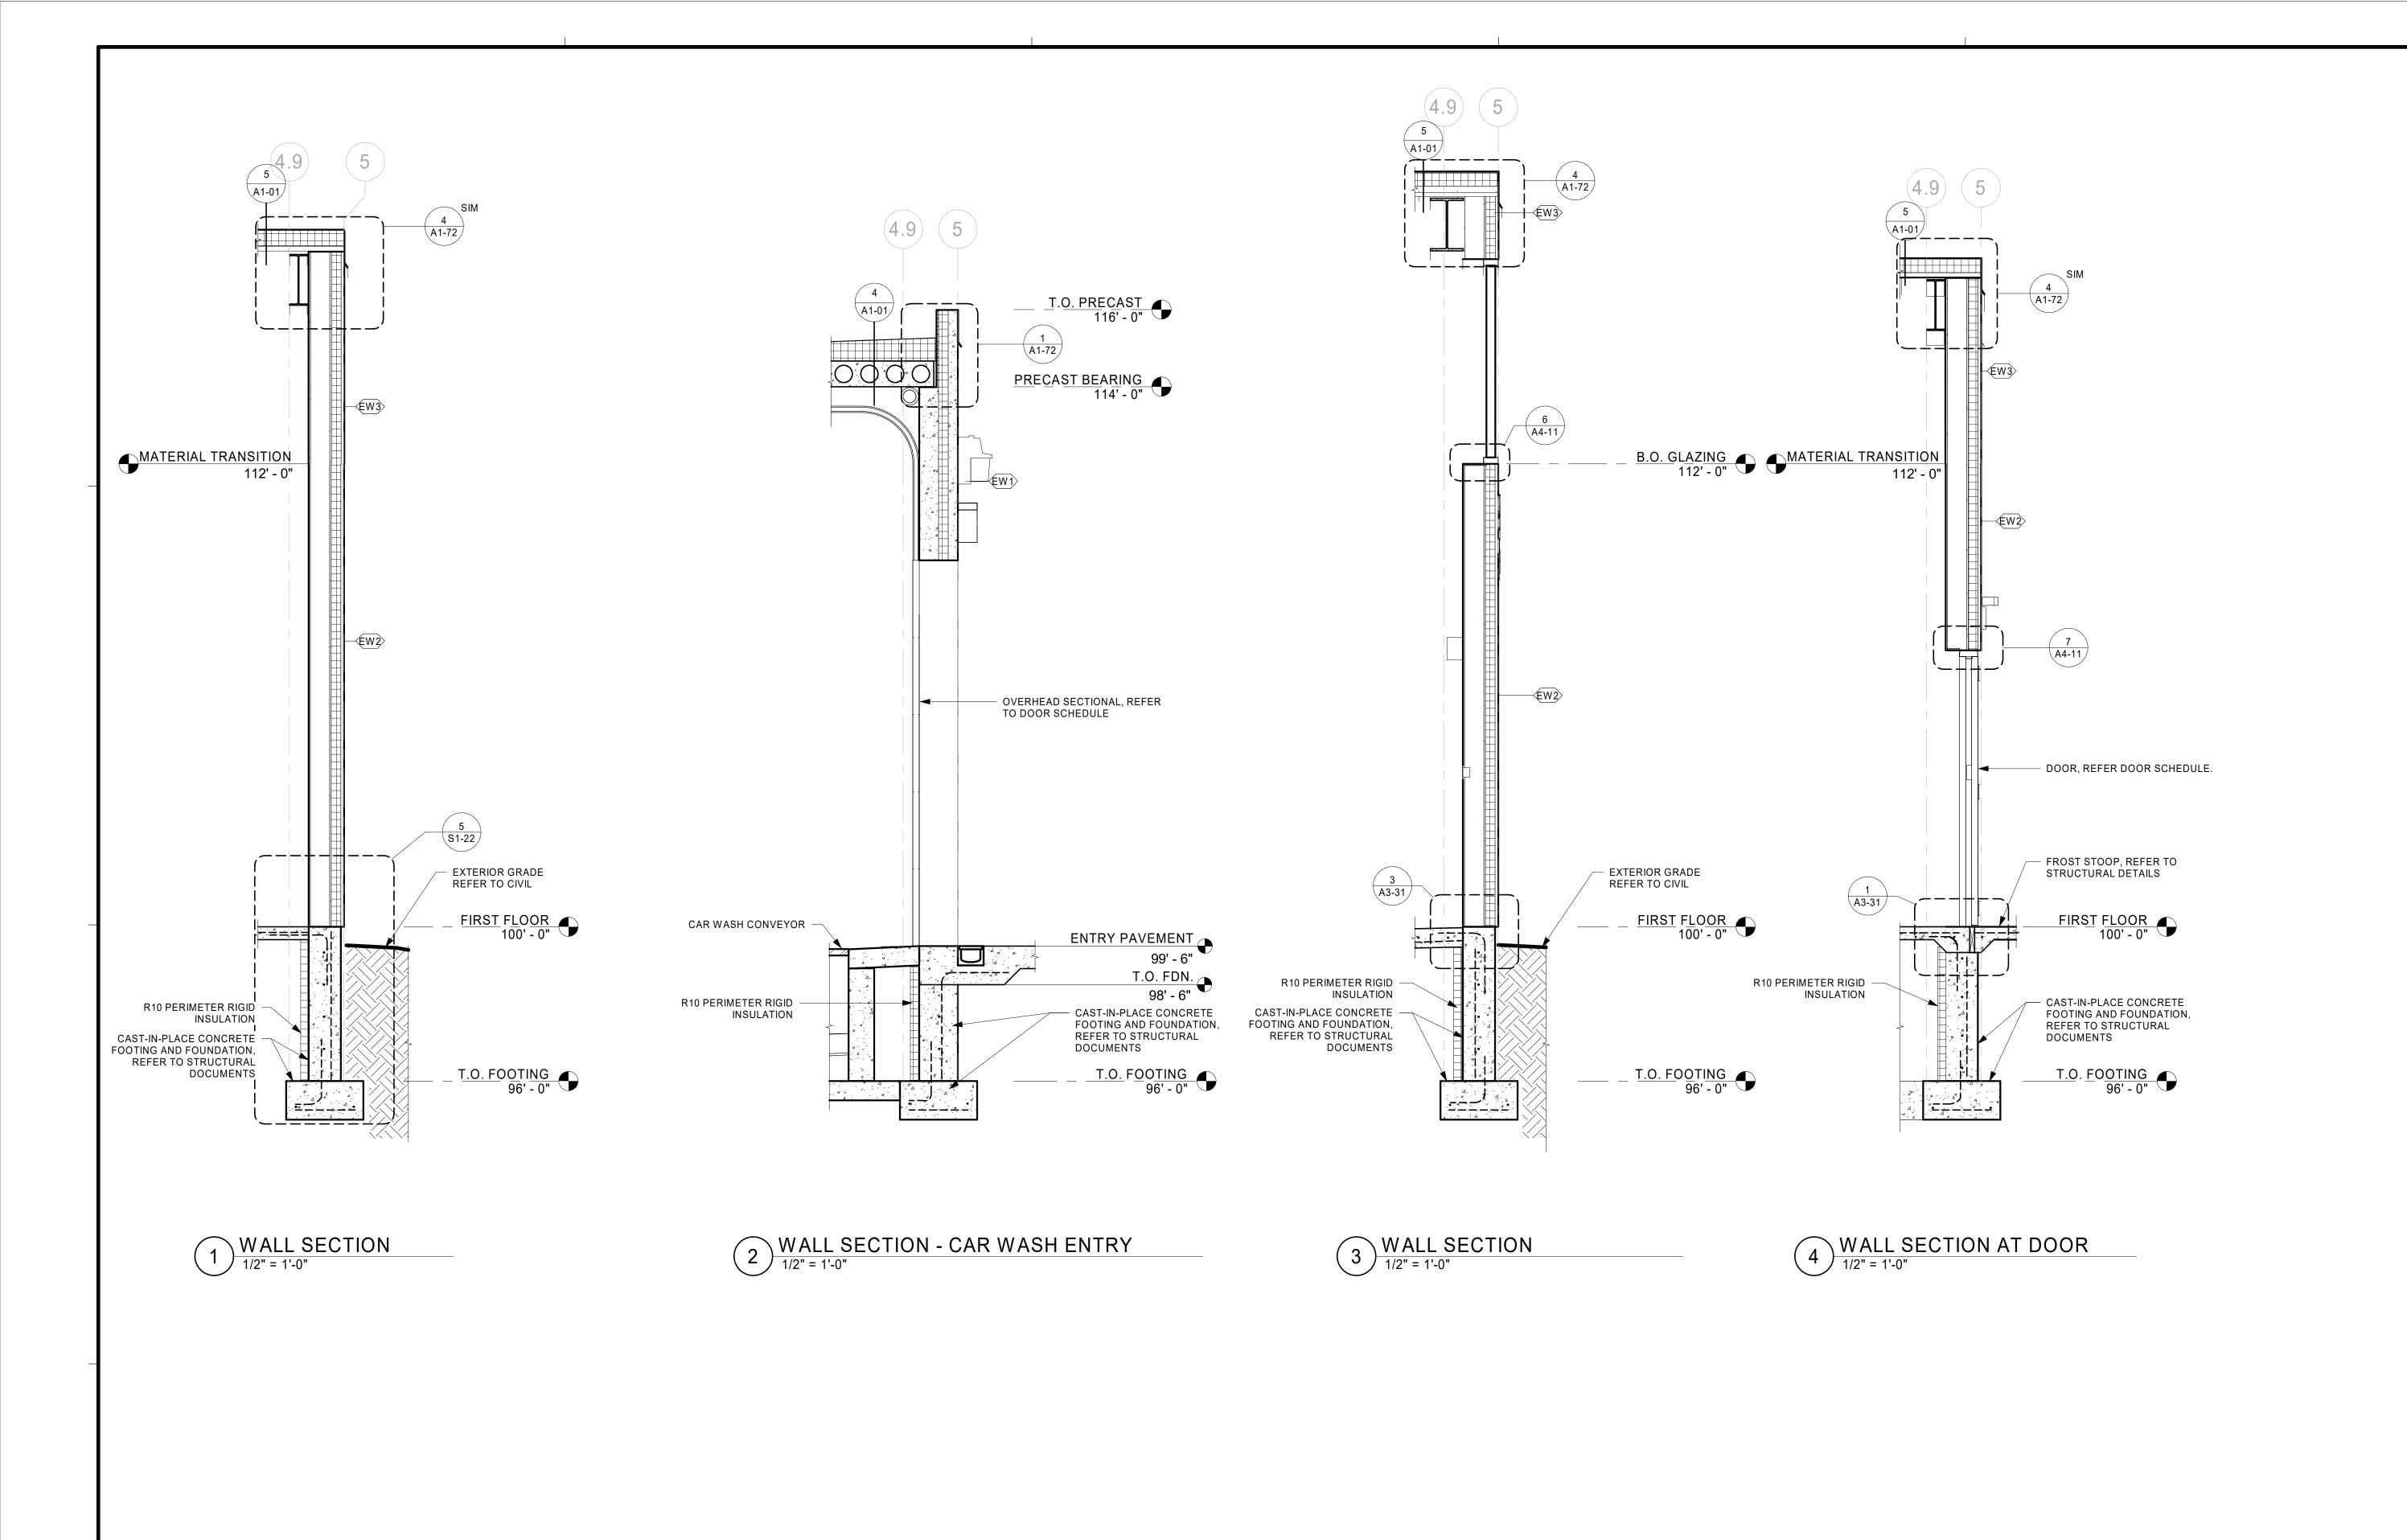

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PROJECT

LA CROSSE REGIONAL AIRPORT

CAR WASH FACILITY

REVISION SCHEDULE

DATE DESCRIPTION BY

PROJECT NO. 18-21496

FILE NAME 21496 Arch R18.rvt

DRAWN BY SJR

DESIGNED BY KMB

REVIEWED BY KMB


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TITLE

WALL SECTIONS

SHEE



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PROJECT

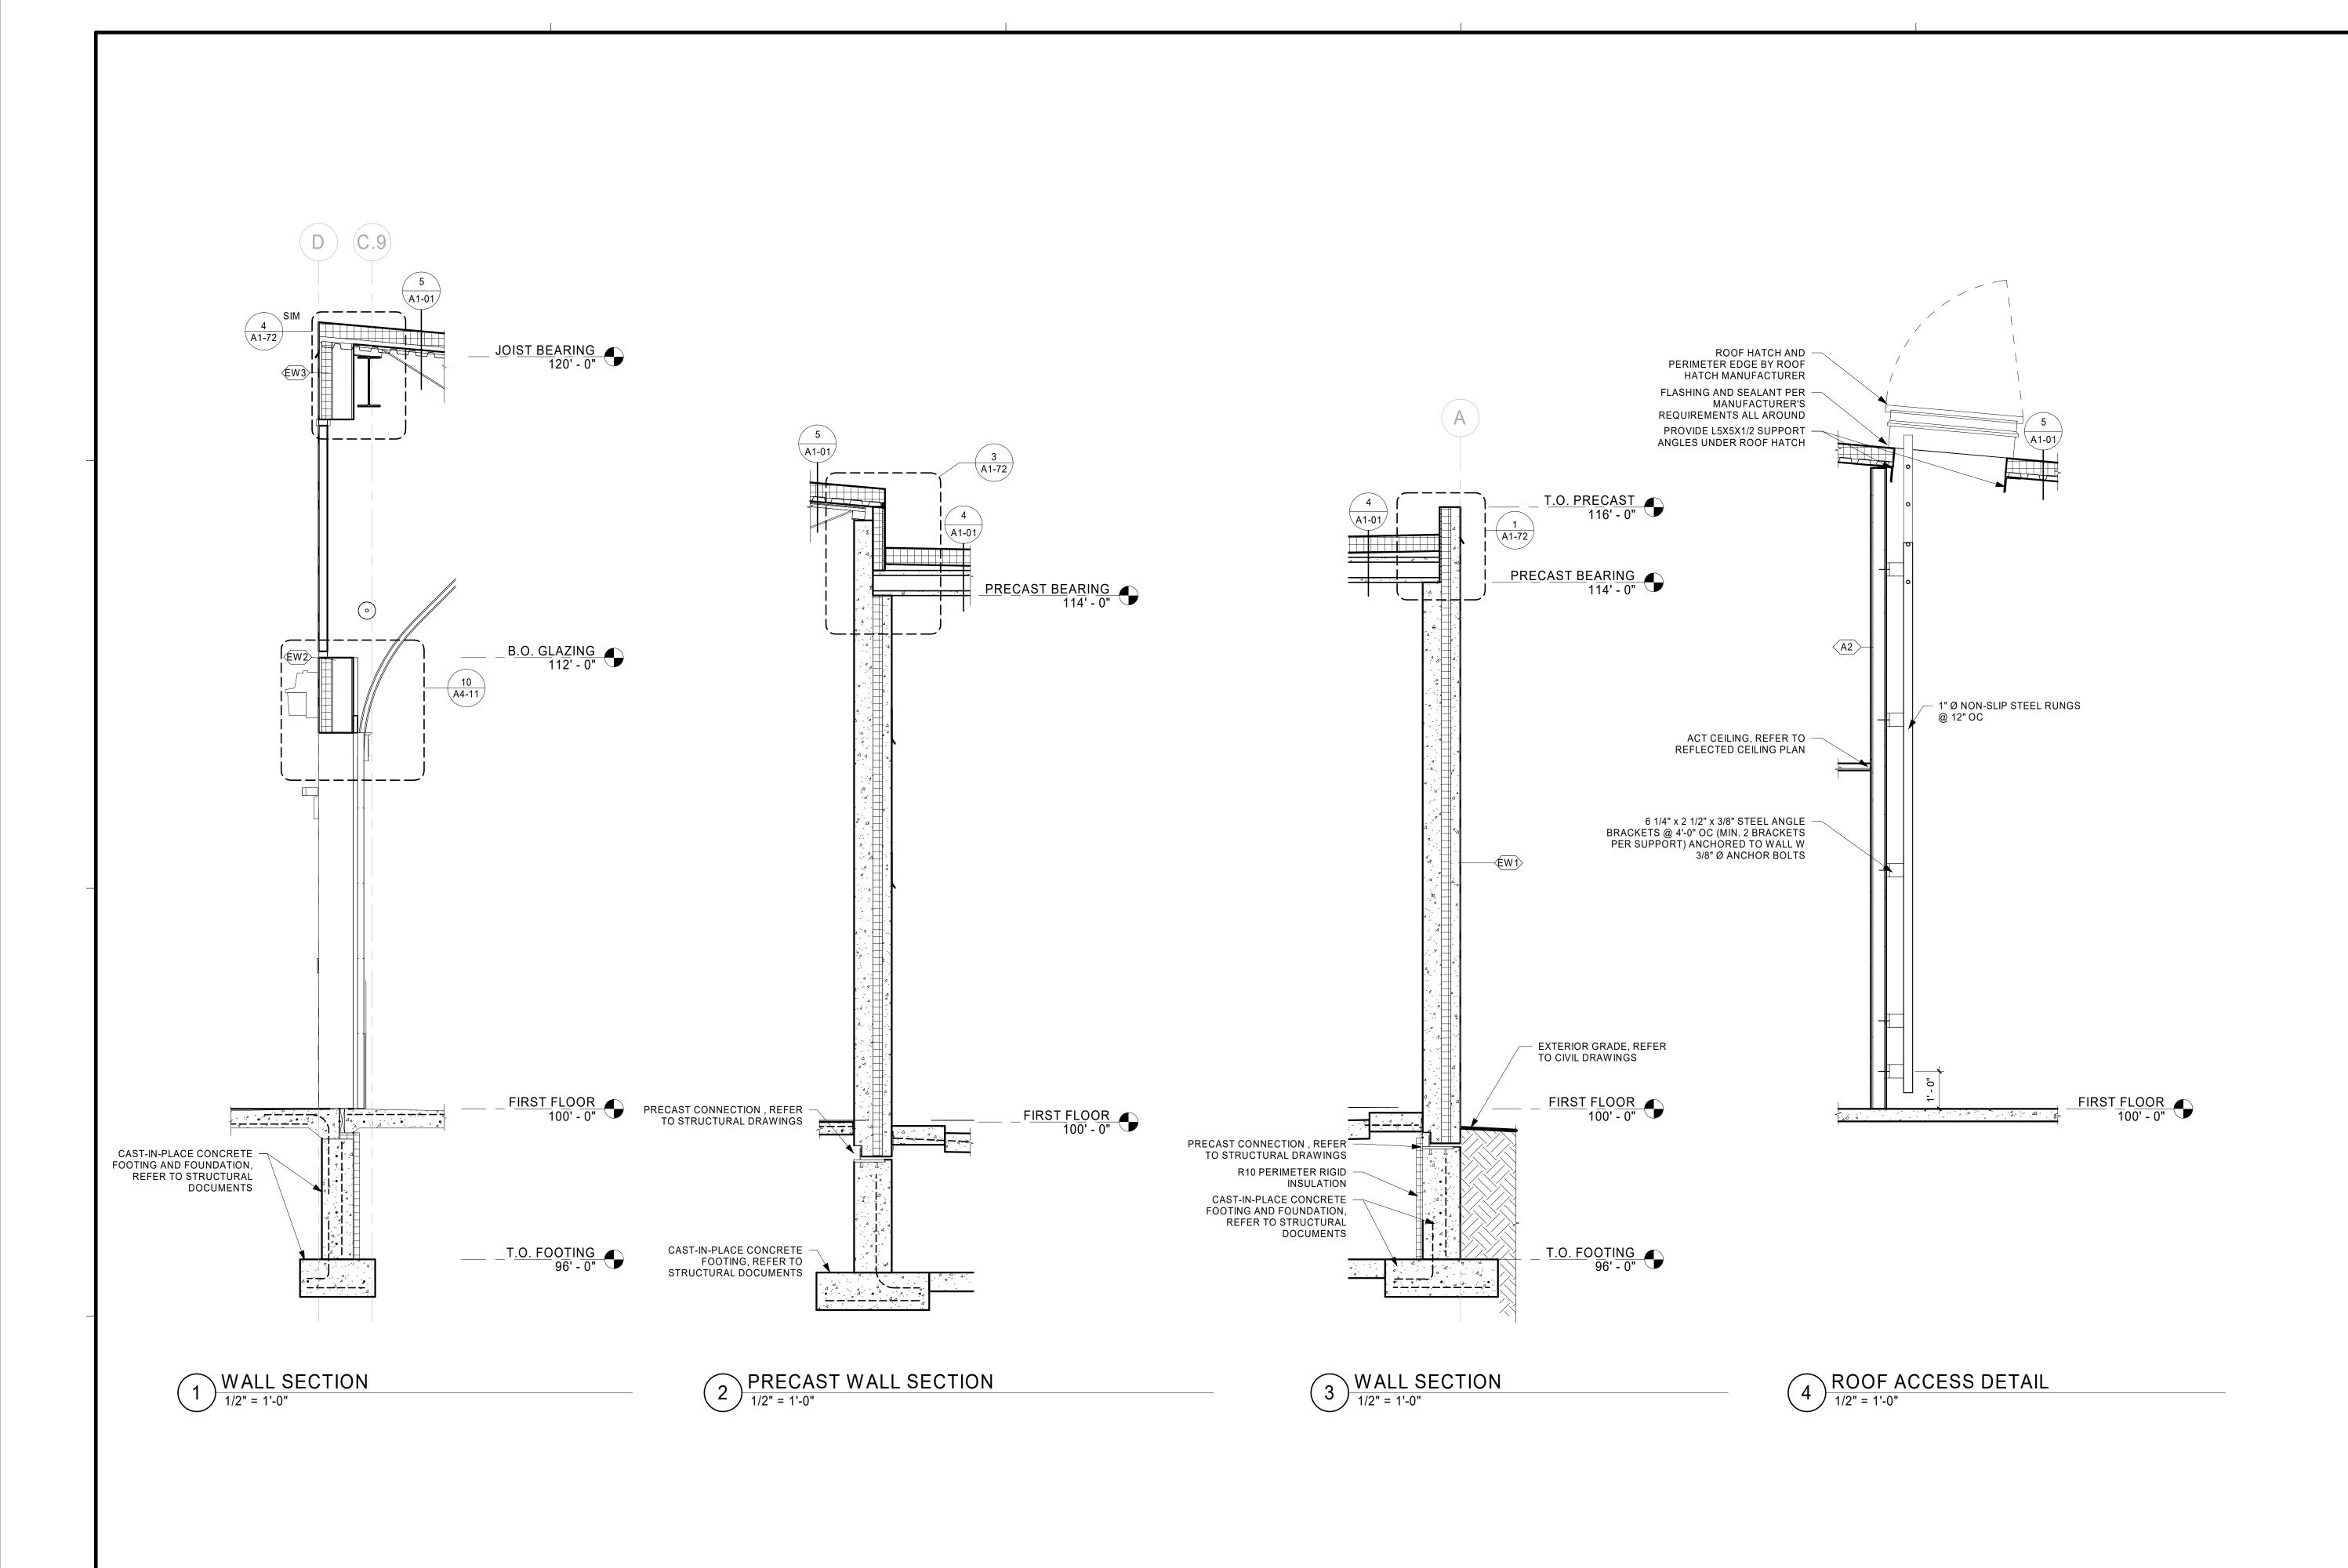LA CROSSE REGIONAL AIRPORT

CAR WASH FACILITY

REVISION SCHEDULE
DATE DESCRIPTION BY

PROJECT NO. 18-21496

FILE NAME 21496 Arch R18.rvt

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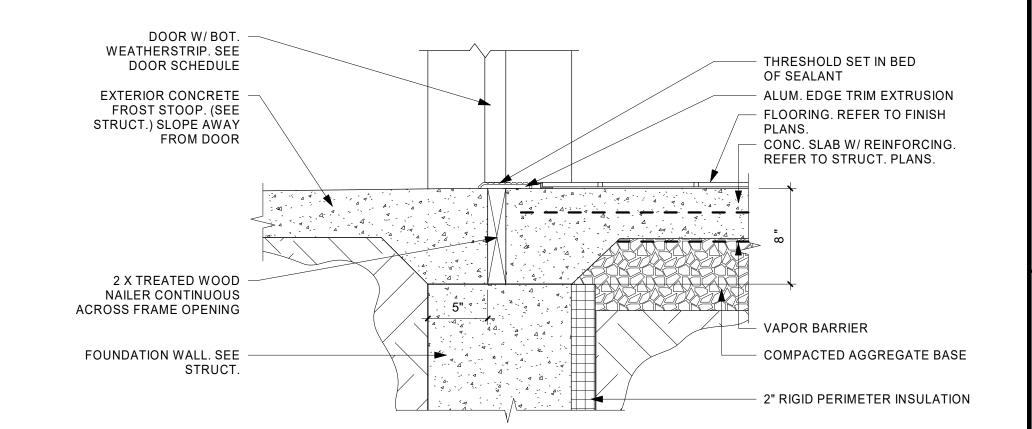
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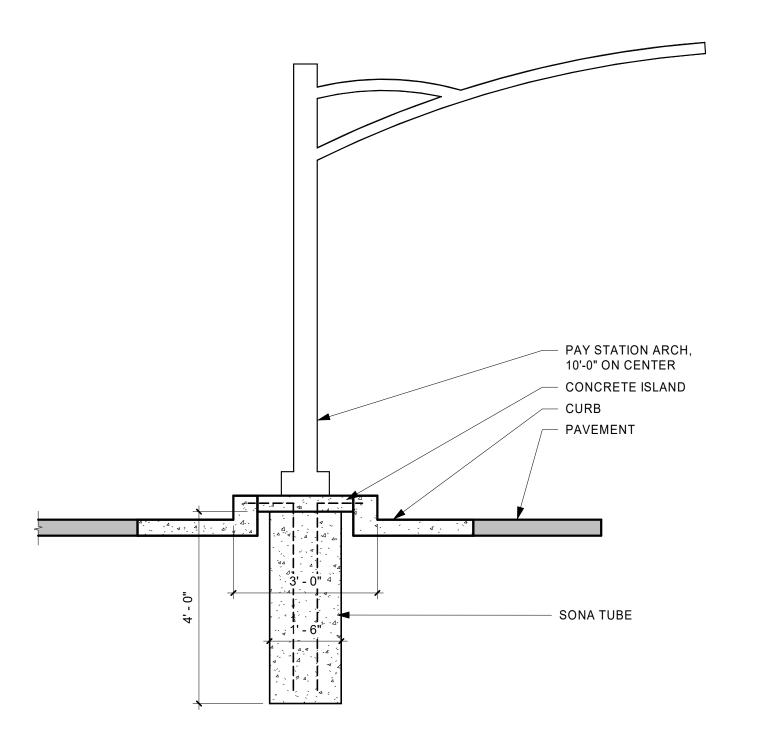
WALL SECTIONS

SHEE






1 DOOR THRESHOLD
1 1/2" = 1'-0"



2 PAY STATION
1/2" = 1'-0"

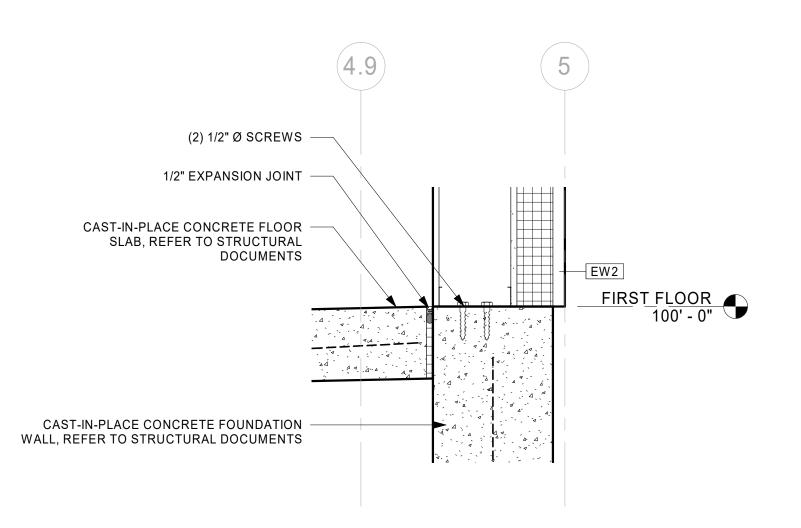

3 EXTERIOR WALL TO FOUNDATION
1 1/2" = 1'-0"

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LA CROSSE REGIONAL AIRPORT

CAR WASH FACILITY

REVISION SCHEDULE

DATE DESCRIPTION BY


PROJECT NO. 18-21496


PROJECT NO.	18-21496
FILE NAME	21496 Arch R18.rvt
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DESIGNED BY	KMB
REVIEWED BY	KMB
ORIGINAL ISSUE DATE	
CLIENT PROJECT NO.	

TITL

**DETAILS** 

SHEET

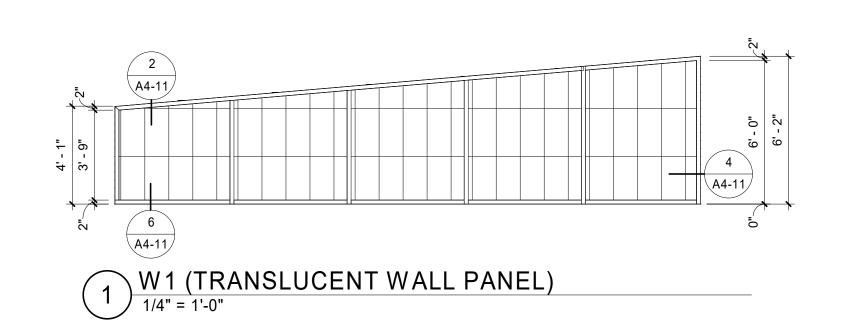


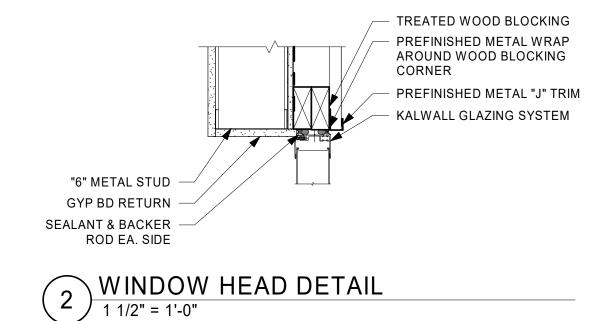

	DOOR SCHEDULE								
MARK	ROOM NAME	WIDTH	HEIGHT	DOOR TYPE	DOOR MATERIAL	FRAME TYPE	FRAME MATERIAL	HARDWARE GROUP	COMMENTS
101A	PREP BAY 1	12' - 0"	10' - 0"	OHD	INSULATED STEEL	-	-		
101B	PREP BAY 1	3' - 0"	7' - 0"	FL	HOLLOW METAL	1	HOLLOW METAL		CARD READER
102A	PREP BAY 2	12' - 0"	10' - 0"	OHD	INSULATED STEEL	-	-		
102B	PREP BAY 2	3' - 0"	7' - 0"	FL	HOLLOW METAL	1	HOLLOW METAL		CARD READER
103A	PREP BAY 3	12' - 0"	10' - 0"	OHD	INSULATED STEEL	-	-		
103B	PREP BAY 3	3' - 0"	7' - 0"	FL	HOLLOW METAL	1	HOLLOW METAL		CARD READER
104A	PREP BAY 4	12' - 0"	10' - 0"	OHD	INSULATED STEEL	-	-		
104B	PREP BAY 4	3' - 0"	7' - 0"	FL	HOLLOW METAL	1	HOLLOW METAL		CARD READER
105	TR 2	3' - 0"	7' - 0"	FL	HOLLOW METAL	1	HOLLOW METAL		
106	TR 1	3' - 0"	7' - 0"	FL	HOLLOW METAL	1	HOLLOW METAL		
107	VESTIBULE	3' - 0"	7' - 0"	FG1	ALUMINUM	1	ALUMINUM		ACCESS CONTROL
108	CLOSET	3' - 0"	7' - 0"	FL	HOLLOW METAL	1	HOLLOW METAL		
109	OFFICE 1	3' - 0"	7' - 0"	FL	HOLLOW METAL	1	HOLLOW METAL		OVERHEAD STOP
110	OFFICE 2	3' - 0"	7' - 0"	FL	HOLLOW METAL	1	HOLLOW METAL		OVERHEAD STOP
111	IT CLOSET	3' - 0"	7' - 0"	FL	HOLLOW METAL	1	HOLLOW METAL		THRESHOLD & GASKET ON DOOR, OVERHEAD STOP
112	OFFICE 3	3' - 0"	7' - 0"	FL	HOLLOW METAL	1	HOLLOW METAL		OVERHEAD STOP
113	OFFICE 4	3' - 0"	7' - 0"	FL	HOLLOW METAL	1	HOLLOW METAL		OVERHEAD STOP
114	MECHANICAL ROOM	6' - 0"	7' - 0"	DBL	HOLLOW METAL	1	HOLLOW METAL		ACCESS CONTROL
115A	CAR WASH	10' - 0"	10' - 0"	OHD	POLYCARBONATE	-	-		
115B	CAR WASH	10' - 0"	10' - 0"	OHD	POLYCARBONATE	-	-		
115C	CAR WASH	3' - 0"	7' - 0"	NL	FIBERGLASS	1	FIBERGLASS		KEYED LOCK
115D	CAR WASH	3' - 0"	7' - 0"	NL	FIBERGLASS	1	FIBERGLASS		
115E	CAR WASH	3' - 0"	7' - 0"	NL	FIBERGLASS	1	FIBERGLASS		

**DOOR TYPES** 



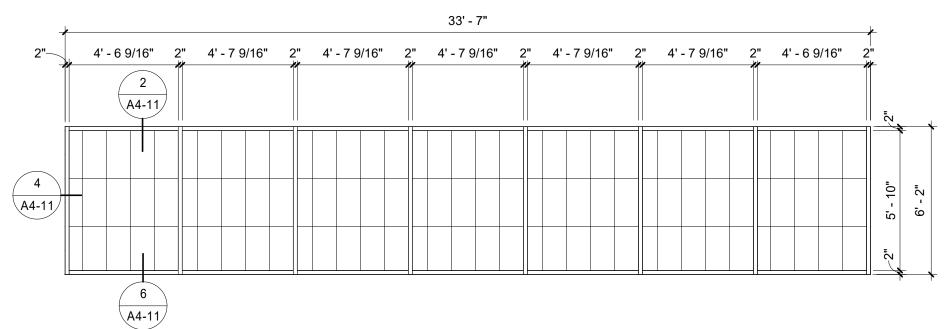

3 5/8" METAL STUDS

SECURE TO DECK W/

5/8" GYP. BOARD


CAULK BOTH SIDES


HOLLOW METAL FRAME

5 3/4"

OF FRAME

SLIP JOINT

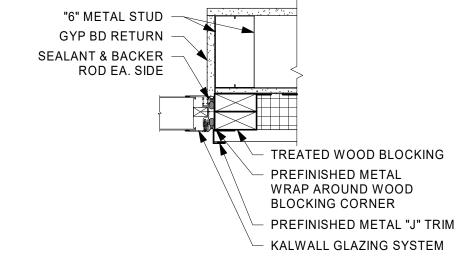

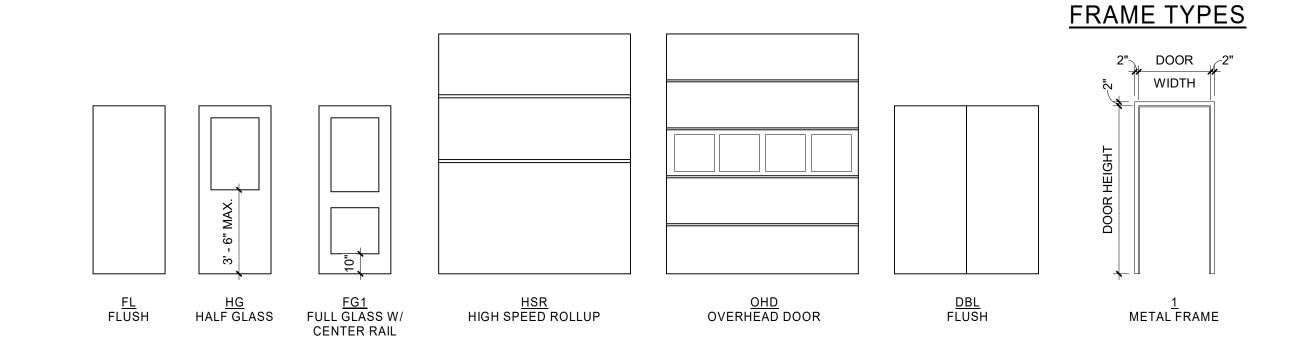

3 W2 (TRANSLUCENT WALL PANEL)
1/4" = 1'-0"

3 5/8" METAL STUD

LAY- IN CEILING SEE

ROOM FINISH SCHED.

SEE DOOR SCHEDULE

3 5/8" METAL STUDS @ 16" O.C.

FOR DOOR TYPE

DIAG. BRACING @

4'-0" O.C.




ROD EA. SIDE


GYP BD RETURN

"6" METAL STUD

5 3/4"

INT. DOOR @ STUD WALL CORNER

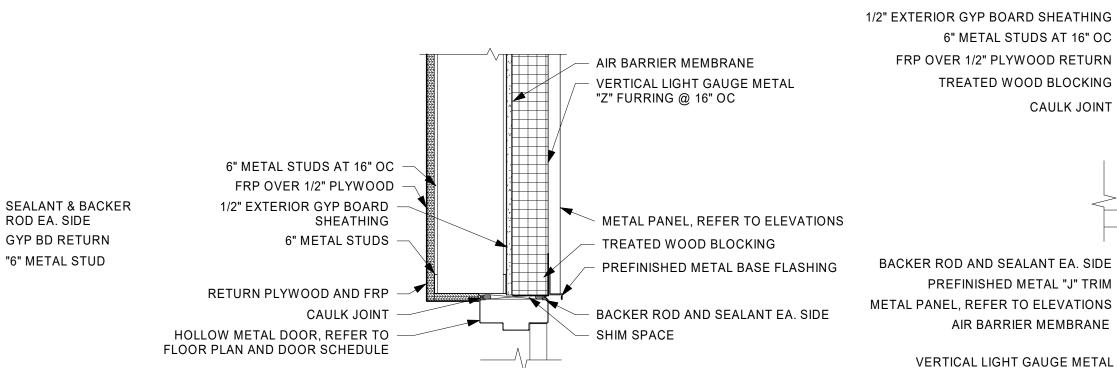

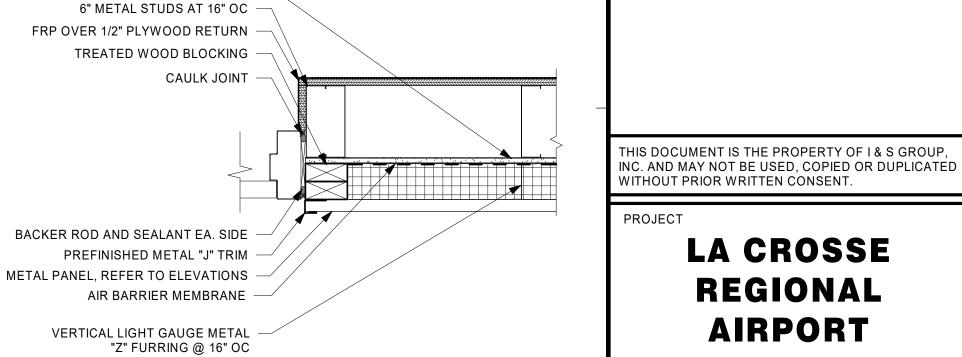

5 INTERIOR HOLLOW METAL HEAD DETAILS
1 1/2" = 1'-0"

5/8" GYP BOARD

(BOTH SIDES)

METAL STUD BOX

HEADER

CAULK (BOTH SIDES OF FRAME)

HOLLOW METAL FRAME

SEE DOOR SCHEDULE

FOR DOOR TYPE



KALWALL GLAZING SYSTEM

PREFINISHED METAL WRAP

TREATED WOOD BLOCKING


PREFINISHED METAL FLASHING


AROUND WOOD BLOCKING CORNER

7 EXTERIOR HOLLOW METAL DOOR HEAD
1 1/2" = 1'-0"

8 EXTERIOR HOLLOW METAL DOOR JAMB

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9 INTERIOR HOLLOW METAL JAMB DETAILS
1 1/2" = 1'-0"

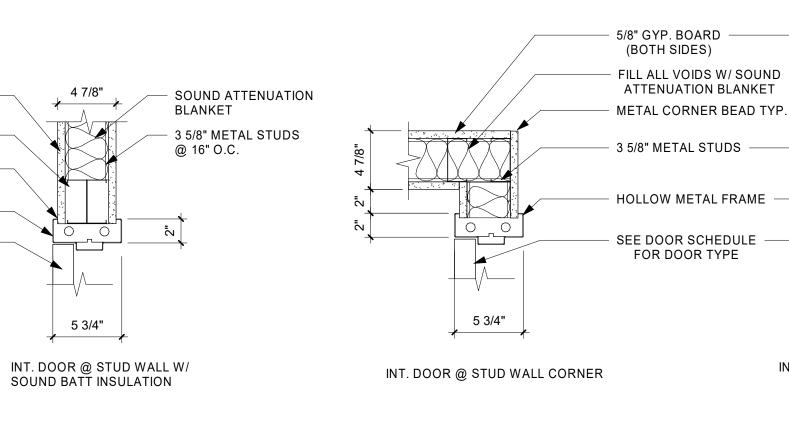5 3/4"

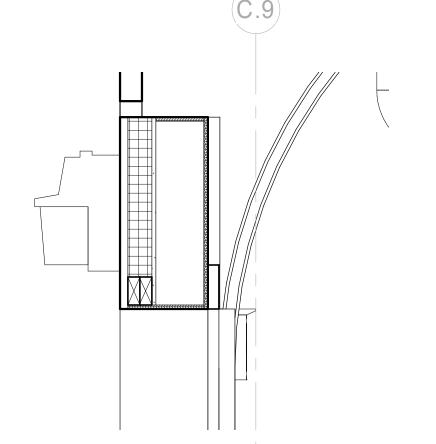INT. DOOR @ STUD WALL

OVERHEAD DOOR HEAD DETAIL

1" = 1'-0"

DOOR SCHEDULE, **DOOR AND FRAME TYPES** 


**CAR WASH** 

**FACILITY** 

WISCONSIN

SHEET

**A4-11** 

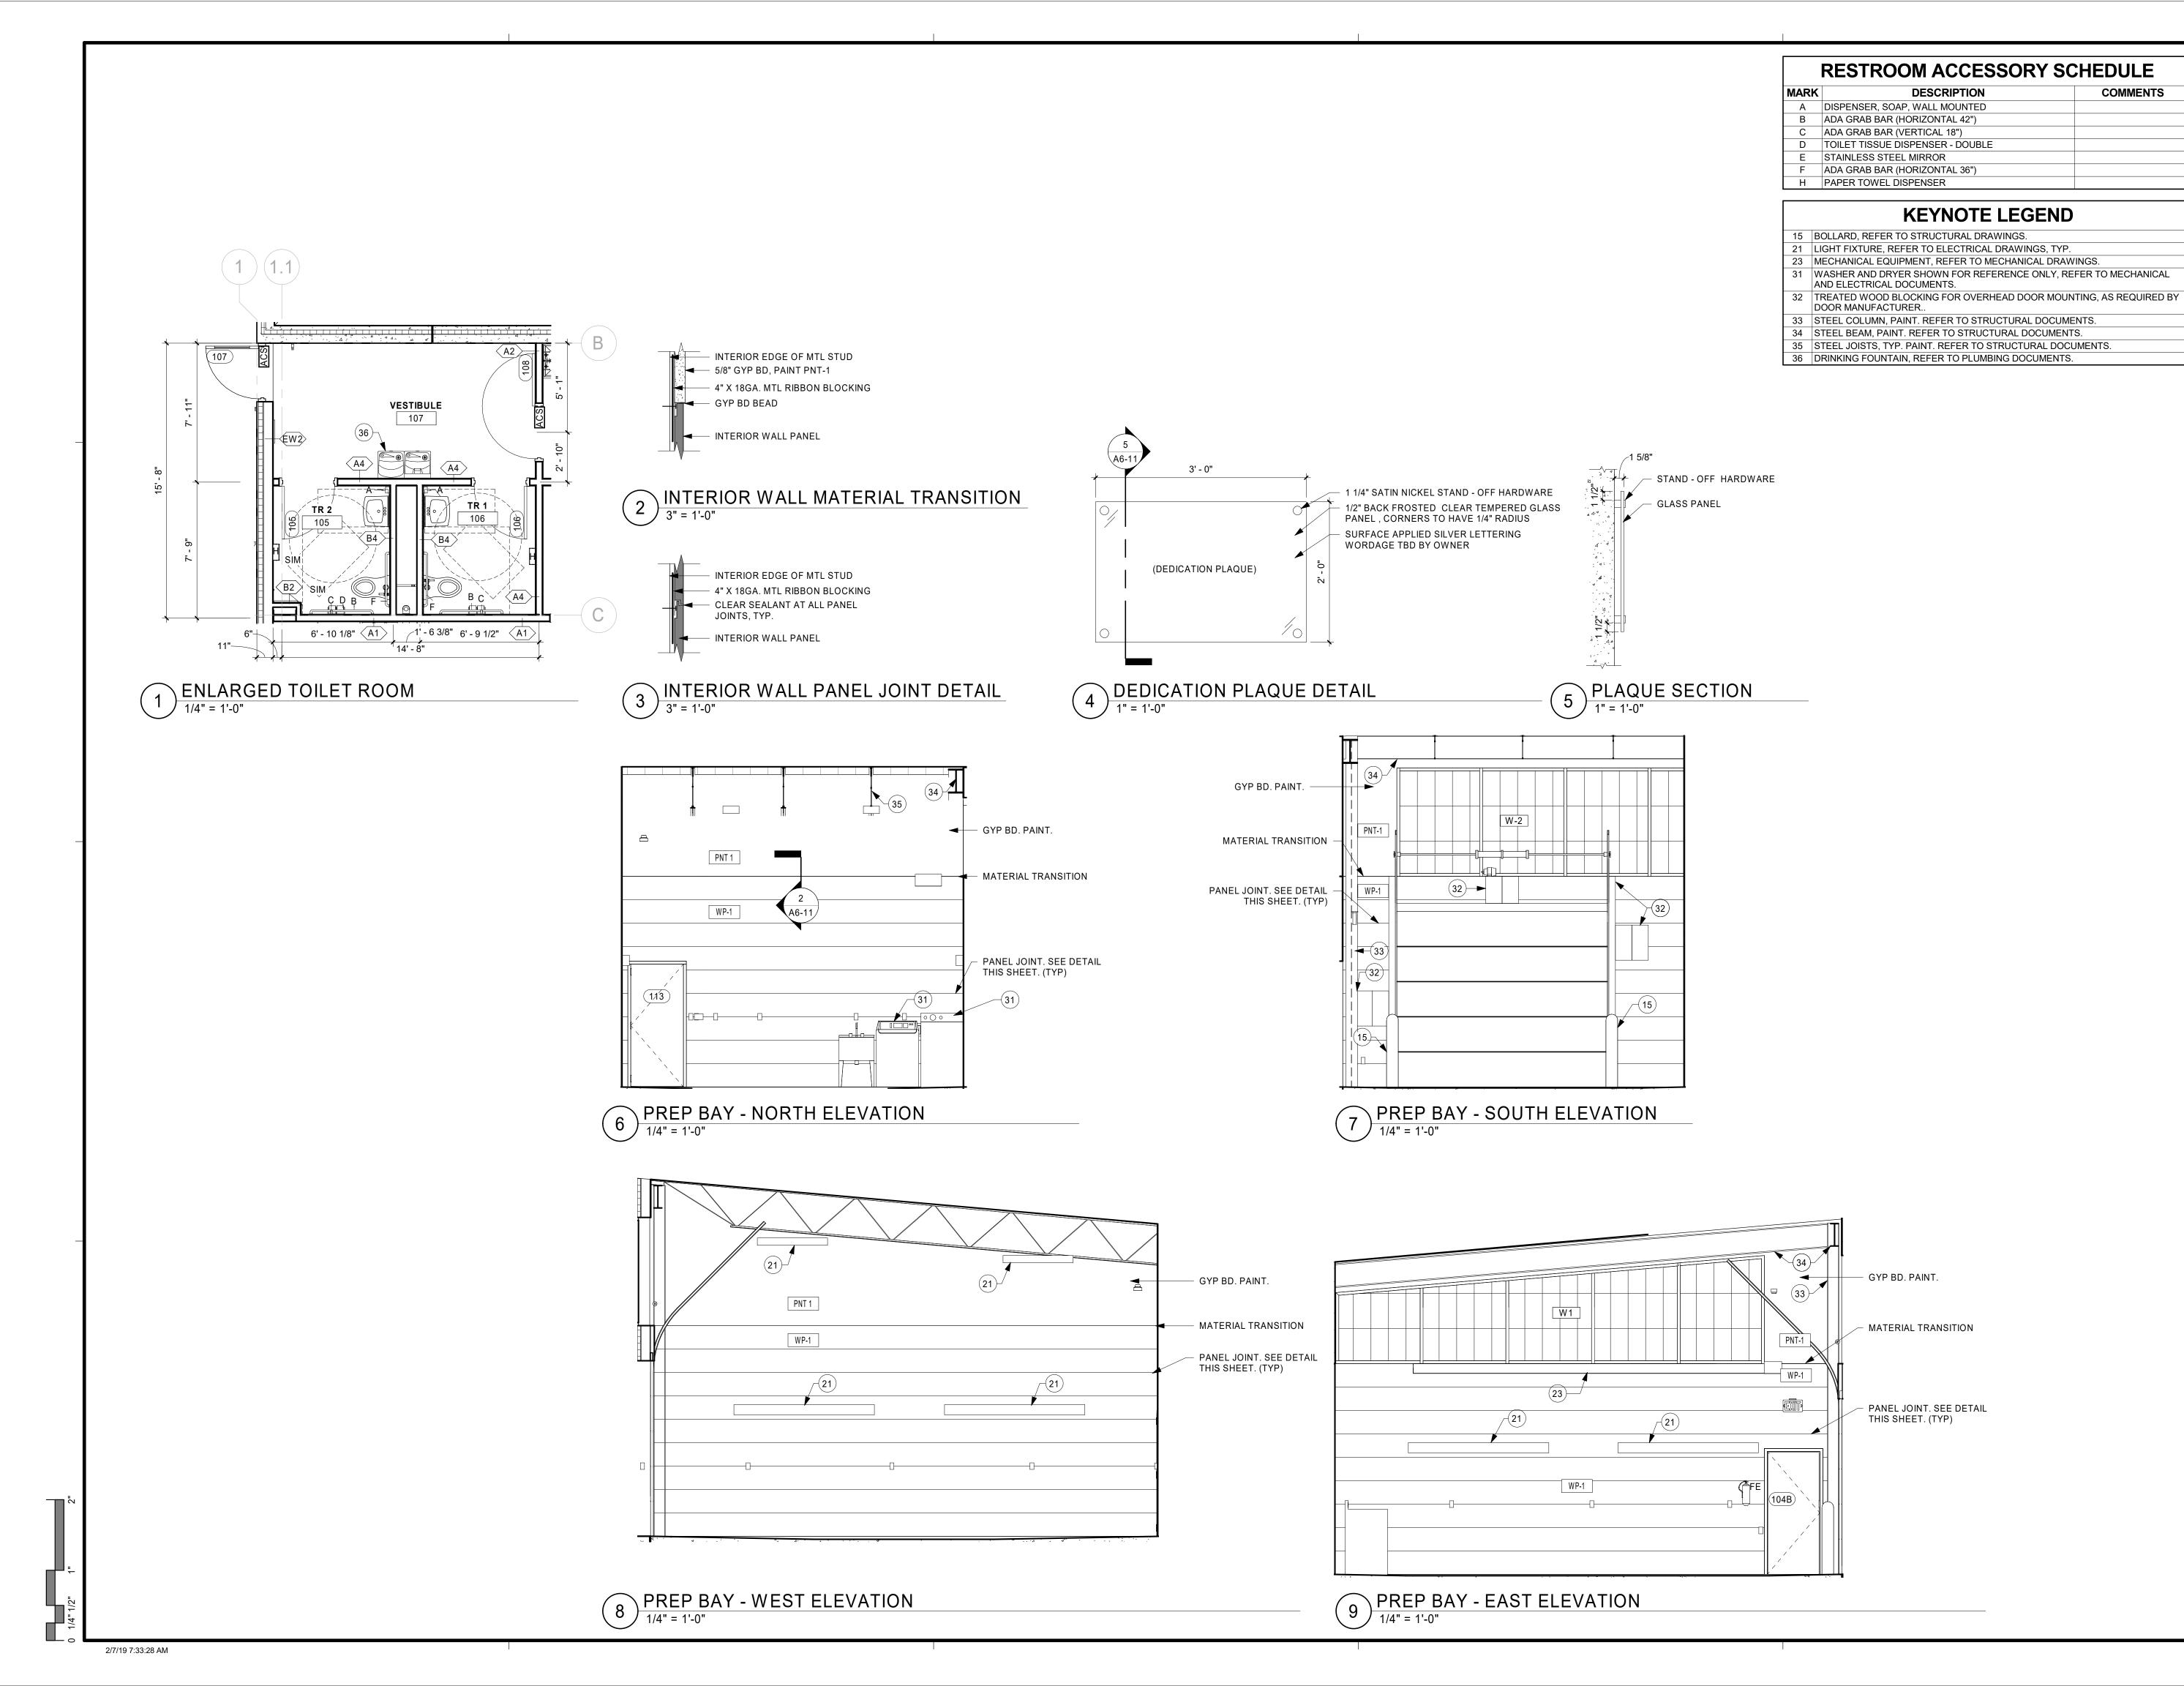

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LA CROSSE **REGIONAL AIRPORT** 

**CAR WASH FACILITY** 

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FILE NAME 21496 Arch R18.rvt DRAWN BY SJR DESIGNED BY KMB KMB REVIEWED BY ORIGINAL ISSUE DATE CLIENT PROJECT NO.

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**ENLARGED PLANS AND INTERIOR ELEVATIONS** 

LIMIN

PR

SHEET

A6-11