

THRUST BLOCKS, TIE RODS & STRAPPING FOR VERTICAL OFFSETS

GENERAL NOTES:


- 1. CONTACT DIGGER'S HOTLINE 5 WORKING DAYS PRIOR TO THE START OF CONSTRUCTION. 2. COORDINATE WITH THE OWNER AND LOCAL UTILITY COMPANIES TO LOCATE ANY EXISTING UTILITIES ON SITE PRIOR TO THE
- START OF WORK. 3. GRADE, LINE, AND LEVEL SHALL BE REVIEWED IN THE FIELD BY THE CONSTRUCTION MANAGER.
- 4. ANY EXISTING UTILITIES NOT SHOWN ON THIS DOCUMENT WHICH NEED TO BE REMOVED, RELOCATED OR ADJUSTED SHALL BE THE RESPONSIBILITY OF THE SITE GRADING CONTRACTOR.
- 5. VERIFY EXACT SANITARY SEWER/WATER LATERAL CONNECTION LOCATIONS AND SIZES WITH THE BUILDING MECHANICAL/PLUMBING PLANS.
- 6. COORDINATE ALL UTILITY WORK WITH THE RESPECTIVE TRADES RESPONSIBLE FOR THE INSTALLATION OF GAS, CABLE,
- TELEPHONE AND ELECTRICAL (INCLUDING MAIN SERVICE, SITE LIGHTING, CONDUITS AND SIGNAGE). 7. COORDINATE ALL WORK WITHIN THE PUBLIC RIGHT OF WAY WITH THE LOCAL MUNICIPALITY.
- 8. TESTING AND INSPECTION SHALL BE DONE IN ACCORDANCE WITH SPS 382.21. 9. THE PROPOSED WATER MAIN/LATERAL SHALL HAVE A MINIMUM COVER OF 7'-6" FROM TOP OF PIPE TO PROPOSED
- 10. PRIOR TO THE START OF WORK VERIFY WITH THE LOCAL AUTHORITIES THAT ALL REQUIRED PERMITS HAVE BEEN ACQUIRED. 11. THE MUNICIPALITY SHALL BE CONTACTED PRIOR TO ANY EXCAVATION IN THE PUBLIC RIGHT-OF-WAY AND PRIOR TO CONNECTING SANITARY SEWER AND WATER LATERALS TO THE PUBLIC MAINS. THE CONTRACTOR SHALL HAVE A TRAFFIC CONTROL PLAN APPROVED PRIOR TO WORK COMMENCING. THE MUNICIPALITY SHALL OPERATE EXISTING WATER VALVES, IF
- NEEDED. 12. FIELD VERIFY INVERT ELEVATION OF THE SANITARY SEWER AND WATER PUBLIC MAIN AT THE LOCATION OF THE SERVICE
- LATERAL CONNECTIONS, PRIOR TO CONNECTING THE LATERALS TO THE PUBLIC MAIN. 13. ALL EXISTING CONDITIONS, INVERTS, AND ELEVATIONS ARE SHOWN APPROXIMATE AND ARE BASED ON MAPPING PROVIDED
- 14. INSTALLATION OF STORM AND SANITARY SEWERS SHALL BE PER STANDARD SPECIFICATIONS FOR THE CONSTRUCTION OF
- SEWERS CITY OF LA CROSSE, WISCONSIN. 15. ADJUSTMENTS TO CITY WATER MAIN REQUIRE DUCTILE IRON PIPE PER CITY SPECIFICATIONS.

UTILITY LEGEND:

EXISTING SANITARY LATERAL TO REMAIN REMOVE, SALVAGE, AND REINSTALL LIGHTPOLE AS NECESSARY FOR UTILITY LATERAL INSTALLATION PROPOSED STORM SEWER PROPOSED SANITARY SEWER PROPOSED WATER MAIN PROPOSED STORM SEWER MANHOLE PROPOSED VALVE

STORM MANHOLE SCHEDULE:

ST#1 ST#2 (MATCH STREET GRADE) RIM (MATCH ALLEY GRADE) INV. N INV. S 52.46± INV. E 52.46± INV. E INV. W 51.42± DEPTH (FIELD VERIFY) DEPTH (FIELD VERIFY) SEE DETAIL 1/C100 SEE DETAIL 1/C100

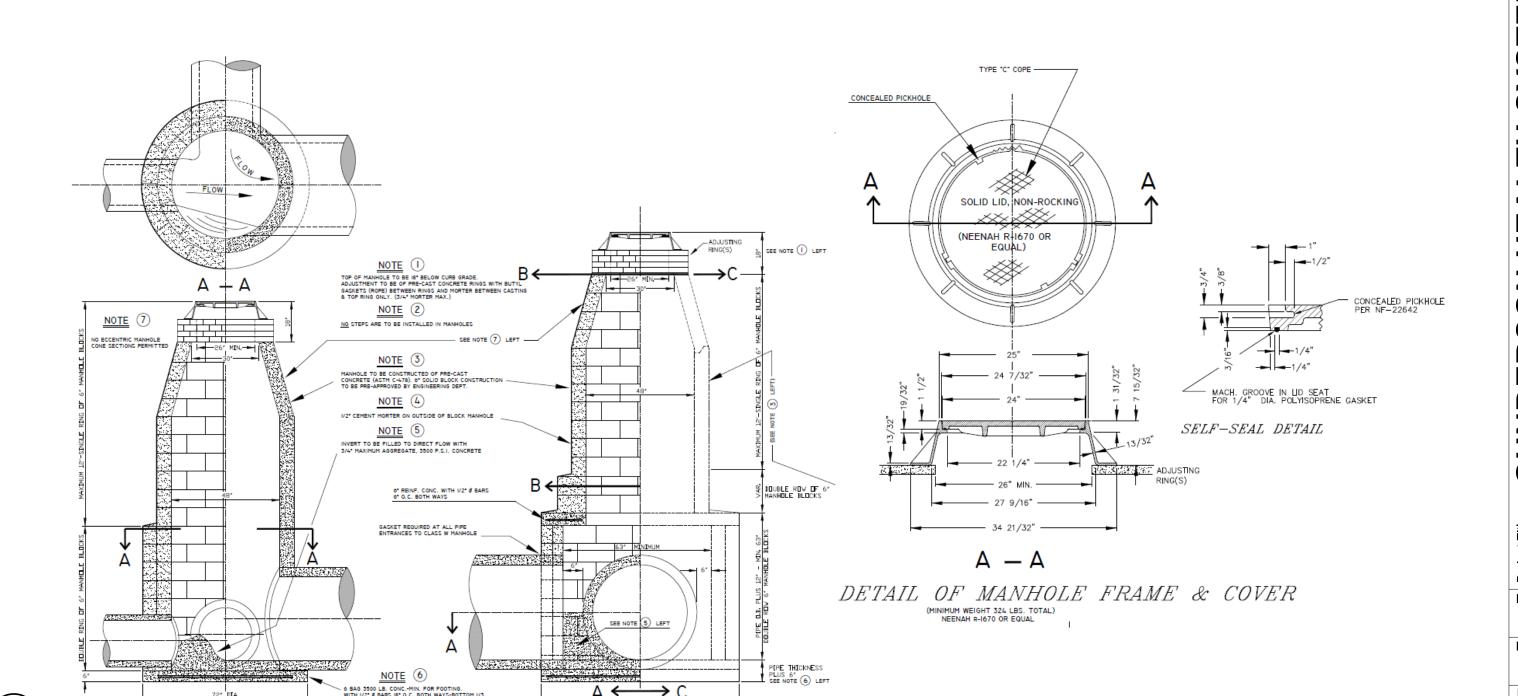

DETAILS OF STANDARD MANHOLE

FOR 36" PIPE OR LARGER


NOTES: THE CITY IS CURRENTLY IN THE PROCESS OF REVISING THE ABOVE DETAIL, NOTE THE FOLLOWING PLANNED REVISIONS:

DETAILS OF STANDARD MANHOLE


FOR 30" PIPE OR SMALLER

1. ALL MANHOLES MUST BE PRECAST CONCRETE. NO BLOCK STRUCTURES ALLOWED. NO SEPARATE BOTTOM PIECES (COOKIES) OR DOGHOUSE SECTIONS ALLOWED, MUST BE INTEGRATED BASE.

2. STORM PIPE TO BE PVC WITH WATER TIGHT BOOTS AT STRUCTURE CONNECTION POINTS.

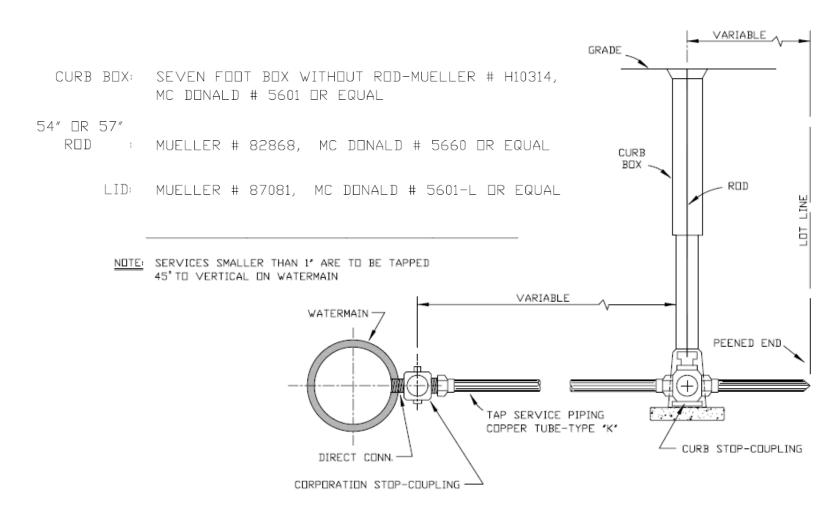



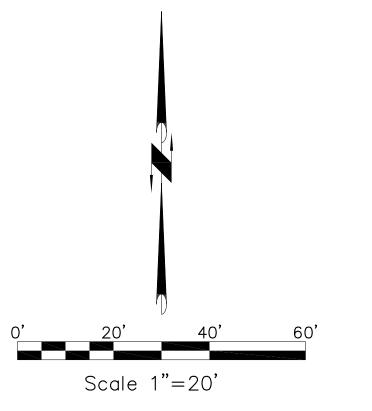



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GUN DOM AND HSR Project Number: **DECEMBER 7, 2018** Drawn By: Key Plan:

Description Graphic Scale: 1" = 20'

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