CITY OF LA CROSSE PEARL STREET WALKWAY

LA CROSSE, WI

100% DD PLAN REVIEW

ISG PROJECT # 22-24807

LEGEND

EXISTING	
	CITY LIMITS
	SECTION LINE
	QUARTER SECTION LINE
	RIGHT OF WAY LINE
	PROPERTY / LOTLINE
	EASEMENT LINE
ΔΔ	ACCESS CONTROL
	WATER EDGE
- — — WET— — -	WETLAND BOUNDARY
मार मार मार मार मार	WETLAND / MARSH
xxxx	FENCE LINE
>>>	CULVERT
	STORM SEWER
	SANITARY SEWER
	SANITARY SEWER FORCEMAIN
	WATER
——————————————————————————————————————	GAS
OE	OVERHEAD ELECTRIC
——————————————————————————————————————	UNDERGROUND ELECTRIC
	UNDERGROUND TELEPHONE
$-\!\!\!-\!\!\!-\!\!\!-\!\!\!\!-\!\!\!\!-\!\!\!\!\!-\!\!\!\!\!\!\!\!\!$	UNDERGROUND TV
——————————————————————————————————————	OVERHEAD UTILITY
——————————————————————————————————————	UNDERGROUND UTILITY
————— FBO —————	UNDERGROUND FIBER OPTIC
990	CONTOUR (MAJOR)
— — <u> </u>	CONTOUR (MINOR)
$\{\cdot\}$	DECIDUOUS TREE
	CONIFEROUS TREE
	TREE LINE
\bigcirc	MANHOLE/STRUCTURE
	CATCH BASIN
-6-	HYDRANT
\bowtie	VALVE
\otimes	CURB STOP
Ø	POWER POLE
	UTILITY PEDESTAL / CABINET

PROPOSED LOT LINE

STORM SEWER
STORM SEWER (PIPE WIDTH)
SANITARY SEWER
SANITARY SEWER (PIPE WIDT
WATER
GAS
OVERHEAD ELECTRIC
UNDERGROUND ELECTRIC



VALVE

OWNER:

CAST IRON PIP

ABBREVIATIONS:

AFF ABOVE FINISHED FLOOR

AGG AGGREGATE

APPROX APPROXIMATE

CITY OF LA CROSSE 400 LA CROSSE STREET LA CROSSE / WI / 54601 PH: 608.789.CITY

CJ CONTROL JOINT

CONC CONCRETE

DEMO DEMOLITION

ELEC ELECTRICAL

ELEV ELEVATION

PROJECT INDEX:

DIMENSION

DOWNSPOUT

CONST CONSTRUCTION

CURB AND GUTTER

CO

EXISTING

FDN

FOUNDATION

FOOT, FEET

GALVANIZED

GENERAL CONTRACTOR

GARAGE FLOOR ELEVATION

FIRE DEPARTMENT CONNECTION HDPE HIGH DENSITY POLYETHYLENE

INV

INVERT

HIGH WATER LEVEL

PROJECT ADDRESS / LOCATION:

LA CROSSE CENTER **300 HARBORVIEW PLAZA** LA CROSSE, WISCONSIN 54601

LOCATION MAP

SCALE IN FEET

J-BOX JUNCTION BOX

JOINT

LINEAR

MECH MECHANICA

NUMBER

NTS NOT TO SCALE

LINEAR FEET

LOW PRESSURE STEA

OC ON CENTER

OH OVERHEAD

OZ OUNCE

R RIM

RAD RADIUS

LOWEST STRUCTURAL OPENING PERF PERFORATED

OHD OVERHEAD DOOR

OCEW ON CENTER EACH WAY

PED PEDESTAL, PEDESTRIAN

PROPERTY LINI

POLYPROPYLENE

POUNDS PER SQUARE INCH

MANAGING OFFICE:

ROOF DRAIN

REBAR REINFORCING BAR

ROW RIGHT OF WAY

R/W RIGHT OF WAY

SANITARY

SCHEDULE

SPEC SPECIFICATION

SQUARE

STATION

T/C TOP OF CURB

TEL TELEPHONE

TEMP TEMPORARY

SQUARE FOOT

SQUARE YARD

REM REMOVE

LA CROSSE OFFICE **201 MAIN STREET SUITE 1020** LA CROSSE, WI 54601 PHONE: 608.789.2034

PROJECT MANAGER:

THRU THROUGH

TRANS TRANSFORMER

T/W TOP OF WALL

TYP

W/O

W/

YD

TELEVISION

TYPICAL

WITHOUT

WITH

YARD

YEAR

TELEPHONE

VITRIFIED CLAY PIPE

TNFH TOP NUT OF FIRE HYDRANT

UTILITY, UNDERGROUND

ALL CONSTRUCTION SHALL COMPLY WITH THE CITY OF LA CROSSE STANDARD SPECIFICATIONS, CURRENT EDITION, WISDOT STANDARD SPECIFICATIONS, 2022 EDITION, WISDOT CONSTRUCTION AND MATERIALS MANUAL, CURRENT EDITION WISCONSIN DEPARTMENT OF SAFETY AND PROFESSIONAL SERVICES STATE PLUMBING CODE, CURRENT EDITION, AND STANDARD SPECIFICATION FOR SEWER & WATER CONSTRUCTION IN WISCONSIN, 6th EDITION, UNLESS DIRECTED

PROJECT DATUM

SPECIFICATIONS REFERENCE

HORIZONTAL COORDINATES HAVE BEEN REFERENCED TO THE NORTH AMERICAN DATUM OF 1983 (NAD83), 2011 ADJUSTMENT (NAD83(2011)) ON THE LA CROSSE COUNTY COORDINATE SYSTEM, IN U.S. SURVEY FEET.

SHEET INDEX

C0-20 SITE DETAILS

C0-21 SITE DETAILS

C0-22 SITE DETAILS

C3-10 SITE PLAN

C3-20 UTILITY PLAN

C5-40 PLANTING DETAILS

E4-12 ELECTRICAL SYMBOLS, SCHEDULES AND DETAILS

E4-13 EQUIPMENT SCHEDULE

E5-21 LIGHTING SCHEDULES

PROJECT GENERAL NOTES

- 1. ALL WORK SHALL CONFORM TO THE CONTRACT DOCUMENTS, WHICH INCLUDE, BUT ARE NOT LIMITED TO, THE OWNER - CONTRACTOR AGREEMENT, THE PROJECT MANUAL (WHICH INCLUDES GENERAL SUPPLEMENTARY CONDITIONS AND SPECIFICATIONS), DRAWINGS OF ALL DISCIPLINES AND ALL ADDENDA, MODIFICATIONS AND CLARIFICATIONS ISSUED BY THE ARCHITECT/ENGINEER.
- CONTRACT DOCUMENTS SHALL BE ISSUED TO ALL SUBCONTRACTORS BY THE GENERAL CONTRACTOR IN COMPLETE SETS IN ORDER TO ACHIEVE THE FULL EXTENT
- AND COMPLETE COORDINATION OF ALL WORK. WRITTEN DIMENSIONS TAKE PRECEDENCE OVER SCALED DIMENSIONS. NOTIFY ARCHITECT/ENGINEER OF ANY DISCREPANCIES OR CONDITIONS REQUIRING INFORMATION OR CLARIFICATION BEFORE PROCEEDING WITH THE WORK.
- 4. FIELD VERIFY ALL EXISTING CONDITIONS AND DIMENSIONS NOTIFY ARCHITECT/ENGINEER OF ANY DISCREPANCIES OR CONDITIONS REQUIRING INFORMATION OR CLARIFICATION BEFORE PROCEEDING WITH THE WORK.
- 5. DETAILS SHOWN ARE INTENDED TO BE INDICATIVE OF THE PROFILES AND TYPE OF DETAILING REQUIRED THROUGHOUT THE WORK. DETAILS NOT SHOWN ARE SIMILAR IN CHARACTER TO DETAILS SHOWN. WHERE SPECIFIC DIMENSIONS, DETAILS OR DESIGN INTENT CANNOT BE DETERMINED, NOTIFY ARCHITECT/ENGINEER BEFORE PROCEEDING WITH THE WORK.
- 6. ALL MANUFACTURED ARTICLES, MATERIALS AND EQUIPMENT SHALL BE APPLIED, INSTALLED, CONNECTED, ERECTED, CLEANED AND CONDITIONED ACCORDING TO MANUFACTURERS' INSTRUCTIONS. IN CASE OF DISCREPANCIES BETWEEN MANUFACTURERS' INSTRUCTIONS AND THE CONTRACT DOCUMENTS, NOTIFY ARCHITECT/ENGINEER BEFORE PROCEEDING WITH THE

- 7. ALL DISSIMILAR METALS SHALL BE EFFECTIVELY ISOLATED
- FROM EACH OTHER TO AVOID GALVANIC CORROSION. THE LOCATION AND TYPE OF ALL INPLACE UTILITIES SHOWN ON THE PLANS ARE FOR GENERAL INFORMATION ONLY AND ARE ACCURATE AND COMPLETE TO THE BEST OF THE KNOWLEDGE OF I & S GROUP, INC. (ISG). NO WARRANTY OR GUARANTEE IS IMPLIED. THE CONTRACTOR SHALL VERIFY THE SIZES, LOCATIONS AND ELEVATIONS OF ALL INPLACE UTILITIES PRIOR TO CONSTRUCTION. CONTRACTOR SHALL IMMEDIATELY NOTIFY ENGINEER OF ANY DISCREPANCIES OR VARIATIONS FROM PLAN.
- THE CONTRACTOR IS TO CONTACT "DIGGER'S HOTLINE" FOR UTILITY LOCATIONS, MINIMUM 3 BUSINESS DAYS PRIOR TO ANY EXCAVATION / CONSTRUCTION (811 OR



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PROJECT

CITY OF LA CROSSE

PEARL WALKWAY IMPROVEMENTS

LA CROSSE				WI
	F	REVISION SCH	HEDULE	
DATE		DESCRIP	PTION	BY
PROJECT	ΓNO.	22-24	807	
	DATE	F	REVISION SCH DATE DESCRIF	REVISION SCHEDULE DATE DESCRIPTION

FILE NAME 24807 C0-DATA **DRAWN BY DESIGNED BY REVIEWED BY** ORIGINAL ISSUE DATE 05/26/22

CLIENT PROJECT NO.

TITLE

TITLE SHEET

TOPOGRAPHIC SURVEY

THIS PROJECT'S TOPOGRAPHIC SURVEY CONSISTS OF DATA COLLECTED IN 2/17, 10/17, 2/19,

B.M. ELEVATION = 658.25


AT INTERSECTION OF SECOND ST

AND PEARL ST.


& 1/22 BY ISG.

TNFH NORTHEAST CORNER OF PROPERTY

CO-10

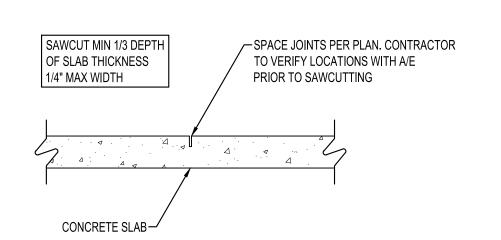


CONTROL JOINT

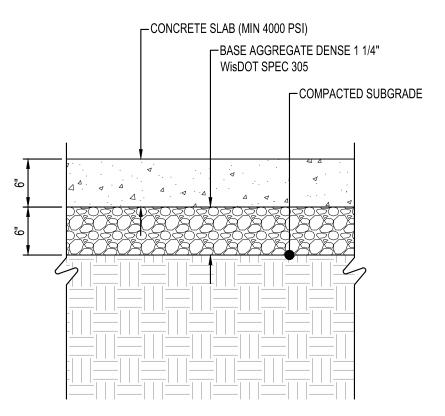


NOTES:

COLORED CONCRETE W/ EXPOSED AGGREGATE FINISH, SEE SITE PLAN FOR LAYOUT PROVIDE SHOP DRAWINGS FOR LAYOUT AND COLOR APPROVAL.

DECORATIVE **CONCRETE WALK**

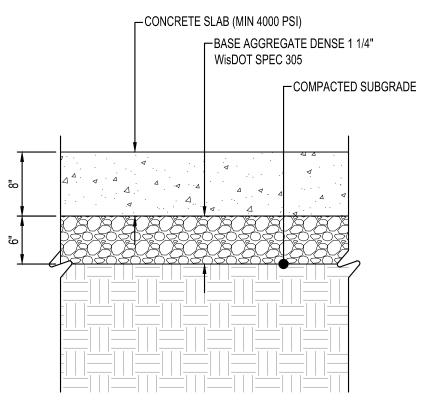

HEAVY DUTY CONCRETE PAVEMENT

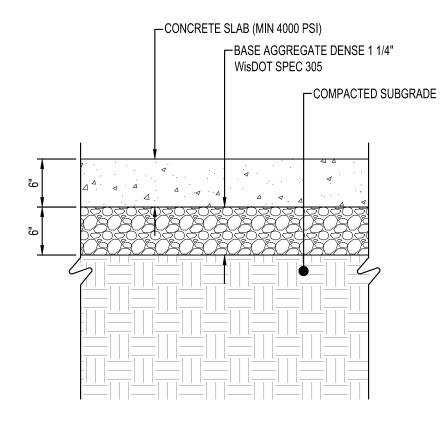

CONCRETE WALK

-METAL BASE OR WATERPROOF-FLASH COLLAR COMPOUND, 2" DEEP ∕-GRADE LINE CONCRETE, 4000 PSI-FOUR HARD WOOD WEDGES-FILL SPACE WITH PACKED DRY SAND-16 GAUGE GALVANIZED CORRUGATED-FOUR WELDED STEEL WEDGES-1/4" WELDED STEEL PLATE SUPPORT PLATE— -3/8" DIAMETER STEEL GROUND SPIKE WELDED TO SPIKE WELDED TO PLATES

NOTES:


- ① INSIDE DIAMETER OF FOUNDATION TUBE, APPROXIMATELY 3" LARGER THAN OUTSIDE BUTT DIAMETER OF FLAG POLE.
- 2) DISTANCE OF POLE IN FOUNDATION ,10% OF EXPOSED HEIGHT OF POLE.
- THICKNESS OF FOOTING UNDER BASE PLATE, AT LEAST 15% IN INCHES OF POLE HEIGHT IN FEET (MINIMUM THICKNESS OF 4").
- 4 DEPTH OF EXCAVATION, DISTANCE OF POLE IN FOUNDATION PLUS THICKNESS OF FOOTING.
- DIAMETER OF FOUNDATION, BOTTOM, AT LEAST FOUR TIMES OUTSIDE BUTT DIAMETER OF POLE (MINIMUM DIAMETER OF 24").
- 6 DIAMETER OF FOUNDATION, TOP, AT LEAST 5 TIMES OUTSIDE BUTT DIAMETER OF POLE (MINIMUM OF 30"). SIZE OF BASE PLATE OF FOUNDATION TUBE, AT LEAST 6" LARGER SQUARE THAN INSIDE DIAMETER OF FOUNDATION TUBE.
- 8 LENGTH OF LIGHTNING GROUND SPIKE ATTACHED TO BASE PLATE OF FOUNDATION TUBE, DEPTH BELOW FOOTING EQUIVALENT TO FOOTING THICKNESS.
- (9) SIZE OF SUPPORT PLATE ATTACHED TO GROUND SPIKE, APPROXIMATELY 25% OF AREA OF BASE PLATE


FLAG POLE FOOTING

SHOP DRAWING REQUIRED

STONE TYPE: DOLOMITIC LIMESTONE SIZE: 2' HEIGHT X 2' DEPTH X 5' LENGTH TOP: SMOOTH BOTTOM: NATURAL BED EXPOSED FACE: SPLIT ADJOINING FACE: SAW-CUT NOTE: SEE GRADING PLAN FOR ELEVATIONS

SOURCES: BIESANZ STONE / MINNESOTA DOLOMITE LIMESTONE WEBER STONE / ANAMOSA LIMESTONE FISCHER STONE / MOUNTAIN BLUFF OR APPROVED EQUAL

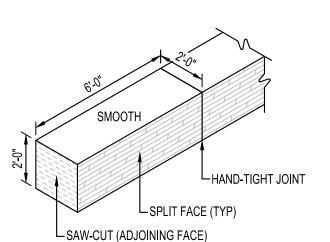

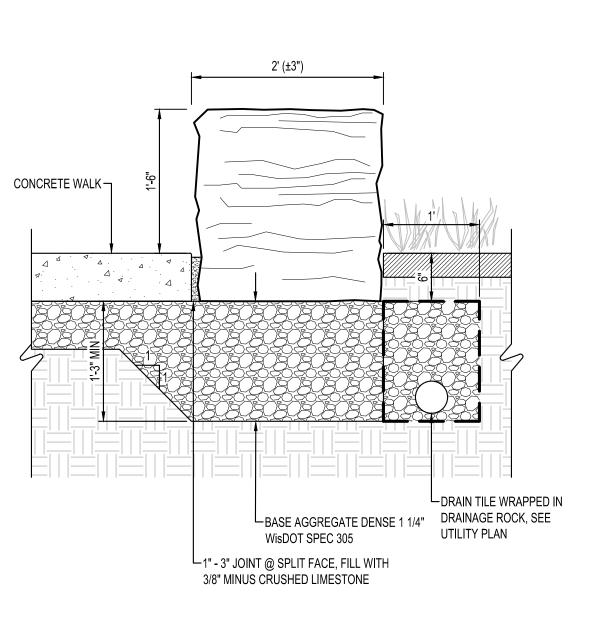



LIMESTONE SEAT WALL SCALE: 1"=1'-0"

SHOP DRAWING REQUIRED

STONE TYPE: DOLOMITIC LIMESTONE SIZE: 1'-6" HEIGHT X 2' DEPTH X 5' LENGTH TOP: SMOOTH BOTTOM: SAW-CUT EXPOSED EDGES: SPLIT FACE NOTE: SEE GRADING PLAN FOR ELEVATIONS

SOURCES: BIESANZ STONE / MINNESOTA DOLOMITE LIMESTONE WEBER STONE / ANAMOSA LIMESTONE FISCHER STONE / MOUNTAIN BLUFF OR APPROVED EQUAL

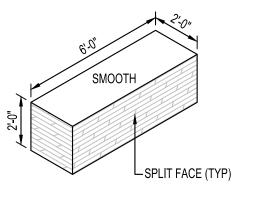


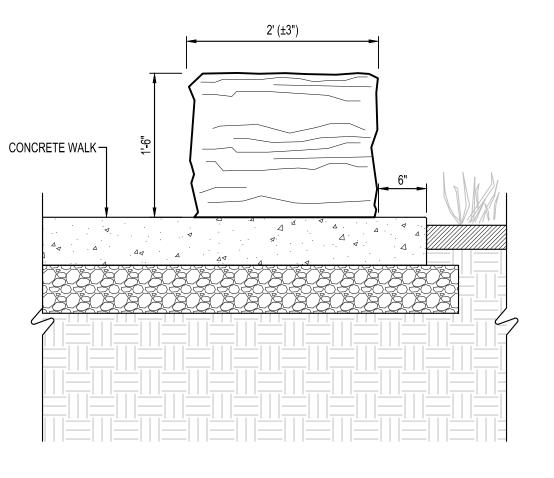


LIMESTONE BLOCK SCALE: 1"=1'-0"

SHOP DRAWING REQUIRED

STONE TYPE: LIMESTONE OUTCROPPING SIZE: ±1'-2" HEIGHT X 2'-6" (±6") DEPTH X 2'-6" - 4'-0" LENGTH FINISH: TOP AND BOTTOM NATURAL BED, SPLIT FACE EXPOSED EDGES, SAW-CUT ADJOINING FACES, NO SHARP EDGES INSTALLATION: HOLD TOP SURFACE OF STONE PIECES LEVEL,

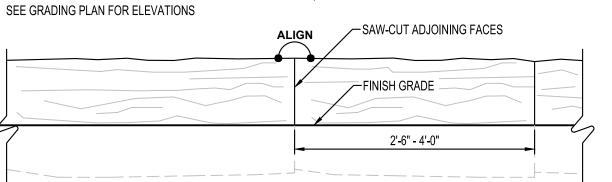

FRONT ELEVATION

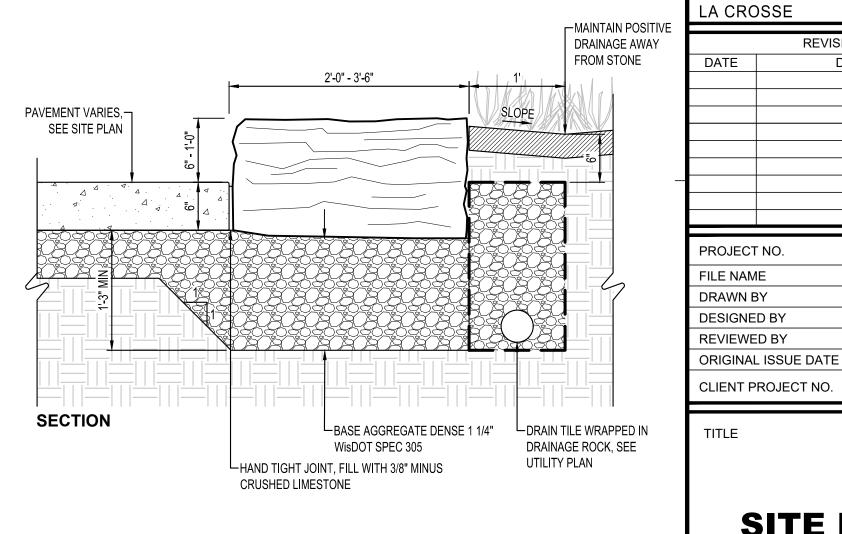

OUTCROPPING BORDER SCALE: 1"=1'-0"

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TRUCTION

FOR

PRELIMINARY

PROJECT

CITY OF LA CROSSE


PEARL WALKWAY IMPROVEMENTS


REVISION SCHEDULE DATE DESCRIPTION 22-24807 PROJECT NO. FILE NAME 24807 C0-DETAILS DRAWN BY GBV **DESIGNED BY REVIEWED BY** ORIGINAL ISSUE DATE 05/26/22

SITE DETAILS

SHEET

C0-20

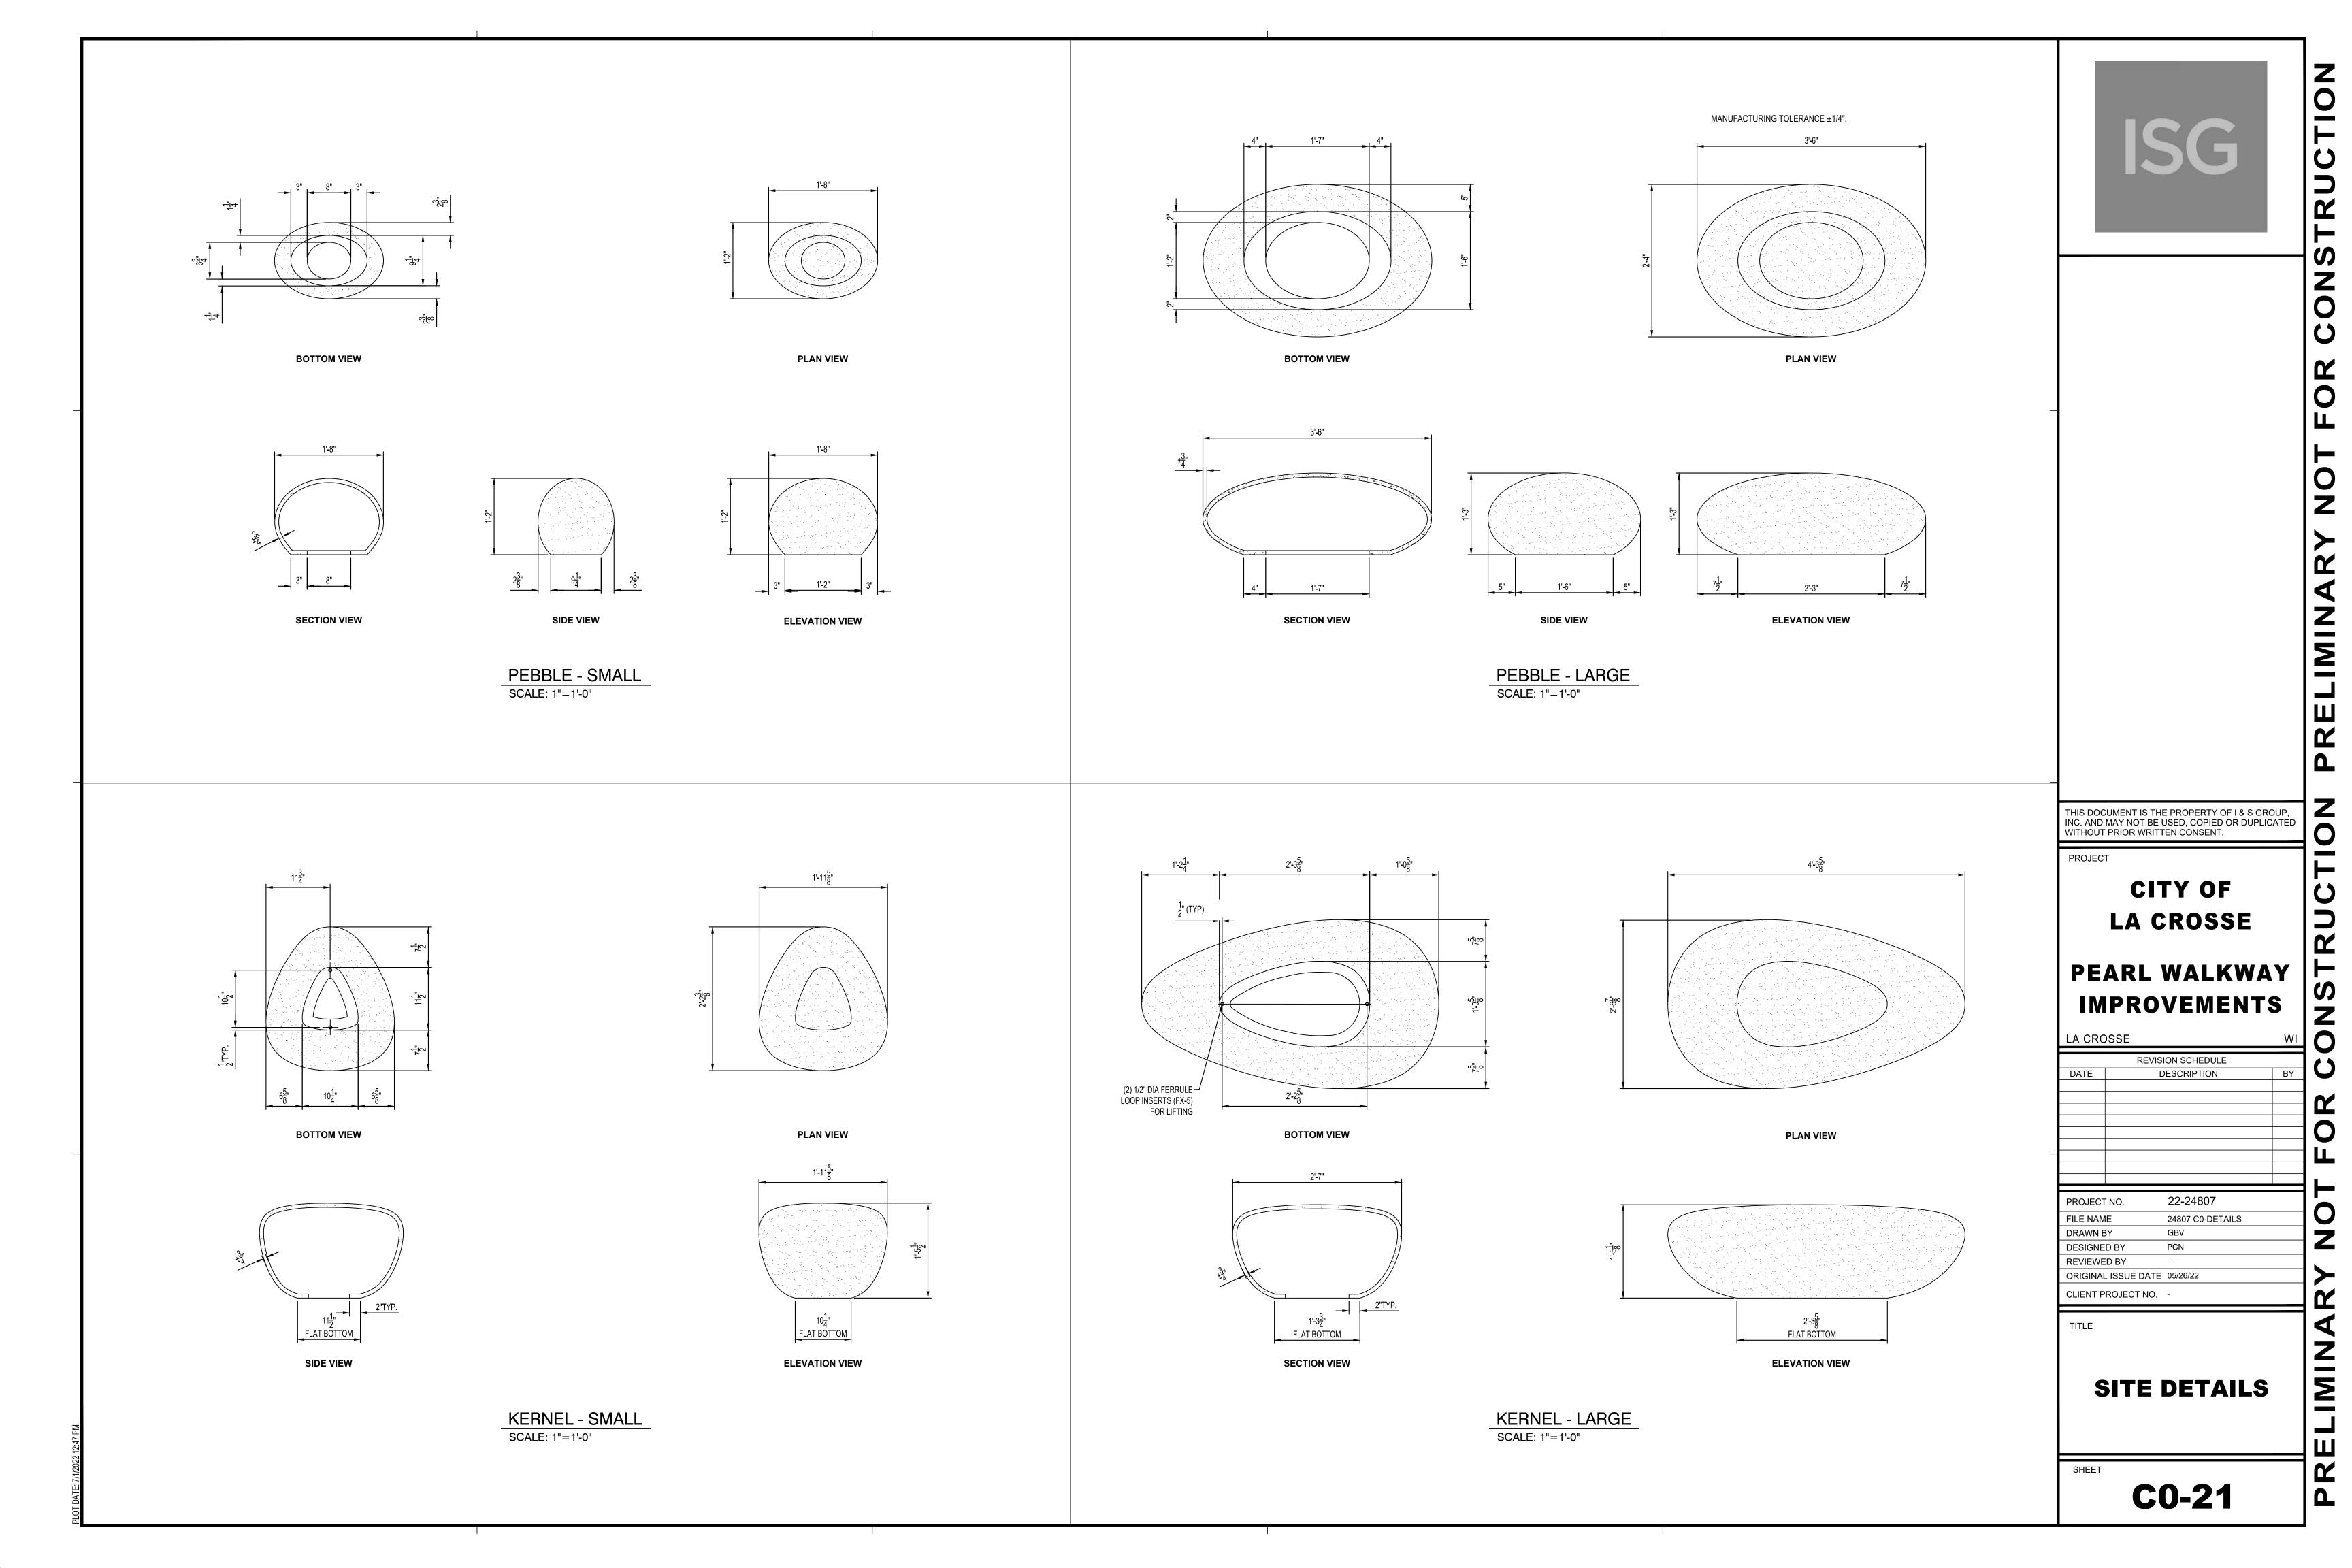

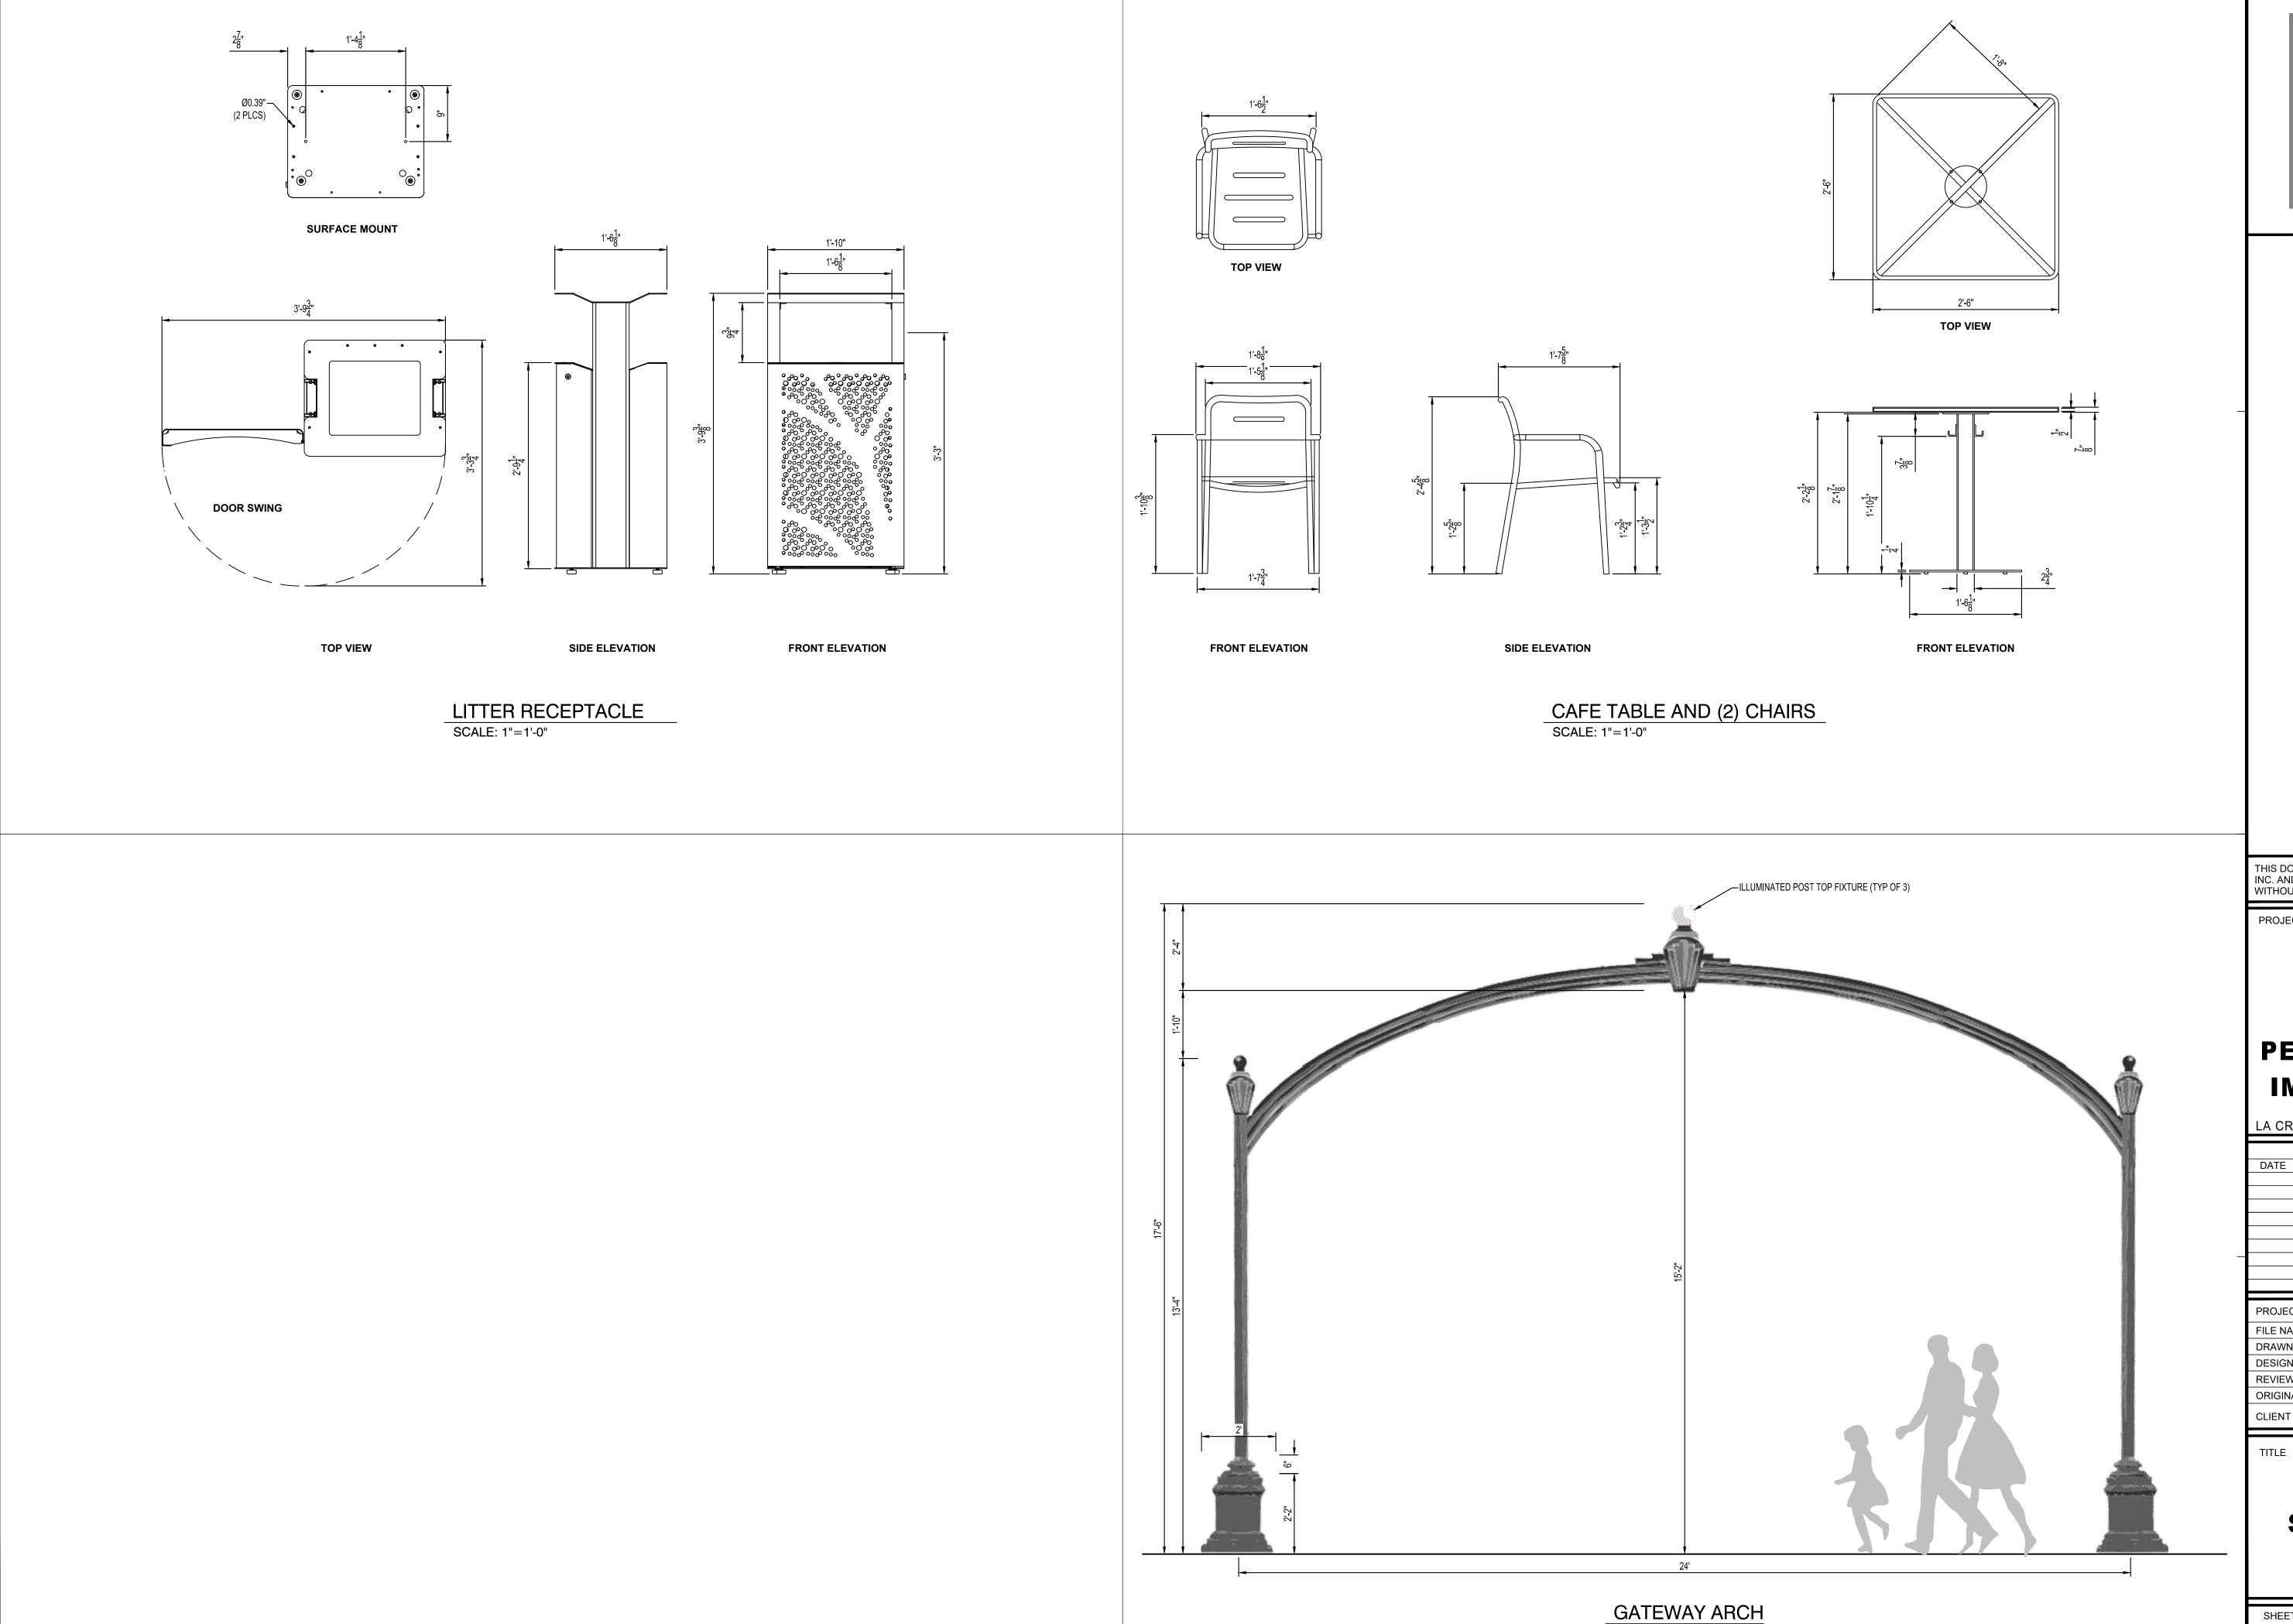

PRELIMINARY

PROJECT

CITY OF LA CROSSE

PEARL WALKWAY **IMPROVEMENTS**


	REVISION SCHEDULE					
	DATE		DES	SCRIPTION		BY
_						
	PROJECT	NO.	2	2-24807		

24807 C0-DETAILS FILE NAME DRAWN BY DESIGNED BY REVIEWED BY ORIGINAL ISSUE DATE 05/26/22 CLIENT PROJECT NO.

SITE DETAILS

SCALE: 1/2"=1'-0"

C0-22

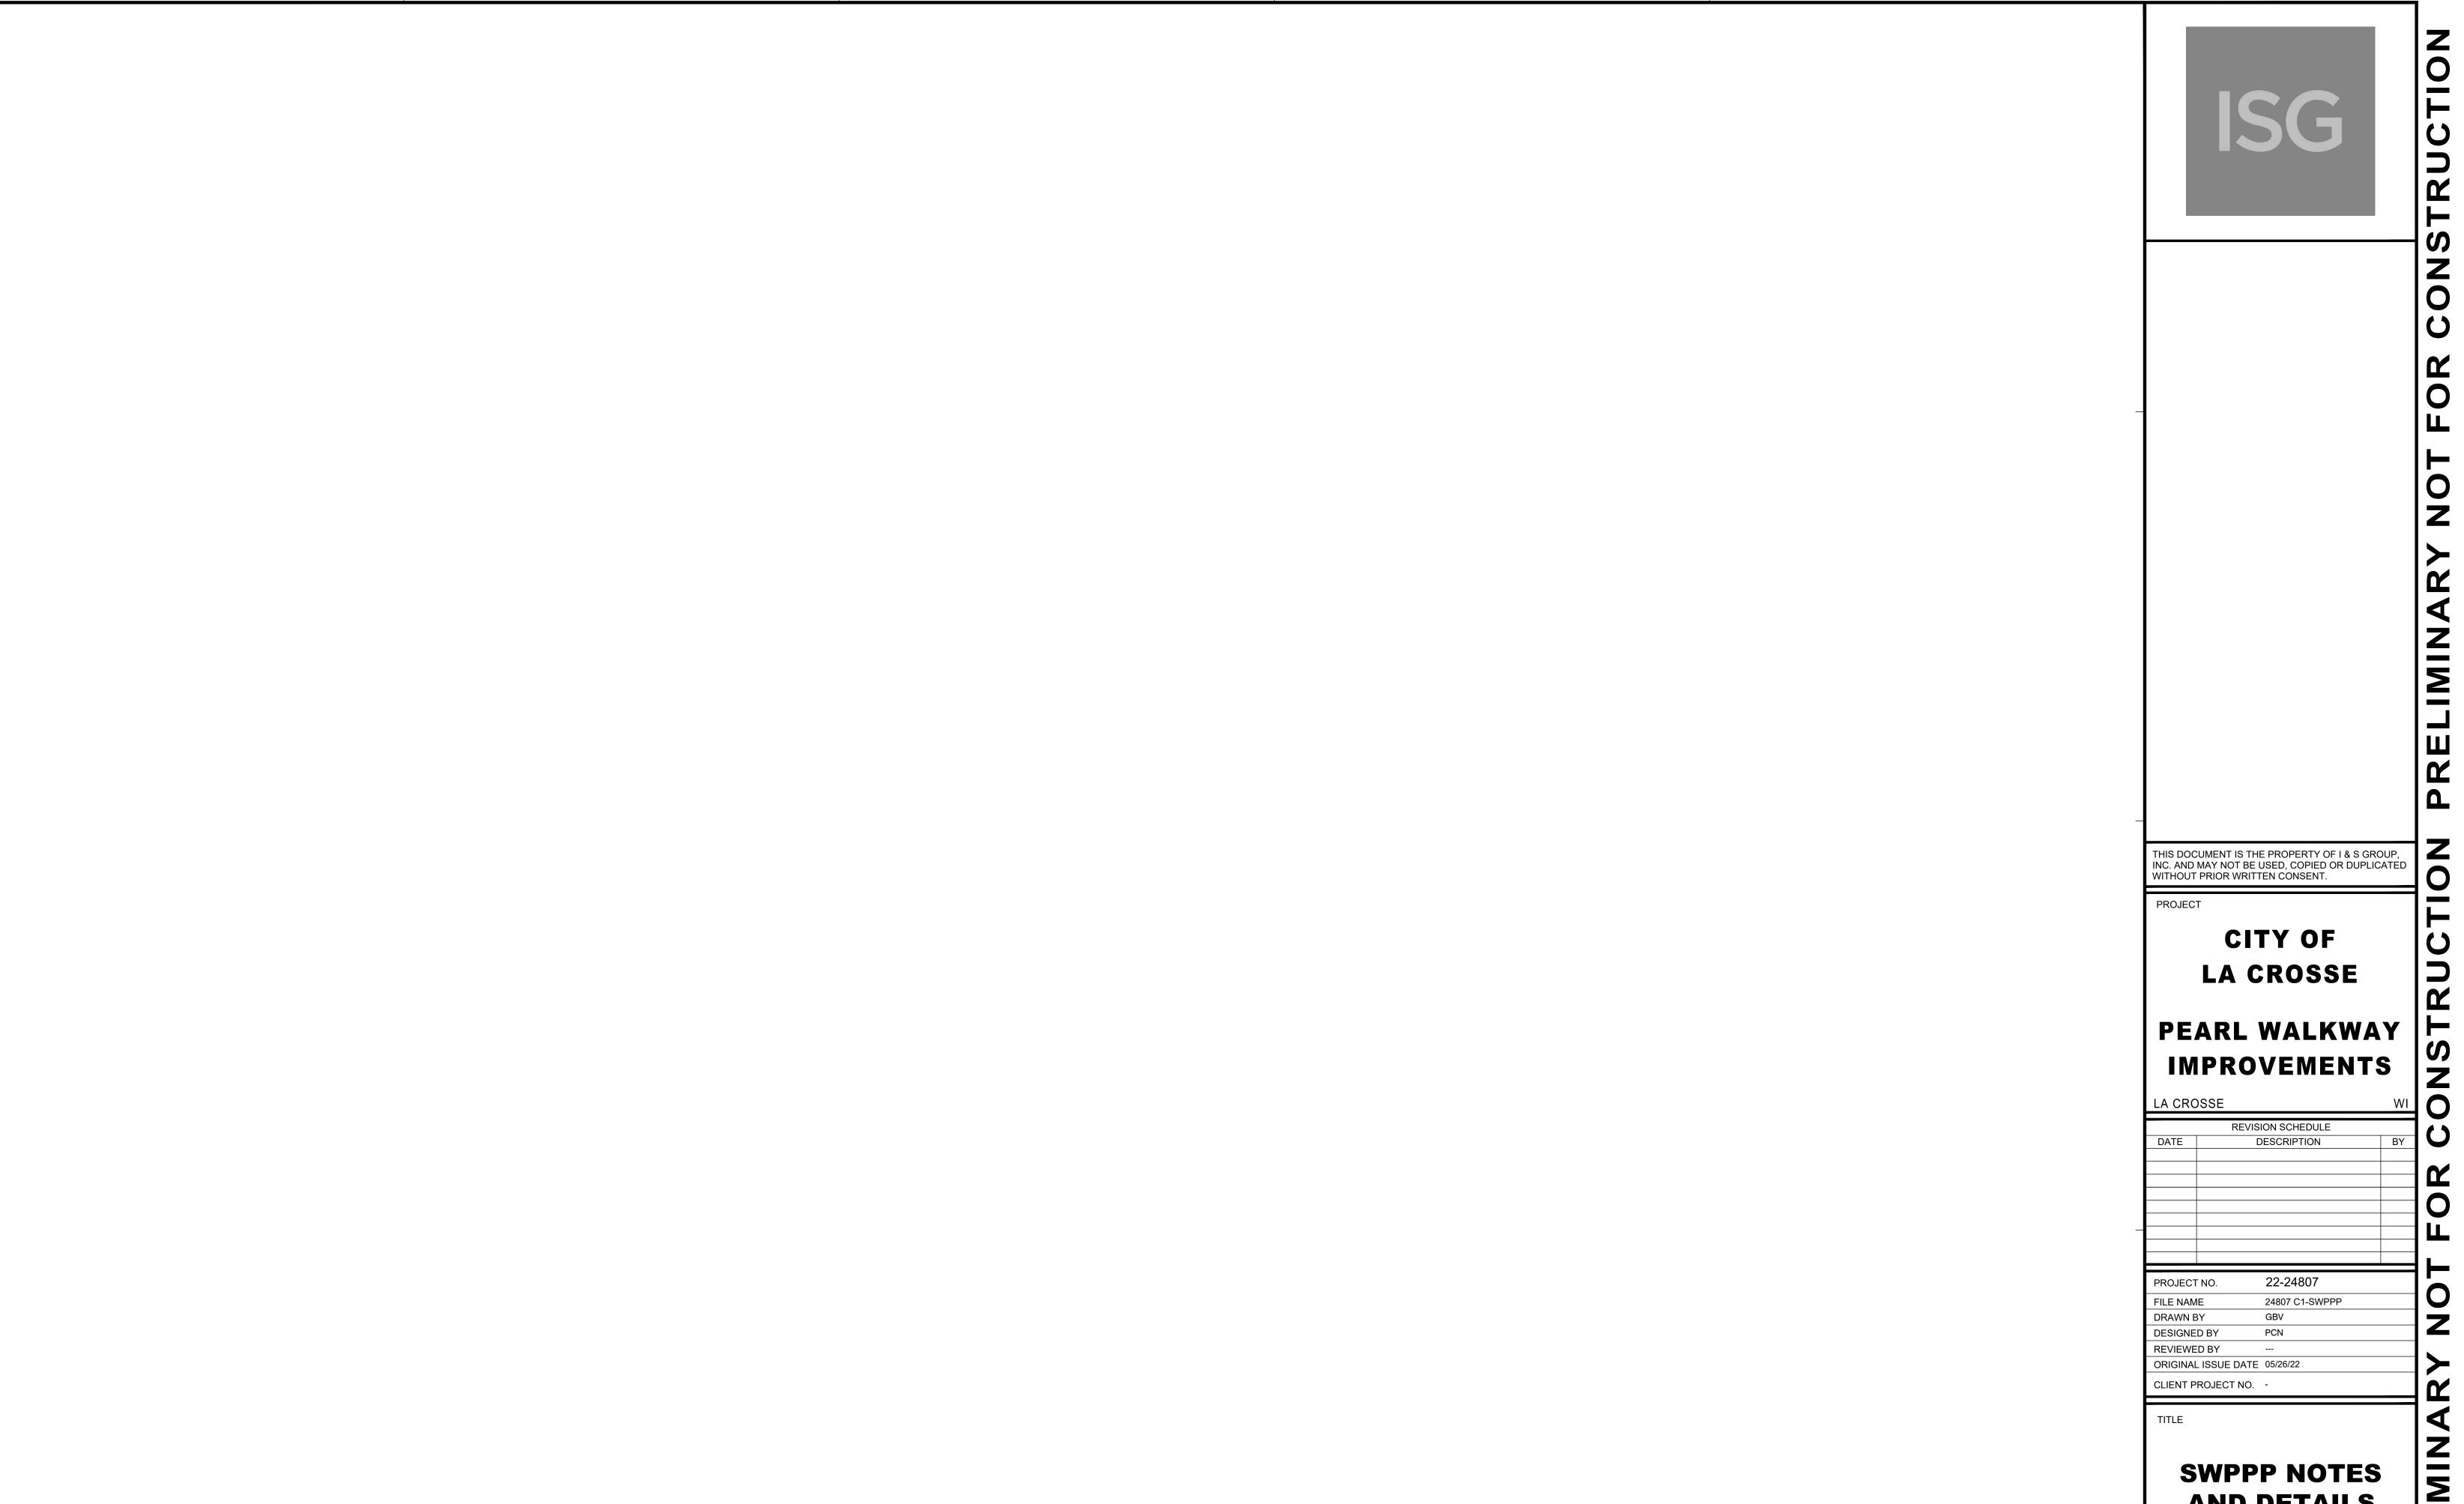


		REVIS	ION SCH	EDULE		
DATE			DESCRIP	TION		BY
PROJECT	NO.		22-24	807		
FILE NAM	IE		24807 C	1-SWPPP	·	

SWPPP NOTES AND DETAILS

PRELIMINAR

C1-10

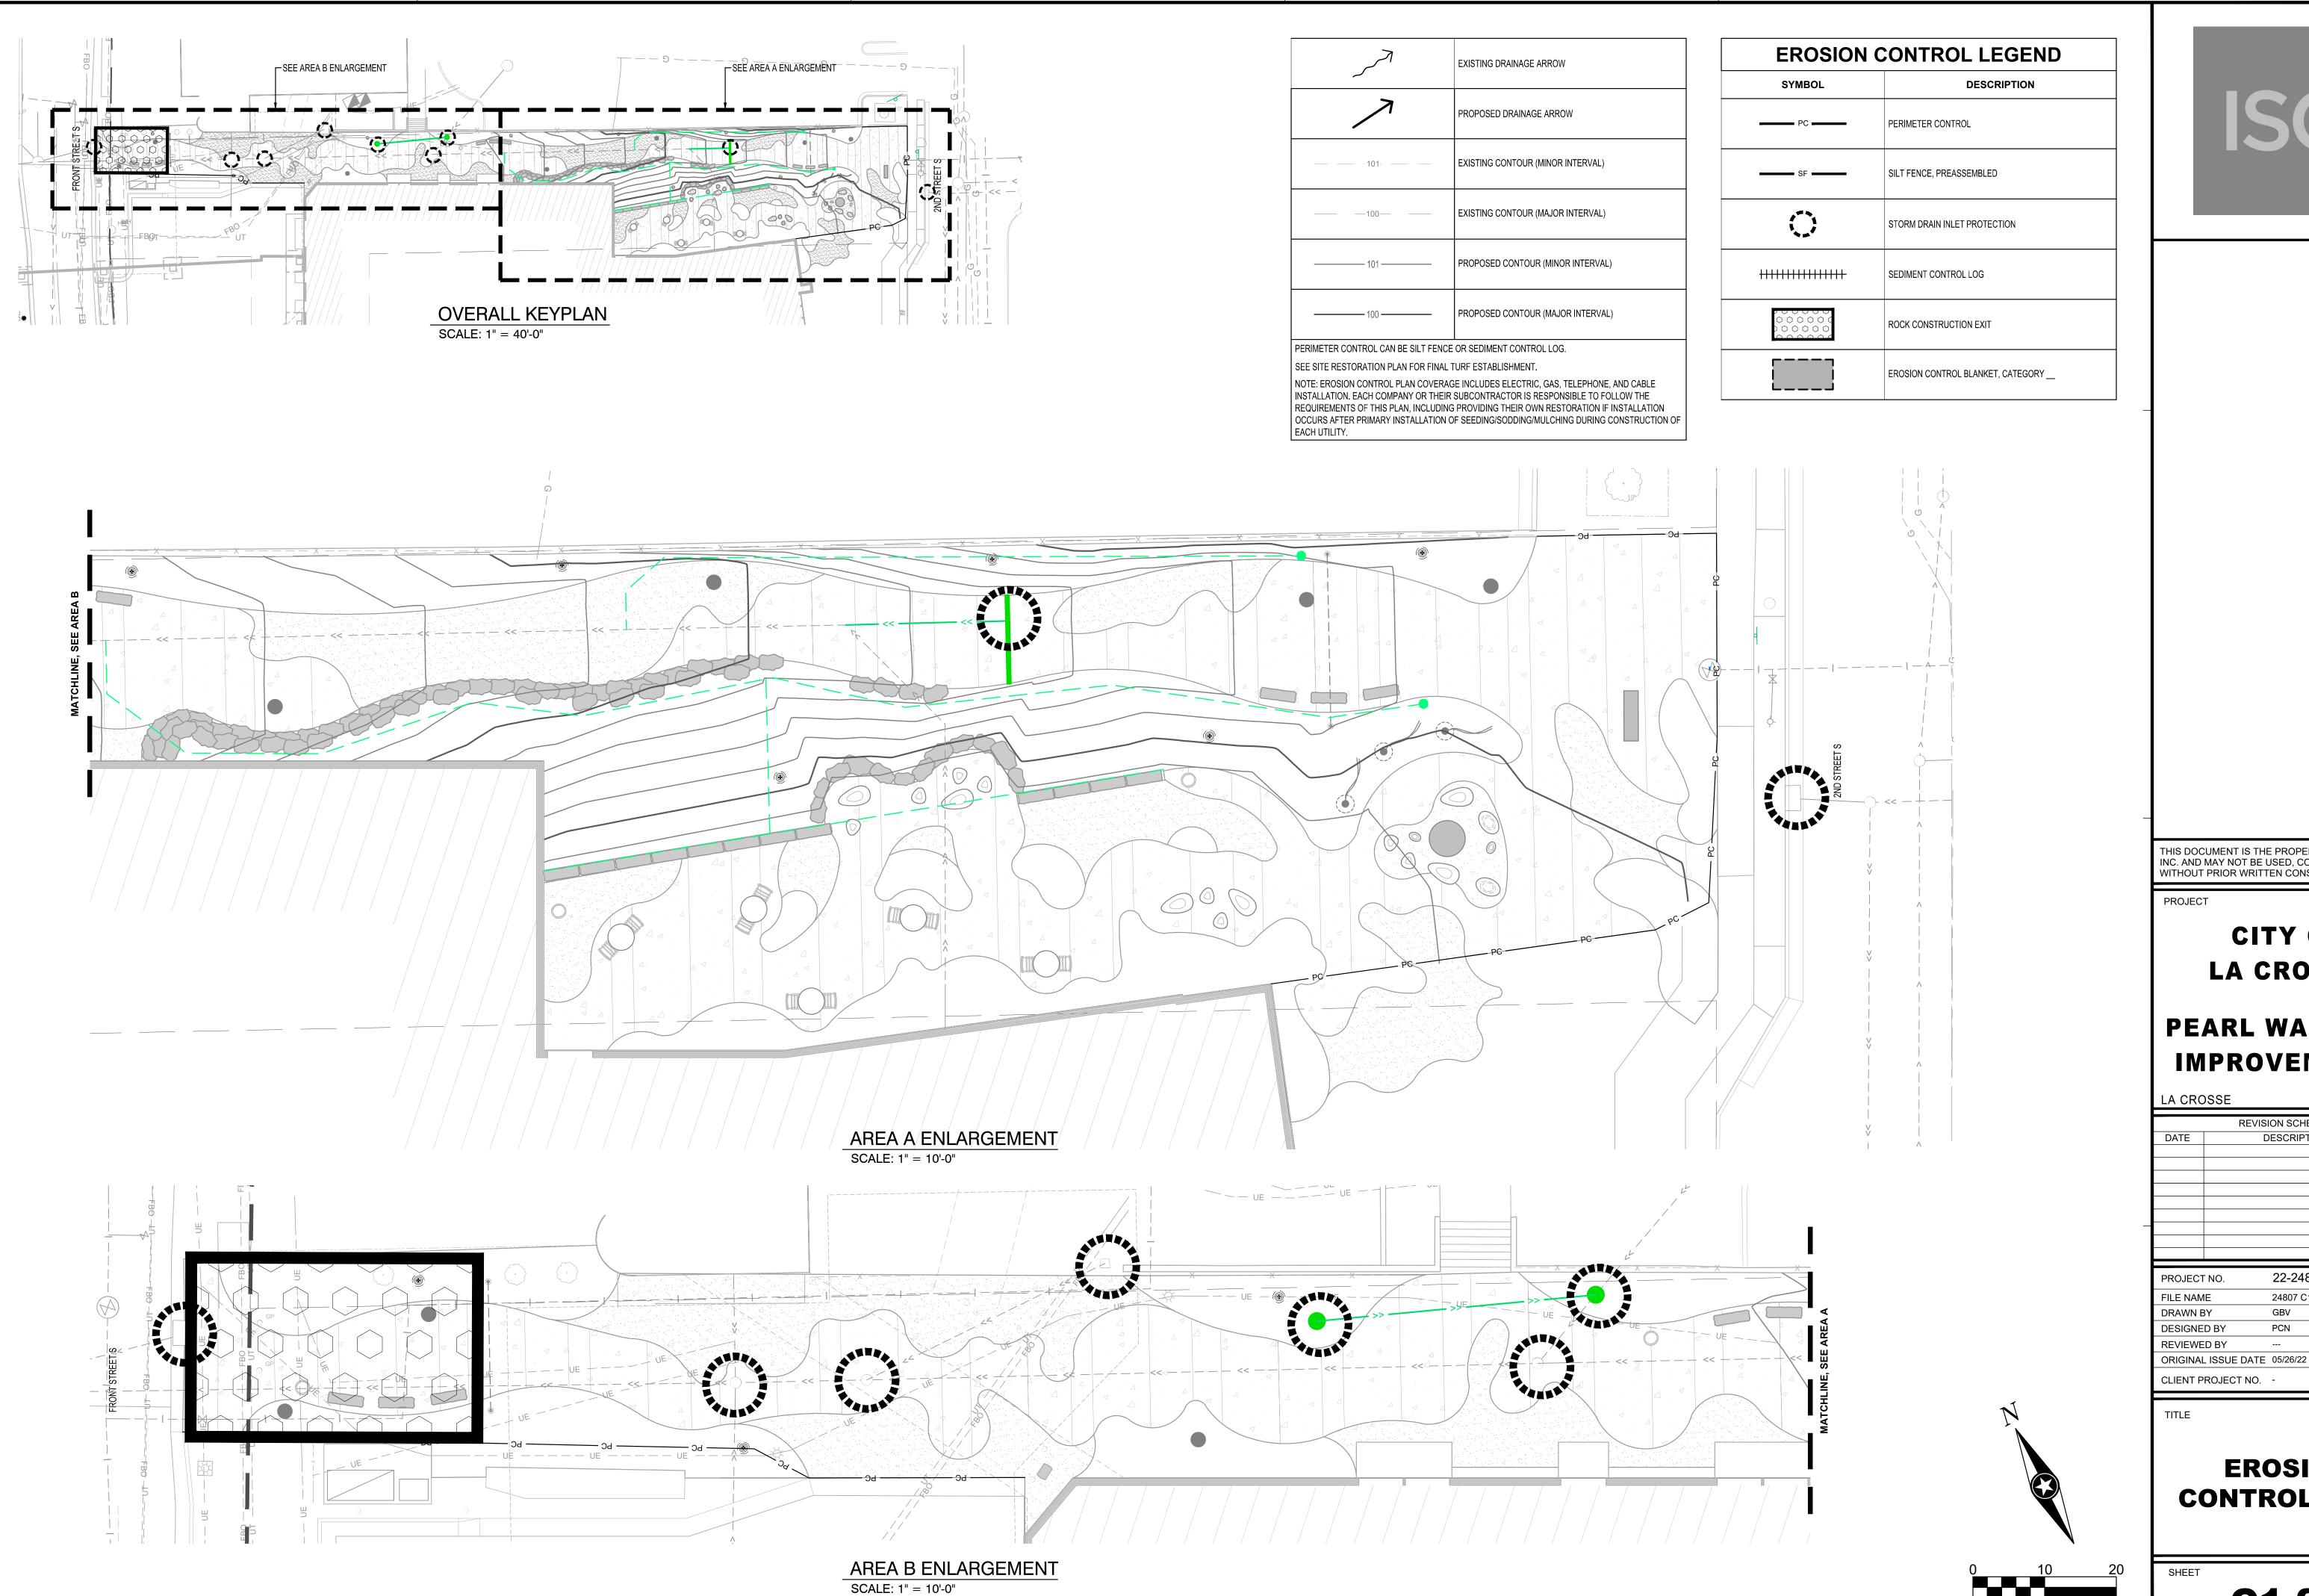



PRELIMINARY


CITY OF LA CROSSE

PEARL WALKWAY IMPROVEMENTS

LA CROSSE REVISION SCHEDULE DESCRIPTION 22-24807 PROJECT NO. 24807 C1-SWPPP

EROSION CONTROL PLAN

C1-20

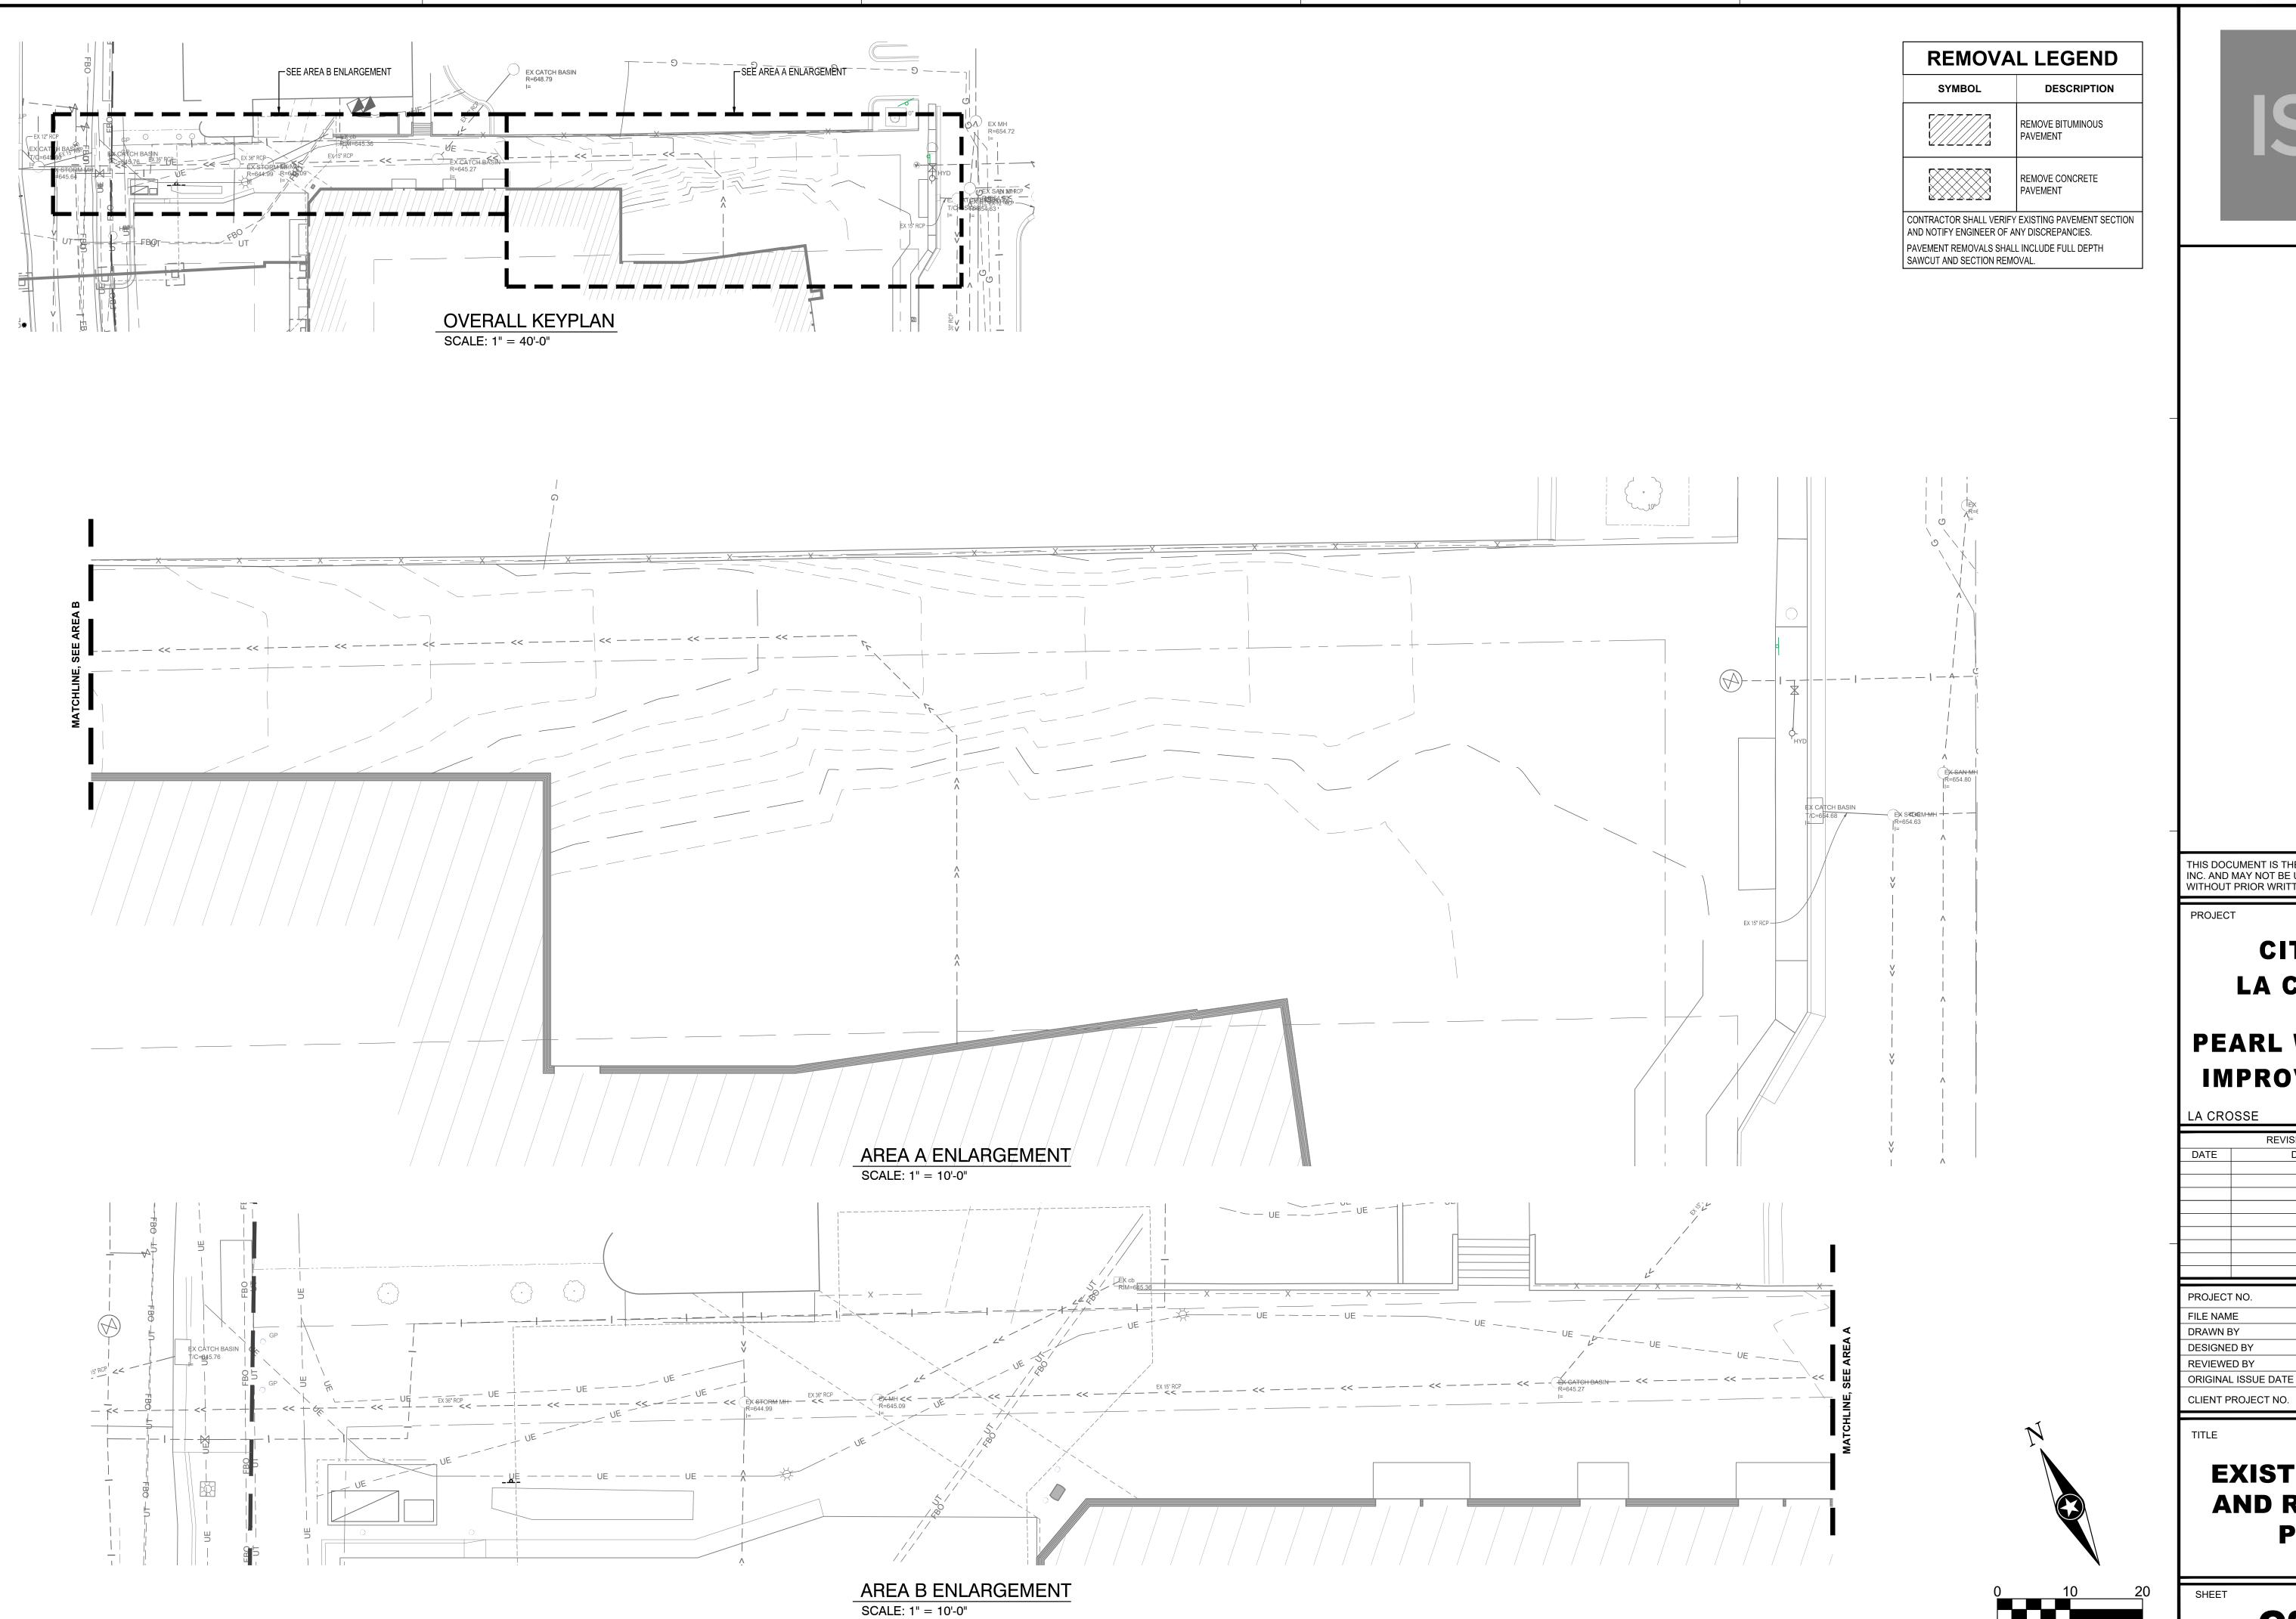



> CITY OF LA CROSSE

PEARL WALKWAY **IMPROVEMENTS**


REVISION SCHEDULE DESCRIPTION


PROJECT NO.	22-24807
FILE NAME	24807 C2-EXIST
DRAWN BY	GBV
DESIGNED BY	PCN
REVIEWED BY	
ORIGINAL ISSUE DATE	05/26/22

EXISTING SITE AND REMOVAL PLAN

MINA

C2-10

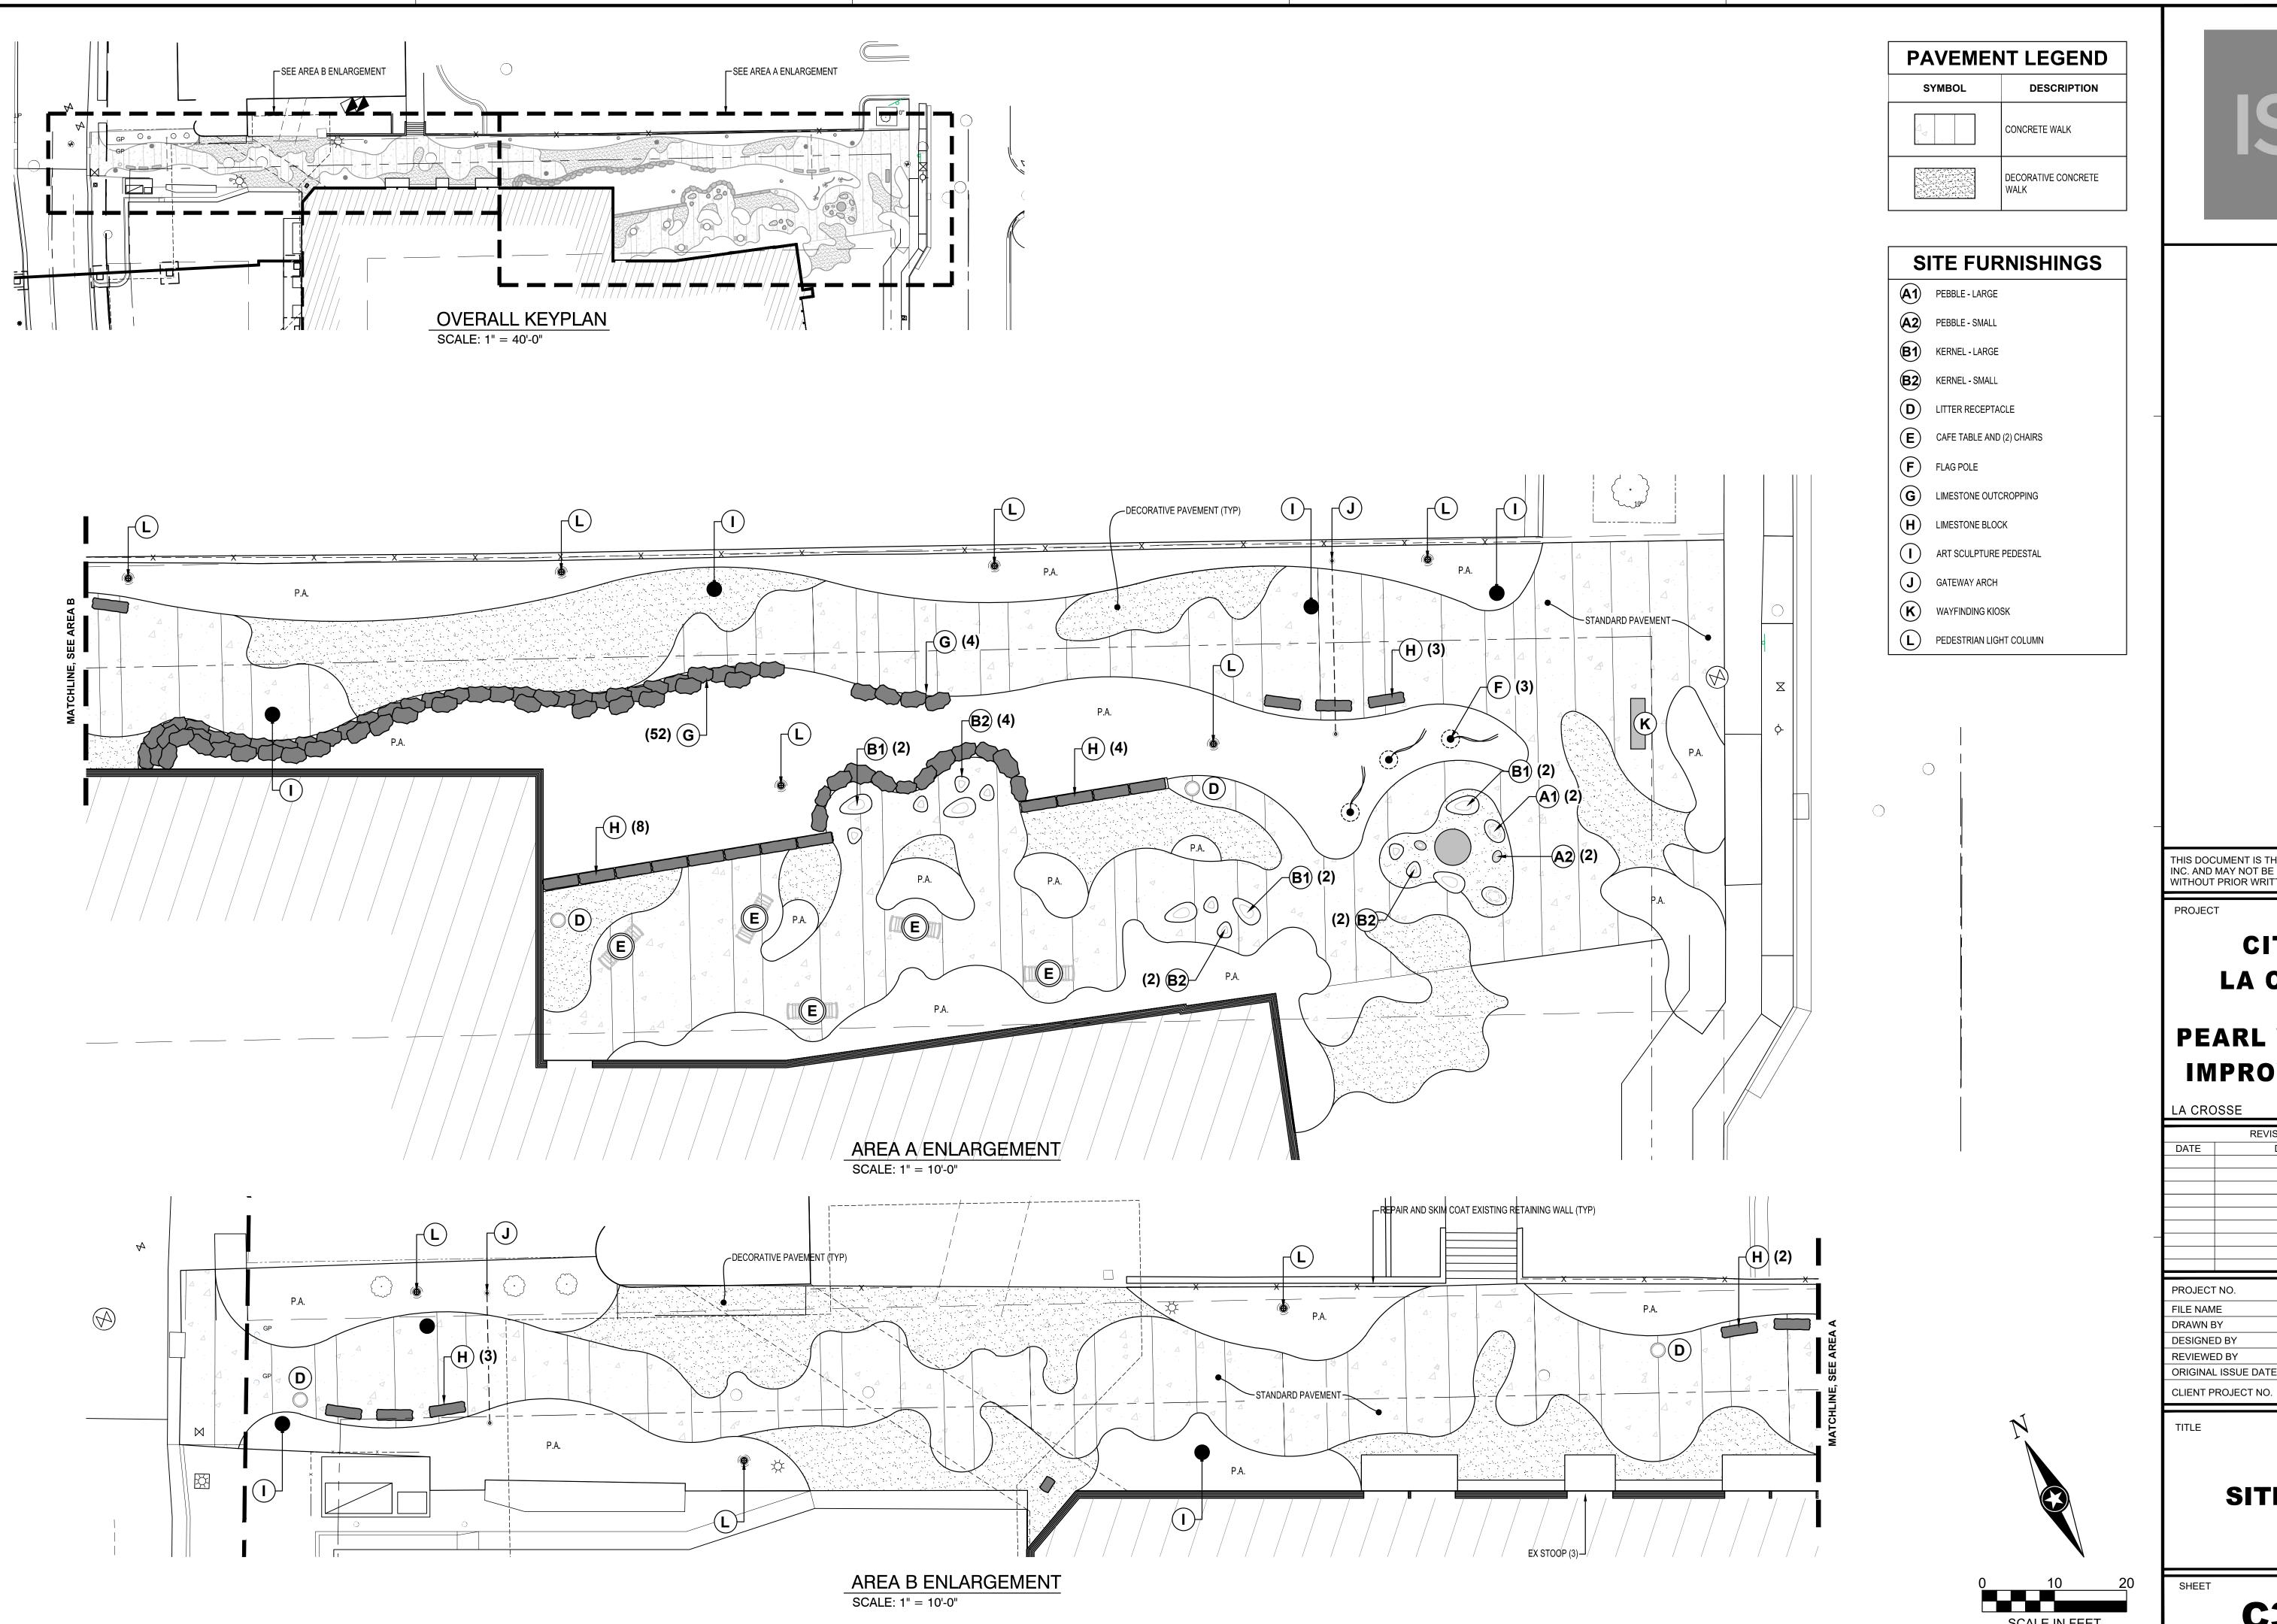

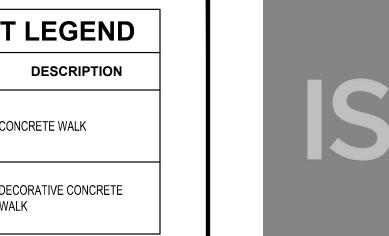

CONSTRUCTION

PRELIMINARY

CITY OF LA CROSSE


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LA CROSSE REVISION SCHEDULE DESCRIPTION 22-24807 PROJECT NO. 24807 C3-SITE DRAWN BY DESIGNED BY REVIEWED BY ORIGINAL ISSUE DATE 05/26/22

SITE PLAN

PRELIMINAR

C3-10



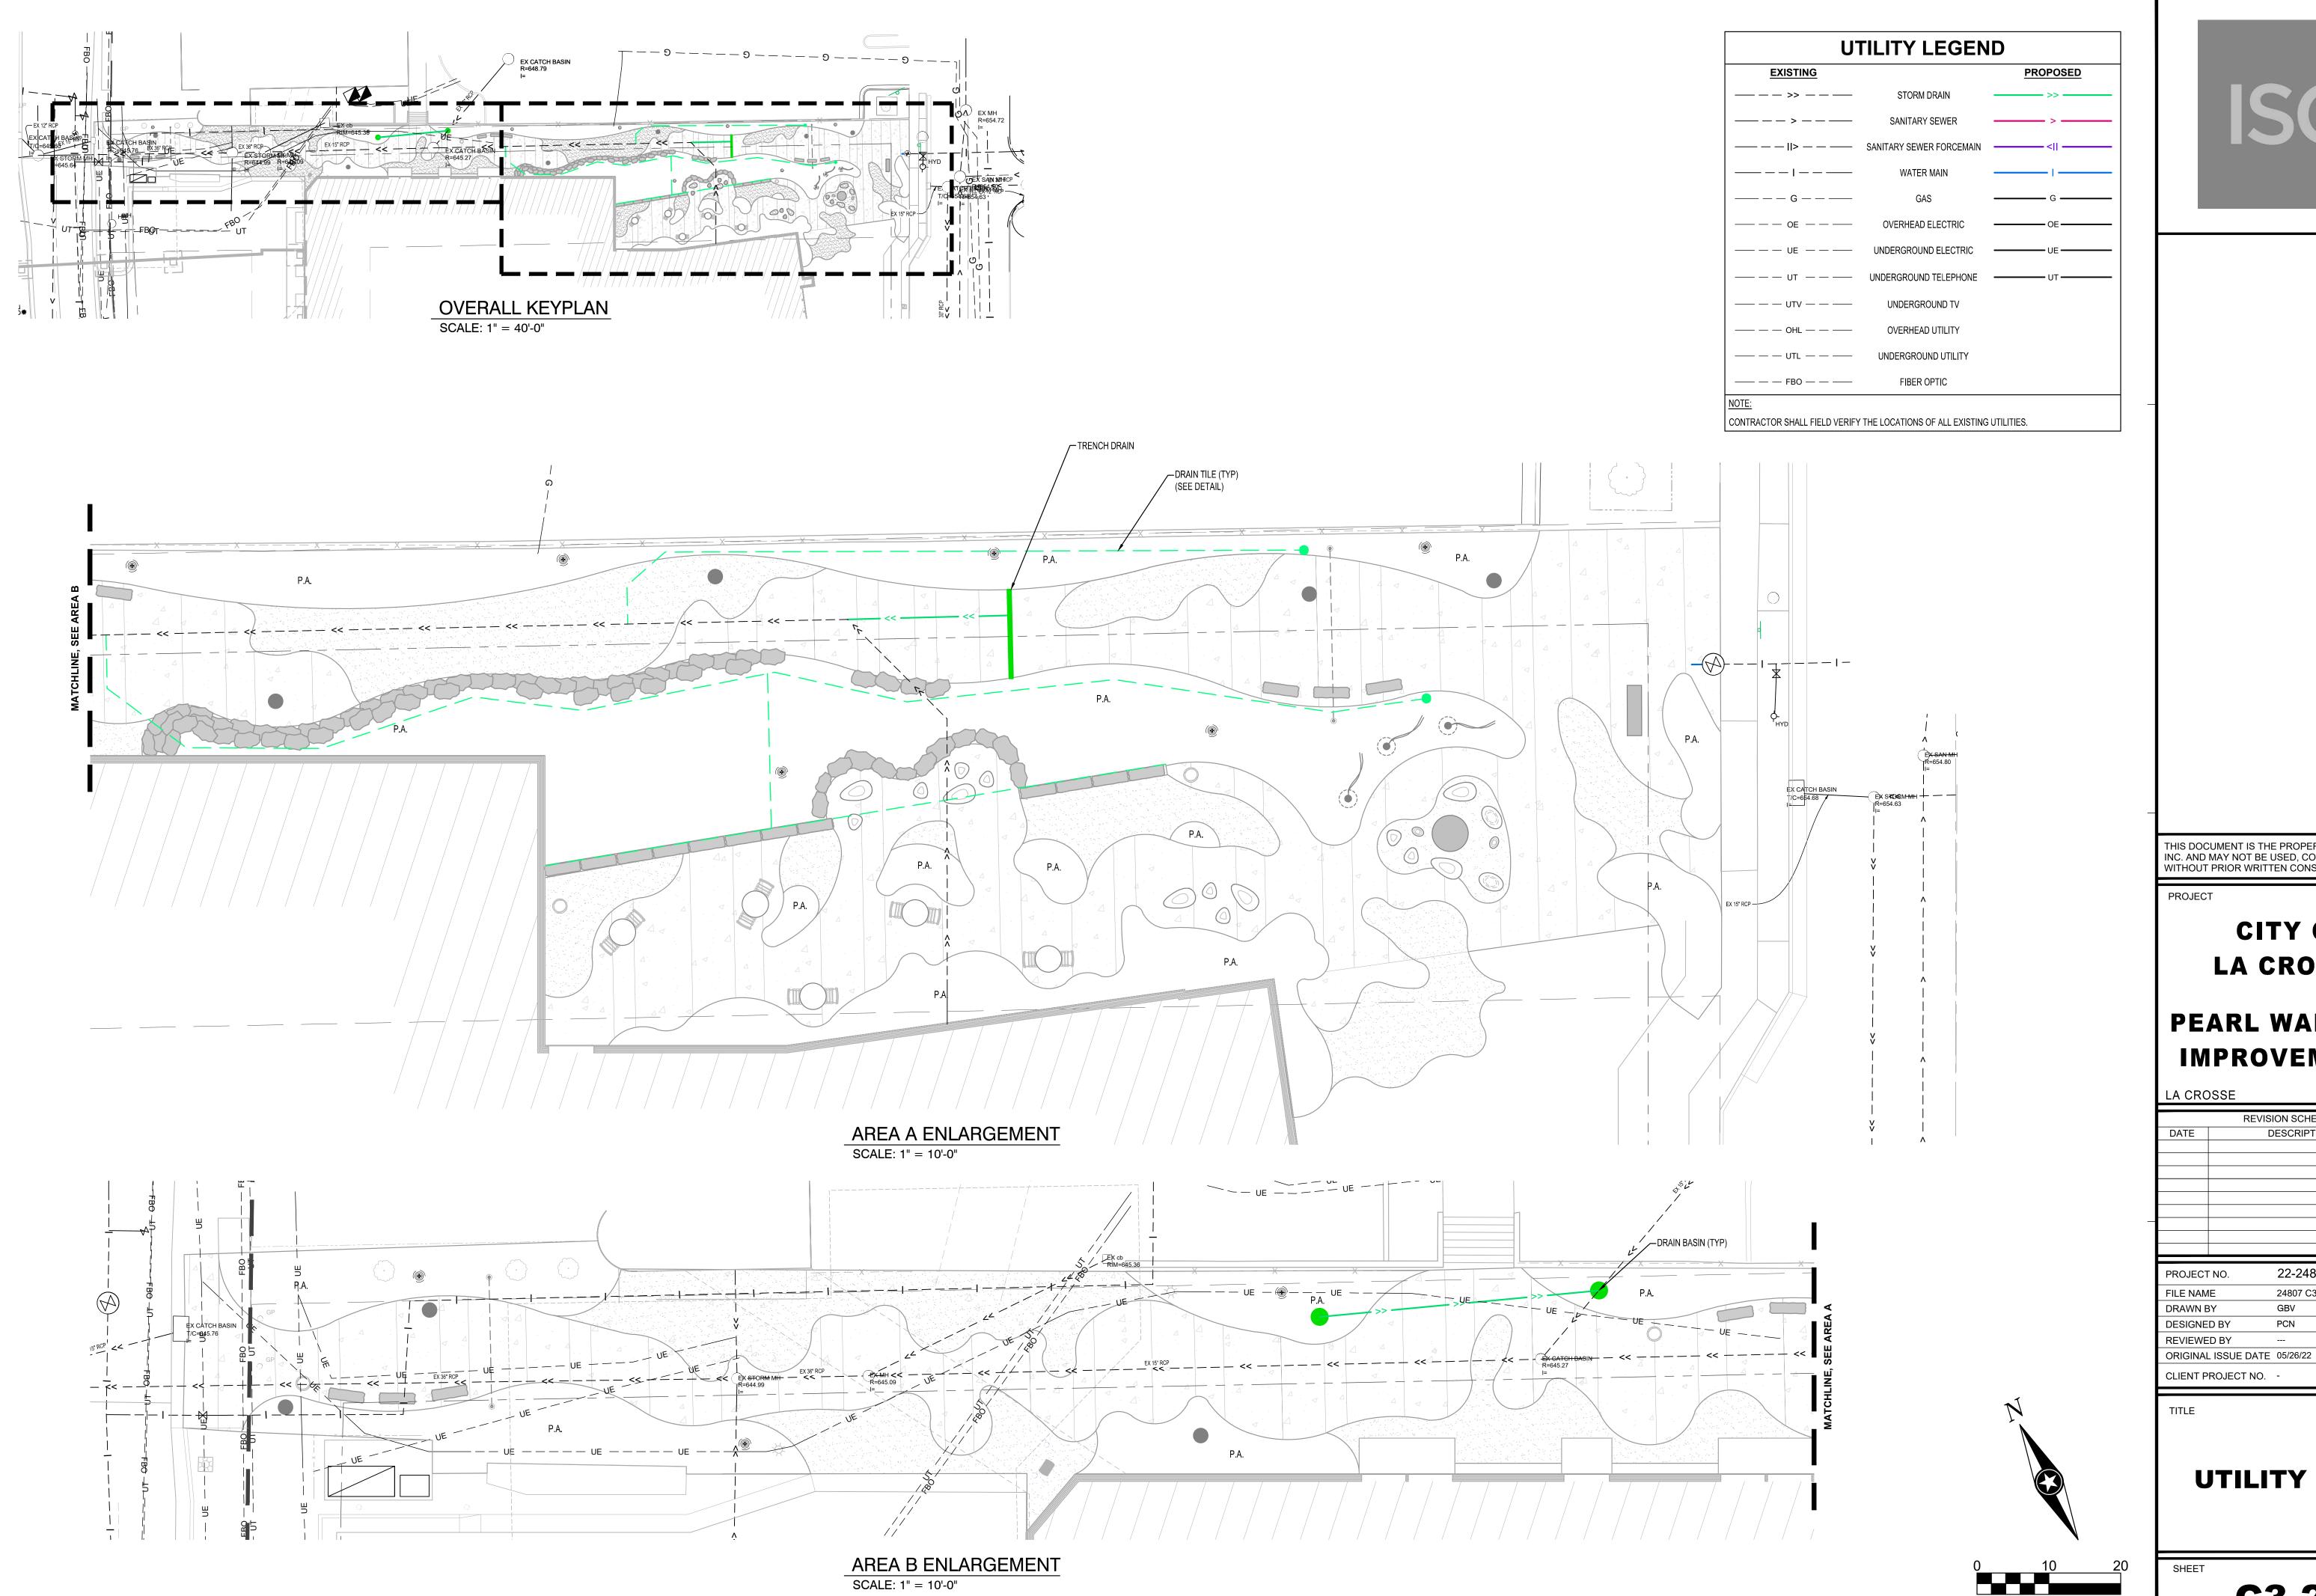


> CITY OF LA CROSSE

PEARL WALKWAY **IMPROVEMENTS**

LA CROSSE REVISION SCHEDULE DESCRIPTION 22-24807 PROJECT NO. 24807 C3-UTILITY DESIGNED BY

UTILITY PLAN

C3-20

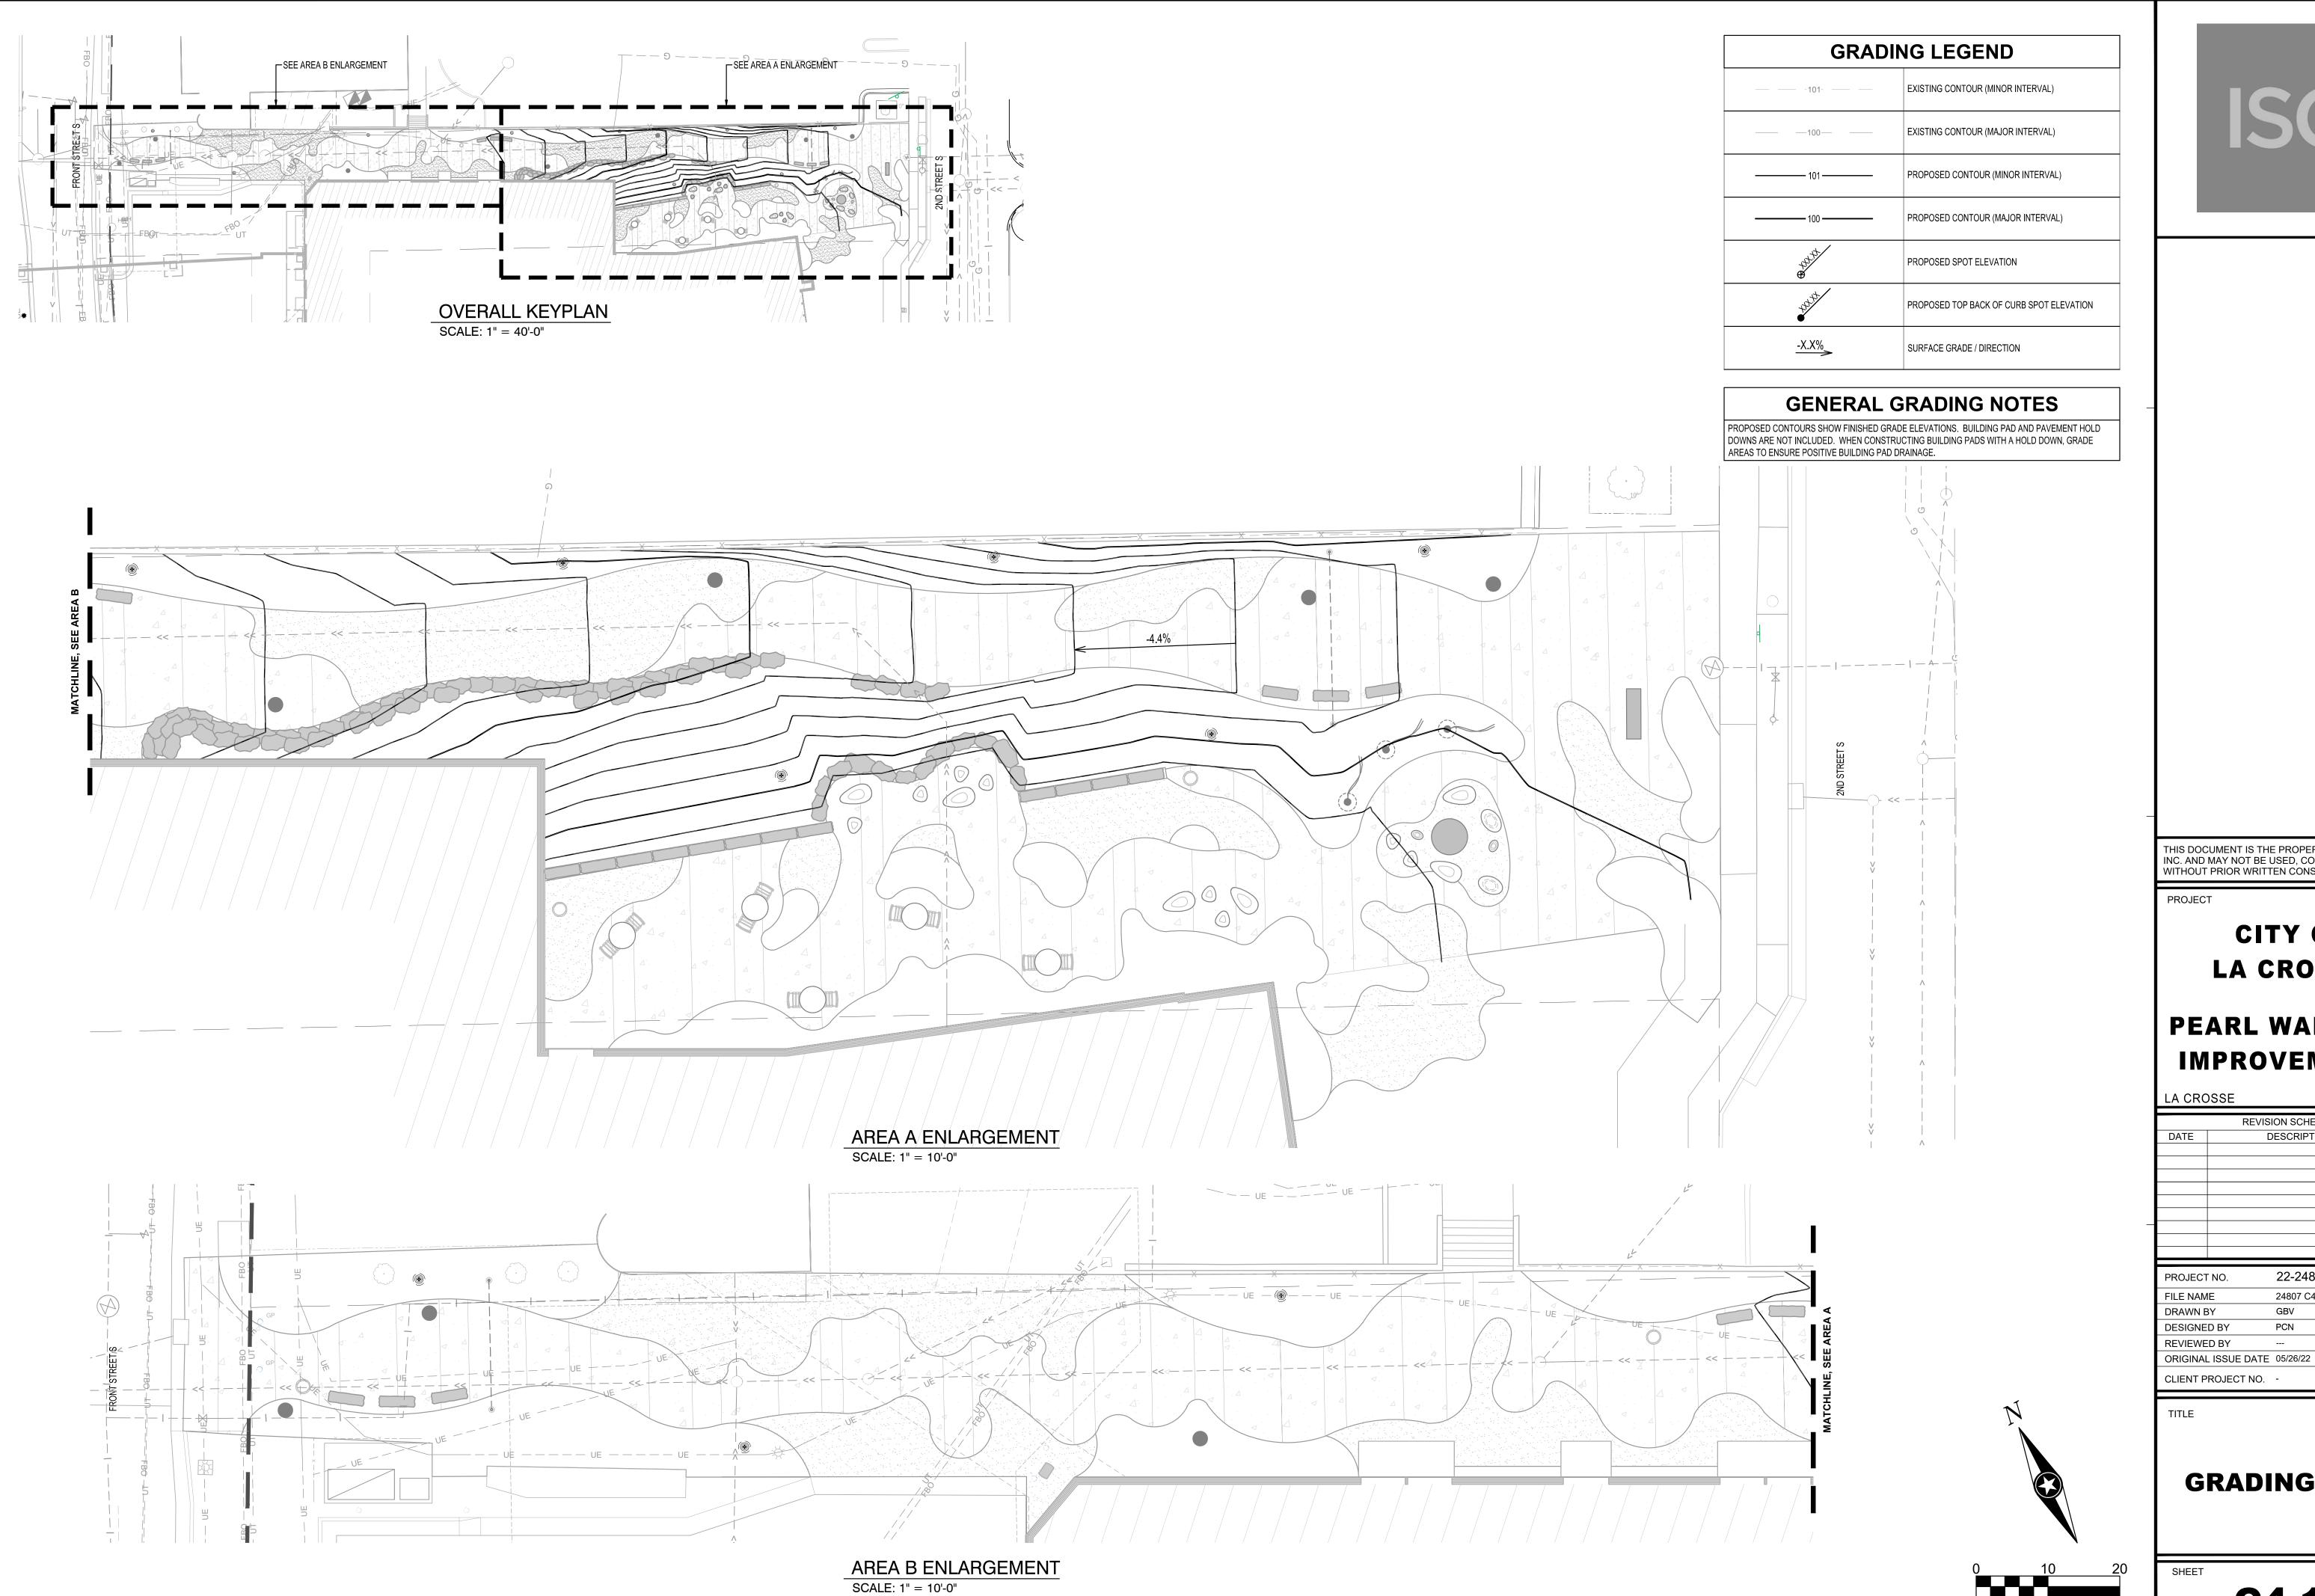



PRELIMINARY


CITY OF LA CROSSE


PEARL WALKWAY **IMPROVEMENTS**

REVISION SCHEDULE DESCRIPTION 22-24807 24807 C4-GRADE

GRADING PLAN

C4-10

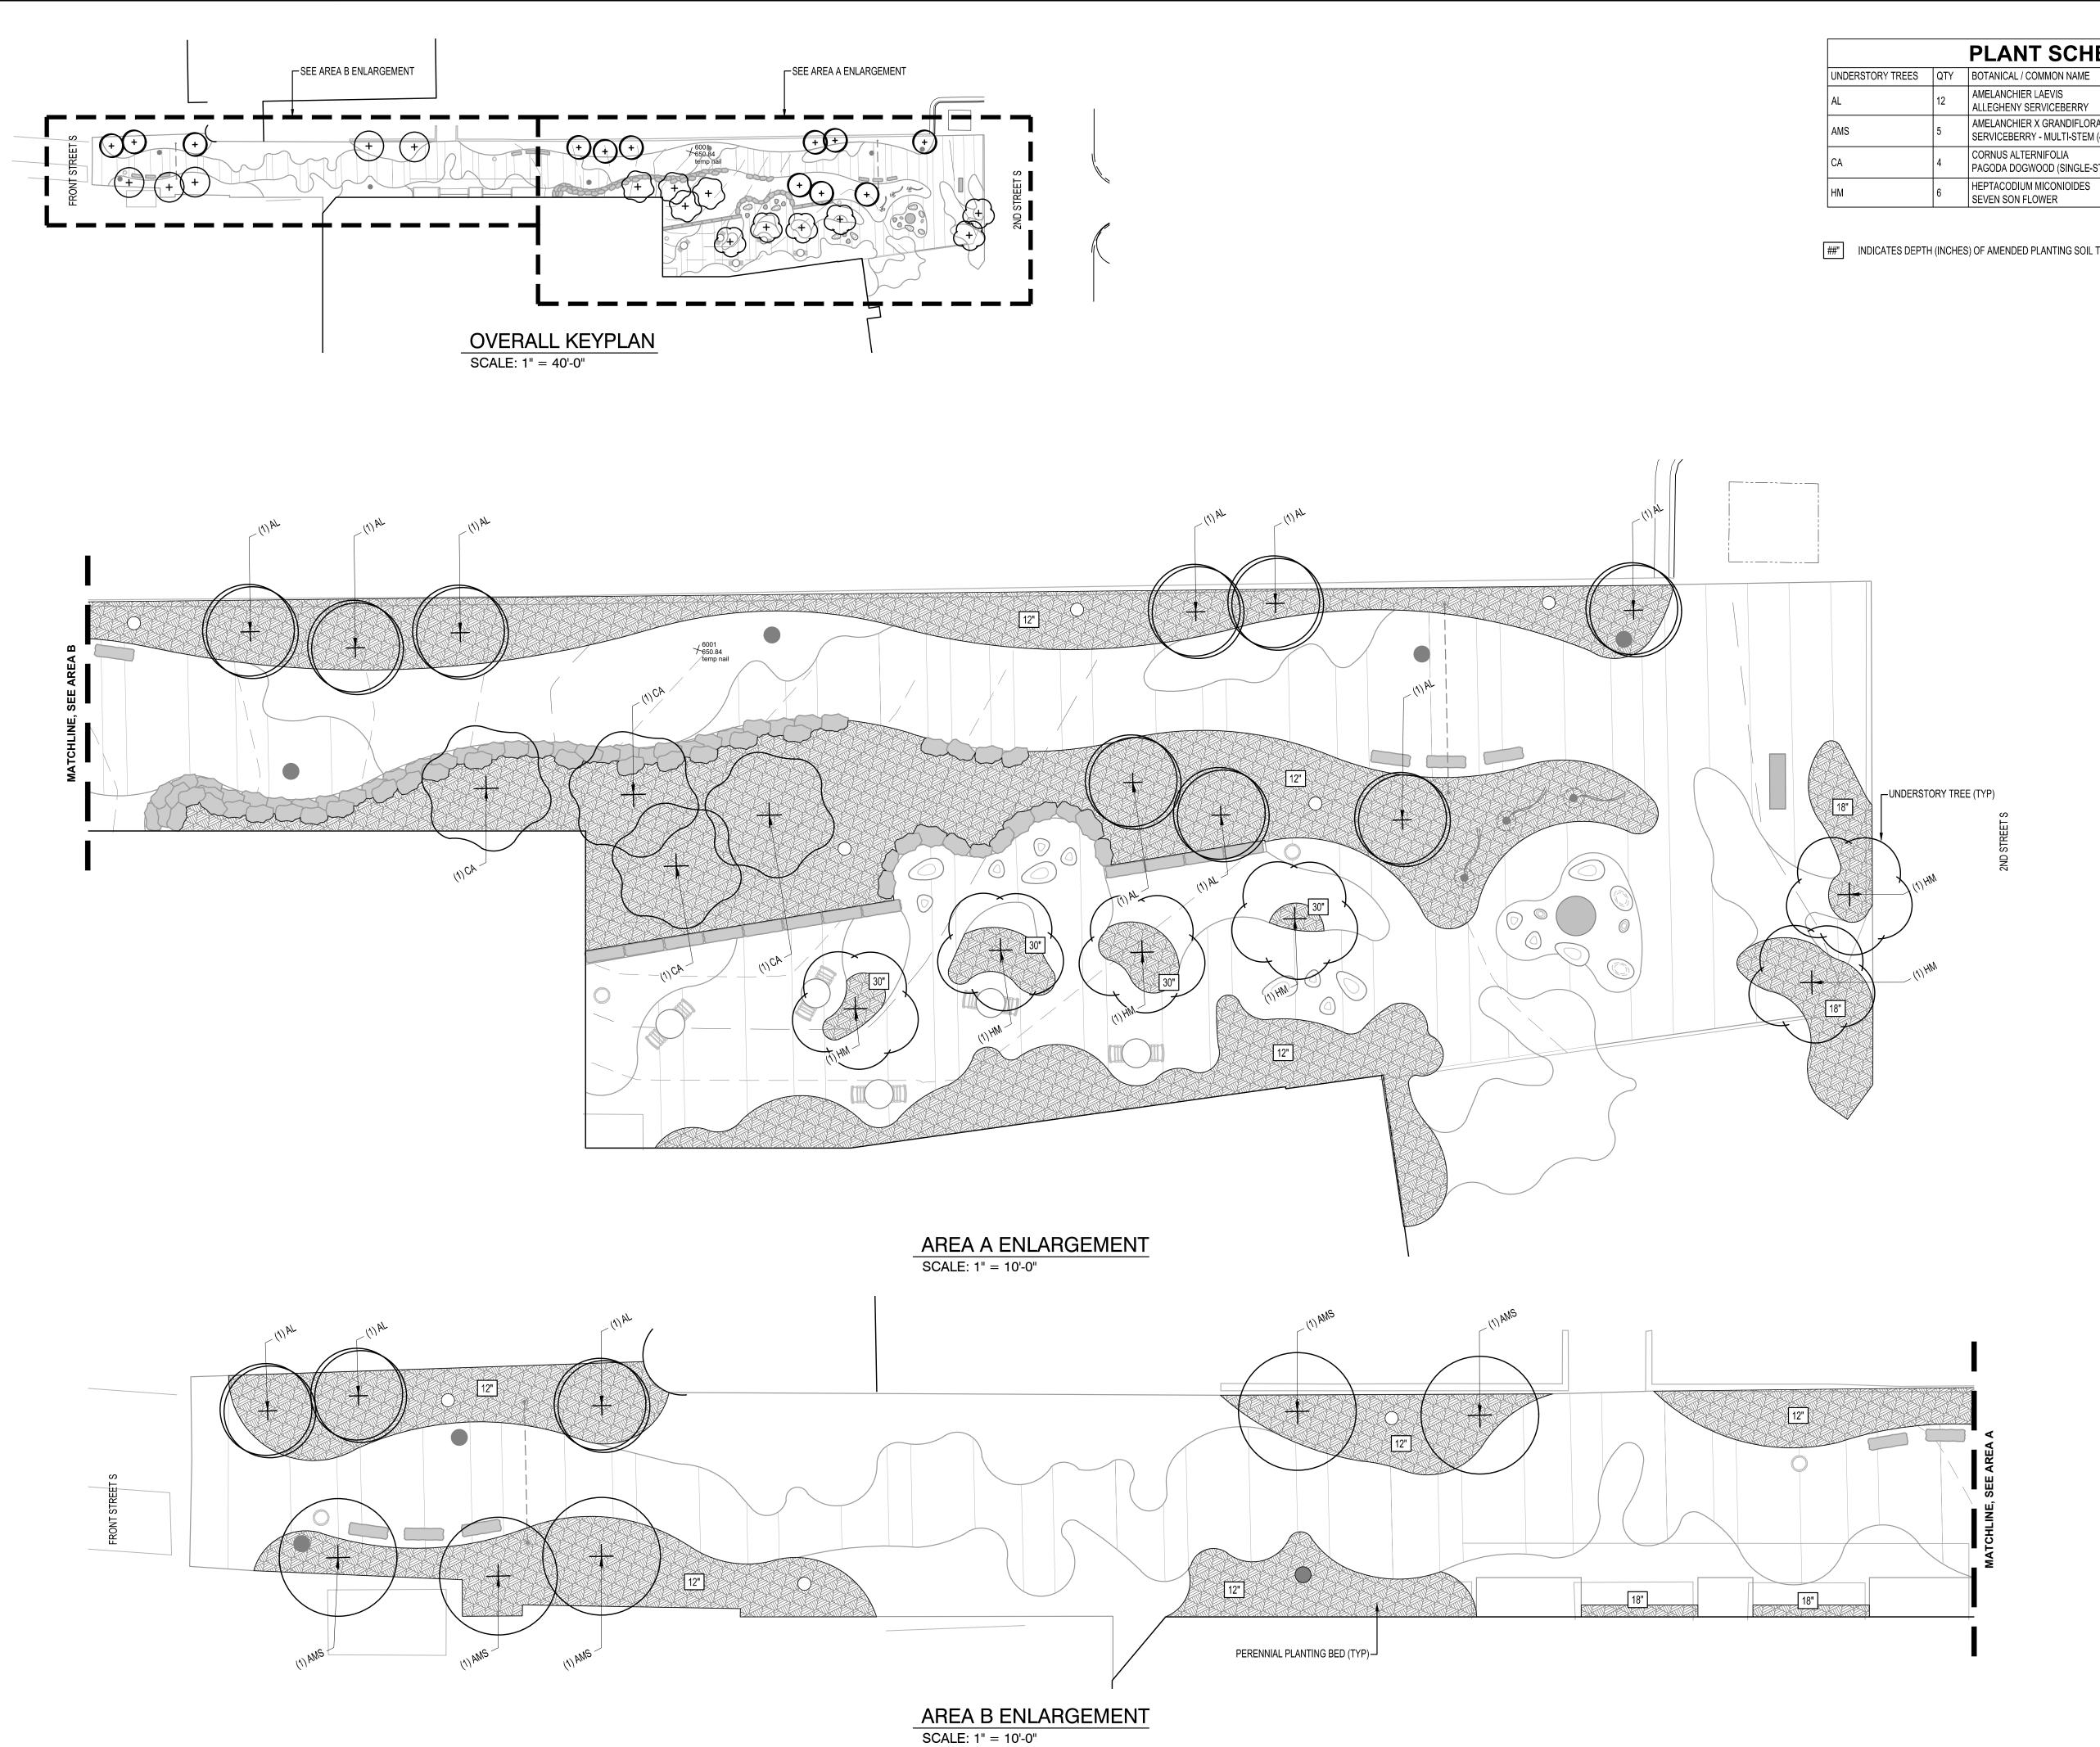

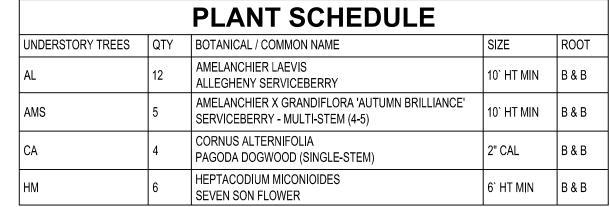

##" INDICATES DEPTH (INCHES) OF AMENDED PLANTING SOIL TO BE PROVIDED IN PLANTING AREA



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PRELIMINARY

PROJECT

CITY OF LA CROSSE

PEARL WALKWAY IMPROVEMENTS

	REVISION SCHEDULE				
DATE		DESCRIPTION		BY	
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PROJECT	ΓNO.	22-24807			
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TITLE

CLIENT PROJECT NO.


ORIGINAL ISSUE DATE 05/26/22

DRAWN BY DESIGNED BY REVIEWED BY

PLANTING PLAN -TREES

SHEET

C5-10

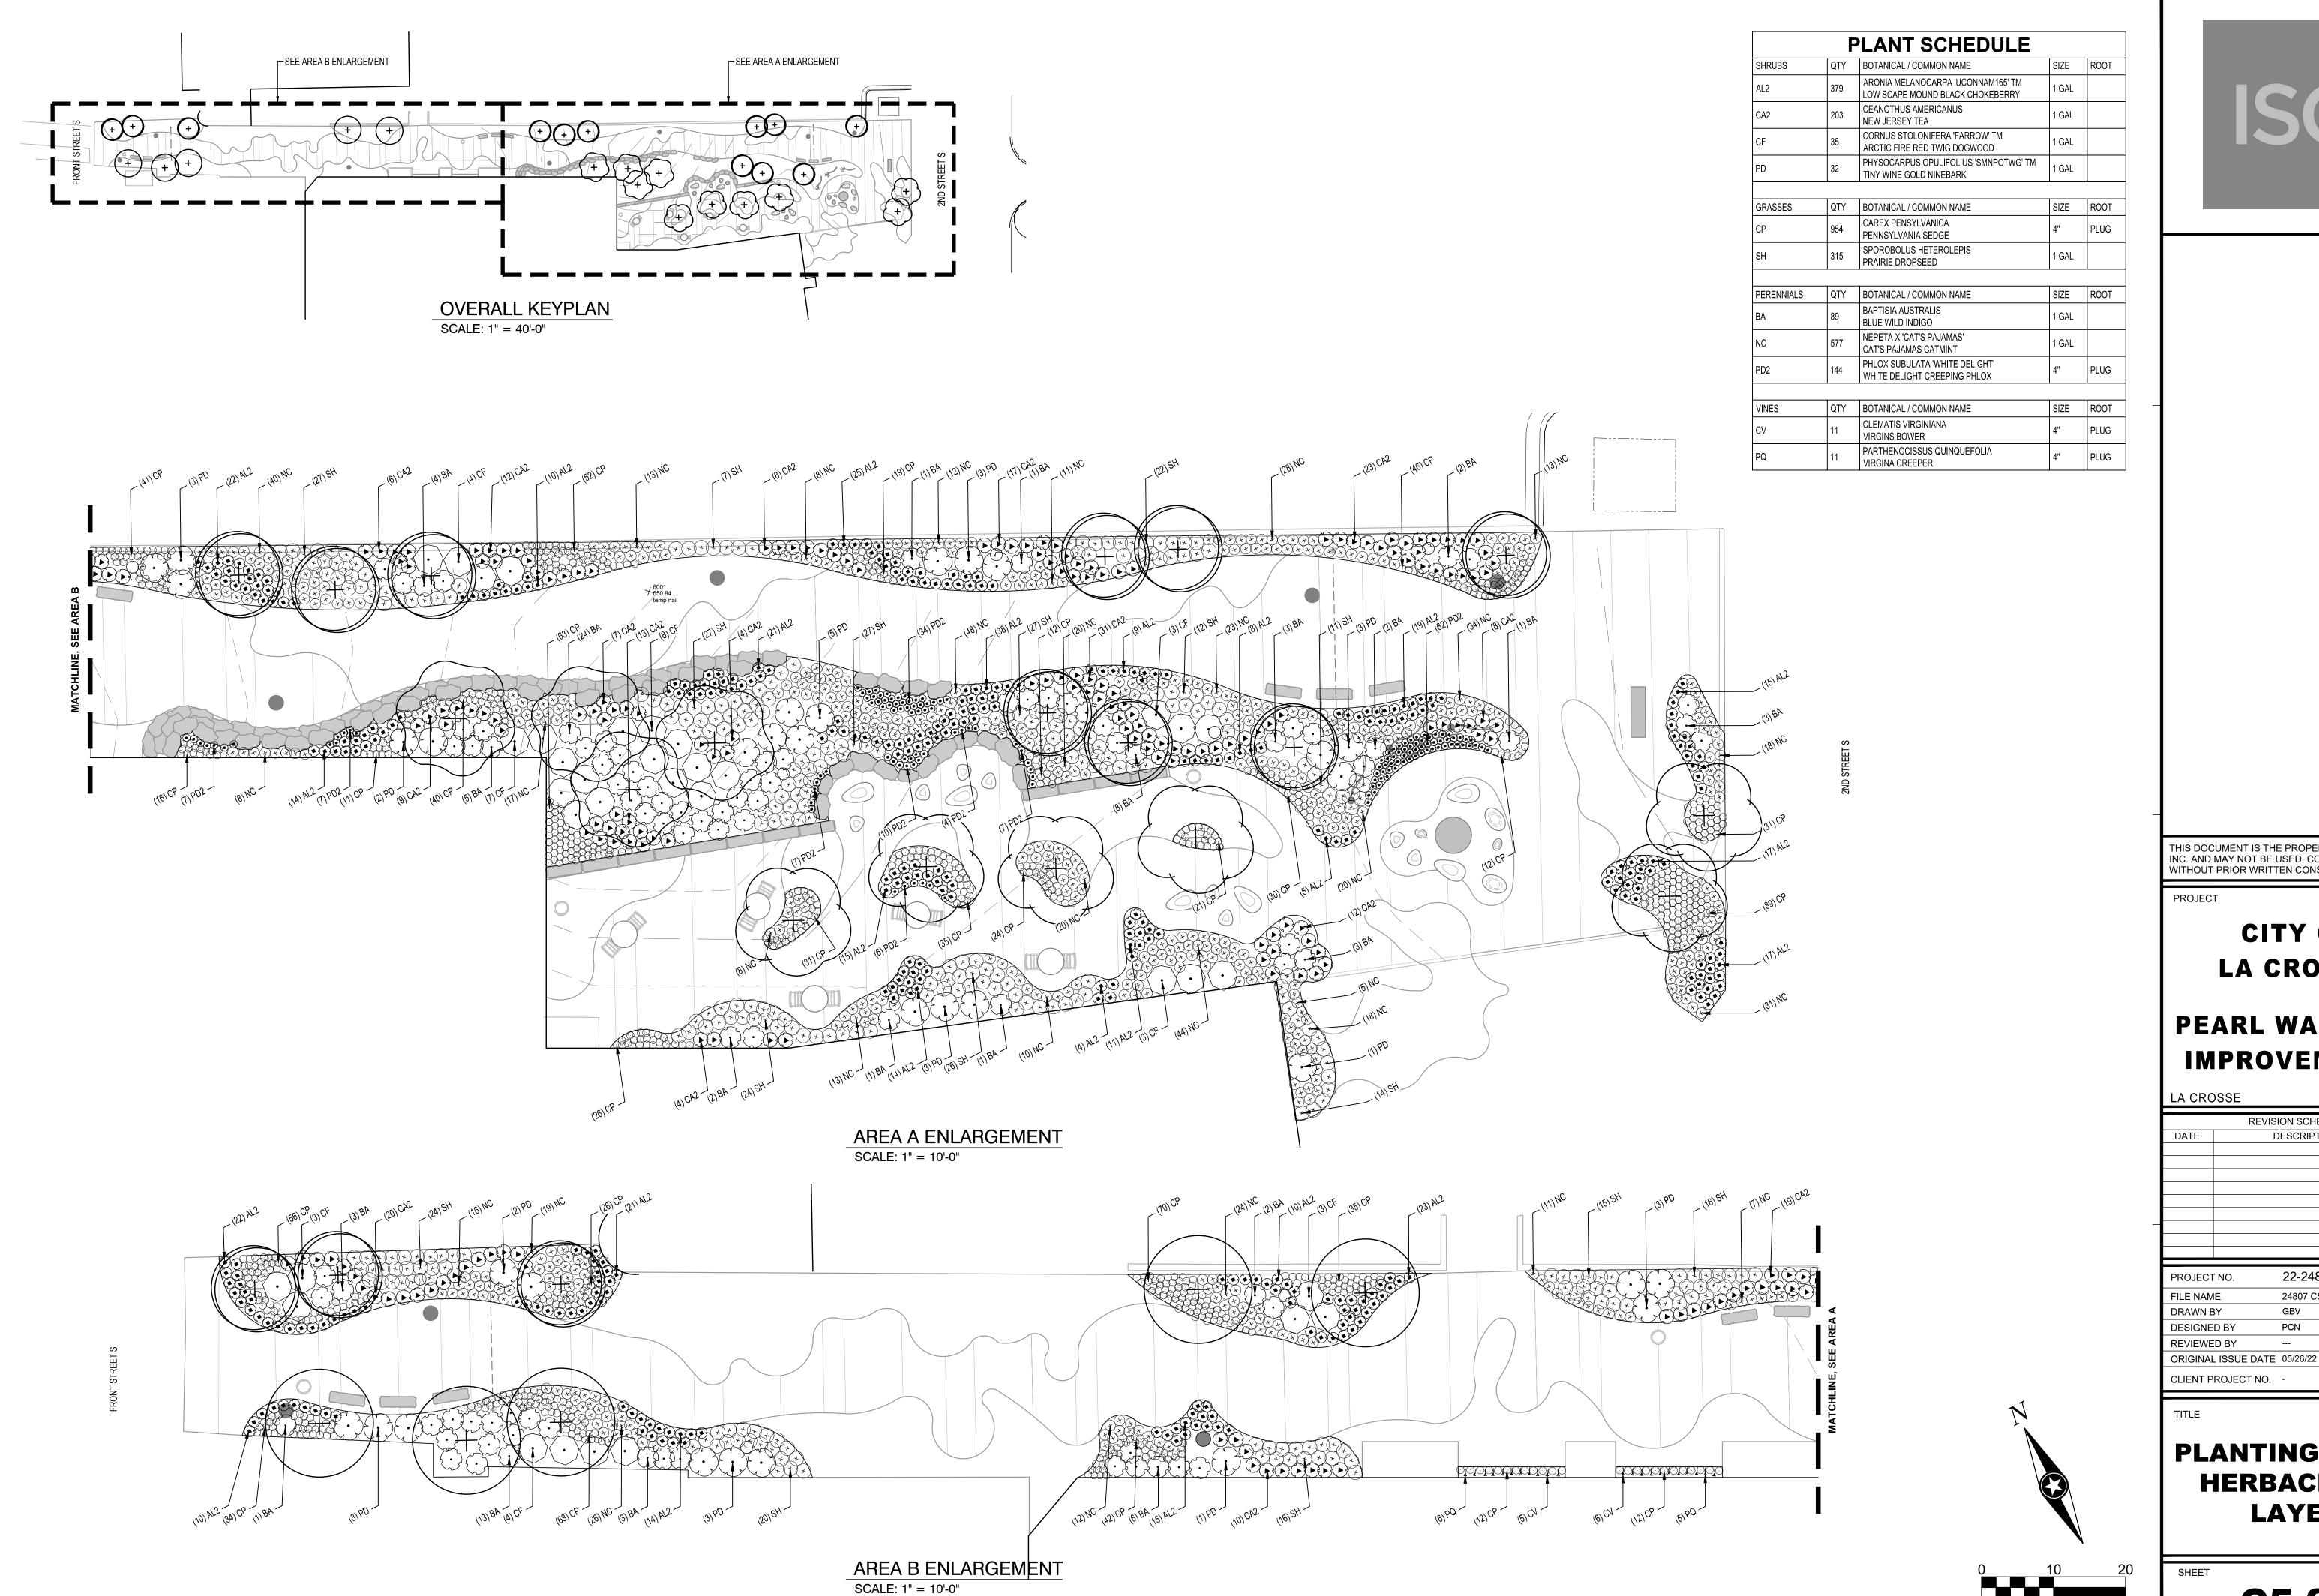



CITY OF LA CROSSE

PEARL WALKWAY **IMPROVEMENTS**

DATE		DESCRIPTION	BY
PROJECT	٦NO.	22-24807	
FII F NAM	1F	24807 C5-I AND	

PLANTING PLAN -HERBACEOUS LAYER

NIWIN

PRE

C5-20

PRUNE ALL BROKEN, DAMAGED, OR RUBBING LIMBS AND BRANCHES IMMEDIATELY AFTER PLANTING - ALL PRUNING CUTS CLEAN AT 90° -DO NOT CUT PRIMARY LEADERS - 3 LARGEST DIAMETER STEMS -3" LAYER OF SHREDDED HARDWOOD MULCH MOUNDED AT EDGE TO FORM A SHALLOW SAUCER - DO NOT PLACE MULCH DIRECTLY ON TREE TRUNK, LEAVE A MINIMUM 3" RING AROUND CROWN SET ROOT FLARE 3" ABOVE FINISH GRADE DO NOT STAKE TREES 2. THOROUGHLY WATER-IN ALL TREES IMMEDIATELY AFTER PLANTING AND ENSURE NO CUT AND REMOVE AT MINIMUM THE TOP HALF UNDESIRABLE SETTLING OF WIRE BASKETS, BURLAP AND/OR TWINE OCCURS - TREE STAYS PLUMB AND REMOVE FROM THE PLANTING PIT. AVOID CUTTING OR SCARING ROOTS. ANY ROOTS THAT ARE SCARED OR BROKEN DURING PLANTING SHALL BE PRUNED AT 90° FINISH GRADE BACKFILL PLANTING PIT WITH NATIVE SOIL-EXCEPT WHEN IN HEAVY CLAY, MIX AMENDED TOPSOIL FROM A LOCAL SOURCE WITH NATIVE SOIL -EXCAVATE PLANTING PIT TO A DEPTH EQUAL TO THE DEPTH OF THE ROOTBALL MINUS 3" AND A MINIMUM TWICE THE DIAMETER OF THE ROOTBALL DIA ROOTBALL. PLACE ROOTBALL ON UNDISTURBED SOIL AND ENSURE TRUNK OF 2X ROOTBALL DIA TREE IS PLUMB

MULTI-STEM TREE PLANTING

PLANTING NOTES

- 1. COORDINATE LOCATION OF ALL UTILITIES (LINES, DUCTS, CONDUITS, SLEEVES, FOOTINGS, ETC.) WITH LOCATIONS OF PROPOSED LANDSCAPE ELEMENTS (FENCE, FOOTINGS, TREE ROOTBALLS, ETC.). CONTRACTOR SHALL REPORT ANY DISCREPANCIES TO OWNER'S REPRESENTATIVE PRIOR TO CONTINUING WORK.
- 2. SAVE AND PROTECT ALL EXISTING TREES NOT NOTED TO BE REMOVED. REMOVE ALL CONSTRUCTION DEBRIS AND MATERIALS INJURIOUS TO PLANT GROWTH
- FROM PLANTING PITS AND BEDS PRIOR TO BACKFILLING WITH PLANTING MIX.
- 4. REFER TO SPECIFICATIONS FOR TOPSOIL REQUIREMENTS. 5. REFER TO PLANTING AND SITE DETAILS FOR AMENDED SOIL DEPTH IN PLANTING BEDS AND SURROUNDING TREES. REFER TO SPECIFICATIONS FOR MIX TYPE.
- 6. FIELD STAKE PLANTINGS ACCORDING TO PLAN. OWNER'S REPRESENTATIVE SHALL APPROVE ALL PLANT LOCATIONS PRIOR TO INSTALLATION. OWNER'S REPRESENTATIVE RESERVES THE RIGHT TO REVISE PLANTING LAYOUT AT TIME OF
- 7. ALL PLANT MATERIALS SHALL BE TRUE TO THEIR SCIENTIFIC NAME AND SIZE AS INDICATED IN THE PLANT SCHEDULE.
- 8. IF DISCREPANCIES EXIST BETWEEN THE NUMBER OF PLANTS DRAWN ON THE PLANTING PLAN AND THE NUMBER OF PLANTS IN THE SCHEDULE, THE PLANTING PLAN
- 9. ANY PROPOSED SUBSTITUTIONS OF PLANT SPECIES SHALL BE MADE WITH PLANTS OF EQUIVALENT OVERALL FORM, HEIGHT, BRANCHING HABIT, FLOWER, LEAF, COLOR, FRUIT AND CULTURE, AND ONLY AFTER WRITTEN APPROVAL OF THE OWNER'S REPRESENTATIVE.
- STOCK (ANSI Z60.1), LATEST EDITION PUBLISHED BY THE AMERICAN ASSOCIATION OF NURSERYMEN, WASHINGTON D.C. LARGER SIZED PLANT MATERIALS OF THE SPECIES LISTED MAY BE USED IF THE STOCK CONFORMS TO ANSI Z60.1. 11. ALL PLANT MATERIAL SHALL BE GUARANTEED BY THE CONTRACTOR TO BE IN A LIVE

10. ALL PLANT MATERIALS MUST CONFORM TO AMERICAN STANDARDS FOR NURSERY

- AND HEALTHY GROWING CONDITION FOR ONE FULL GROWING SEASON (ONE YEAR) AFTER FINAL PROJECT ACCEPTANCE OR SHALL BE REPLACED BY THE CONTRACTOR FREE OF CHARGE WITH THE SAME GRADE AND SPECIES.
- 12. ALL TREES SHALL HAVE A STRONG CENTRAL LEADER. ANY TREES DEEMED NOT TO HAVE A STRONG CENTRAL LEADER SHALL BE REJECTED. 13. CONTRACTOR IS RESPONSIBLE FOR ALL DAMAGE DUE TO CONSTRUCTION
- OPERATIONS. ANY AREAS THAT ARE DISTURBED SHALL BE RESTORED TO ITS ORIGINAL CONDITION AT NO ADDITIONAL COST TO THE OWNER. 14. PROVIDE SHREDDED HARDWOOD MULCH SURROUNDING ALL PROPOSED TREES (5' Ø)
- AND WITHIN PLANTING BEDS TO A 3" MINIMUM DEPTH AS SHOWN IN TREE PLANTING DETAIL. DO NOT USE AN UNDERLAYMENT SUCH AS PLASTIC SHEET OR LANDSCAPE FABRIC. APPLY PRE-EMERGENT TO ALL PLANTING BEDS PRIOR TO MULCHING. REFER TO PLANS FOR ADDITIONAL DETAILS. REFER TO STORMWATER DETAILS FOR BASIN CONSTRUCTION AND MULCH APPLICATION.
- 18. MULCHING MATERIAL SHALL BE SHREDDED HARDWOOD MULCH, WITH NO INDIVIDUAL PIECES LARGER THAN 3", FREE OF GROWTH OR GERMINATION INHIBITING INGREDIENTS, 3" MINIMUM DEPTH. MINIMUM DEPTHS AT LOCATIONS INDICATED ON DRAWINGS.
- 19. CONTRACTOR SHALL PROVIDE SAMPLE OF MULCH TO BE APPROVED BY THE LANDSCAPE ARCHITECT.
- 20. INDICATED QUANTITIES ARE ESTIMATES AND SHALL BE CONFIRMED BY THE CONTRACTOR.

IRRIGATION NOTES

CARE IN EXCAVATING AND WORKING NEAR UTILITIES. DAMAGE DONE TO UTILITIES, STRUCTURES, OR OTHER FINISHED WORK SHALL BE REPAIRED OR REPLACED AT

8. IRRIGATION CONTRACTOR TO FIELD ADJUST DRIP LINE LOCATIONS SO AS TO AVOID

INSTALL ALL MAINLINES TO SLOPE AT 1% MINIMUM TO MANUAL DRAIN VALVES

9. THE CONTRACTOR SHALL PLACE A #12 SOLID COPPER TRACE WIRE WITH PURPLE PE

10. THE IRRIGATION CONTRACTOR SHALL COORDINATE WITH GENERAL CONTRACTOR

IRRIGATION CONTRACTOR SHALL INSTALL DRIP IRRIGATION SYSTEM FOR ALL

PLANTING AREAS. CONTRACTOR TO SUBMIT IRRIGATION PLAN AND PRODUCT

7. CONTRACTOR TO INSTALL NEW TORO CUSTOM COMMAND SERIES / HUNTER ACC-D /

RAIN BIRD ESP-LXIVM CONTROLLER WITH STAINLESS STEEL PEDESTAL MOUNT.

CONTROL VALVES FROM ONE MANUFACTURER. CONTRACTOR TO VERIFY 110V

8. PROTECT AT ALL TIMES THE WORK FROM DAMAGE AND THEFT. REPLACE ALL DAMAGED OR STOLEN PARTS AT CONTRACTOR'S EXPENSE UNTIL THE WORK IS

SOURCE IRRIGATION CONTROLLER, RAIN / FREEZE SENSOR, QUICK COUPLERS, AND

UNINTERRUPTED ELECTRICAL SERVICE FOR THE CONTROLLER. CONTRACTOR TO

INSTALL VALVE BOX LOCATIONS IN PLANTING AREAS, PARALLEL TO AND SET BACK

INFORMATION TO LANDSCAPE ARCHITECT FOR REVIEW AND APPROVAL PRIOR TO

COVER FOR WATER ALONG ALL PVC MAINLINE. THIS INCLUDES ALL PVC MAINLINE

INSTALL A BACKFLOW PREVENTER AND ENCLOSURE AT THE POINT OF CONNECTION. INSTALL PER MANUFACTURER SPECIFICATIONS. COORDINATE WITH LOCAL CITY ORDINANCES TO ENSURE THE POINT OF CONNECTION MEETS ALL CODES.

LOCATED AT LOW POINTS OR AS INDICATED ON PLANS OF MAINLINE SYSTEM.

7. INSTALL PVC SCHEDULE 40 PIPE SLEEVES UNDER HARDSCAPE AT ALL POINTS

IRRIGATION CONTRACTOR SHALL BE RESPONSIBLE FOR THE LOCATION AND VERIFICATION OF ALL EXISTING UTILITIES AND STRUCTURES. EXERCISE EXTREME

THE IRRIGATION CONTRACTORS EXPENSE.

CONNECTING QUICK COUPLER VALVES.

CONFLICTS WITH TREES, SITE FURNITURE, AND UTILITIES.

WHERE IRRIGATION MAIN LINE AND LATERALS ARE LOCATED.

TO INSURE THE POINT OF CONNECTION IS PROVIDED PER PLANS.

INSTALL CONTROLLER PER MANUFACTURER'S SPECIFICATIONS.

FROM PAVEMENT EDGES AS INDICATED ON THE PLANS.

ACCEPTED IN WRITING BY THE OWNER'S REPRESENTATIVE.

21. ADJUST SPACING OF PLANT MATERIALS AROUND ADJACENT UTILITY STRUCTURES.

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PROJECT

CITY OF LA CROSSE

PEARL WALKWAY IMPROVEMENTS

LA CROSSE

	F	REVISION SCHEDULE	
DATE		DESCRIPTION	BY
PROJEC [°]	T NO.	22-24807	

FILE NAME 24807 C5-LAND DRAWN BY GBV **DESIGNED BY REVIEWED BY**

ORIGINAL ISSUE DATE 05/26/22

CLIENT PROJECT NO.

TITLE

PLANTING DETAILS

C5-40

-SHRUBS TO BE INSTALLED SO THAT THE TOP OF THE CROWN OF THE PLANT IS ABOVE FINISH GRADE 3" -CUT AND REMOVE AT MINIMUM THE TOP HALF

OR ENTIRE CONTAINER, AND REMOVE FROM THE PLANTING PIT, SCARIFY ROOTS FOR ALL CONTAINER PLANTS #5 GALLON OR SMALLER

CONTAINER. PLACE ROOTBALL ON

UNDISTURBED SOIL AND ENSURE PLANT IS

SHRUB PLANTING

2X ROOTBALL DIA

2X CONTAINER DIA

OF WIRE BASKETS, BURLAP AND/OR TWINE, −3" LAYER OF SHREDDED HARDWOOD MULCH -BACKFILL PLANTING PIT WITH NATIVE SOIL-EXCEPT WHEN IN HEAVY CLAY, MIX AMENDED TOPSOIL FROM A LOCAL SOURCE WITH NATIVE SOIL -EXCAVATE PLANTING PIT TO A DEPTH EQUAL TO THE DEPTH OF THE ROOTBALL OR CONTAINER MINUS 3" AND A MINIMUM TWICE THE DIAMETER OF THE ROOTBALL OR **CONTAINER DIA** ROOTBALL DIA