TABLE OF CONTENTS



CONTACT INFORMATION

Kristine Giornalista

Vice President, Real Estate Development Impact Seven

PH | 608.514.2108 EMAIL | kristine.giornalista@impactseven.org

Michael Carlson

Director, Real Estate Development Impact Seven

PH | 608.405.9064 EMAIL | michael.carlson@impactseven.org

ARCHITECTURAL SITE PLAN + SITE IMAGES	A001
SITE DATA	CO-10
EROSION CONTROL PLAN (EXISITING CONDITIONS)	C1-10
EROSION CONTROL PLAN (PROPOSED CONDITIONS)	C1-20
EXISTING SITE & REMOVAL PLAN	C2-10
PROPOSED SITE PLAN	C3-10
UTILITY PLAN	C3-30
GRADING PLAN	C4-10
PLANTING PLAN	C5-20
PLANTING NOTES & DETAILS	C5-22
LIGHTING PLAN	A003
SCHEDULED FIXTURES	A004
TOWNHOMES OVERALL FLOOR PLANS	A100
TOWNHOMES BUILDING ELEVATIONS	A400
TOWNHOMES - STREET FACING FACADES STUDY	A402
COMMUNITY CENTER FLOOR PLANS	A100
COMMUNITY CENTER BUILDING ELEVATIONS	A401
COMMUNITY CENTER - STREET FACING FACADES STUDY	A402

Garden Terrace – Townhomes & Community Center LA CROSSE, WISCONSIN









PROJECT NUMBER

Rice Lake, WI 54868

ISSUED FOR:

CITY REVIEW SET 12-01-2017

REVISION FOR: NO. DESCRIPTION


DATE

DRAWN BY

CHECKED BY

ARCHITECTURAL SITE PLAN & SITE PHOTOS


A001

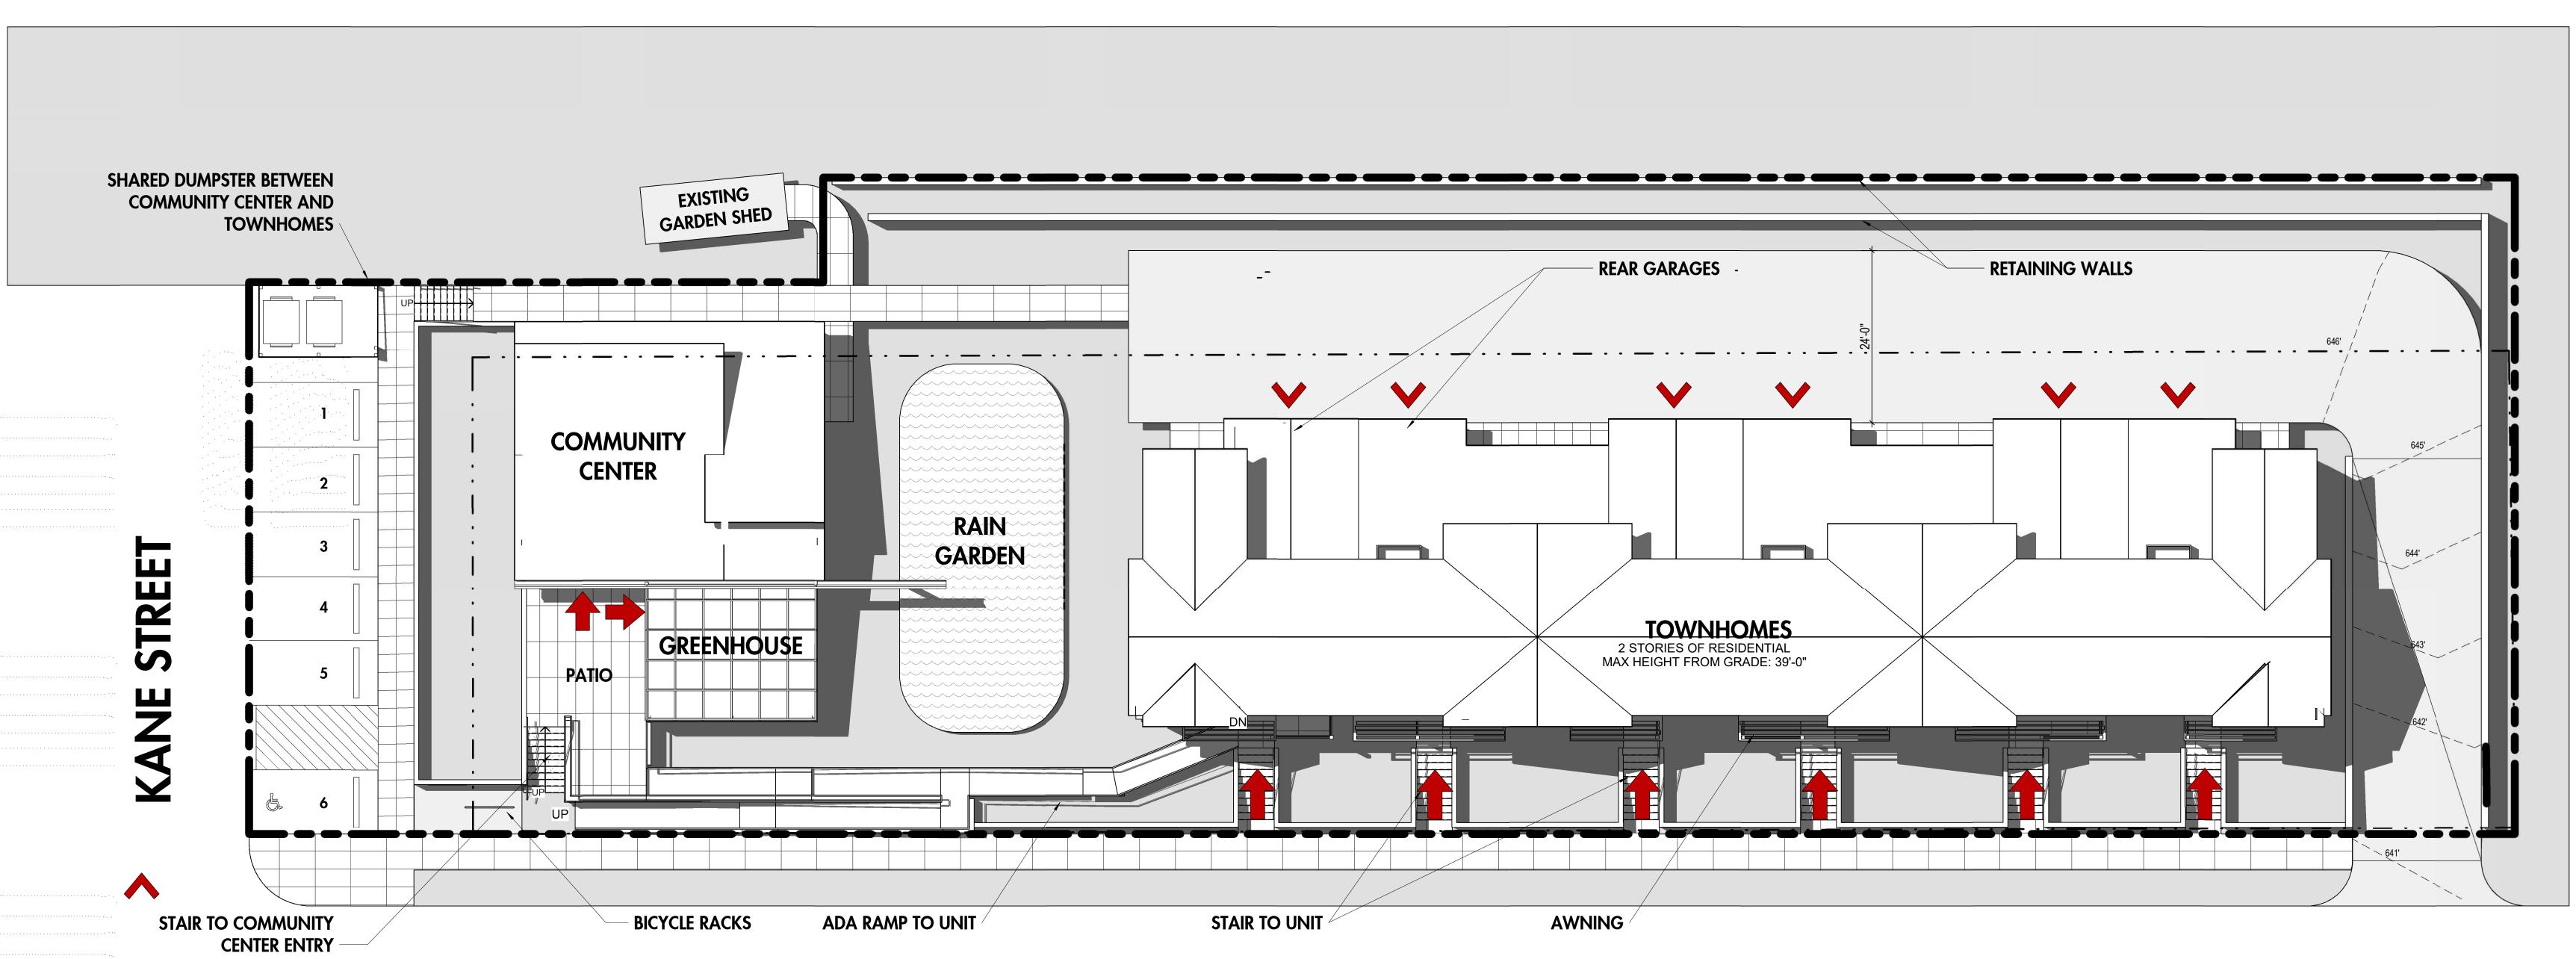

ST JAMES ST





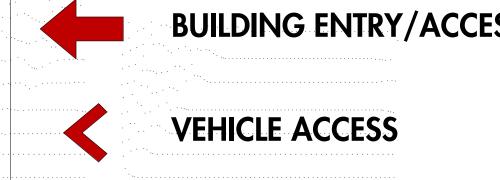















LOCATION MAP

PROJECT ADDRESS / LOCATION: ST JAMES STREET **LA CROSSE, WI 54603**

SECTION/TOWNSHIP/RANGE SEC 29 / TWP 16 / R 7

LA CROSSE, WISCONSIN

PROJECT GENERAL NOTES

ALL WORK SHALL CONFORM TO THE CONTRACT DOCUMENTS, WHICH INCLUDE, BUT ARE NOT LIMITED TO, THE OWNER - CONTRACTOR AGREEMENT, THE PROJECT MANUAL (WHICH INCLUDES GENERAL SUPPLEMENTARY CONDITIONS AND SPECIFICATIONS), DRAWINGS OF ALL DISCIPLINES AND ALL ADDENDA, MODIFICATIONS AND CLARIFICATIONS

2. CONTRACT DOCUMENTS SHALL BE ISSUED TO ALL SUBCONTRACTORS BY THE GENERAL CONTRACTOR IN COMPLETE SETS IN ORDER TO ACHIEVE THE FULL EXTENT AND COMPLETE COORDINATION OF ALL WORK.

3. WRITTEN DIMENSIONS TAKE PRECEDENCE OVER SCALED DIMENSIONS. NOTIFY ARCHITECT/ENGINEER OF ANY DISCREPANCIES OR CONDITIONS REQUIRING INFORMATION OR CLARIFICATION BEFORE PROCEEDING WITH THE WORK.

4. FIELD VERIFY ALL EXISTING CONDITIONS AND DIMENSIONS. NOTIFY ARCHITECT/ENGINEER OF ANY DISCREPANCIES OR CONDITIONS REQUIRING INFORMATION OR CLARIFICATION BEFORE PROCEEDING WITH THE WORK.

5. DETAILS SHOWN ARE INTENDED TO BE INDICATIVE OF THE PROFILES AND TYPE OF DETAILING REQUIRED THROUGHOUT THE WORK. DETAILS NOT SHOWN ARE SIMILAR IN CHARACTER TO DETAILS SHOWN. WHERE SPECIFIC DIMENSIONS, DETAILS OR DESIGN INTENT CANNOT BE DETERMINED, NOTIFY ARCHITECT/ENGINEER BEFORE PROCEEDING WITH THE WORK.

6. ALL MANUFACTURED ARTICLES, MATERIALS AND EQUIPMENT SHALL BE APPLIED, INSTALLED, CONNECTED, ERECTED, CLEANED AND CONDITIONED ACCORDING TO MANUFACTURERS' INSTRUCTIONS. IN CASE OF DISCREPANCIES BETWEEN MANUFACTURERS' INSTRUCTIONS AND THE CONTRACT DOCUMENTS, NOTIFY ARCHITECT/ENGINEER BEFORE PROCEEDING WITH THE WORK.

7. ALL DISSIMILAR METALS SHALL BE EFFECTIVELY ISOLATED FROM EACH OTHER TO AVOID GALVANIC CORROSION.

8. THE LOCATION AND TYPE OF ALL INPLACE UTILITIES SHOWN ON THE PLANS ARE FOR GENERAL INFORMATION ONLY AND ARE ACCURATE AND COMPLETE TO THE BEST OF THE KNOWLEDGE OF I & S GROUP, INC. (ISG). NO WARRANTY OR GUARANTEE IS IMPLIED. THE CONTRACTOR SHALL VERIFY THE SIZES, LOCATIONS AND ELEVATIONS OF ALL INPLACE UTILITIES PRIOR TO CONSTRUCTION. CONTRACTOR SHALL IMMEDIATELY NOTIFY ENGINEER OF ANY DISCREPANCIES OR VARIATIONS FROM PLAN.

9. THE CONTRACTOR IS TO CONTACT "DIGGER'S HOTLINE" FOR UTILITY LOCATIONS, MINIMUM 3 BUSINESS DAYS PRIOR TO ANY EXCAVATION / CONSTRUCTION (811 OR



SPECIFICATIONS REFERENCE

ALL CONSTRUCTION SHALL COMPLY WITH THE CITY OF LA CROSSE STANDARD SPECIFICATIONS, CURRENT EDITION, WISDOT STANDARD SPECIFICATIONS, 2017 EDITION, WISDOT CONSTRUCTION AND MATERIALS MANUAL, CURRENT EDITION, WISCONSIN DEPARTMENT OF SAFETY AND PROFESSIONAL SERVICES STATE PLUMBING CODE, CURRENT EDITION, AND STANDARD SPECIFICATION FOR SEWER & WATER CONSTRUCTION IN WISCONSIN, 6th EDITION, UNLESS DIRECTED OTHERWISE.

PROJECT DATUM

HORIZONTAL COORDINATES HAVE BEEN REFERENCED TO THE NORTH AMERICAN DATUM OF 1983 (NAD83), 2011 ADJUSTMENT ON THE LA CROSSE COUNTY COORDINATE SYSTEM, IN U.S. SURVEY FEET.

TOPOGRAPHIC SURVEY

THIS PROJECT'S TOPOGRAPHIC SURVEY CONSISTS OF DATA COLLECTED ON 9/16, 1/17, &

B.M. ELEVATION=646.52

TOP NUT OF FIRE HYDRANT LOCATED ON THE NORTHEAST CORNER OF THE INTERSECTION OF ST JAMES ST AND GEORGE ST FRONTAGE RD

LEGEND

EXISTING	
	CITY LIMITS
	SECTION LINE
	QUARTER SECTION LINE
	RIGHT OF WAY LINE
	PROPERTY / LOTLINE
	EASEMENT LINE
ΔΔ	ACCESS CONTROL
	WATER EDGE
- — — WET — — -	WETLAND BOUNDARY
<u> 711 </u>	WETLAND / MARSH
XXXX	FENCE LINE
> <<<	CULVERT
	STORM SEWER
	SANITARY SEWER
	SANITARY SEWER FORCEMAIN
	WATER
——————————————————————————————————————	GAS
——————————————————————————————————————	OVERHEAD ELECTRIC
——————————————————————————————————————	UNDERGROUND ELECTRIC
——————————————————————————————————————	UNDERGROUND TELEPHONE
UTV	UNDERGROUND TV
	OVERHEAD UTILITY
——————————————————————————————————————	UNDERGROUND UTILITY
——————————————————————————————————————	UNDERGROUND FIBER OPTIC
990	CONTOUR (MAJOR)
— — <u> </u>	CONTOUR (MINOR)
$\{\cdot\}$	DECIDUOUS TREE
	CONIFEROUS TREE
	TREE LINE
0	MANHOLE/STRUCTURE
	CATCH BASIN
-6-	HYDRANT
\bowtie	VALVE
\otimes	CURB STOP
Ø	POWER POLE
	UTILITY PEDESTAL / CABINET

	PROPERTY BOUNDARY
	RIGHT OF WAY
	EASEMENT
~~~~	CULVERT
	STORM SEWER
	STORM SEWER (PIPE WIDT)
	SANITARY SEWER
	SANITARY SEWER (PIPE WII
I	WATER
G	GAS
OE	OVERHEAD ELECTRIC
———— UE————	UNDERGROUND ELECTRIC
UTV	UNDERGROUND TV
 1015 	CONTOUR
•	MANHOLE
	CATCH BASIN
+	HYDRANT
Н	VALVE

CIVIL SHEET INDEX

C1-10 EROSION CONTROL PLAN (EXISTING CONDITIONS)

C1-20 EROSION CONTROL PLAN (PROPOSED CONDITIONS)

C2-10 EXISTING SITE & REMOVAL PLAN

C3-10 PROPOSED SITE PLAN

C3-30 PROPOSED SITY UTILITY PLAN C4-10 OVERALL GRADING PLAN

C5-10 SITE RESTORATION PLAN

C5-21 PLANTING NOTES & DETAILS

MILWAUKEE | MADISON | TUSCON | CHICAGO

Garden Terrace -Townhomes

St James Street La Crosse, WI 54603

Impact Seven 2961 Decker Drive

Rice Lake, WI 54868

PROJECT NUMBER

ISSUED FOR: CITY REVIEW SET

REVISION FOR: NO. DESCRIPTION

VIDTH)

Sheet List Table


C0-10 SITE DATA

C3-20 PROPOSED SITE LAYOUT PLAN

C5-20 PLANTING PLAN

SITE DATA

C0-10

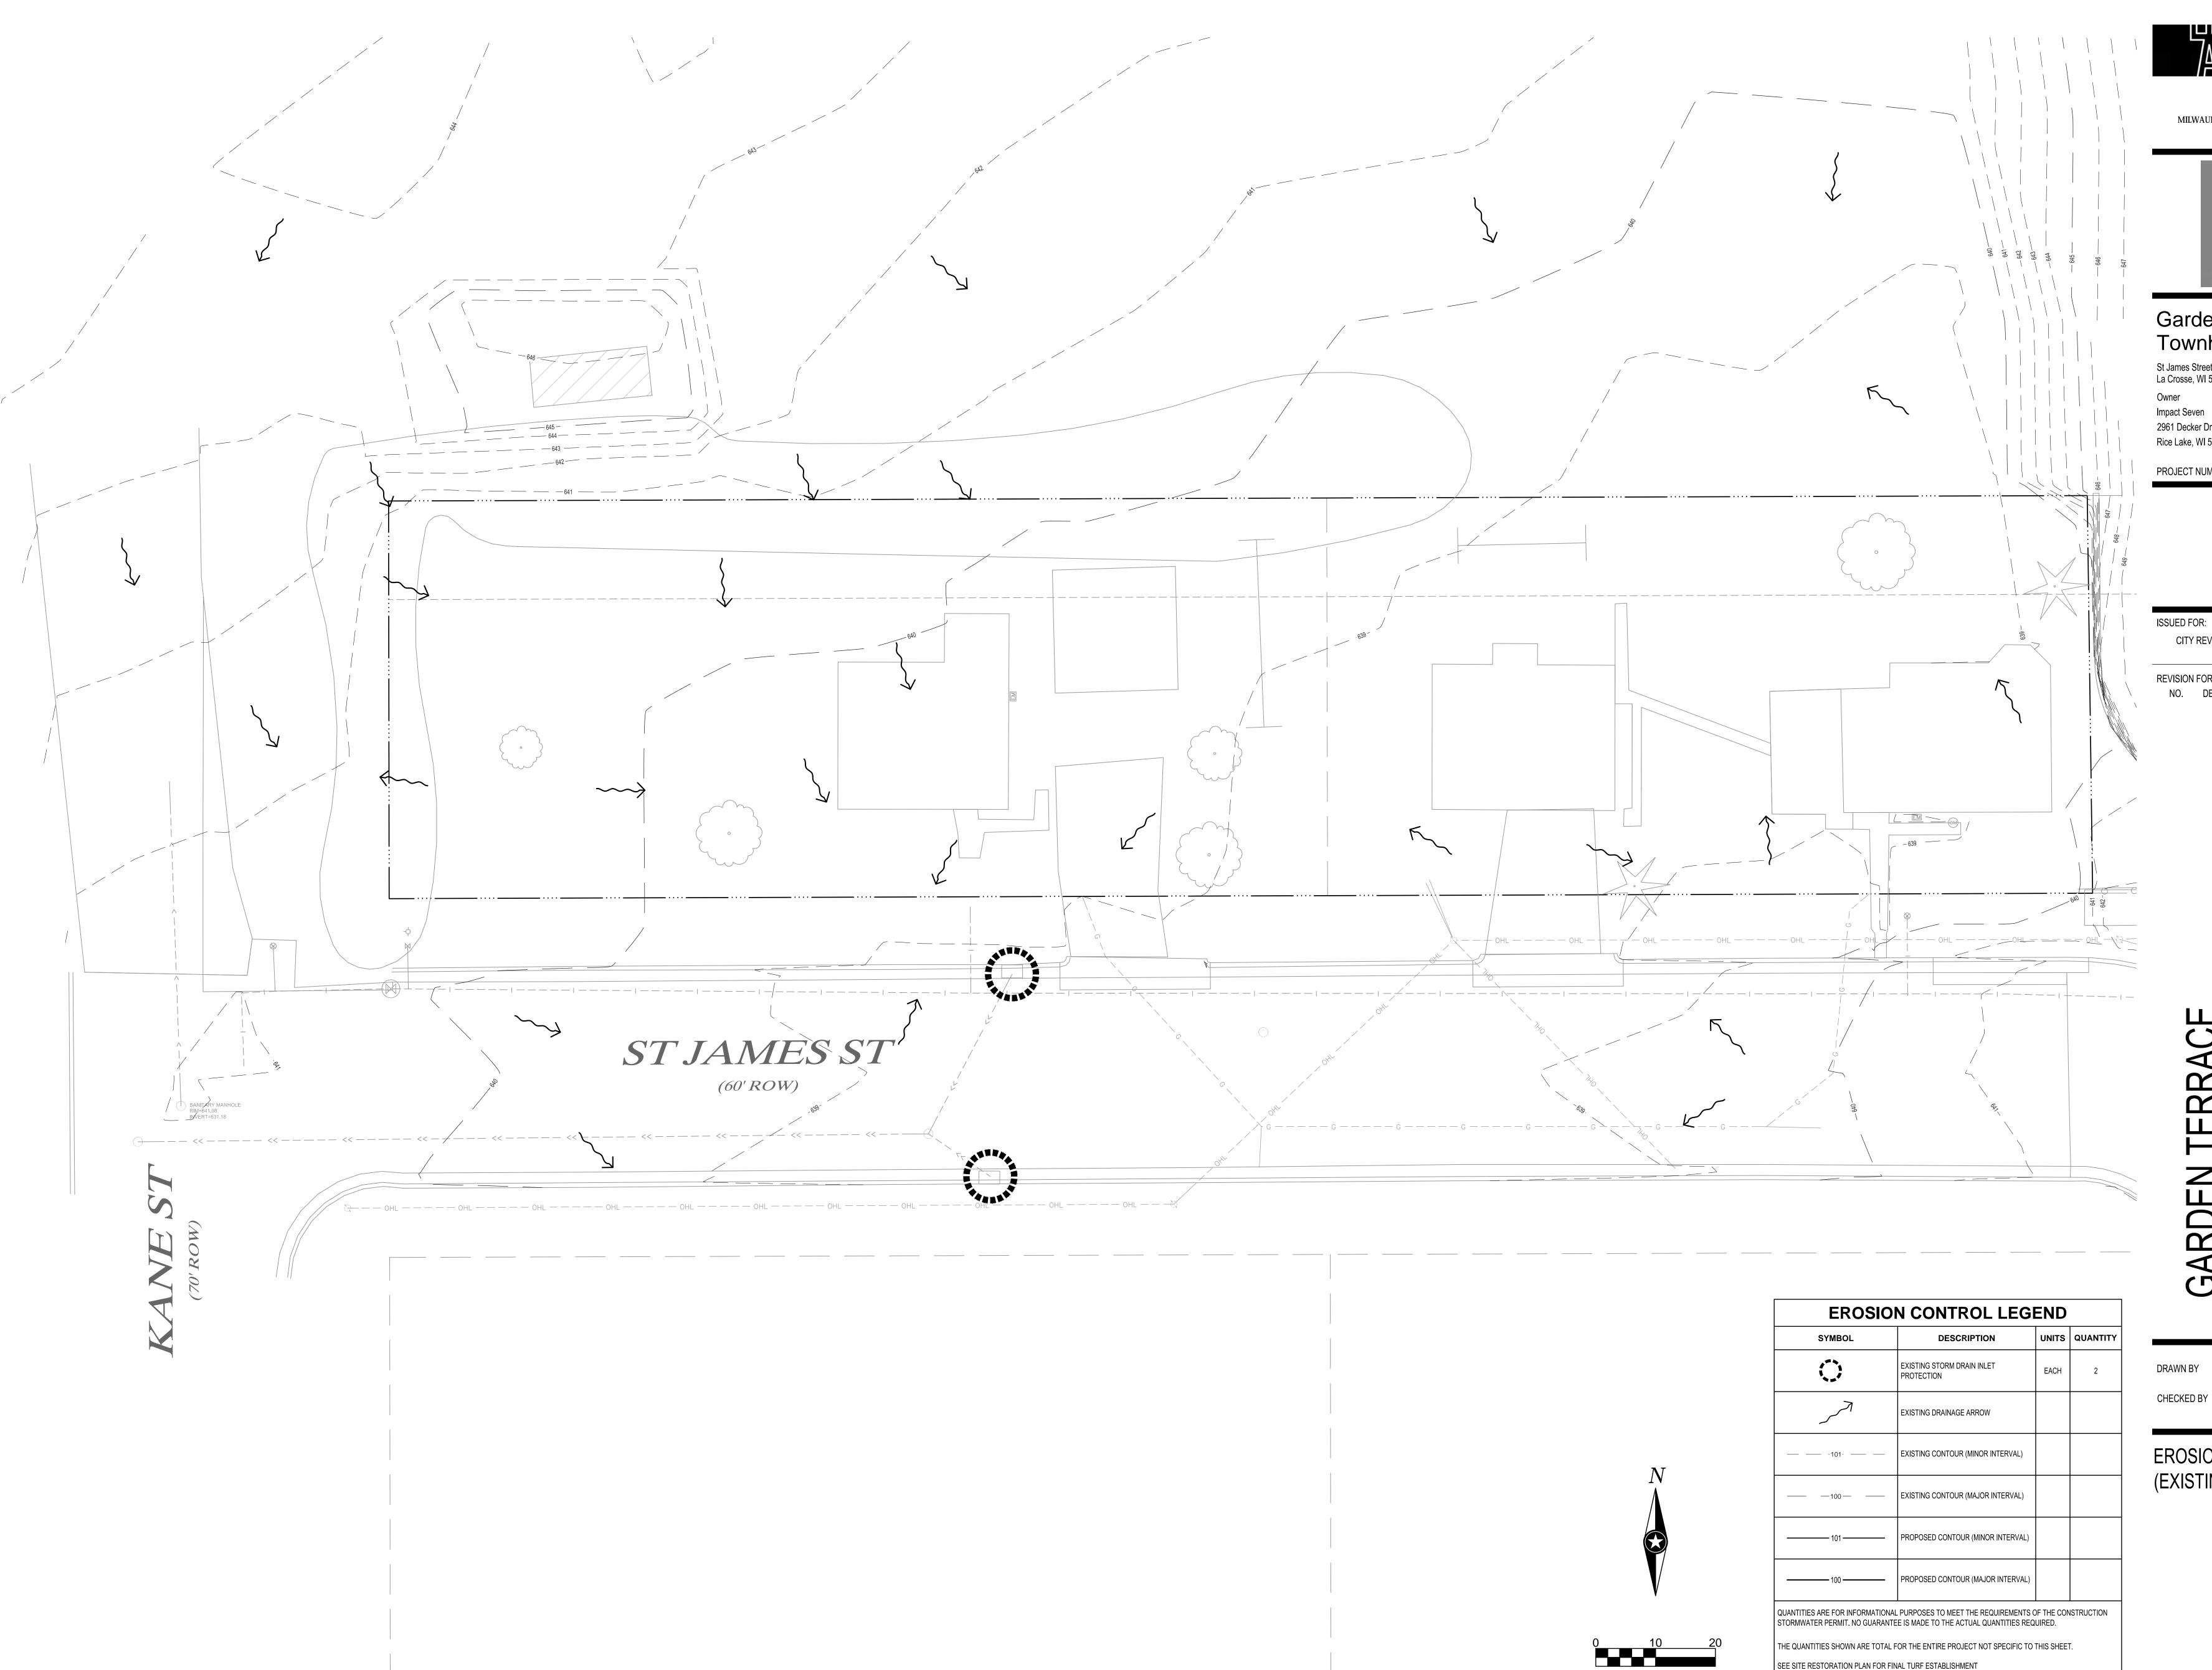



Garden Terrace -Townhomes

St James Street La Crosse, WI 54603

2961 Decker Drive

Rice Lake, WI 54868

PROJECT NUMBER

ISSUED FOR: CITY REVIEW SET

REVISION FOR: NO. DESCRIPTION

CHECKED BY


EROSION CONTROL PLAN (EXISTING CONDITIONS)

C1-10

SCALE IN FEET

NOTE: EROSION CONTROL PLAN COVERAGE INCLUDES ELECTRIC, GAS, TELEPHONE, AND CABLE INSTALLATION. EACH COMPANY OR THEIR SUBCONTRACTOR IS RESPONSIBLE TO FOLLOW THE REQUIREMENTS OF THIS EROSION CONTROL PLAN INCLUDING PROVIDING THEIR OWN RESTORATION IF INSTALLATION OCCURS AFTER PRIMARY INSTALLATION OF SEEDING/SODDING/MULCHING DURING

CONSTRUCTION OF EACH UTILITY.

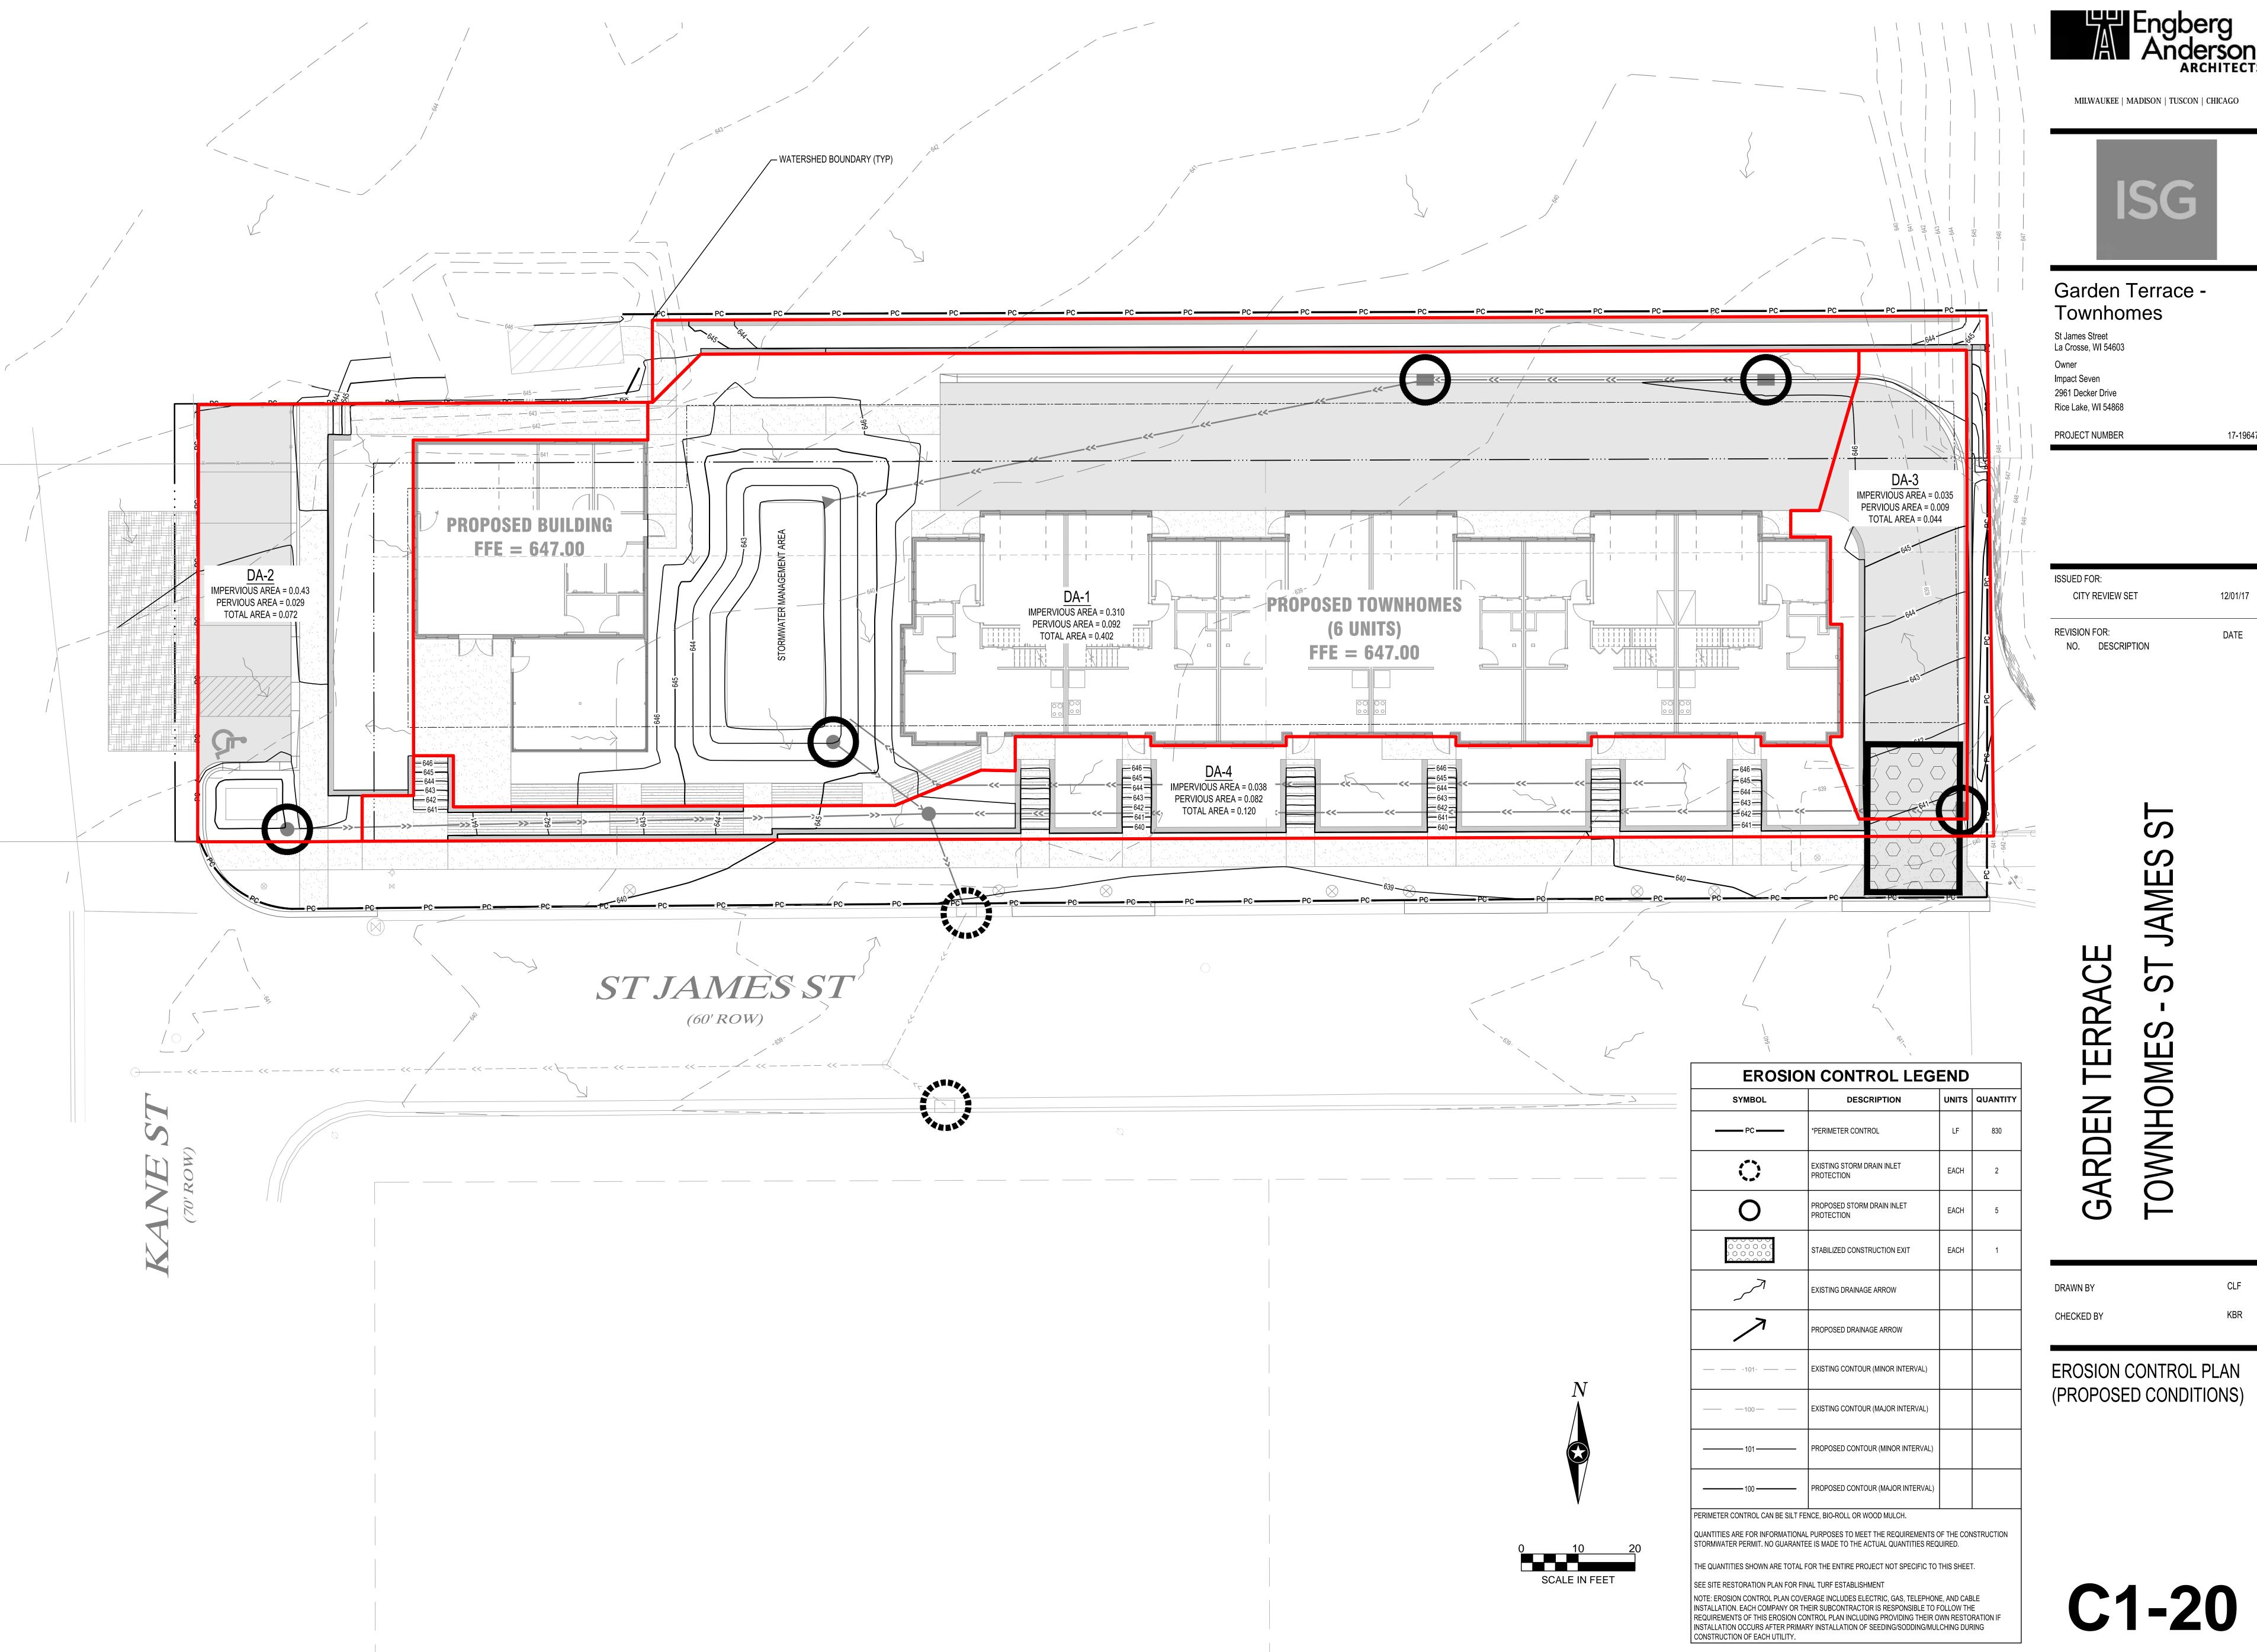

ISSUED FOR:	
CITY REVIEW SET	12/01/17





Garden Terrace -Townhomes

St James Street La Crosse, WI 54603

Impact Seven 2961 Decker Drive

Rice Lake, WI 54868

PROJECT NUMBER

NO. DESCRIPTION

ISSUED FOR:	
CITY REVIEW SET	12/01/17

TOWNHOME

DRAWN BY CHECKED BY

EXISTING SITE & REMOVAL PLAN

DESCRIPTION

REMOVE ASPHALT PAVEMENT

REMOVE CONCRETE

REMOVE CONCRETE

DEMOLISH BUILDING

CLEAR & GRUB TREES &

REMOVE DECIDUOUS TREE (CLEAR & GRUB)

REMOVE CONIFEROUS TREE (CLEAR & GRUB)

UNDERBRUSH

CONTRACTOR SHALL VERIFY EXISTING PAVEMENT SECTION AND NOTIFY ENGINEER OF ANY DISCREPANCIES.


PAVEMENT REMOVALS SHALL INCLUDE FULL DEPTH


SAWCUT & SECTION REMOVAL.

REMOVE GRAVEL SURFACE

PAVEMENT

C2-10

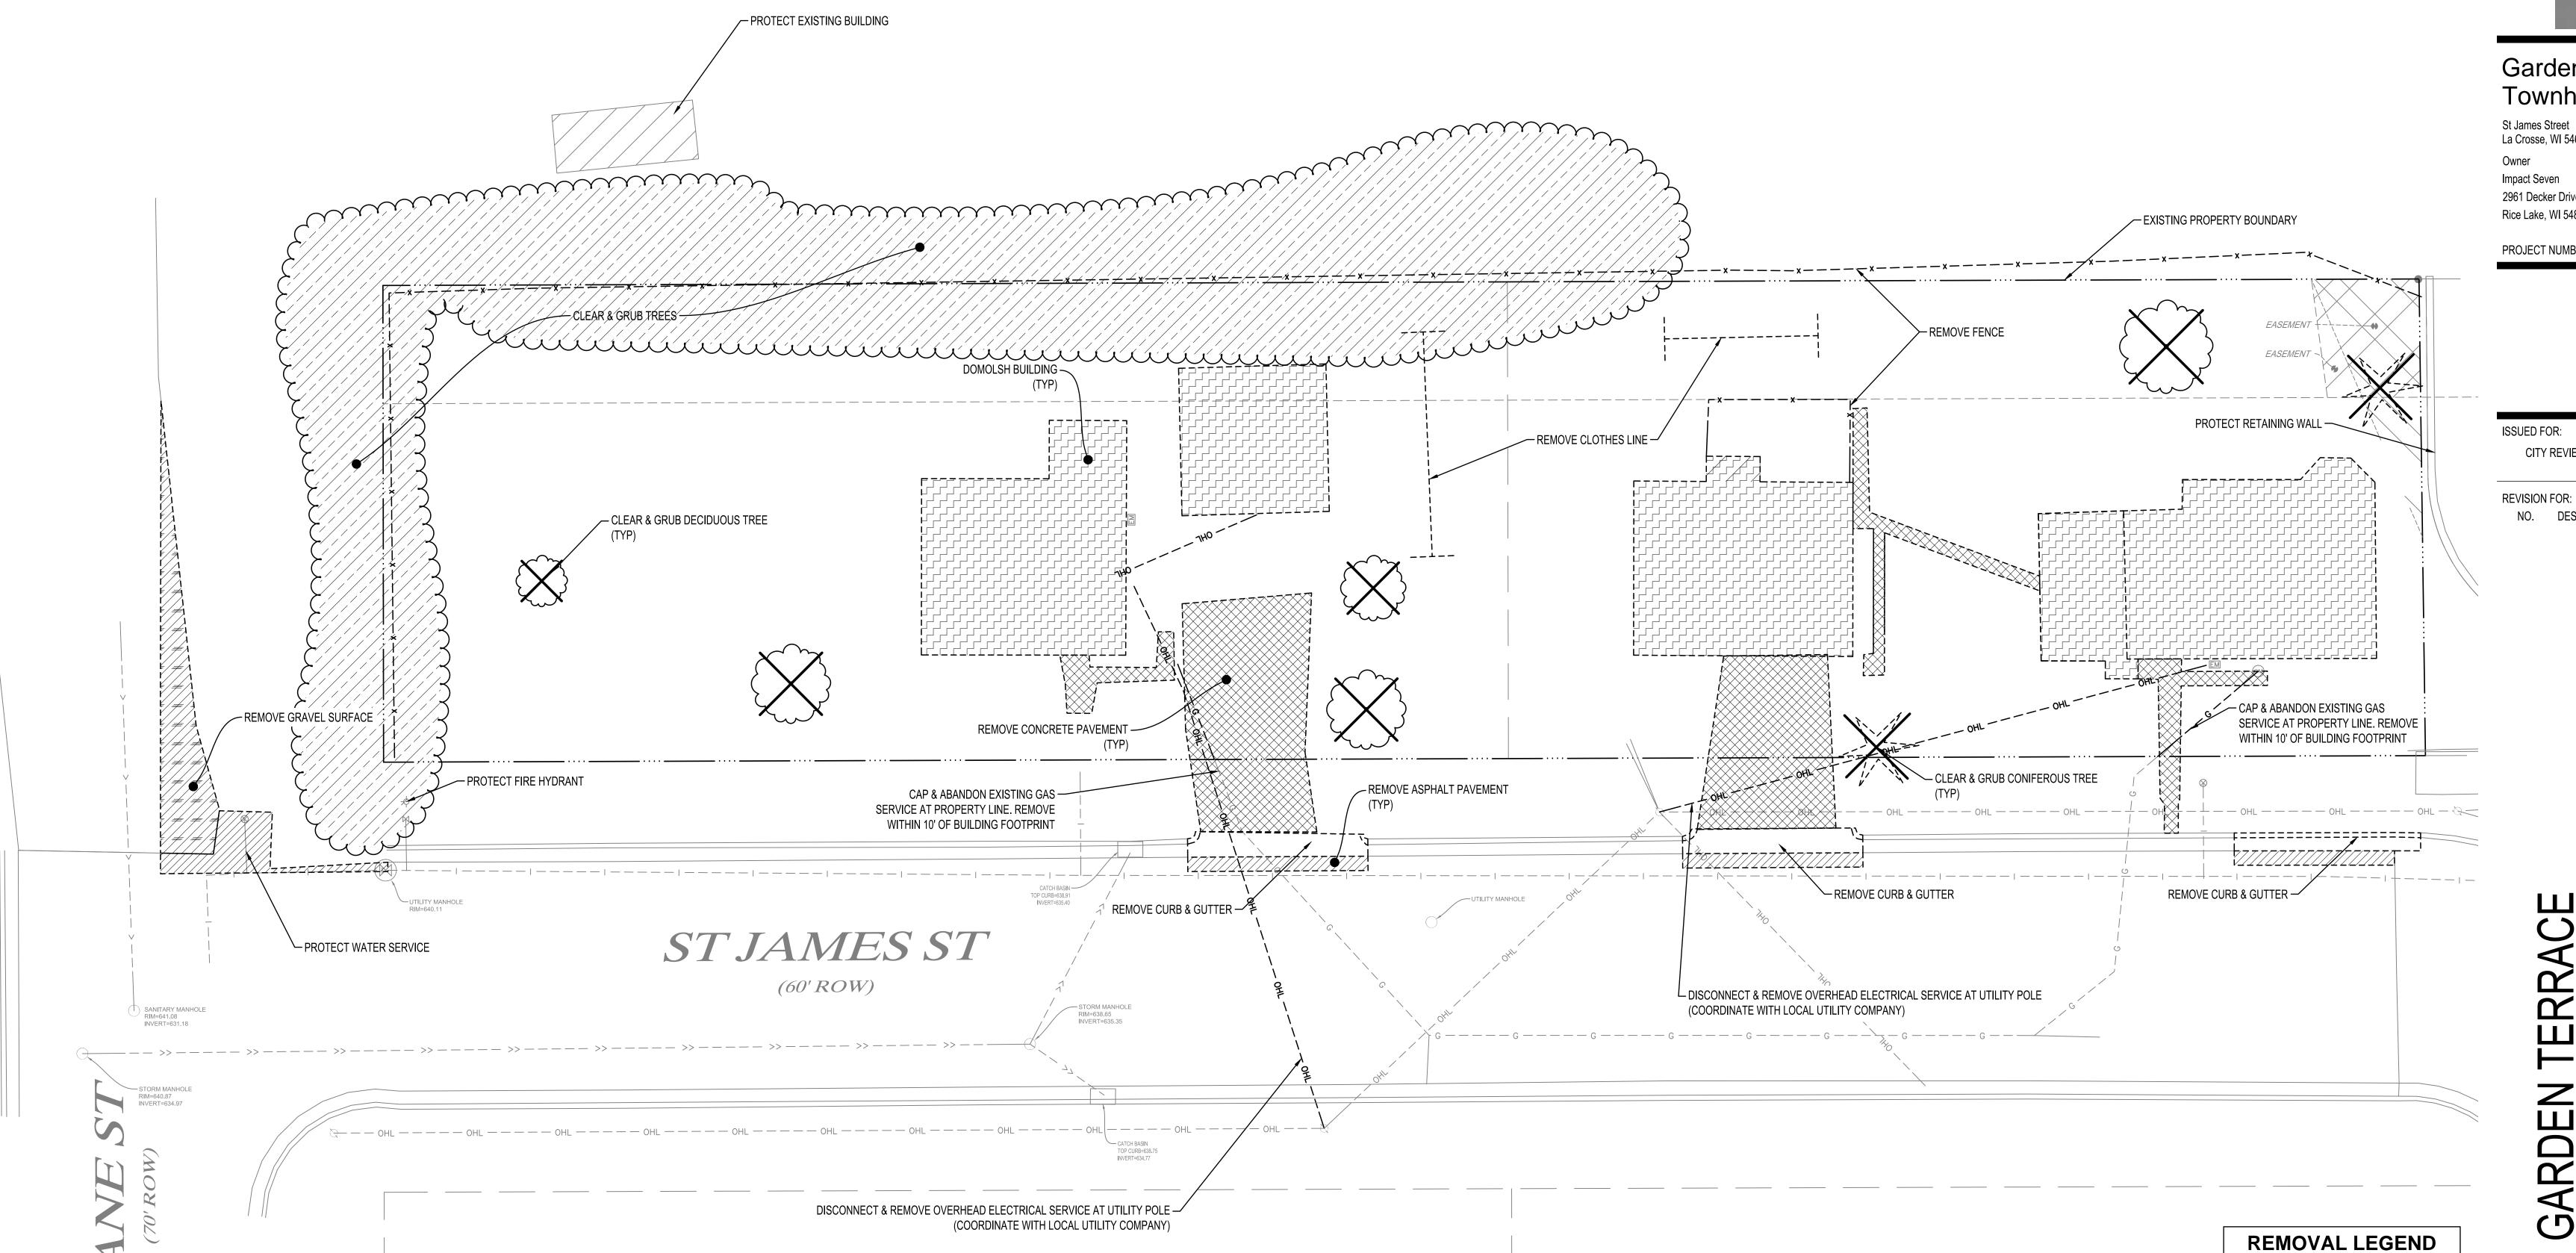

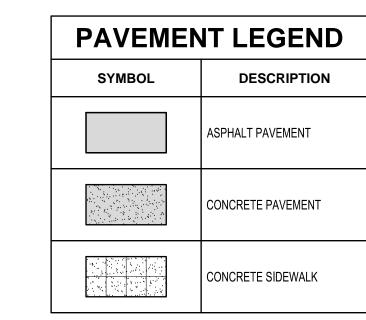







Garden Terrace -Townhomes

St James Street La Crosse, WI 54603

Owner Impact Seven

2961 Decker Drive Rice Lake, WI 54868


PROJECT NUMBER


ISSUED FOR: CITY REVIEW SET 12/01/17 **REVISION FOR:** DATE

> GARDEN TERRACE TOWNHOMES

CHECKED BY

PROPOSED SITE PLAN

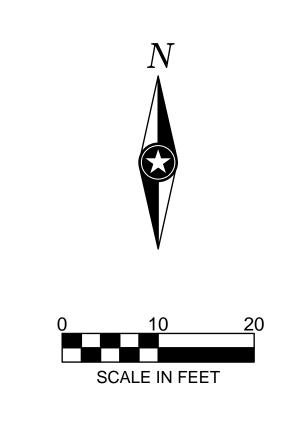

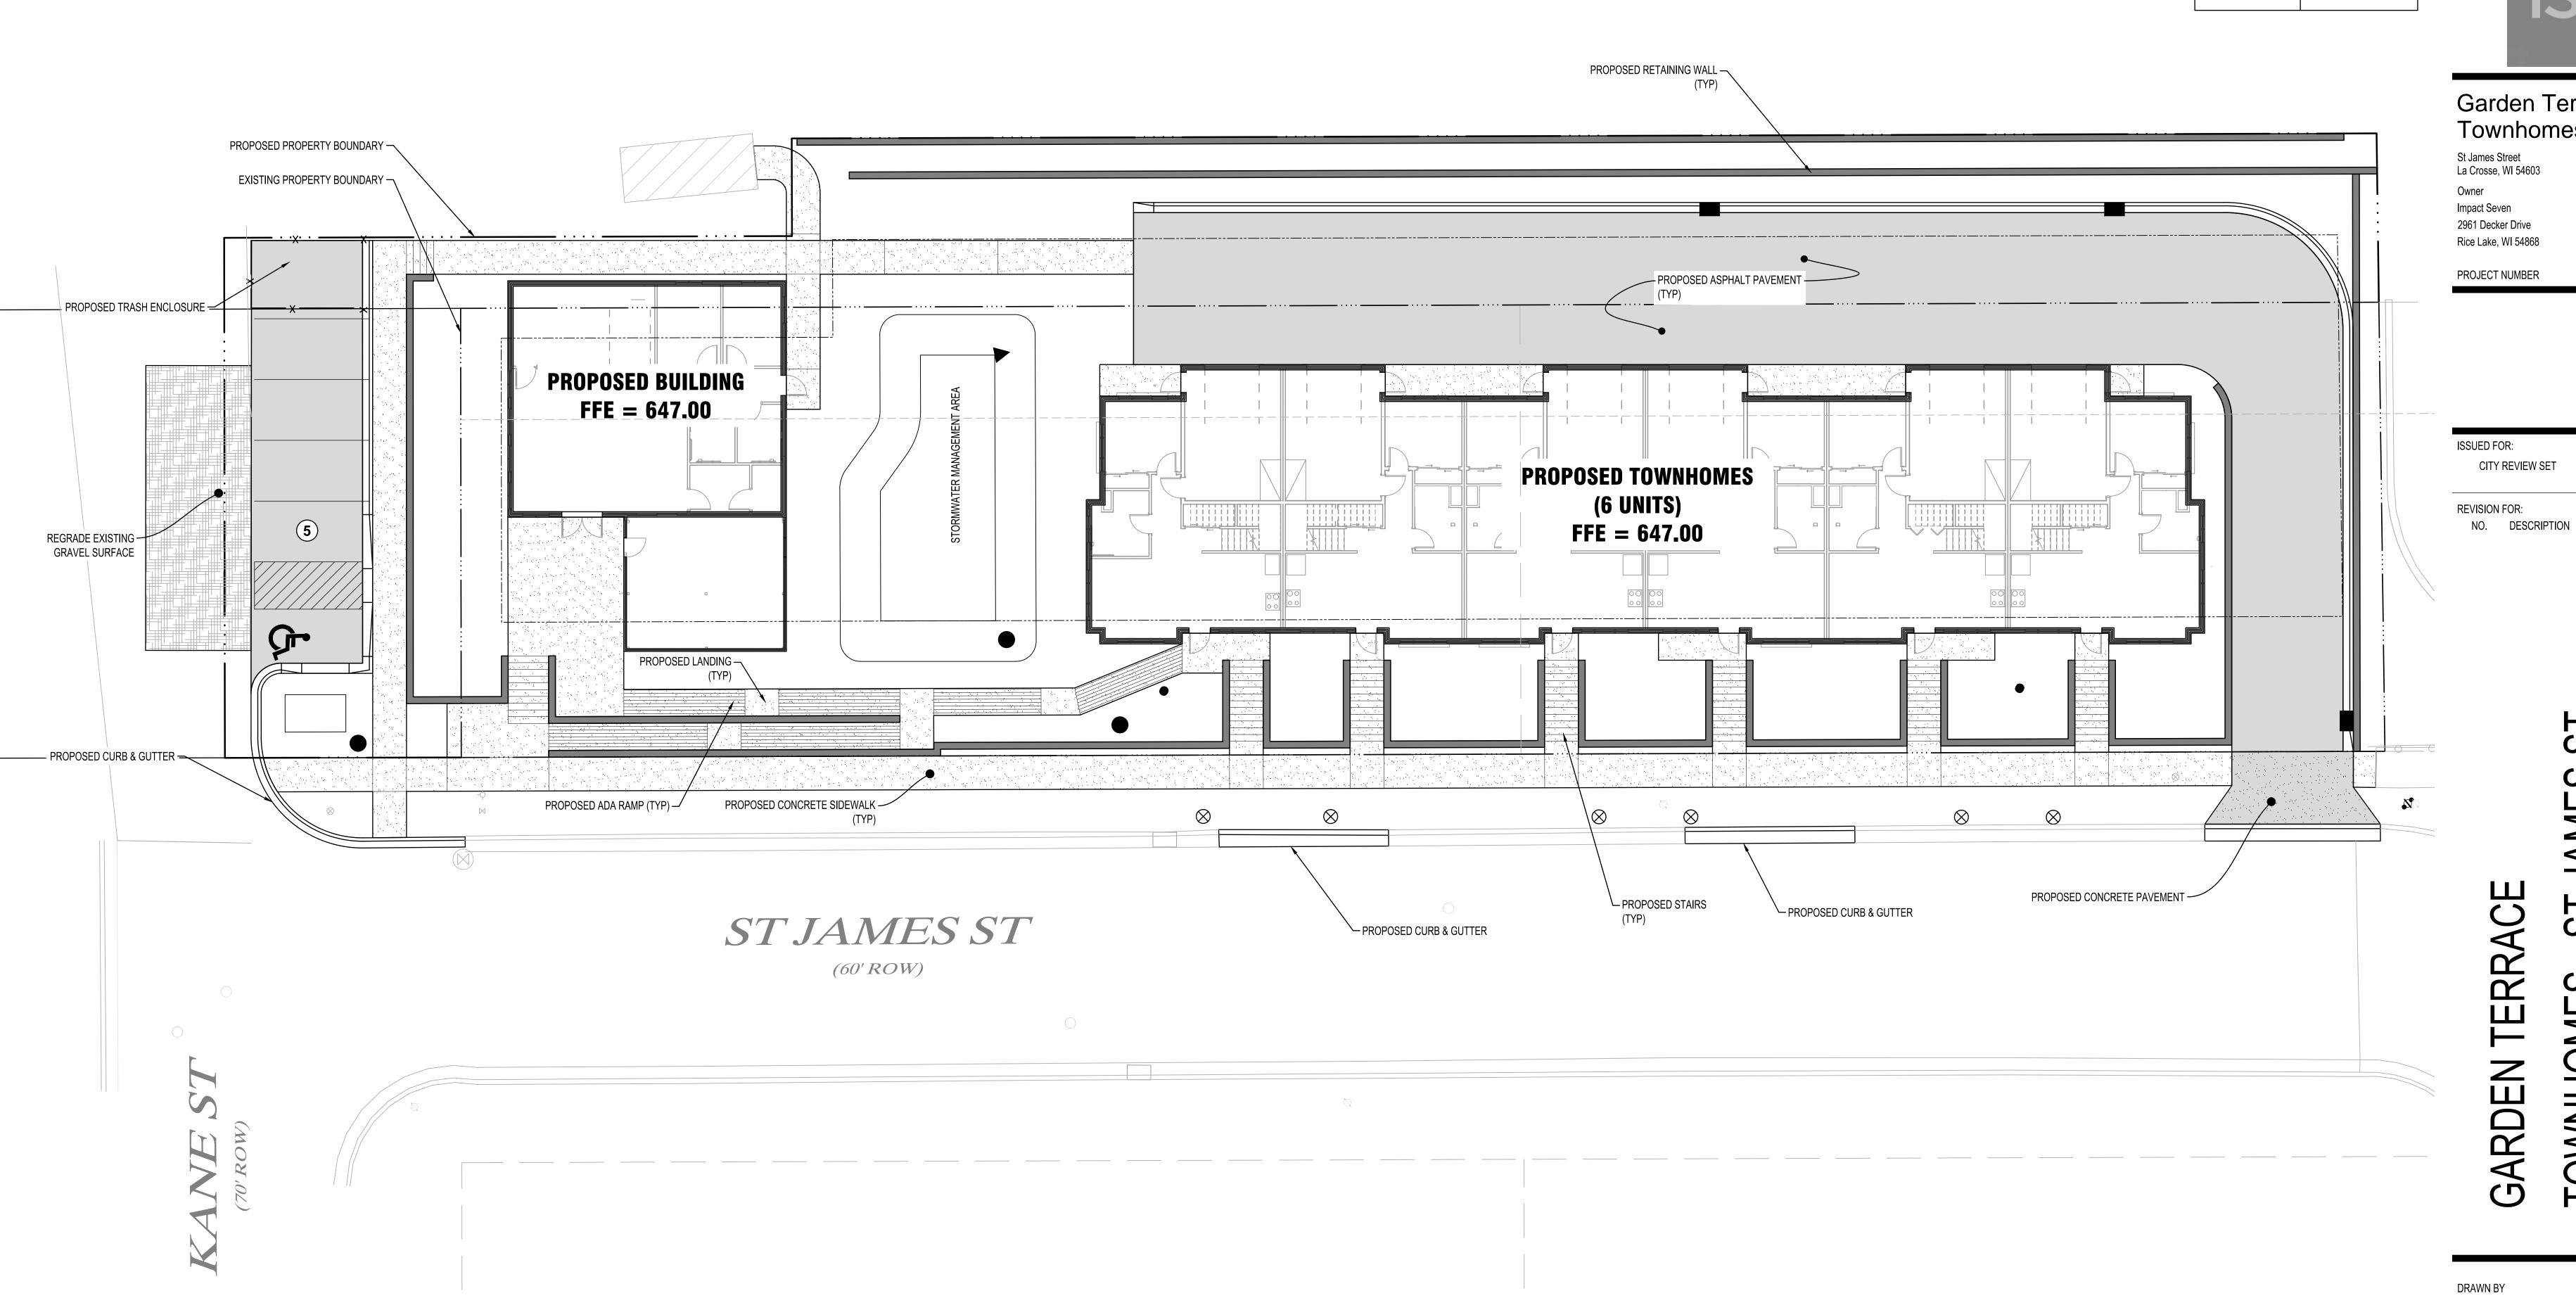





Garden Terrace -Townhomes

St James Street La Crosse, WI 54603

Impact Seven

2961 Decker Drive Rice Lake, WI 54868


ISSUED FOR: CITY REVIEW SET **REVISION FOR:**


DATE NO. DESCRIPTION

GARDEN TERRACE TOWNHOMES


CHECKED BY

PROPOSED SITE LAYOUT PLAN

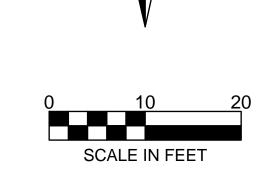

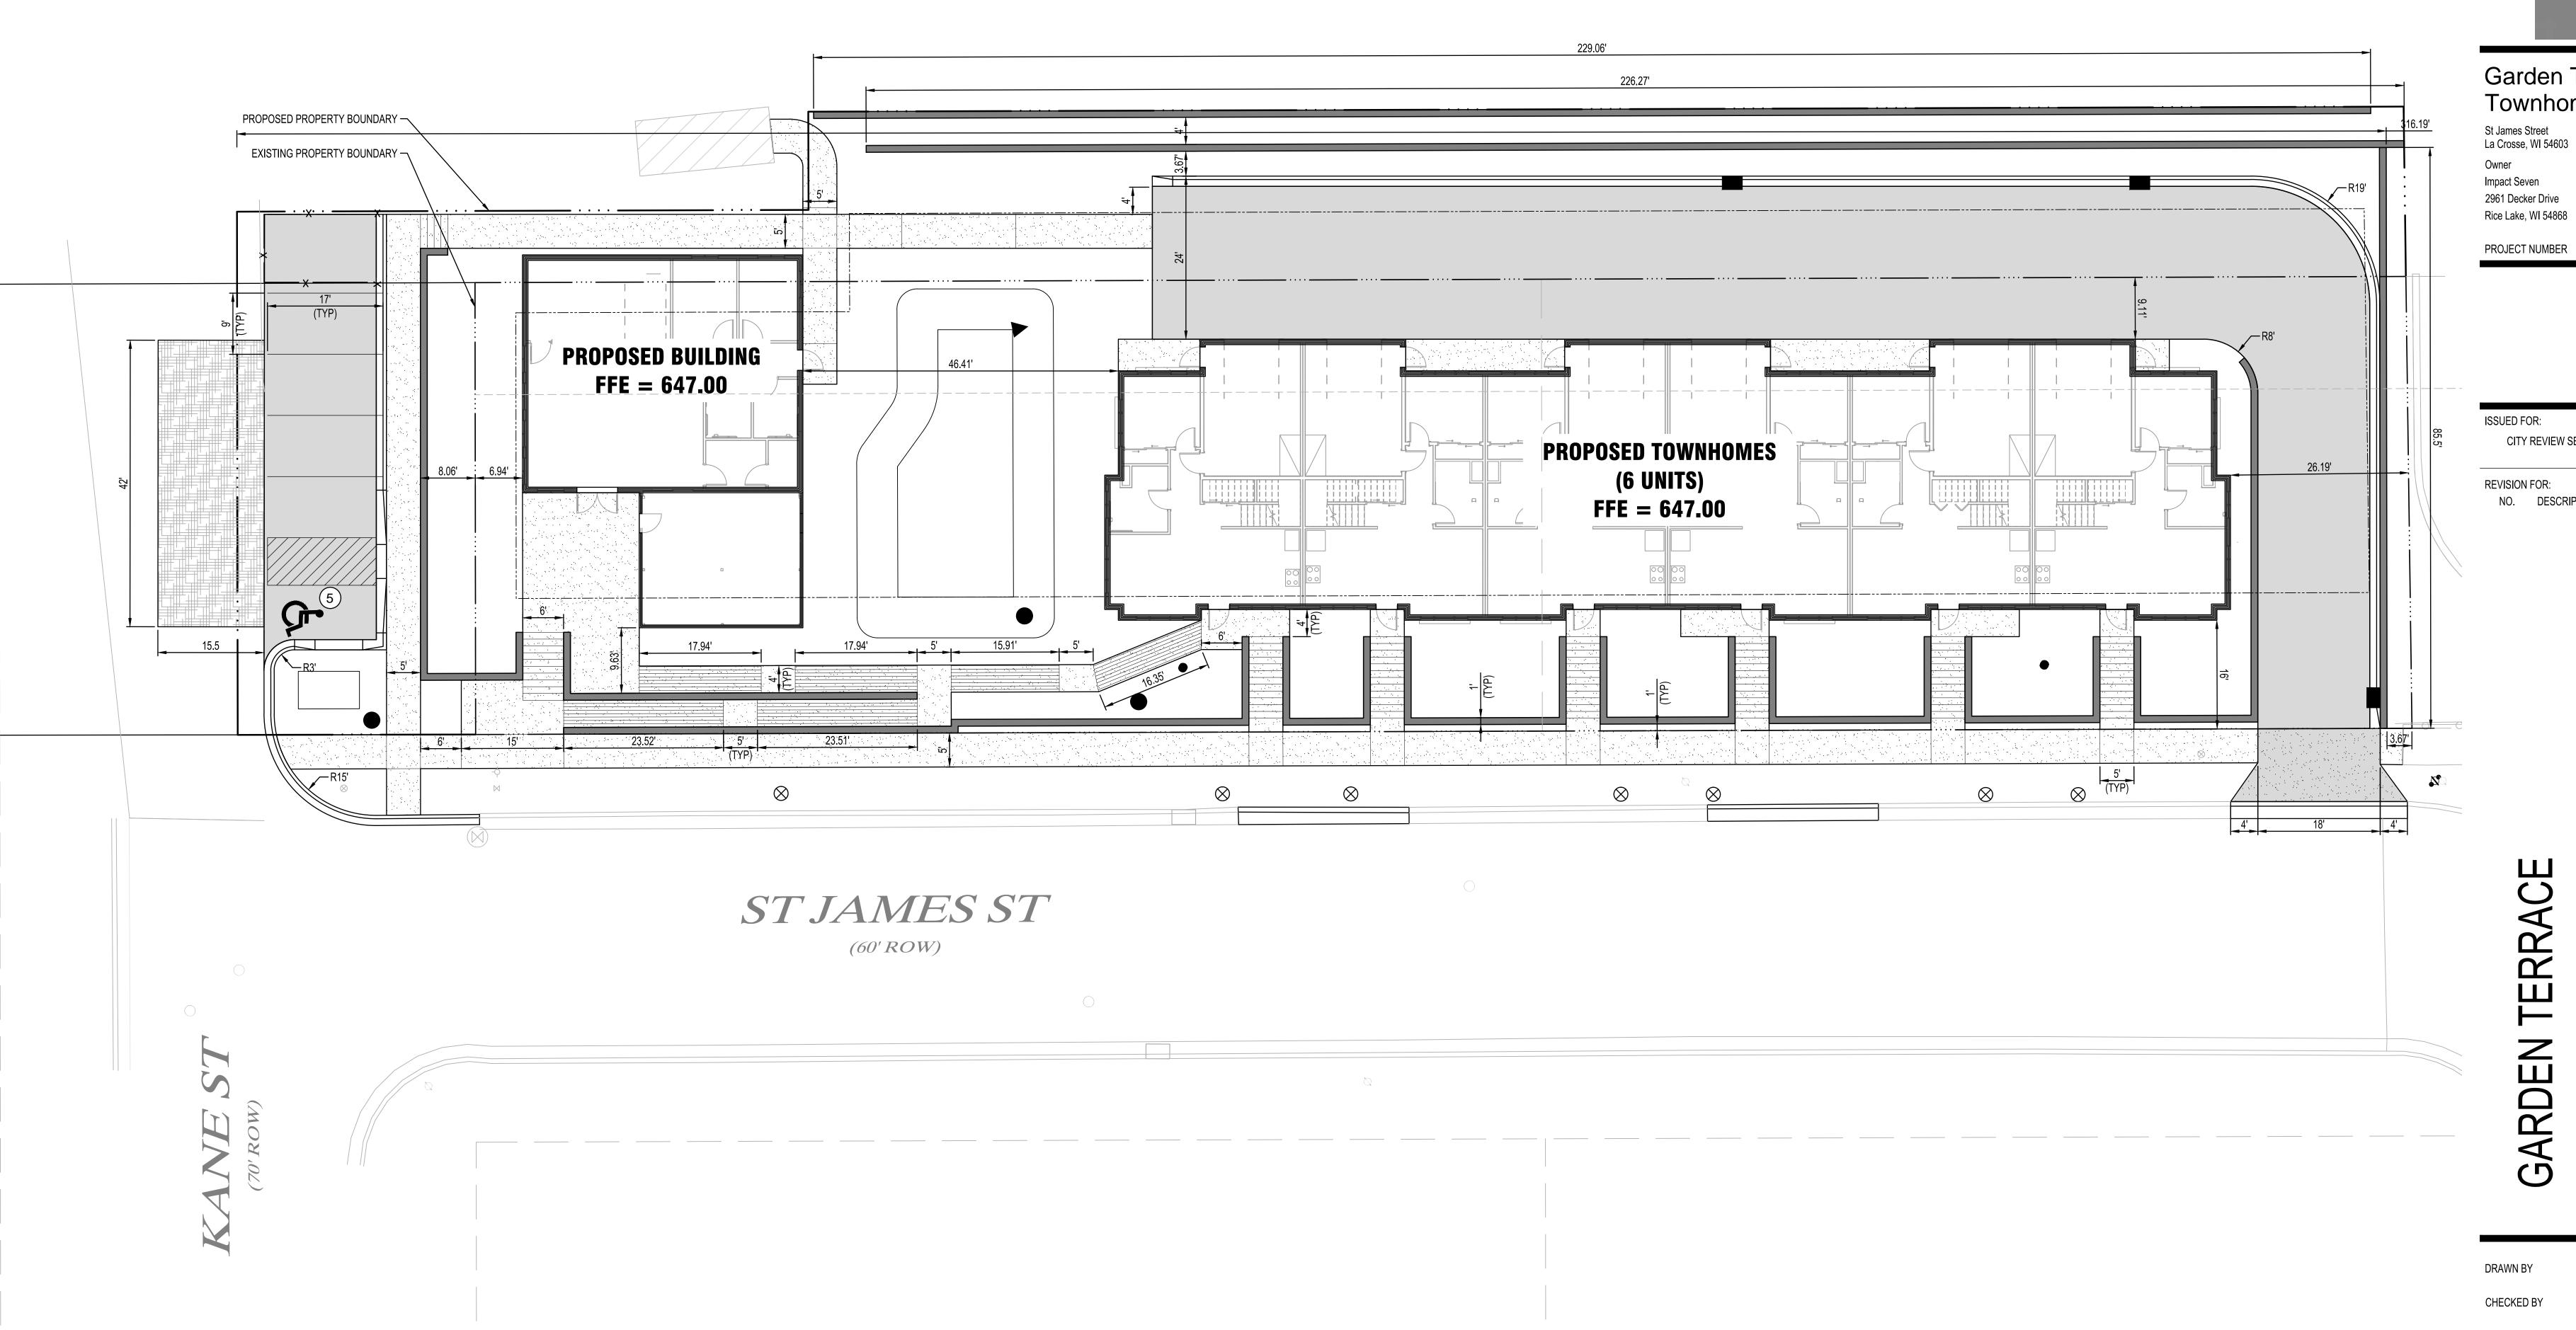



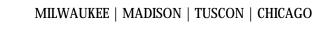



Garden Terrace -Townhomes

St James Street La Crosse, WI 54603

Owner Impact Seven

2961 Decker Drive Rice Lake, WI 54868

ISSUED FOR: CITY REVIEW SET 12/01/17 **REVISION FOR:** DATE

TOWNHOME

DRAWN BY CHECKED BY

PROPOSED SITY UTILITY

—— —— UT —— UNDERGROUND TELEPHONE —— UT —— UT ——

---- UTV --- UNDERGROUND TV


---- OHL --- OVERHEAD UTILITY

—— —— UTL. —— —— UNDERGROUND UTILITY

CONTRACTOR SHALL FIELD VERIFY THE LOCATIONS OF ALL EXISTING UTILITIES.


—— — FBO — — — FIBER OPTIC

C3-30

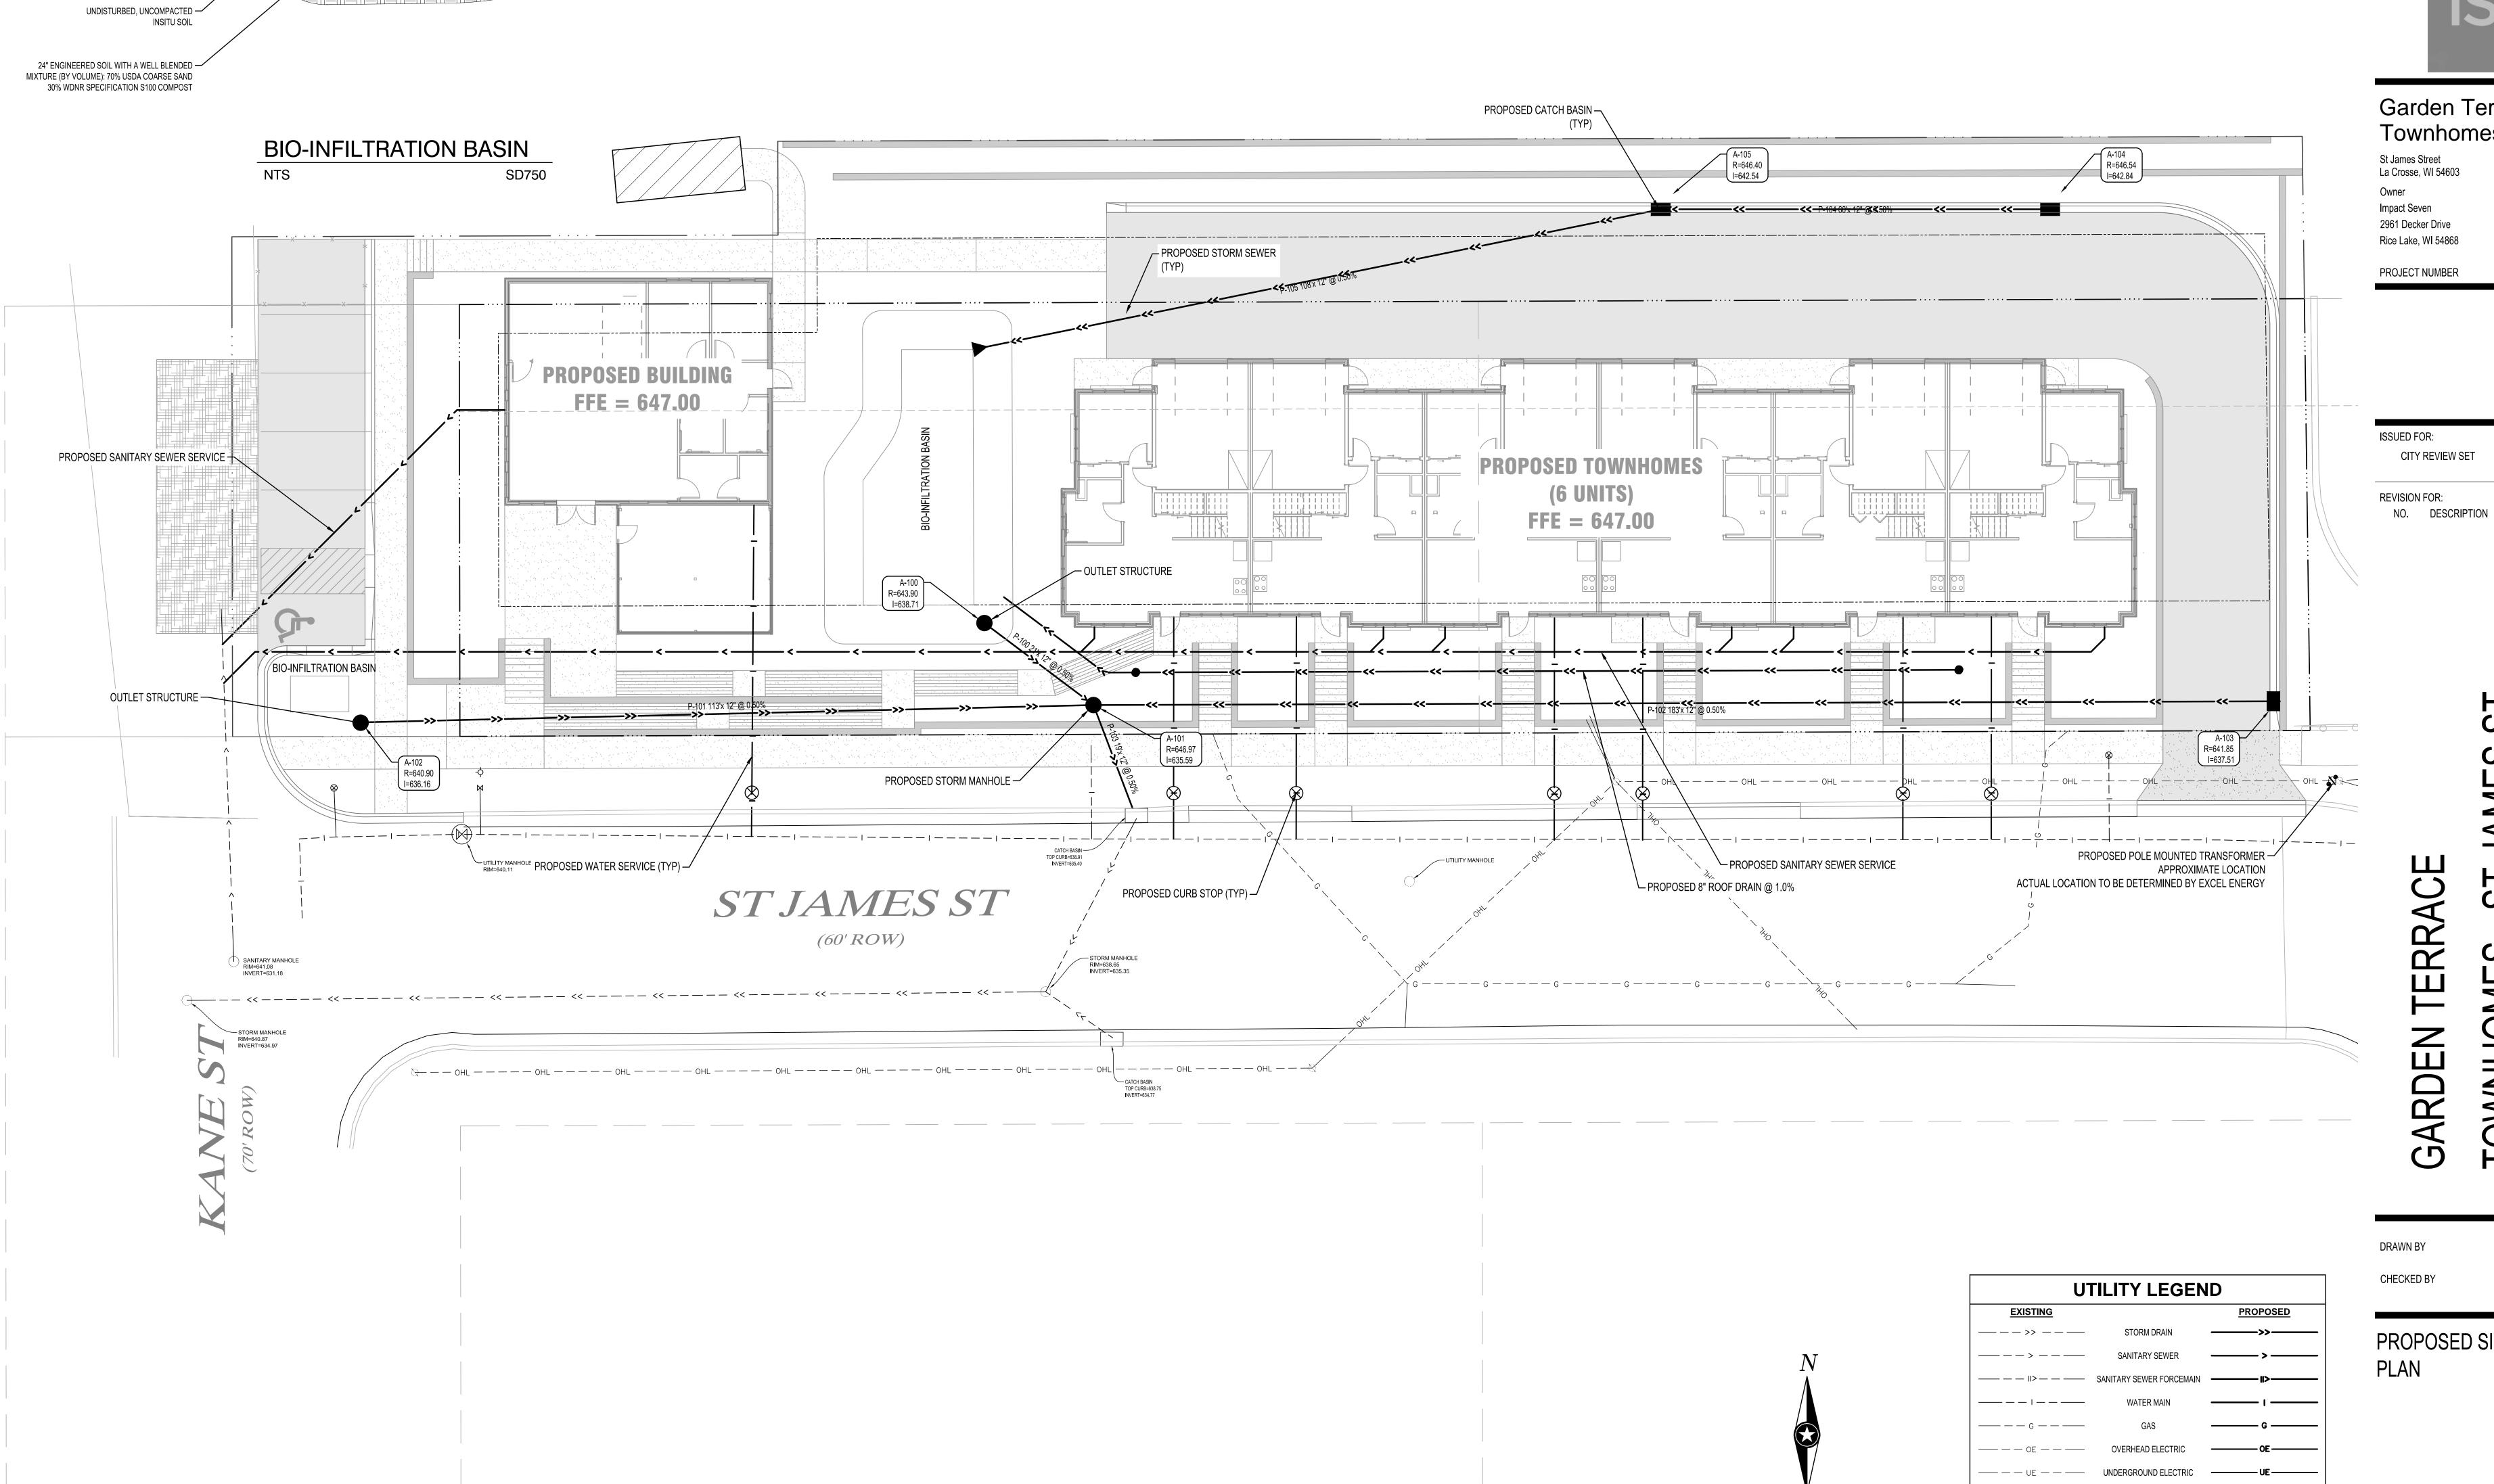

24" DRAIN BASIN w/24" DOME GRATE

GRASS PRE-TREATMENT STRIP —

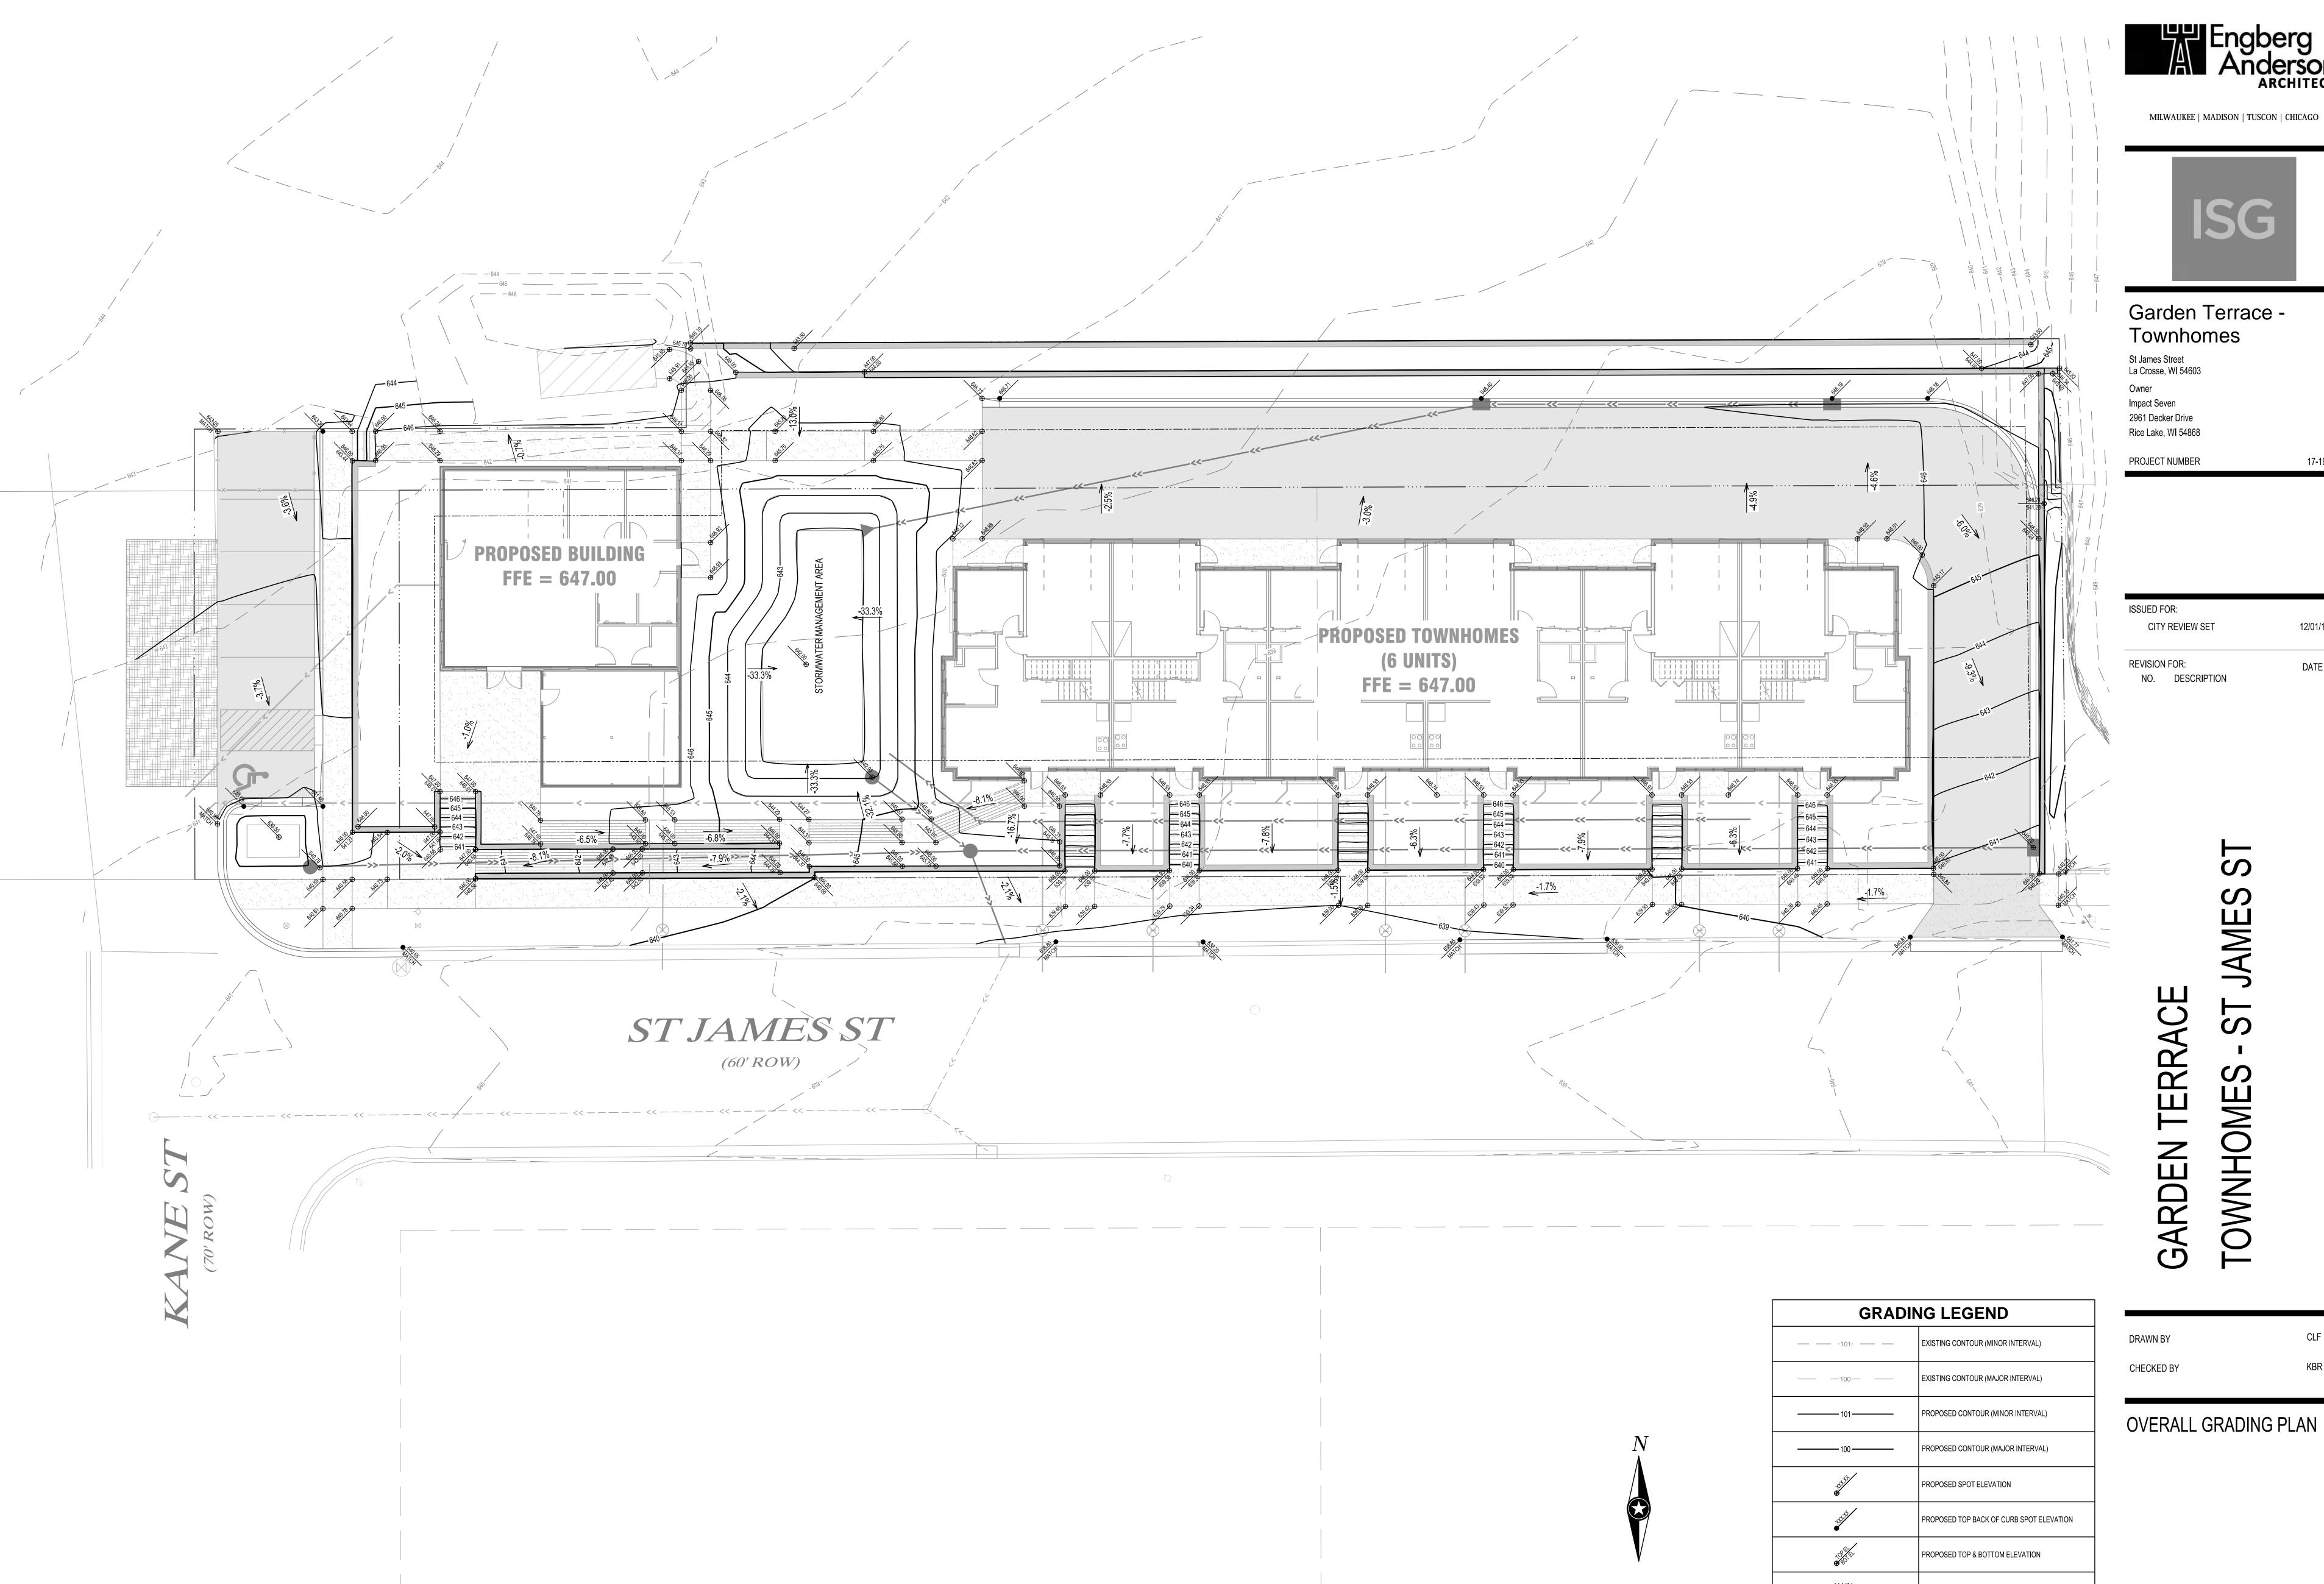





Garden Terrace -Townhomes

CITY REVIEW SET

DATE NO. DESCRIPTION

TOWNHOMES


GRADING LEGEND				
— -101- — —	EXISTING CONTOUR (MINOR INTERVAL)			
——————————————————————————————————————	EXISTING CONTOUR (MAJOR INTERVAL)			
101	PROPOSED CONTOUR (MINOR INTERVAL)			
100	PROPOSED CONTOUR (MAJOR INTERVAL)			
&	PROPOSED SPOT ELEVATION			
\$3.5°	PROPOSED TOP BACK OF CURB SPOT ELEVATION			
* ***********************************	PROPOSED TOP & BOTTOM ELEVATION			
-X.X%	SURFACE GRADE / DIRECTION			

GENERAL GRADING NOTES

EXCAVATED MATERIAL SHALL BE COMPACTED TO 100% PROCTOR DENSITY FOR THE UPPER 3', AND 95% PROCTOR DENSITY BELOW 3' IN ALL BUILDING PADS. REFER TO THE QUALITY COMPACTION METHOD IN ALL OTHER AREAS. PROPOSED CONTOURS SHOW FINISHED GRADE ELEVATIONS. BUILDING PAD AND PAVEMENT HOLD DOWNS ARE NOT INCLUDED.

0 10
SCALE IN FEET

C4-10

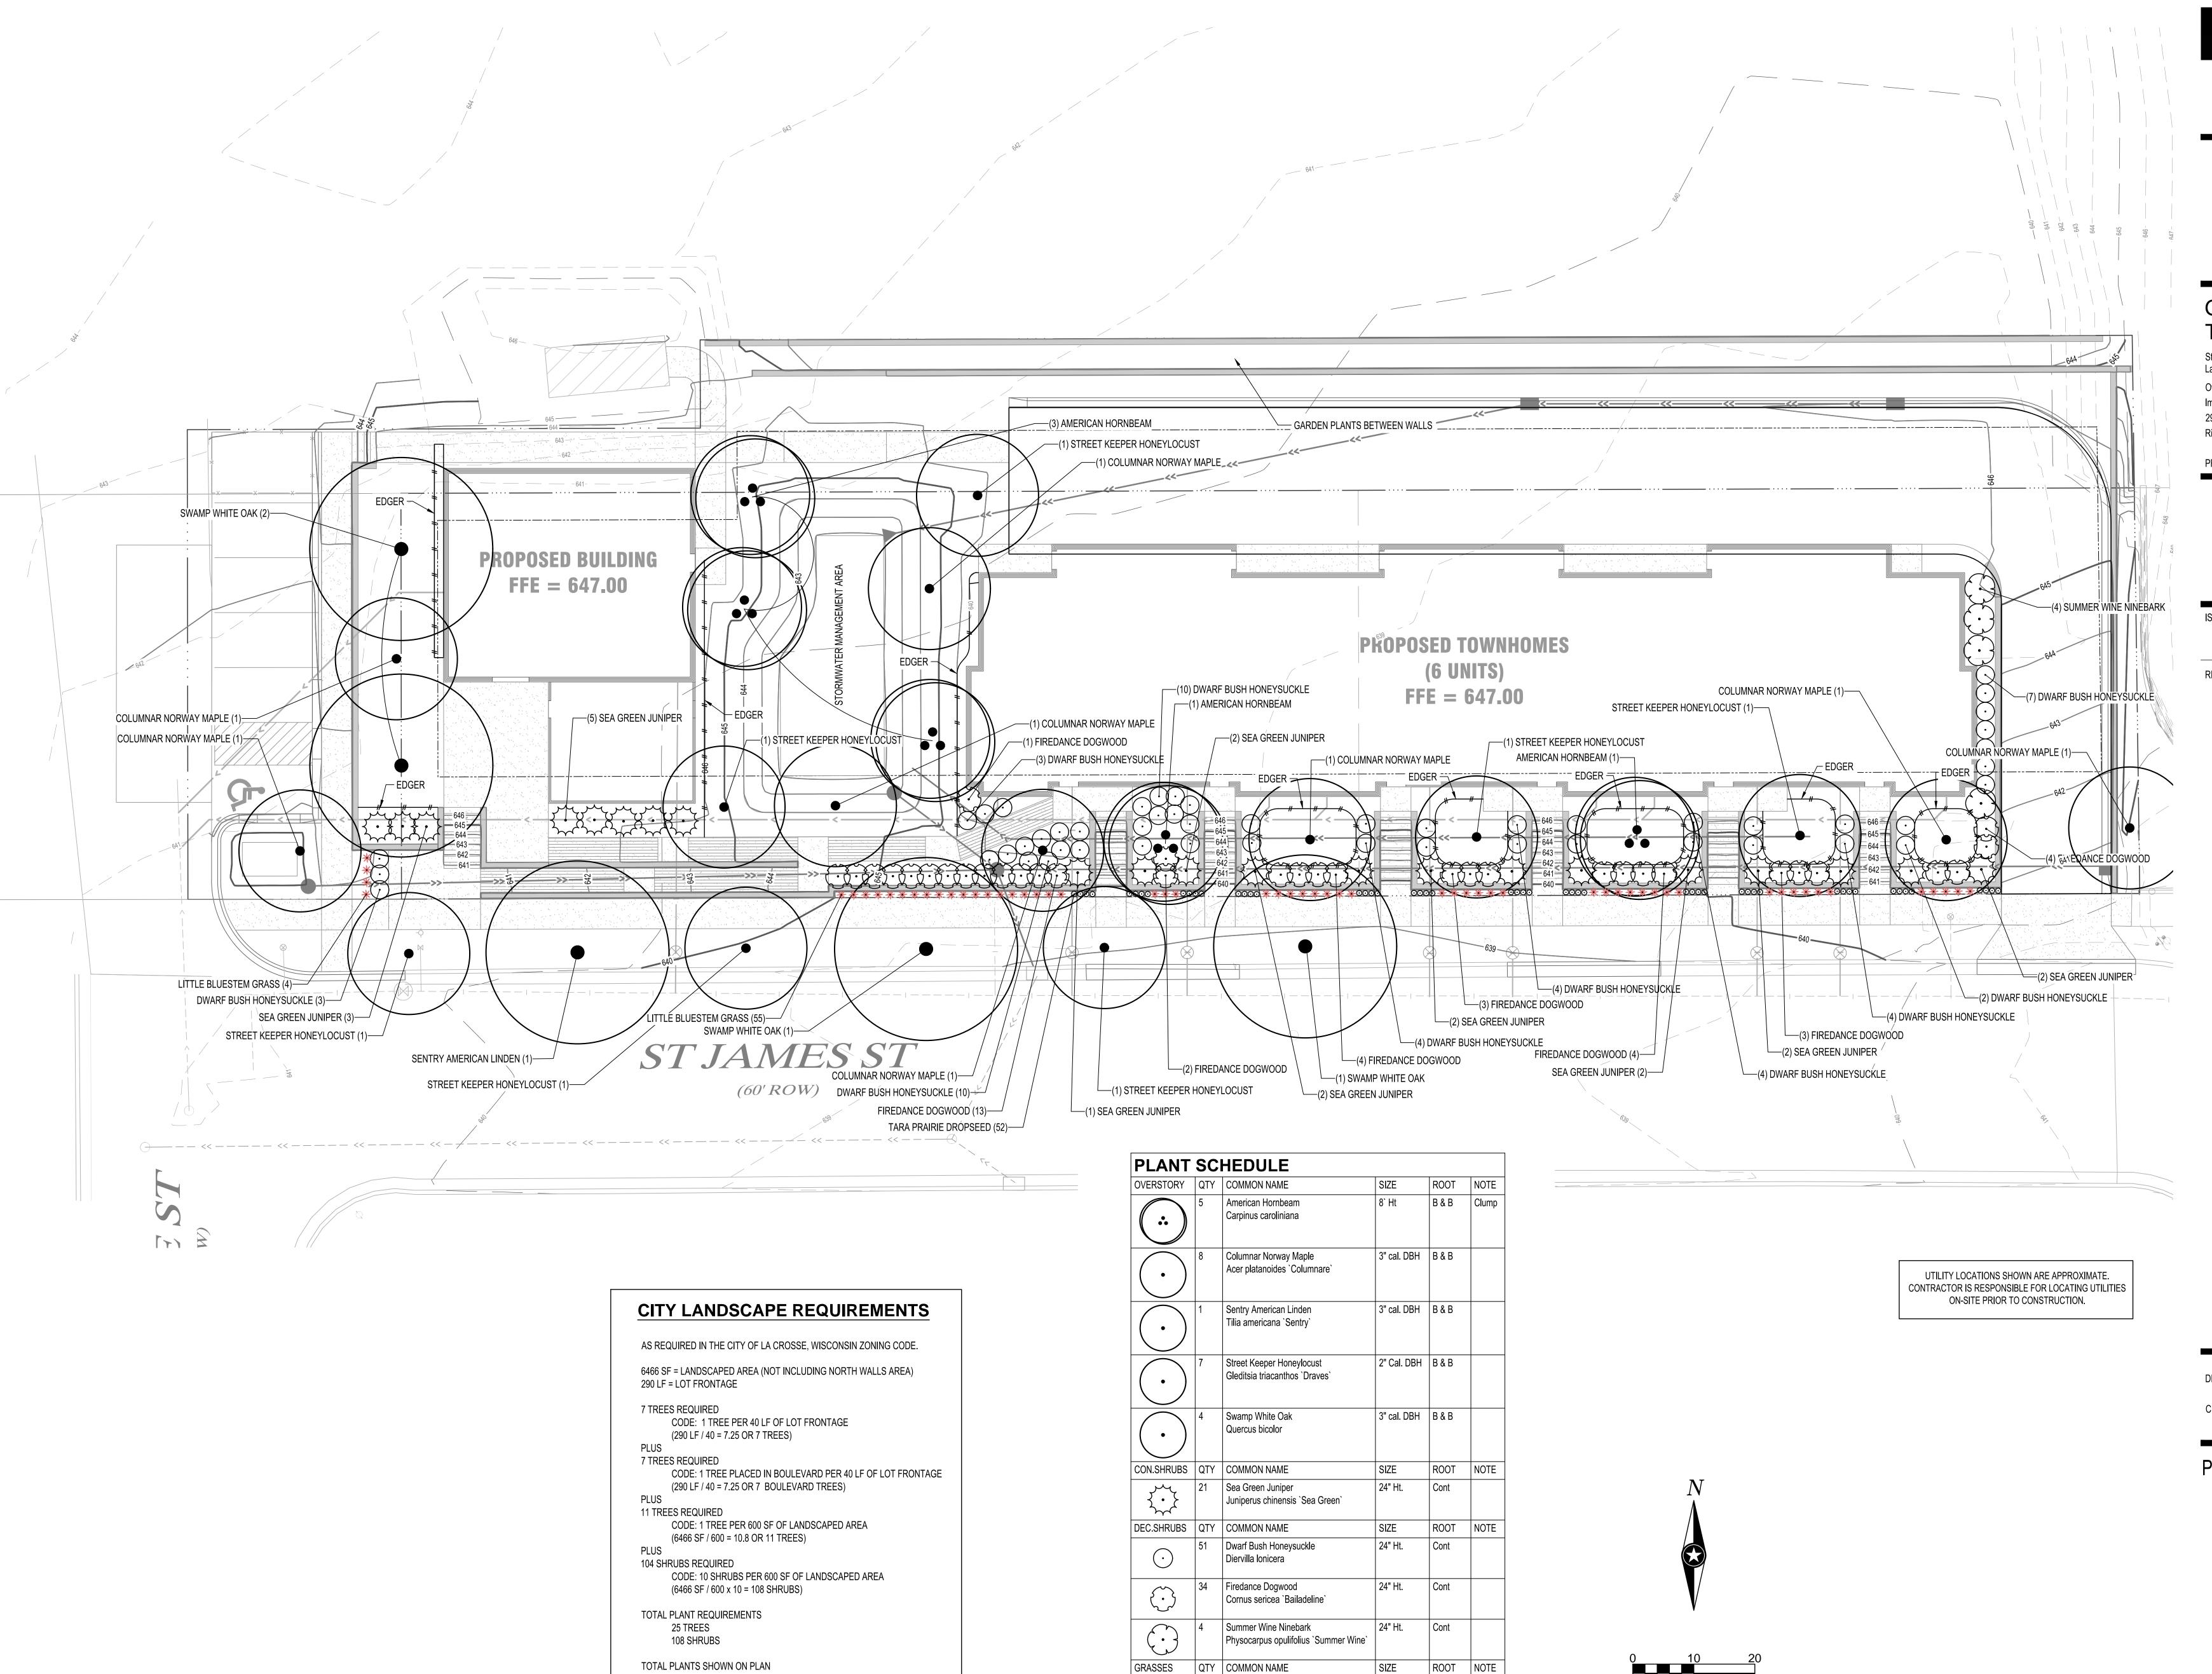

ROOT NOTE

SCALE IN FEET

#1 Cont.

6" HT. #1 Cont.

12" Ht

59 Little Bluestem Grass

Schizachyrium scoparium

Sporobolus heterolepis `Tara`

Tara Prairie Dropseed

TOTAL PLANTS SHOWN ON PLAN

MANY GARDEN PLANTS BETWEEN NORTH WALLS

25 TREES

110 SHRUBS

111 GRASSES

MILWAUKEE | MADISON | TUSCON | CHICAGO



Garden Terrace -Townhomes

St James Street La Crosse, WI 54603

Impact Seven 2961 Decker Drive

Rice Lake, WI 54868

PROJECT NUMBER

ISSUED FOR: CITY REVIEW SET


REVISION FOR: DATE NO. DESCRIPTION

TOWNHOME GARDEN


DRAWN BY CHECKED BY

PLANTING PLAN


C5-20

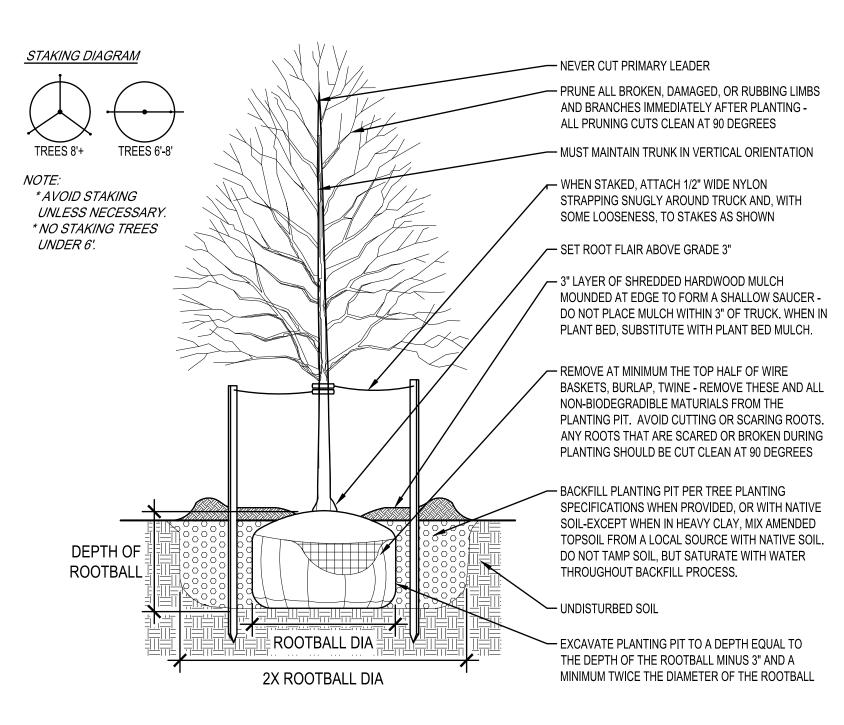

TREE PLANTING DETAIL

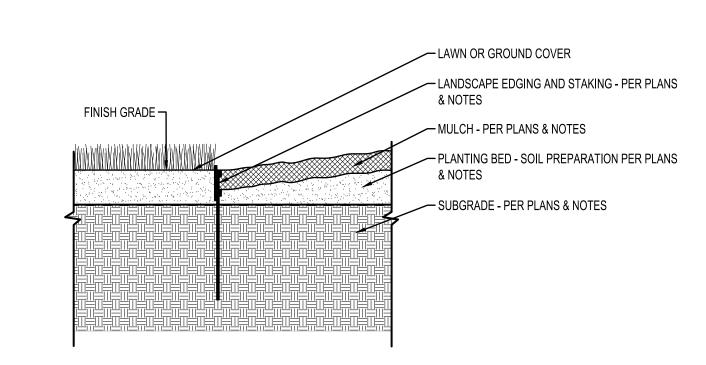

LANDSCAPE EDGING DETAIL
NO SCALE

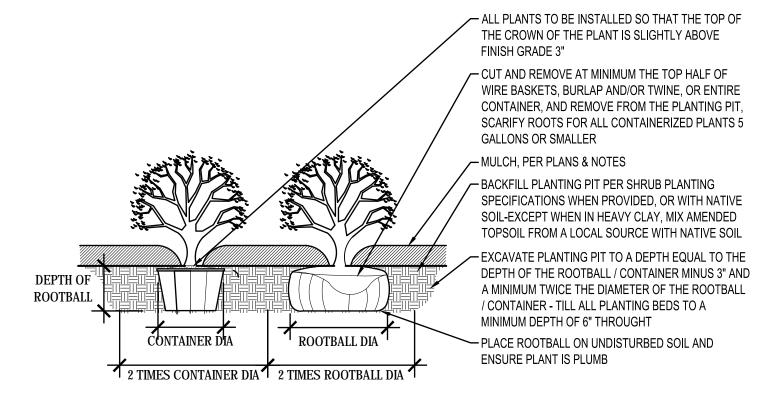

SHRUB PLANTING DETAIL

GENERAL PLANTING NOTES

- COORDINATE LOCATION OF ALL UTILITIES (LINES, DUCTS, CONDUITS, SLEEVES, FOOTINGS, ETC.) WITH LOCATIONS OF PROPOSED LANDSCAPE ELEMENTS (FENCE, FOOTINGS, TREE ROOTBALLS, ETC.). CONTRACTOR SHALL REPORT ANY DISCREPANCIES TO OWNER'S REPRESENTATIVE PRIOR TO CONTINUING WORK.
- SAVE AND PROTECT ALL EXISTING TREES NOT NOTED TO BE REMOVED.
 REMOVE ALL CONSTRUCTION DEBRIS AND MATERIALS INJURIOUS TO PLANT GROWTH FROM PLANTING PITS AND BEDS PRIOR TO BACKFILLING WITH PLANTING MIX.
- 4. LAWN AREAS SHALL HAVE 6" MINIMUM DEPTH OF TOPSOIL. TOPSOIL SHALL BE COMPACTED TO 85% MAXIMUM DENSITY AT OPTIMUM MOISTURE CONTENT.
- 5. REFER TO PLANTING DETAILS PLAN FOR AMENDED SOIL DEPTH IN PLANTING BEDS AND SURROUNDING TREES. REFER TO SPECIFICATIONS FOR MIX TYPE.
- 6. FIELD STAKE PLANTINGS ACCORDING TO PLAN. OWNER'S REPRESENTATIVE SHALL APPROVE ALL PLANT LOCATIONS PRIOR TO INSTALLATION. OWNER RESERVES THE RIGHT TO REVISE PLANTING LAYOUT AT TIME OF INSTALLATION.
- 7. ALL PLANT MATERIALS SHALL BE TRUE TO THEIR SCIENTIFIC NAME AND SIZE AS INDICATED IN THE PLANT SCHEDULE.
- 8. IF DISCREPANCIES EXIST BETWEEN THE NUMBER OF PLANTS DRAWN ON THE PLANTING PLAN AND THE NUMBER OF PLANTS IN THE SCHEDULE, THE PLANTING PLAN SHALL GOVERN.
- 9. OWNER RESERVES THE RIGHT TO REVISE QUANTITIES TO SUIT BUDGET LIMITATIONS. CONTRACTOR'S UNIT BID PRICES SHALL PREVAIL FOR ANY CHANGES IN QUANTITIES.
- CHANGES IN QUANTITIES.

 10. ANY PROPOSED SUBSTITUTIONS OF PLANT SPECIES SHALL BE MADE WITH PLANTS OF EQUIVALENT OVERALL FORM, HEIGHT, BRANCHING HABIT, FLOWER, LEAF, COLOR, FRUIT AND CULTURE, AND ONLY AFTER
- WRITTEN APPROVAL OF THE OWNER'S REPRESENTATIVE AND OWNER.

 11. ALL PLANT MATERIALS MUST CONFORM TO AMERICAN STANDARDS FOR NURSERY STOCK (A.N.S.I.), LATEST EDITION PUBLISHED BY THE AMERICAN ASSOCIATION OF NURSERYMEN, WASHINGTON D.C. LARGER SIZED PLANT MATERIALS OF THE SPECIES LISTED MAY BE USED IF THE STOCK CONFORMS TO A.N.S.I.
- 12. ALL PLANT MATERIAL SHALL BE GUARANTEED TO BE IN A LIVE AND HEALTHY GROWING CONDITION FOR ONE FULL GROWING SEASON (ONE YEAR) AFTER FINAL PROJECT ACCEPTANCE OR SHALL BE REPLACED FREE OF CHARGE WITH THE SAME GRADE AND SPECIES. ALL TREES SHALL HAVE A STRONG CENTRAL LEADER.
- 13. CONTRACTOR IS RESPONSIBLE FOR ALL DAMAGE DUE TO OPERATIONS.
 ANY AREAS THAT ARE DISTURBED SHALL BE RESTORED TO ITS ORIGINAL CONDITION AT NO ADDITIONAL COST TO THE OWNER.
- 14. PLANTING BED EDGING USE 1/8" x 4" METAL EDGING IN ALL AREAS WHERE PLANTING BED MEETS LAWN AREAS OR WHERE INDICATED. USE 12" METAL SPIKES AS INSTRUCTED BY MANUFACTURER.
- 15. PROVIDE SHREDDED HARDWOOD MULCH, NATURAL COLOR, SURROUNDING ALL PROPOSED TREES TO A 3-INCH MINIMUM DEPTH AS SHOWN IN TREE PLANTING DETAIL. DO NOT USE AN UNDERLAYMENT SUCH AS PLASTIC SHEET OR LANDSCAPE FABRIC. IF LOCATED WITHIN A PLANT BED, SUBSTITUTE THIS MULCH WITH THE MULCH CALLED FOR WITHIN THAT PLANT BED. APPLY PRE-EMERGENT TO ALL PLANTING BEDS PRIOR TO MULCHING.
- 16. PROVIDE SHREDDED HARDWOOD MULCH, NATURAL COLOR, IN ALL PLANTING BEDS 3-INCH MINIMUM DEPTH. DO <u>NOT</u> USE AN UNDERLAYMENT SUCH AS PLASTIC SHEET OR LANDSCAPE FABRIC. APPLY PRE-EMERGENT TO ALL PLANTING BEDS PRIOR TO MULCHING.
- 17. ALL TURF AREAS DISTURBED BY CONSTRUCTION SHALL BE SODDED. SOD SECTIONS SHALL BE NO SMALLER THAN 24" X 36" STAKED IN PLACE WITH BIODEGRADABLE SOD STAKES WHEN SLOPE IS STEEPER THAN 5:1 OR WHEN CONDITIONS REQUIRE.
- 18. FOR PLANT, SHRUB, AND TREE LOCATIONS: CONTRACTOR IS PERMITTED TO USE DISCRETION AS NECESSARY TO AVOID DRIVEWAYS, UTILITIES, OR OTHER CONFLICTS. THE TOTAL NUMBER OF PLANTS, INCLUDING
- SHRUBS AND TREES SHALL MEET CITY CODE.

 19. INDICATED QUANTITIES ARE ESTIMATES AND SHOULD BE CONFIRMED BY THE CONTRACTOR/BIDDER.



MILWAUKEE | MADISON | TUSCON | CHICAGO



Garden Terrace - Townhomes

St James Street La Crosse, WI 54603

Owner

Impact Seven 2961 Decker Drive

Rice Lake, WI 54868

Trice Lake, WI 54000

PROJECT NUMBER

REVISION FOR:

NO. DESCRIPTION

SUED FOR:	
CITY REVIEW SET	12/01/17

DATE


GARDEN TERRACE TOWNHOMES - ST JAMES S

DRAWN BY CWT
CHECKED BY KBR

PLANTING NOTES & DETAILS

C5-21



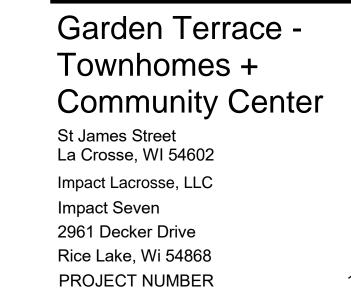


ISSUED FOR: CITY REVIEW SET	12-01-2017
REVISION FOR: NO. DESCRIPTION	DATE

CITY REVIEW SET - NOT FOR CONSTRUCTION


DRAWN BY Auth
CHECKED BY Check

LIGHTING PLAN

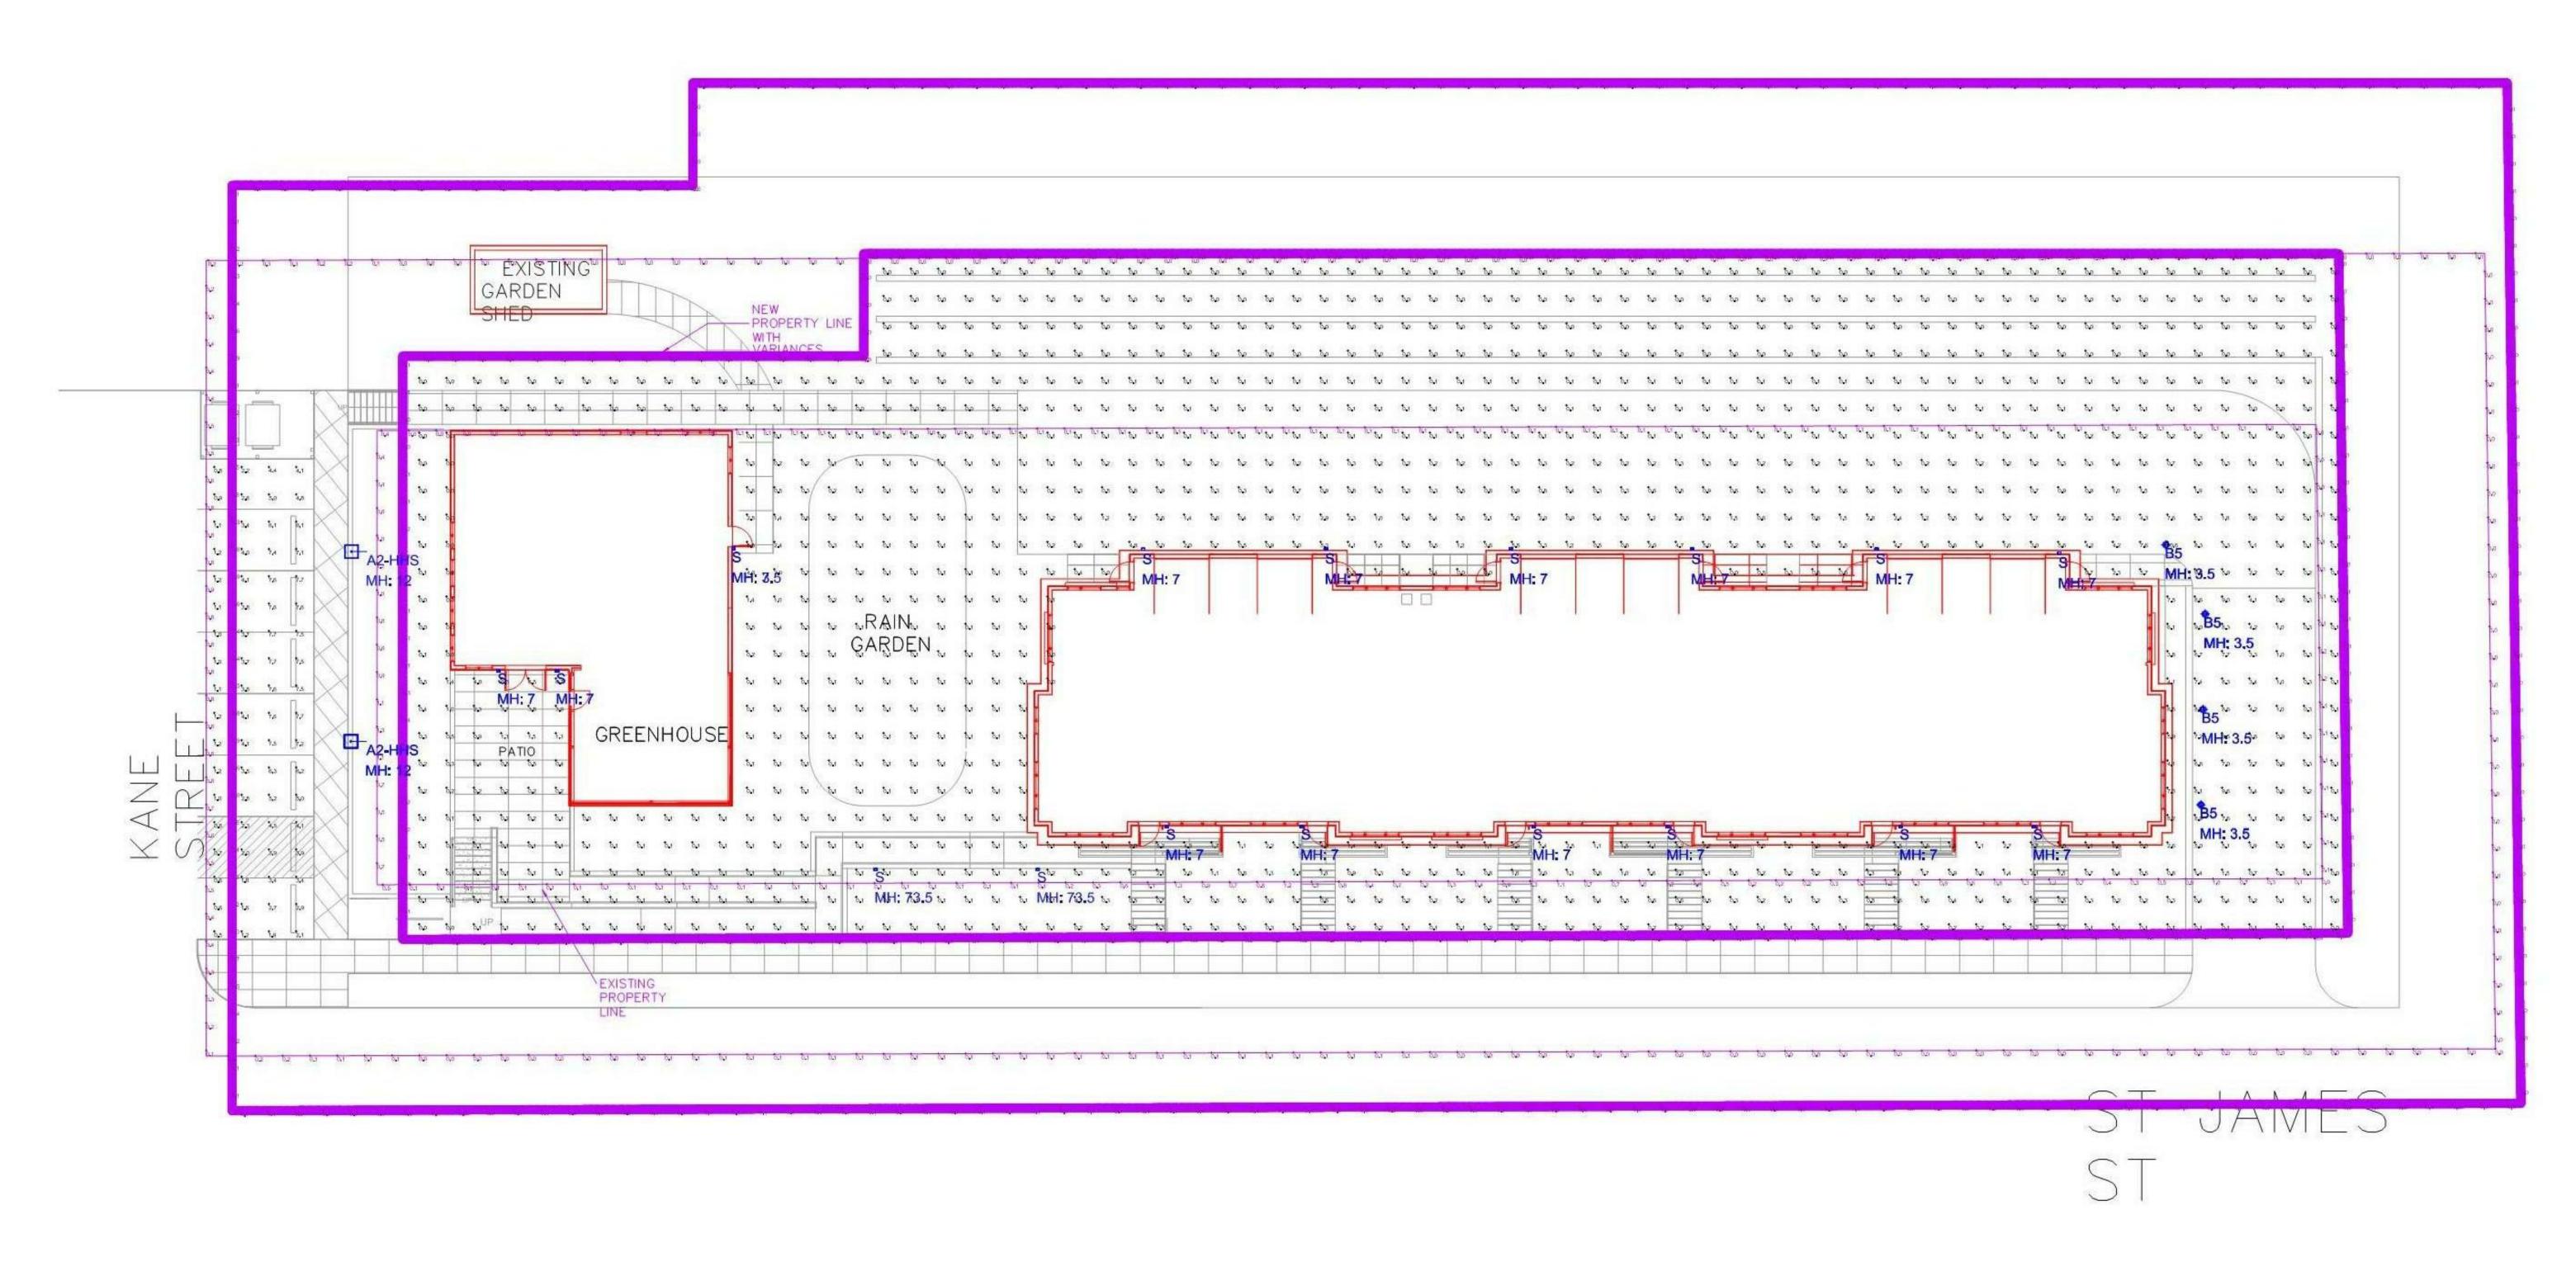

Luminaire Schedule							
Qty	Label	Arrangement	Lum. Lumens	Lum. Watts	LLF	Description	Total Watts
17	s	SINGLE	1571	28.7	0.900	KUZCO + EW7024-GH	487.9
4	B5	SINGLE	1779	21.3	0.900	PWY-EDG-5M-P4-02-E-UL-xxK	85.2
2	A2-HHS	SINGLE	5162	59	0.900	McGRAW-EDISON + GLEON-AF-01-LED-E1-SL2-HSS	118

Calculation Summary							
Label	CalcType	Units	Avg	Max	MIn	Avg/Min	Max/Mir
25' OFF EXISTING PROP LINE	Illuminance	Fc	0.10	0.9	0.0	N.A.	N.A.
25' OFF NEW PROP LINE	Illuminance	Fc	0.20	2.9	0.0	N.A.	N.A.
EXISTING PROP LINE	Illuminance	Fc	0.32	1.3	0.0	N.A.	N.A.
NEW PROP LINE	IllumInance	Fc	0.07	0.4	0.0	N.A.	N.A.
PARKING AREA	Illuminance	Fc	3.87	7.7	0.5	7.74	15.40
SITE	Illuminance	Fc	0.68	10.6	0.0	N.A.	N.A.

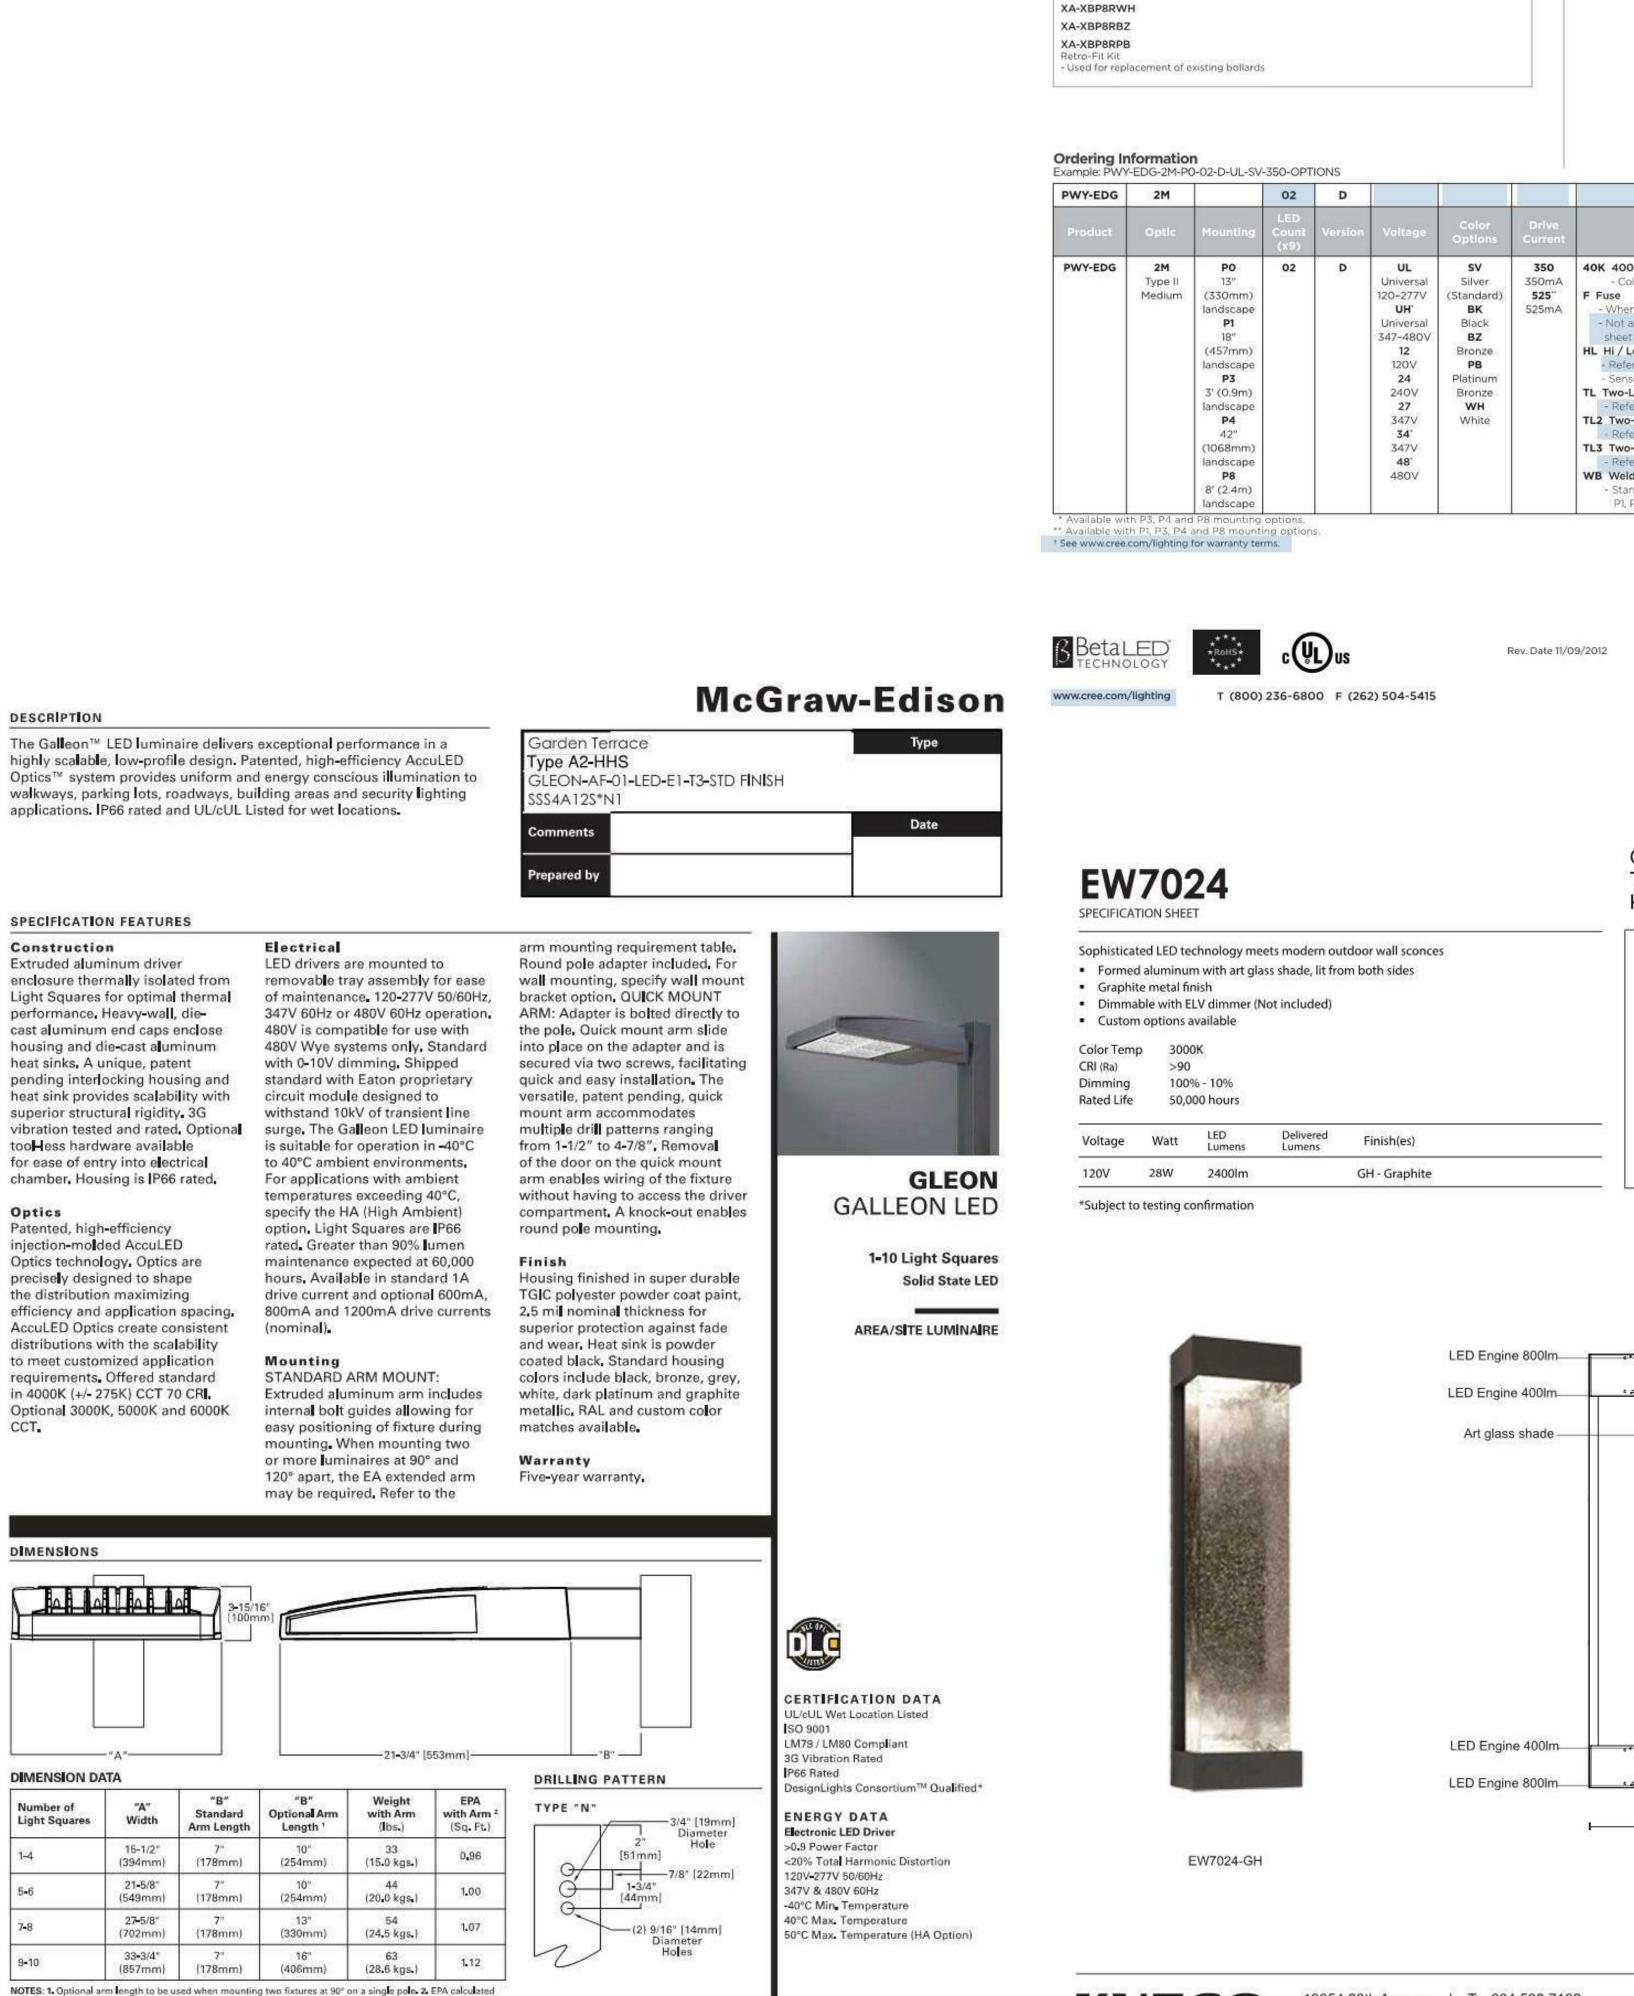

2016-09-28 15:31:55

DESCRIPTION

SPECIFICATION FEATURES

Extruded aluminum driver

enclosure thermally isolated from

Light Squares for optimal thermal

cast aluminum end caps enclose

pending interlocking housing and

heat sink provides scalability with

superior structural rigidity. 3G

for ease of entry into electrical

chamber. Housing is IP66 rated.

housing and die-cast aluminum

performance, Heavy-wall, die-

heat sinks. A unique, patent

tooHess hardware available

Patented, high-efficiency

injection-molded AccuLED

precisely designed to shape

the distribution maximizing

efficiency and application spacing.

AccuLED Optics create consistent

distributions with the scalability

to meet customized application

requirements. Offered standard

in 4000K (+/- 275K) CCT 70 CRI.

DIMENSIONS

DIMENSION DATA

Light Squares

with optional arm length.

Powering Business Worldwide

Optional 3000K, 5000K and 6000K

Width

21-5/8"

33-3/4"

Standard Arm Length

(178mm)

(178mm)

Length 1

10" (254mm) 10" (254mm)

(330mm)

16"

(406mm)

13"

(lbs.)

(15.0 kgs.)

44 (20.0 kgs.)

(24.5 kgs.)

(28.6 kgs.)

*www.designlights.org

Optics technology. Optics are

Construction

The Galleon™ LED luminaire delivers exceptional performance in a

Electrical

(nominal).

Mounting

LED drivers are mounted to

circuit module designed to

temperatures exceeding 40°C,

specify the HA (High Ambient)

STANDARD ARM MOUNT:

may be required. Refer to the

applications. IP66 rated and UL/cUL Listed for wet locations.



MILWAUKEE | MADISON | TUSCON | CHICAGO

Garden Terrace -Townhomes + **Community Center**

St James Street La Crosse, WI 54602 Impact Lacrosse, LLC

Impact Seven 2961 Decker Drive Rice Lake, Wi 54868

PROJECT NUMBER

ISSUED FOR: CITY REVIEW SET 12-01-2017 **REVISION FOR:** DATE

NO. DESCRIPTION

CREE

Garden Terrace

PWY-EDG-5M-P4-02-E-UL-xxK

[102mm]

Model Dim. "A"

Landscape-13 13" [330mm]

Landscape-18 18" [457mm] Pathway 36" [914mm] Pathway 42" [1067mm]

Pedestrian 96" [2438mm]

350 40K 4000K Color Temperature

Color temperature per luminaire

sheet for availability with ML options

HL Hi / Low (175/350/525 Dual Circuit Input)

Refer to ML spec sheet for details

- Refer to ML spec sheet for details

- Refer to ML spec sheet for details

- Refer to ML spec sheet for details

P1, P3, and P4 mounting options

Garden Terrace

- Sensor not included

WB Welded Base

- When code dictates fusing, use time delay fuse

TL Two-Level (175/525 w/ integrated sensor control)

TL2 Two-Level (0/350 w/ integrated sensor control)

TL3 Two-Level (0/525 w/ integrated sensor control)

- Standard on P8 mounting option, available with

- Not available with all ML options. Refer to ML spec

Silver

Bronze

PB

Platinum

Bronze

White

350mA

Rev. Date 11/09/2012

Type B5

Sophisticated LED technology meets modern outdoor wall sconces Formed aluminum with art glass shade, lit from both sides

THE EDGE® PWY-EDG-2M

Duable die-cast aluminum luminaire housing mounts directly to 4" (102mm) diameter pole without visible mounting hardware for clean apperance. Pole mounts to rugged die cast aluminum internal flange secured by (3) 3/8-16 anchor bolts (provided), Note: T45 Torx 3/8 socket required for head installation. Top mounted LEDs for superior

Pathway Luminaire - Type II Medium

Product Description

optical performance and light control.

Performance Summary

CRI: Minimum 70 CRI

Accessories

XA-XBP8RSV

XA-XBP8BK

Utilizes BetaLED® Technology

Patented NanoOptic® Product Technology Made in the U.S.A. of U.S. and imported parts

CCT: 5700K (+/- 500K) Standard, 4000K (+/- 300K)


EPA and Weight: Reference EPA and Weight spec sheet

Warranty: 10 years on luminaire/10 years on Colorfast DeltaGuard® finish®

Finish(es) GH - Graphite Type S KUZCO + EW7024-GH

Metal Finish

GH - Graphite

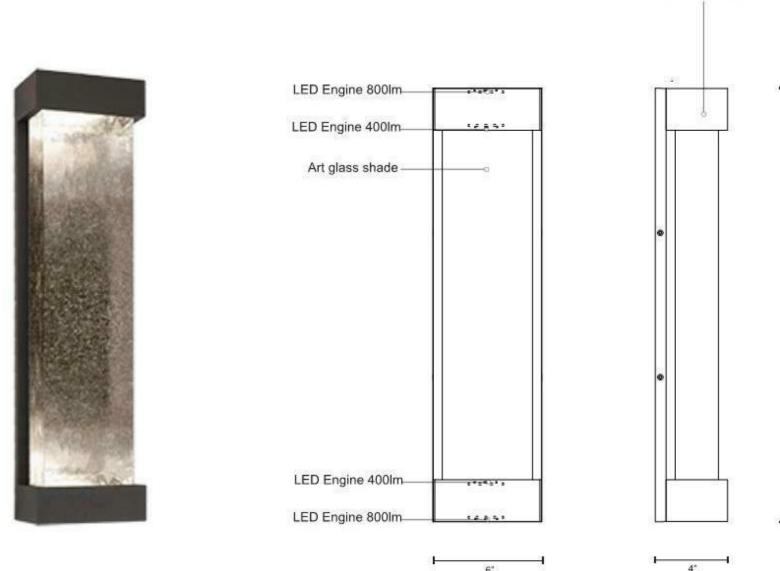


19054 28th Avenue T: 604 538 7162 Surrey, BC, Canada F: 604 538 7196 W: Kuzcolighting.com SCHEDULED **FIXTURES**

DRAWN BY

CHECKED BY

Author

Checker

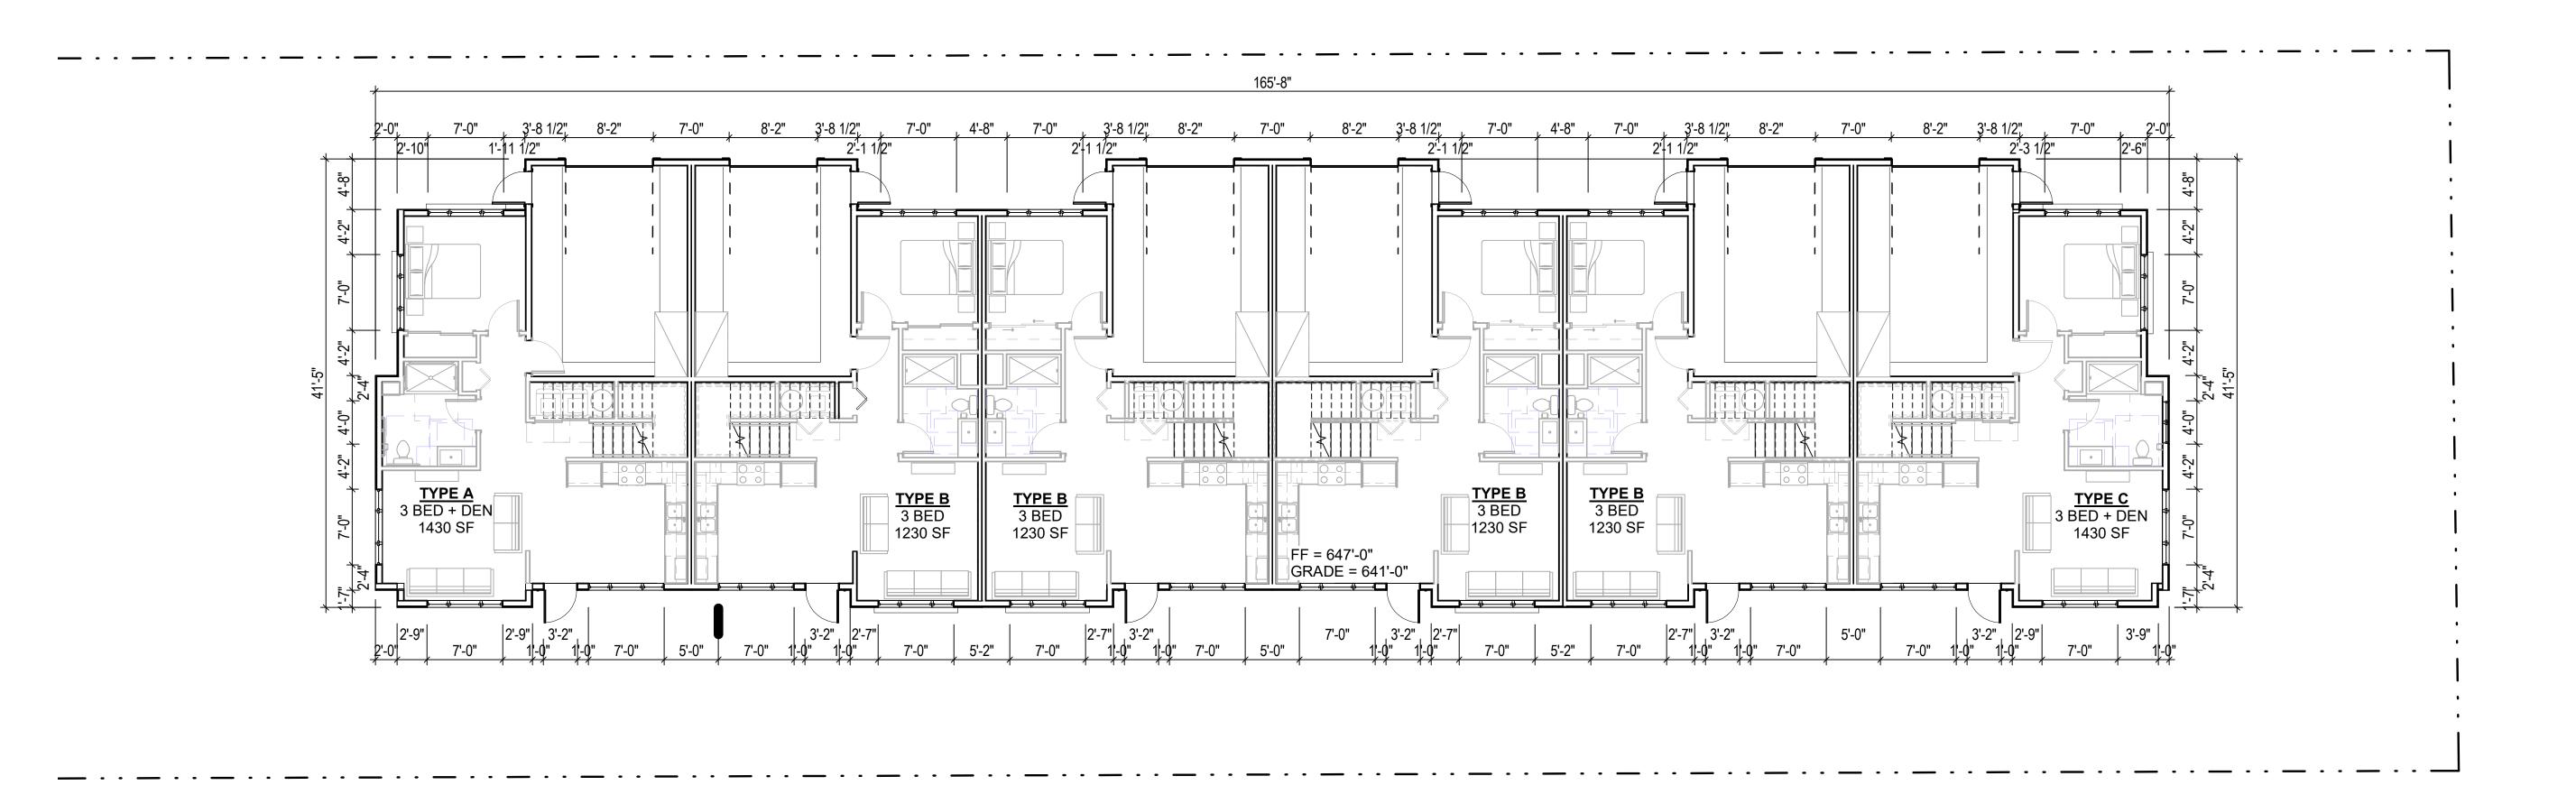

1 LEVEL 1 OVERALL PLAN
SCALE: 1/8" = 1'-0"



MILWAUKEE | MADISON | TUSCON | CHICAGO

Garden Terrace Town Homes

St James Street
La Crosse, WI 54602

Impact La Crosse, LLC
Impact Seven

2961 Decker Drive Rice Lake, WI 54868

PROJECT NUMBER

ISSUED FOR:
CITY REVIEW SET 12-01-2017

REVISION FOR:
NO. DESCRIPTION

CITY REVIEW SET - NOT FOR CONSTRUCTION

DRAWN BY
CHECKED BY

PLANS

OVERALL FLOOR



Garden Terrace Town Homes

St James Street
La Crosse, WI 54602
Impact La Crosse, LLC
Impact Seven
2961 Decker Drive

Rice Lake, WI 54868

ISSUED FOR:
CITY REVIEW SET 12-01-2017

REVISION FOR: DATE

NO. DESCRIPTION

CTY REWEW SET - NOT FOR CONSTRUCTION OF THE CO

DRAWN BY

BUILDING ELEVATIONS

CHECKED BY





SHINGLED ROOF

FIBER CEMENT BOARD, WOOD FINISH —





- MILL FINISH METAL LOUVER

FIBERGLASS WINDOWS

WOOD AWNING & POST

5/4" COMPOSITE TRIM BOARD

PREFINISHED METAL
RAILING WITH MESH INFILL

- CEMENT BOARD LAP SIDING, COLOR A

NORTH ELEVATION - TOWNHOUSE





OVERALL SOUTH ELEVATION- street-facing facade

1 20% study
SCALE: 1/8" = 1'-0"

WINDOWS / DOOR AREA ON STREET FACADE 20% MINIMUM REQUIREMENT

SOUTH ELEVATION							
TOTAL WALL 3,520.24 sf							
window / door area	minimum requirement	20%	704.048 sf				
WINDOW TYPE	SF	UNITS	TOTAL				
TYPE A	42	24	1008 sf				
UNIT DOOR	22.43	6	134.58 sf				
	TOTAL AREA WINDOV	WS/DOOR	1142.58 sf				



MILWAUKEE | MADISON | TUSCON | CHICAGO

Garden Terrace -Town Homes

St James Street La Crosse, WI 54602 Impact La Crosse, LLC Impact Seven 2961 Decker Drive Rice Lake, WI 54868

PROJECT NUMBER

ISSUED FOR: CITY REVIEW SET 12-01-2017 REVISION FOR:

NO. DESCRIPTION

DATE

DRAWN BY CHECKED BY

STREET FACING FACADE STUDY-DESIGN REVIEW CHECKLIST- K.7

Garden Terrace -

St James Street La Crosse, WI

Impact Seven

ISSUED FOR:

REVISION FOR:

CITY REVIEW SET

NO. DESCRIPTION

2961 Decker Drive Rice Lake, WI 54868

PROJECT NUMBER

Impact La Crosse, LLC

Community Center


162624.00


12-01-2017

DATE

CLUB HOUSE FINISH SCHEDULE

ROOM NAME	FLOORS	BASE	WALLS	CEILING	REMARKS
OFFICE	CPT	PFW	GYP, PT-X	SUS GYP, PT-X	
RESTROOM	SC	RB	GYP, PT-X	SUS GYP, PT-X	
COMMON AREA	SC	RB	GYP, PT-X		
KITCHEN	SC	RB	GYP, PT-X		
GREEN ROOM	SC	RB	GYP, PT-X		

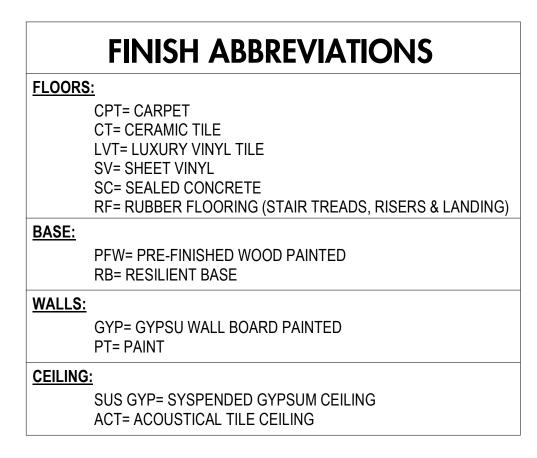

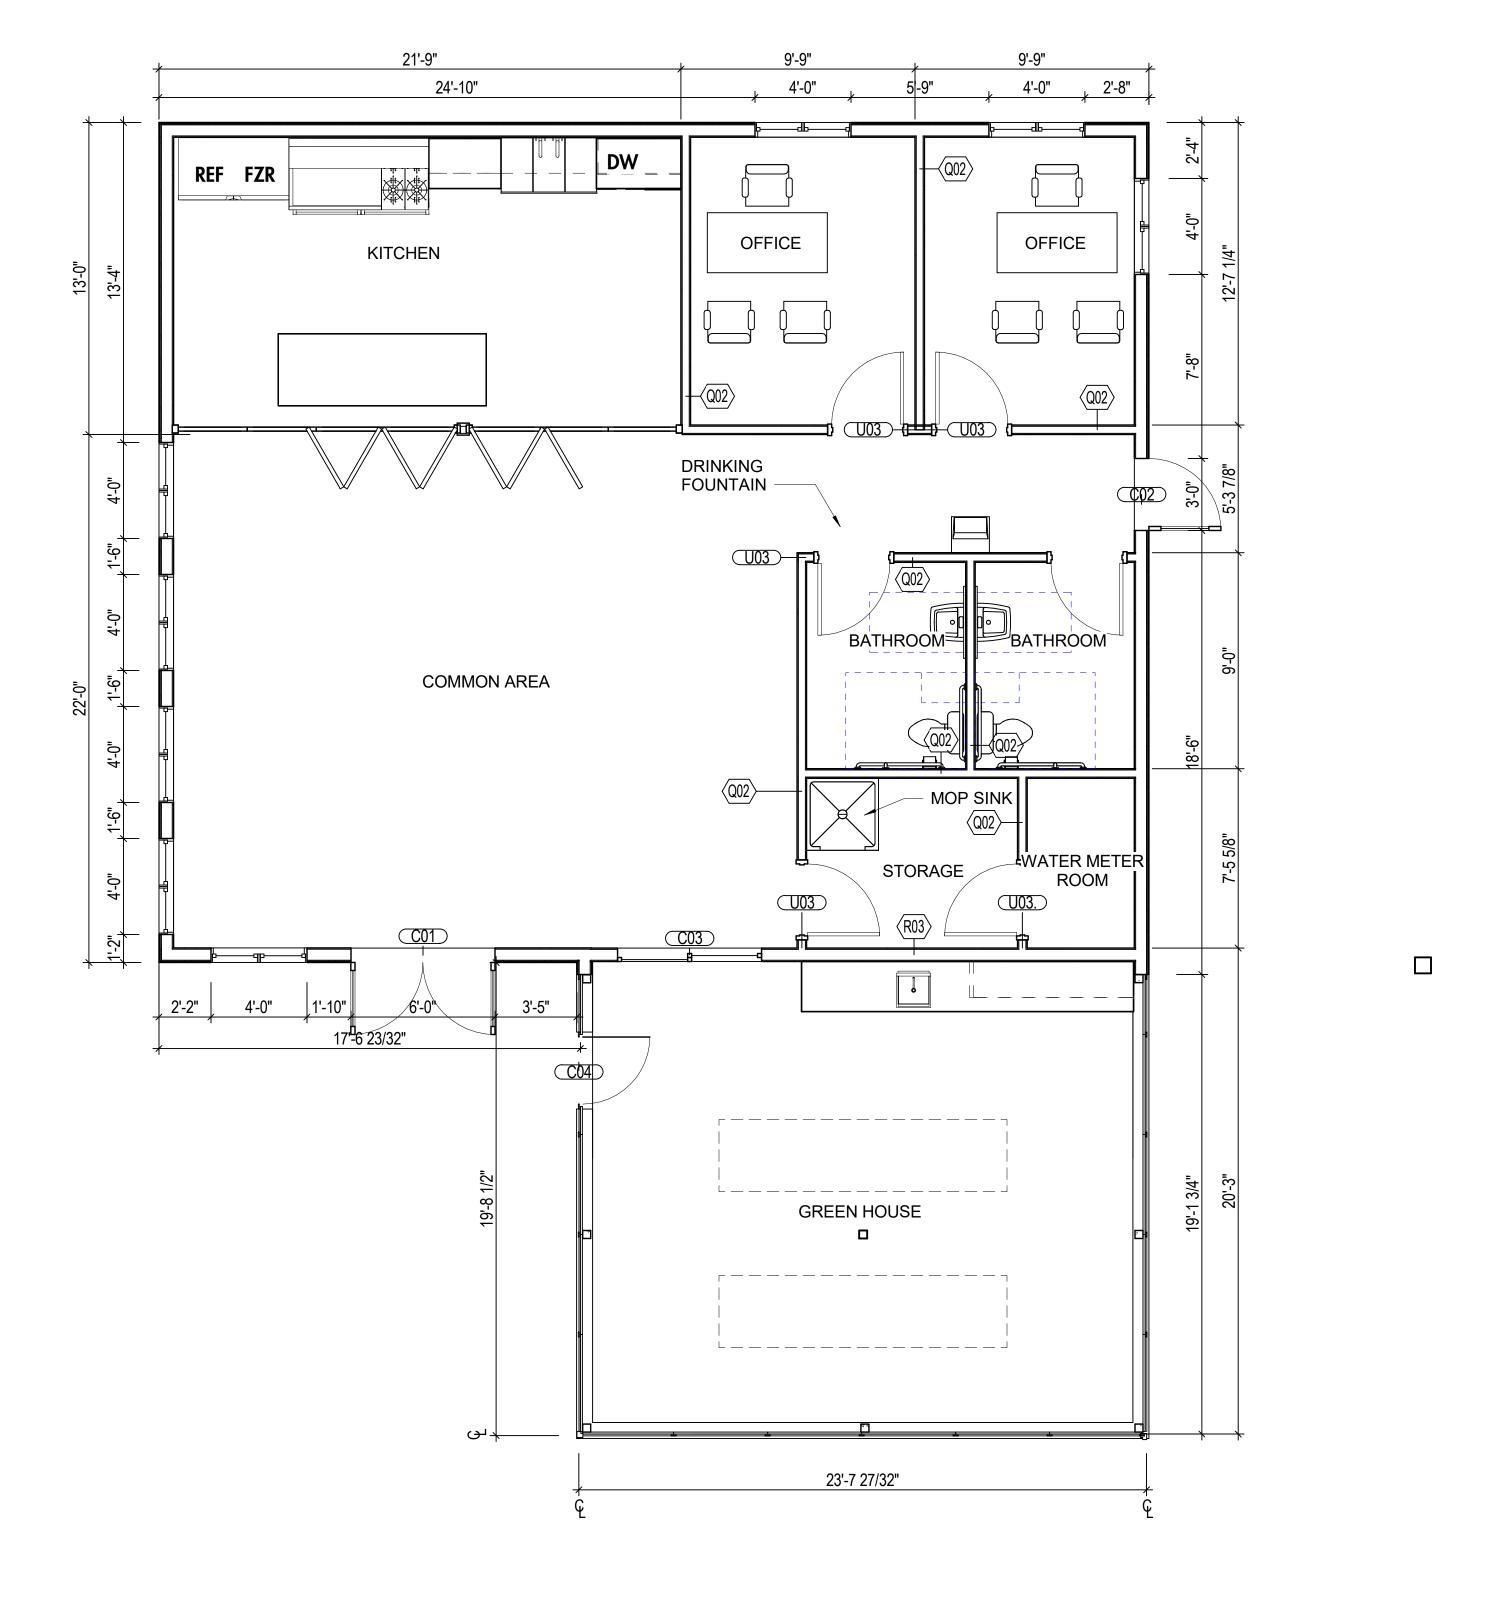


Plan North

GENERAL NOTES - FLOOR PLANS

- 616.5' CIVIL = 616'-6" ARCHITECTURAL.
 DIMENSIONS AT BUILDING EXTERIOR, MASONRY VENEER ARE MEASURED TO EXT. F.O. MASONRY.
- DIMENSIONS AT BUILDING EXTERIOR, NON-MASONRY VENEER ARE MEASURED TO EXT. F.O. WOOD STUD FRAMING.
 DIMENSIONS AT BUILDING INTERIOR ARE MEASURED TO NOMINAL FACE OF FINISHED GYPSUM BOARD UNLESS
 - OTHERWISE NOTED.
- 5. SEE UNIT PLANS FOR DWELLING UNIT INFORMATION.
 6. SEE FINISH SCHEDULE AND PLANS FOR FINISH INFORMATION.

DRAWN BY CHECKED BY

FIRST FLOOR PLAN

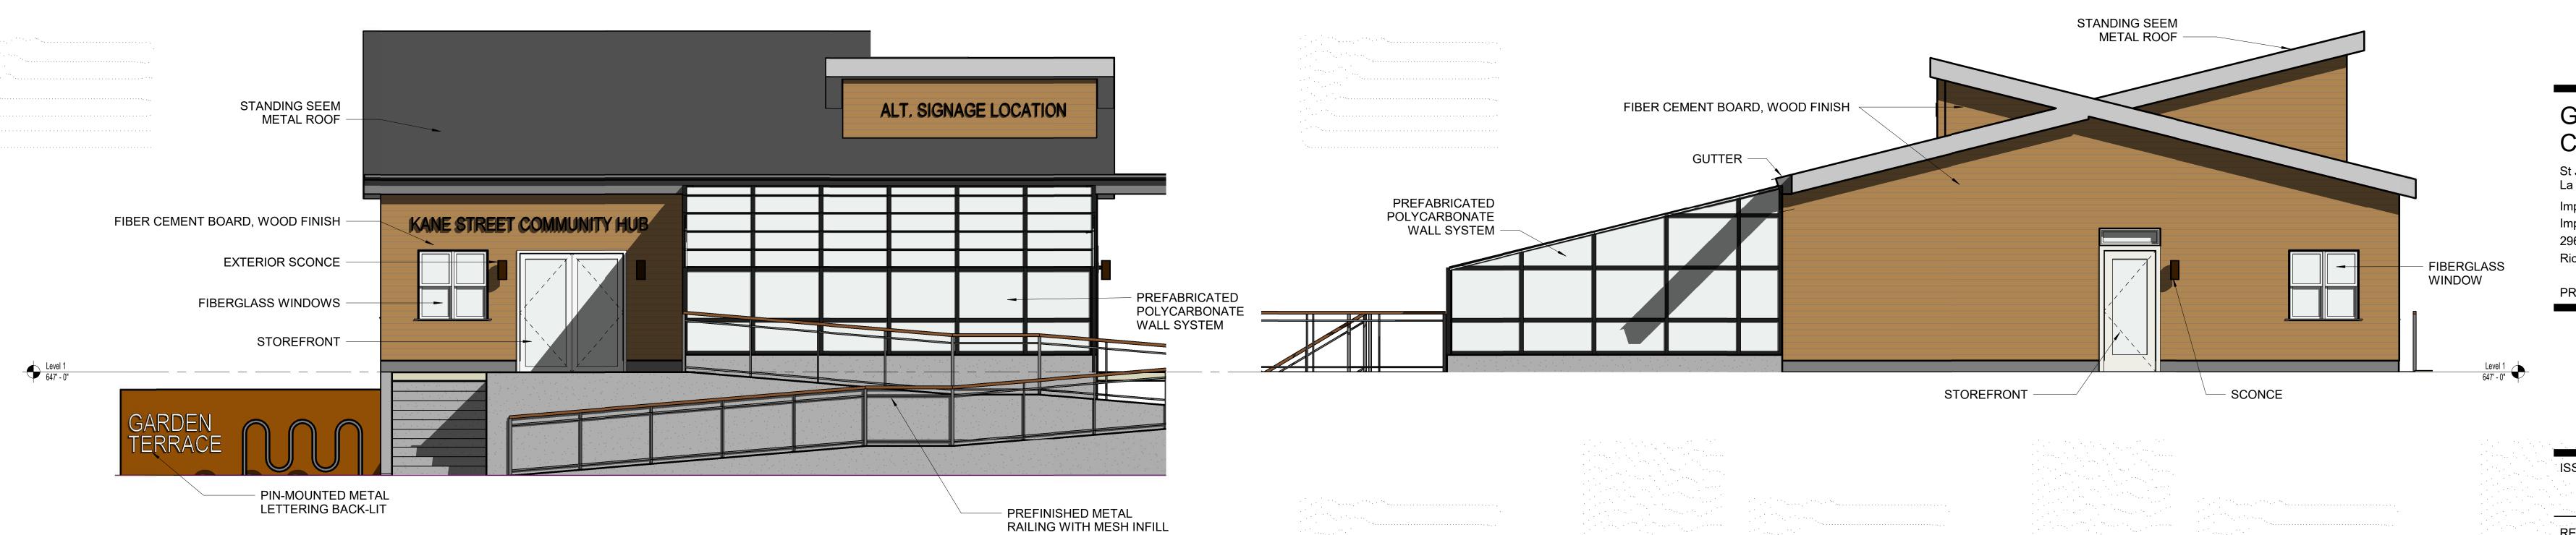

Garden Terrace -Community Center St James Street La Crosse, WI Impact La Crosse, LLC Impact Seven 2961 Decker Drive Rice Lake, WI 54868

ISSUED FOR:	
CITY REVIEW SET	12-01-2017
	and the second s
REVISION FOR:	DATE
NO. DESCRIPTI	ON

CHECKED BY

BUILDING ELEVATIONS




SOUTH ELEVATION

SCALE: 1/4" = 1'-0"

NORTH ELEVATION

SCALE: 1/4" = 1'-0"

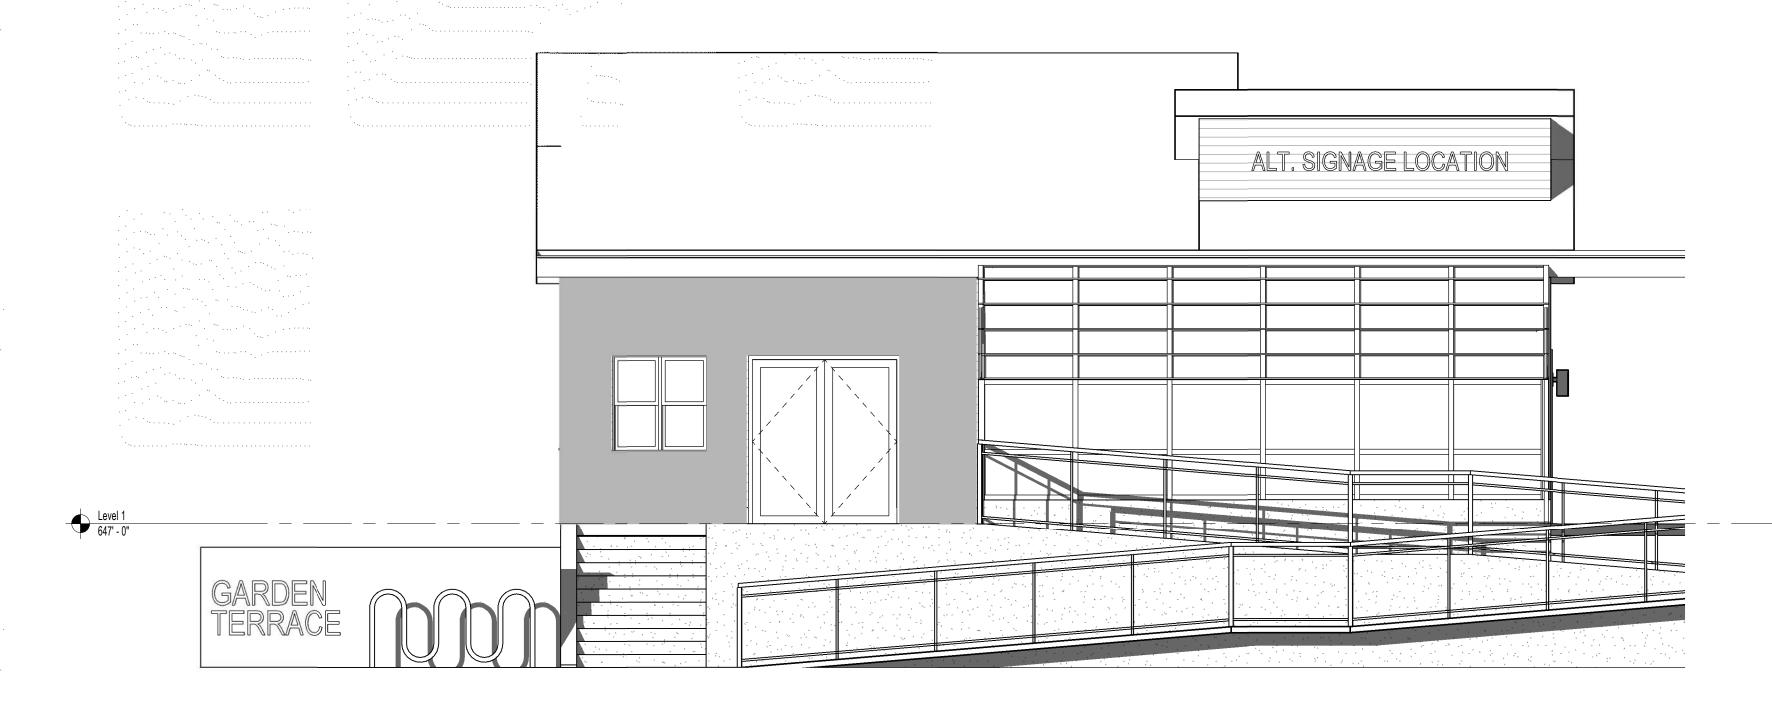


OVERALL SOUTH ELEVATION- street-facing

1 facade 20% study
SCALE: 1/4" = 1'-0"

OVERALL WEST

2 facade 20% study
SCALE: 1/4" = 1'-0"

ELEVATION- street-facing

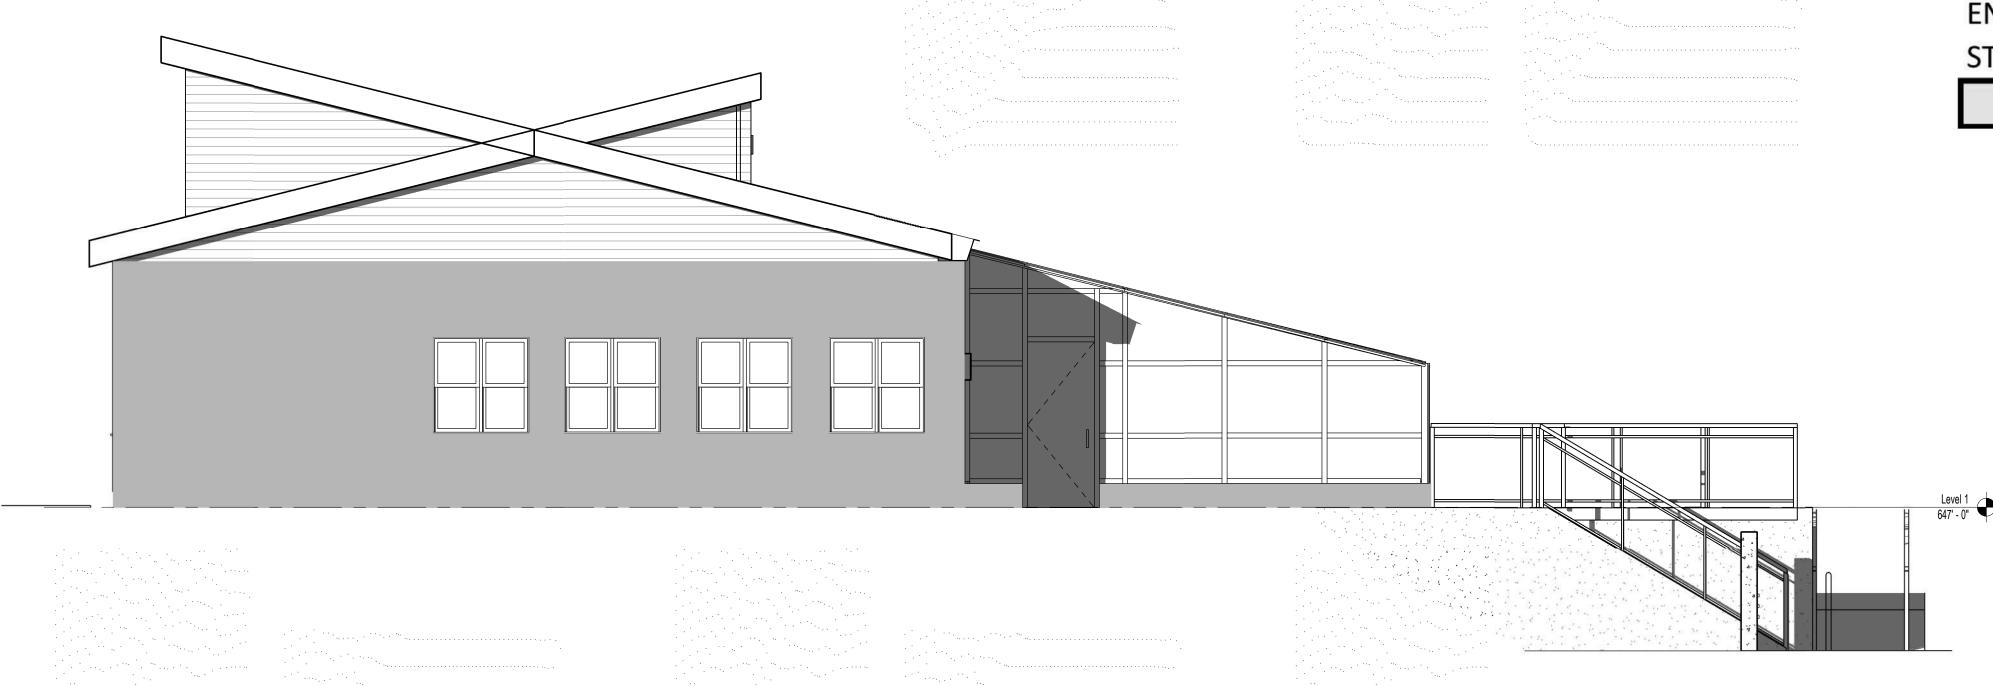

WINDOWS / DOOR AREA ON STREET FACADE 20% MINIMUM REQUIREMENT

SOUTH ELEVATION								
	410.43 sf							
window / door area minimum requirement 20%			82.086 sf					
WINDOW TYPE	SF	UNITS	TOTAL					
TYPE A	16	4	64 sf					
STOREFRONT	146.52	1	146.52 sf					
TOTAL AREA WINDOWS/DOOR			210.52 sf					

NORTH ELEVATIO	N	
TO	TAL WALL	521.26
indow / door area minimum requirement	20%	104.252

WINDOW TYPE	SF	UNITS	TOTAL	
TYPE A	16	1	16 sf	
ENTRY DOOR	54.61	1	54.61 sf	
STOREFRONT	231.43	1	231.43	
	TOTAL AREA WINDOWS/DOOR			



MILWAUKEE | MADISON | TUSCON | CHICAGO

Garden Terrace Community Center
St James Street
La Crosse, WI

La Crosse, WI
Impact La Crosse, LLC
Impact Seven
2961 Decker Drive
Rice Lake, WI 54868

ROJECT NUMBER

ISSUED FOR:
CITY REVIEW SET 12-01-2017

REVISION FOR: DATE
NO. DESCRIPTION

CHY REWEW SET - NOT POR CONSTRUCTION OF SET - NOT SET -

DRAWN BY

CHECKED BY

STREET FACING FACADE STUDY-DESIGN REVIEW CHECKLIST- K.7

A402