

BRIDGEVIEW PLAZA PICKLEBALL FACILITY 2400 ROSE ST, LA CROSSE, WI 54603

GENERAL NOTES

- THE CONTRACTOR SHALL BE RESPONSIBLE FOR VERIFYING ALL EXISTING CONDITIONS INCLUDING LOCATIONS OF EXISTING UTILITIES AND EASEMENTS.
- ALL WORK SHALL BE IN COMPLIANCE WITH LOCAL, STATE AND NATIONAL CODES FOR RESPECTIVE TRADES.
- DO NOT SCALE DRAWINGS.
- THE CONTRACTOR SHALL VERIFY ALL DIMENSIONS.
- DRAWINGS AND SPECIFICATIONS ARE TO BE CONSIDERED AS SUPPLEMENTING EACH OTHER. WORK SPECIFIED, BUT NOT SHOWN, OR SHOWN BUT NOT SPECIFIED SHALL BE PERFORMED AS THOUGH MENTIONED IN BOTH SPECIFICATIONS AND DRAWINGS.
- THE CONTRACTOR SHALL BE RESPONSIBLE FOR PROVIDING EXPANSION/CONTROL JOINTS IN ALL MATERIALS, SYSTEMS AND BUILDING CONFIGURATIONS INCLUDING CAULKING AS REQUIRED. JOINTS SHALL BE PLACED NO MORE THAN 30 TIMES THE SLAB THICKNESS O.C. BOTH DIRECTIONS IN CONCRETE SLABS, 20' TO 25' O.C. FOR MASONRY WALLS AND 20' TO 30' O.C. BOTH DIRECTIONS FOR GYPSUM BOARD WALLS, SOFFITS, CEILINGS,
- INFORMATION PERTAINING TO EXISTING CONDITIONS IS BASED ON AVAILABLE RECORDS AND/OR VISUAL INSPECTION OF THE EXISTING CONDITIONS. WHILE SUCH DATA HAS BEEN COLLECTED WITH REASONABLE CARE, THERE IS NO EXPRESS OR IMPLIED GUARANTEE THAT CONDITIONS SO INDICATED ARE ENTIRELY REPRESENTATIVE OF THOSE ACTUALLY EXISTING. CONTRACTORS SHALL NOTIFY THE ARCHITECT AT ONCE OF ANY DISCREPANCIES BETWEEN THE DRAWINGS AND ACTUAL CONDITIONS ENCOUNTERED. ALL EXISTING BUILDING/FLOOR HEIGHTS AND DIMENSIONS WHERE NEW WORK OCCURS SHALL BE VERIFIED BY ALL TRADES PRIOR TO STARTING CONSTRUCTION.
- THE OWNER AND/OR CLIENT HAS ASSUMED RESPONSIBILITY FOR ALL BIDDING, AND RELATED DETAILS.
- ALL DETAILS NOT INDICATED SHALL BE THE RESPONSIBILITY OF THE OWNER AND CONTRACTOR.

PROJECT DIRECTORY

OWNER: TODD PAGE 9447 JANCING AVE, SPARTA, WI 54656 PHONE: 608.343.8803


ARCHITECT:

RIVER VALLEY ARCHITECTS, INC. 3300 BIRCH STREET, SUITE IA EAU CLAIRE, WI 54703 PHONE: 715.832.0875

LOCATION MAP




LA CROSSE, WI 54603

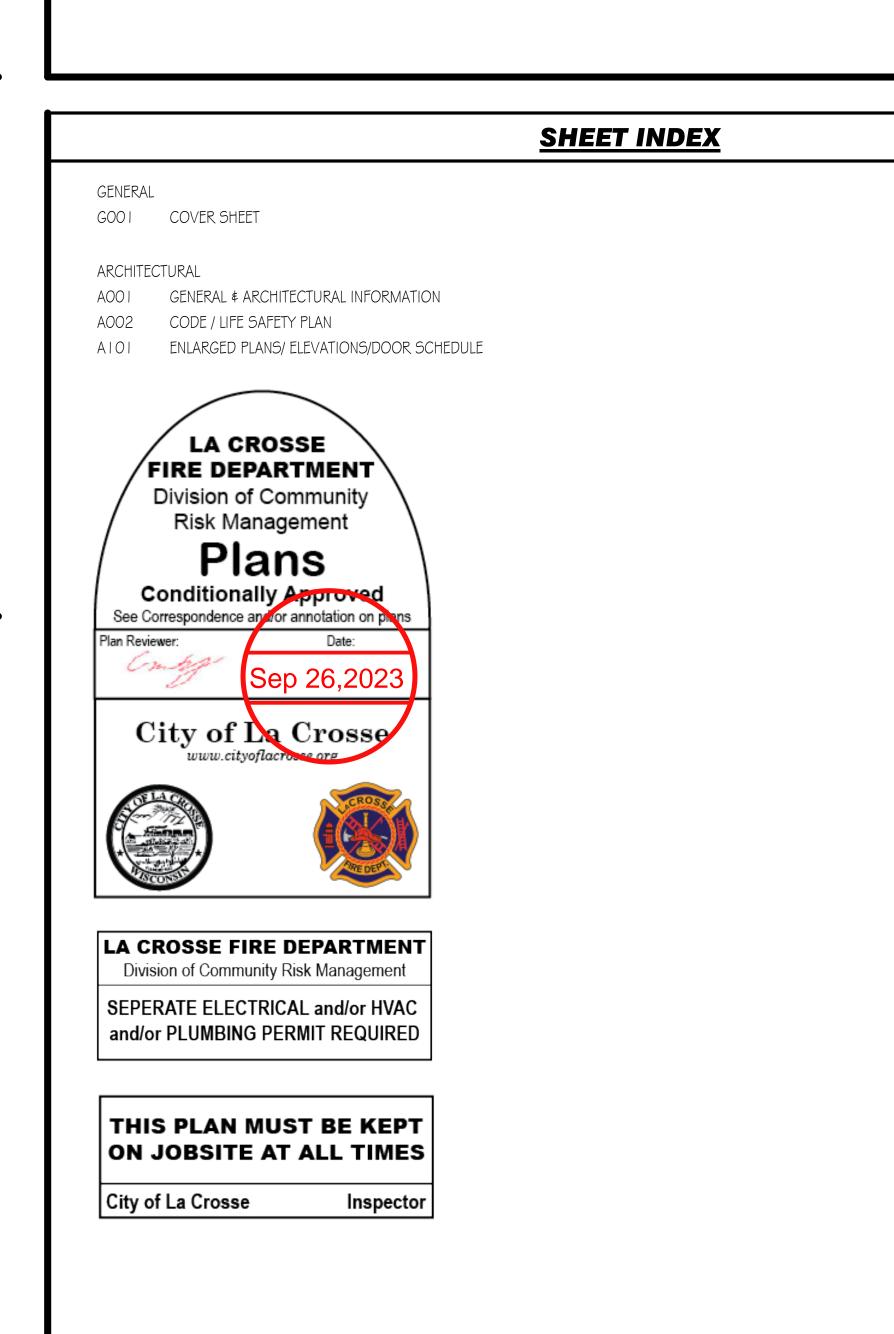

DRAWN BY: 09.25.2023 COVER SHEET

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ARCHITECT

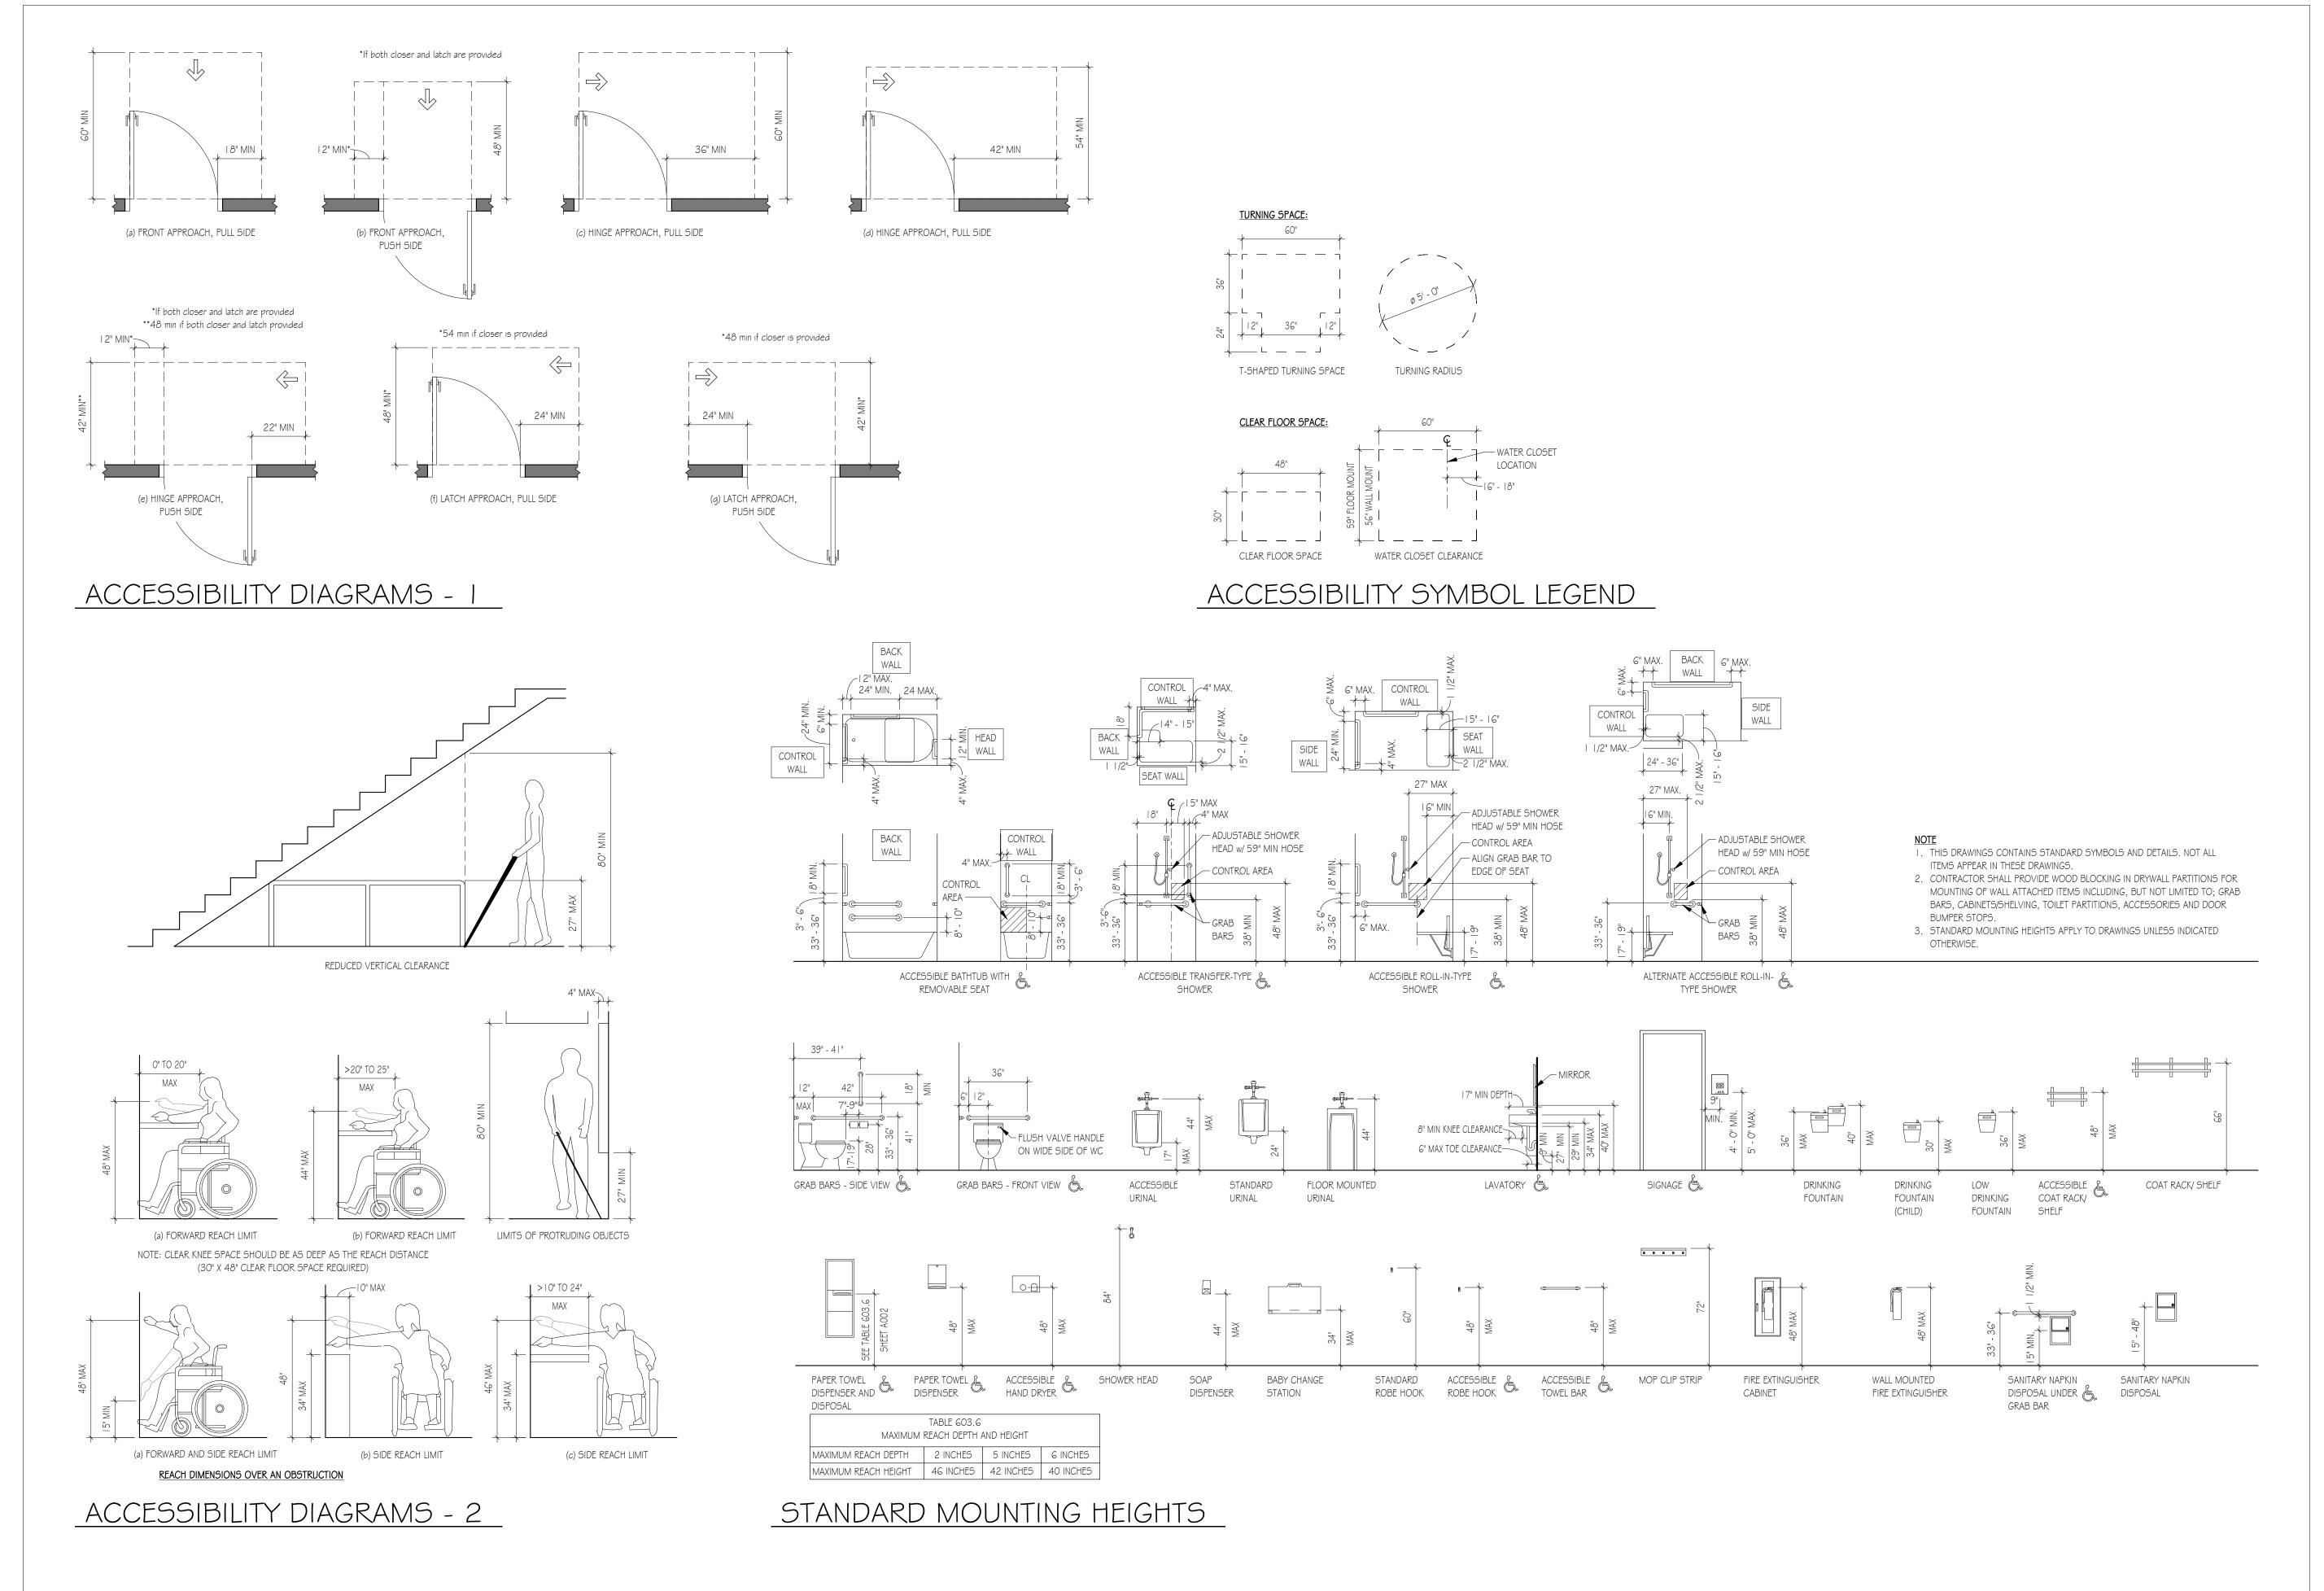

BRIDGEVIEW PLAZA PICKLEBALL F 2400 ROSE ST. LA CROS

DRAWN BY: JOB NO: DATE: 09.25.2023 GENERAL & ARCHITECTUR/ INFORMATION

APPLICABLE CODES

BUILDING CODE: 2015 INTERNATIONAL BUILDING CODE (IBC) WITH WISCONSIN

ACCESSIBILITY CODE: STANDARD FOR ACCESSIBLE AND USABLE BUILDINGS AND FACILITIES - ANSI A I 17.1-2009

ENERGY CODE: 2015 INTERNATIONAL ENERGY CONSERVATION CODE (IECC)

OCCUPANCY CLASSIFICATION

IBC CHAPTER 3

BUILDING = M OCCUPANCYUNIT B = A-3 OCCUPANCY

ALLOWABLE BUILDING HEIGHT & AREA IBC CHAPTER 5

BUILDING HEIGHT: 18'2" NUMBER OF STORIES:

ALLOWABLE BUILDING HEIGHT PER TABLE 504.3 \$ 504.4:

STORIES = 3

ALLOWABLE BUILDING AREA PER TABLE 506.2 = 38,000 SQ. FT ALLOWABLE BUILDING AREA PER SECTION 507.4 = UNLIMITED

TYPE OF CONSTRUCTION

IBC CHAPTER 6

TYPE IIB CONSTRUCTION

FIRE RESISTANCE RATING REQU	FIRE SEPERATION RATING			
BUILDING ELEMENT	FIRE SEPERATION DISTANCE (FEET)	REQ'D	PROVID	
PRIMARY STRUCTURAL FRAME	-	0	0	
BEARING WALLS - EXTERIOR	X>=60	0	0	
BEARING WALLS - INTERIOR	-	0	0	
NONBEARING WALLS AND PARTITIONS - EXTERIOR	-	0	0	
NONBEARING WALLS AND PARTITIONS - INTERIOR	-	0	0	
FLOOR CONSTRUCTION AND ASSOCIATED SECONDARY MEMBERS	-	0	0	
ROOF CONSTRUCTION AND ASSOCIATED SECONDARY MEMBERS	-	0	0	

FIRE PROTECTION

IBC CHAPTER 9

IBC CHAPTER 10

SECTION 903 - AUTOMATIC SPRINKLER SYSTEMS

SPRINKLER REQUIREMENTS: EXISTING COMPLETE NFPA 13 SECTION 906 - PORTABLE FIRE EXTINGUISHERS SEE CODE PLAN

SECTION 907 - FIRE ALARM DETECTION SYSTEMS

ALARM REQUIREMENTS: EXISTING / NA

MEANS OF EGRESS ILLUMINATION

- IBC 1008.3.2 BUILDINGS. IN THE EVENT OF POWER SUPPLY FAILURE IN BUILDINGS THAT REQUIRE TWO OR MORE MEANS OF EGRESS, AN EMERGENCY ELECTRICAL SYSTEM SHALL AUTOMATICALLY ILLUMINATE ALL THE FOLLOWING AREAS:
- I. INTERIOR EXIT ACCESS STAIRWAYS AND RAMPS.
- 2. INTERIOR AND EXTERIOR EXIT STAIRWAYS AND RAMPS.
- 3. EXIT PASSAGEWAYS.
- 4. VESTIBULES AND AREAS ON THE LEVEL OF DISCHARGE USED FOR EXIT DISCHARGE. 5. EXTERIOR LANDINGS FOR EXIT DOORWAYS THAT LEAD DIRECTLY TO THE EXIT

THE EMERGENCY POWER SYSTEM SHALL PROVIDE POWER FOR NOT LESS THAN 90 MINUTES. ILLUMINATION UNDER NORMAL POWER SHALL BE NOT LESS THAN I FOOT-CANDLE AT THE WALKING SURFACE. ILLUMINATION UNDER EMERGENCY POWER SHALL BE NOT LESS THAN AN AVERAGE OF I FOOT-CANDLE, AND A MINIMUM AT ANY POINT OF O. I FOOT-CANDLE MEASURED ALONG THE PATH OF EGRESS AT FLOOR LEVEL.

EXIT REQUIREMENTS					
LEVEL	OCCUPANCY LOAD	EGRESS WIDTH REQUIRED (INCHES)	EGRESS WIDTH PROVIDED (INCHES)		
FIRST FLOOR	299	60	184		

OCCUPANT LOAD

OCCUPANCY CALCULATIONS FIRST FLOOR 390

TOTAL OCCUPANT LOAD = 390

POSTED OCCUPANCY NOT TO EXCEED 299 OCCUPANTS

PLUMBING SYSTEMS

IBC CHAPTER 29

IBC CHAPTER 10

PLUMBING FIXTURE COUNTS (PER TABLE 2902.1)					
FIXTURE	REQUIRED	PROVIDED			
VATER CLOSETS (MALE)	2	3			
JRINALS	0	0			
VATER CLOSETS (FEMALE)	2	3			
AVATORIES (MALE)	1	3			
AVATORIES (FEMALE)	1	3			
WATER COOLERS	1	I			

BRIDGEVIEW PLAZA PICKLEBALL F 2400 ROSE ST. LA CROS


DRAWN BY: JOB NO: 23-139 DATE: 09.25.2023 CODE / LIFE SAFETY PLAN

1210.2.1 Floors and wall bases. In other than dwelling units, toilet, bathing and shower room floor finish materials shall have a smooth, hard, nonabsorbent surface. The intersections of such floors with walls shall have a smooth, hard, nonabsorbent vertical base that extends upward onto the walls not less than 4 inches (102 mm).


1210.2.2 Walls and partitions. Walls and partitions within 2 feet (610 mm) of service sinks, urinals and water closets shall have a smooth, hard, nonabsorbent surface, to a height of not less than 4 feet (1219 mm) above the floor, and except for structural elements, the materials used in such walls shall be of a type that is not adversely affected by moisture.

ENLARGED TYP. TOILET ROOM PLAN


3/8" = 1'-0"

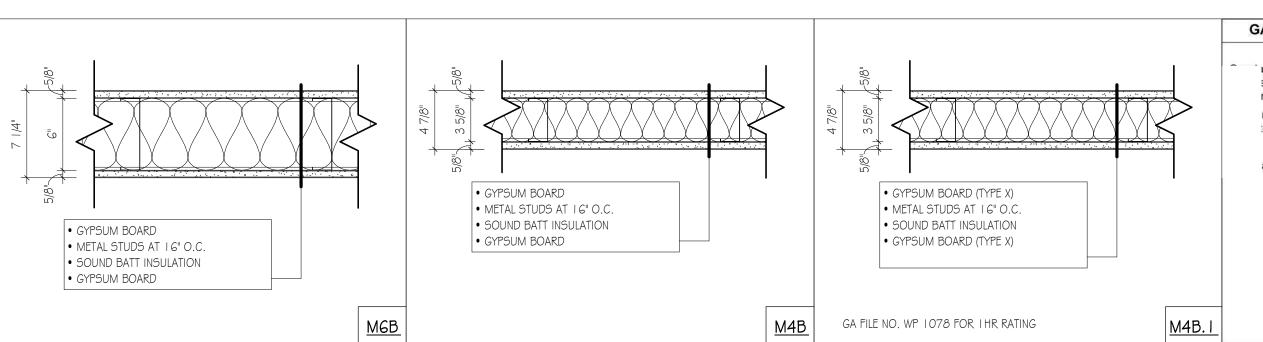


DOOR SCHEDULE DOOR FRAME DOOR NUMBER MATERIAL HEIGHT TYPE MATERIAL TYPE ALUMINUM 6' - 0" 7' - 0" ALUMINUM 101 SF-I 102 3' - 0" 7' - 0" WOOD HOLLOW METAL HM-I 103A WOOD 6' - 0" 7' - 0" HM-I HOLLOW METAL 103B ALUMINUM 6' - 0" 7' - 0" SF-2 ALUMINUM 104 7' - 0" WOOD 3' - 0" HM-I HOLLOW METAL 105 3' - 0" 7' - 0" HM-I HOLLOW METAL 106 3' - 0" 7' - 0" WOOD HM-I HOLLOW METAL 107 WOOD 3' - 0" 7' - 0" HOLLOW METAL HM-I

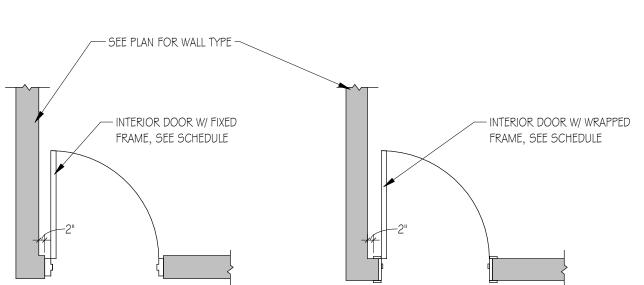



TYPICAL INTERIOR DOOR LOCATIONS

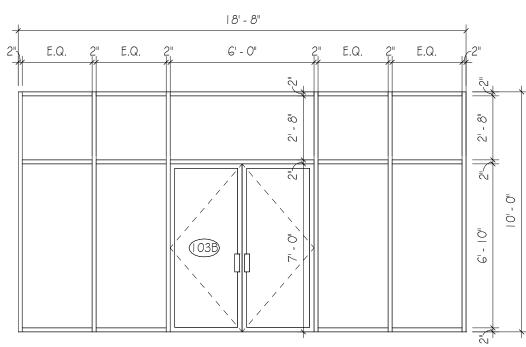



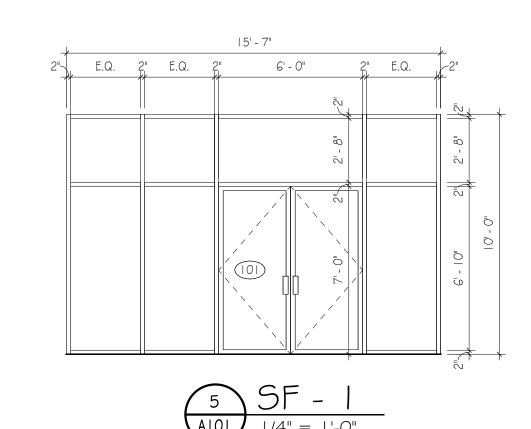


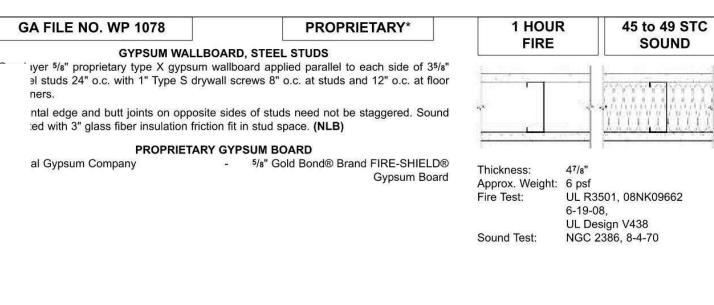

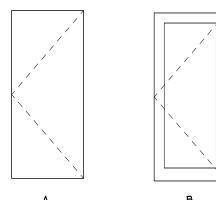


SOLID PANEL


DOOR ELEVATIONS

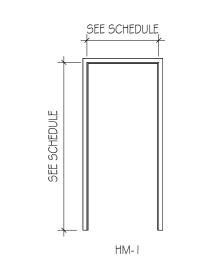

FRAME ELEVATIONS

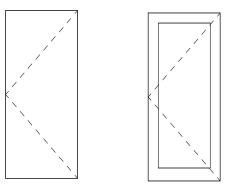

KEY NOTES

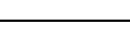

- ALIGN FACE OF GYP. BOARD WITH FACE OF BRICK
- 2 FRAME AREA FOR FUTURE INSTALLATION OF W 6'-0" X H 7'-0" DOUBLE DOOR

A. ALL INTERIOR DIMENSIONS ARE FROM FACE OF STUD/ MASONRY

CONSTRUCTION TO FACE OF STUD/MASONRY CONSTRUCTION,

B. "CLEAR DIMENSIONS" ARE DIMENSIONED FROM FACE OF FINISH

. GENERAL CONTRACTOR SHALL COORDINATE WITH OWNER, BEFORE INSTALLATION OF GYPSUM BOARD, ANY WOOD BLOCKING, BACKING

AND MOUNTING BOARDS REQUIRED FOR OWNER PROVIDED ITEMS.

O. ALL WALLS MUST BE ELEVATED TO 10'- 0", UNLESS NOTED

- 3 WALL TO EXTEND TO BOTTOM SIDE OF ROOFDECK
- 4 HI LO WATER FOUNTAIN


GENERAL NOTES


UNLESS NOTED OTHERWISE

MATERIAL TO FACE OF FINISH MATERIAL.

- 5 TOILET PAPER DISPENSER
- 6 VANITY AND MIRROR 7 GRAB BARS
- 8 60"X56" CLEAR FLOOR SPACE
- 9 30"X48" CLEAR FLOOR SPACE
- 10 PAPER TOWEL DISPENSER I I 5'-0" DIA. TURNING CIRCLE

12 EXTEND GYP. BOARD TO COVER BRICK

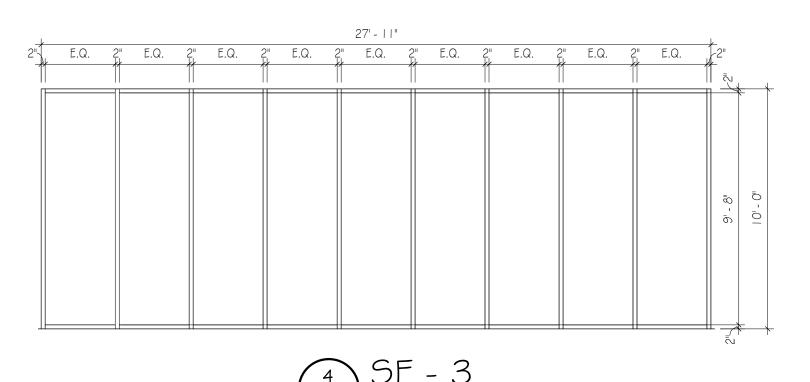

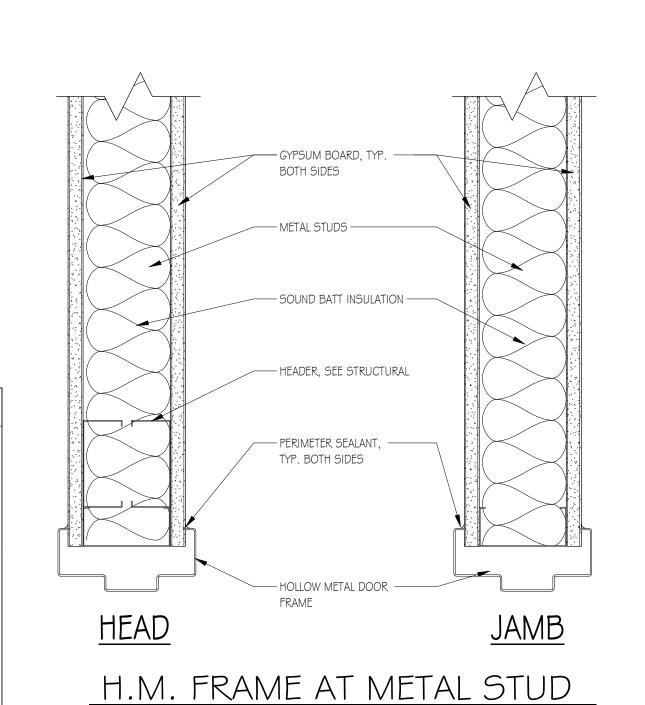

BRIDGEVIEW PLAZA PICKLEBALL 1
2400 ROSE ST. LA CROS

DRAWN BY: JOB NO: DATE: 09.25.2023

ENLARGED PLANS/ ELEVATIONS/DOOR SCHEDULE AIOI