



Change Order Request

Project: 1923025-02
La Crosse Center Expansion & Renovation
400 La Crosse Street
La Crosse, WI 54601

COR # 266.00

Date: 10/12/2021

To: Owner City of La Crosse
400 La Crosse Street
La Crosse, WI 54601

From: Kraus-Anderson Construction Company
151 East Wilson Street, Suite 100
Madison, WI 53703

PCO # 388 - PR 21 Faucets

Item #	Description	Vendor	Amount
1	PR 21 Faucets: Add of 3 hand sinks.	Stafford-Smith, Inc.	\$1,370.15
Total For Change Order			\$1,370.15

Approved By: City of La Crosse

Signed: _____

Date: _____

Submitted By: Kraus-Anderson Construction Company

Signed: *Peter Linsmeier*
6867371012384A6...

Date: 10/12/2021 | 3:27 PM C

Accepted By: I & S Group, Inc.

Signed: *Kevin Bills*
B2D92ADEC10949C...

Date: 10/19/2021 | 9:33 AM C



3414 S. BURDICK, KALAMAZOO, MI 49001 PH. 1-800-968-2442

AIA CHANGE ORDER

CONSTRUCTION MANAGER:

Kraus-Anderson
Weston Gumbert

CHANGE ORDER PROPOSAL #

4

DATE:

9/30/2021

RE: (ASI, RFI, ETC.)

Faucets for PR 21 add of three hand sinks

JOB NAME LaCrosse Center

JOB NUMBER

EQUIPMENT:

ITEM	MANUFACTURER	DESCRIPTION	QTY	ADD	DEDUCT (SOV)
	T&S	EC-3105-VF12	3	\$1,180.59	
				\$1,180.59	\$0.00 SUB TOTAL

RESTOCK FEES:

ITEM	MANUFACTURER	DESCRIPTION	QTY	ADD	DEDUCT
				\$0.00	\$0.00 SUB TOTAL

LABOR:

ITEM	MANUFACTURER	DESCRIPTION	QTY	ADD	DEDUCT
				\$0.00	\$0.00 SUB TOTAL

SHIPPING:

ITEM	MANUFACTURER	DESCRIPTION	QTY	ADD	DEDUCT
	T&S	Faucets	3	\$65.00	
				65	\$0.00 SUB TOTAL

**PLEASE SIGN AND RETURN CHANGE ORDER TO:

STAFFORD-SMITH, INC.
3414 S. Burdick Street
Kalamazoo, MI 49001

Also email signed copy to: kmiller@staffordsmith.com

Accepted

Rejected

ADDED SUBTOTAL		\$1,245.59
SUBTOTAL		\$1,245.59
O&P %	10%	\$124.56
5% labor mark t	5%	
SUBTOTAL		\$1,370.15
TAX	0.00%	\$0.00
BOND		\$0.00
GRAND TOTAL		\$1,370.15

Authorized Signature: _____ Date: _____

Please do not hesitate to contact me if you have any questions. Thank you.

**Pricing can only be guaranteed for 30 days.



AIA® Document G709™ – 2018

Proposal Request

PROJECT: *(name and address)*

La Crosse Center Expansion + Renovation
La Crosse, WI

CONTRACT INFORMATION:

Contract For: General Construction
Date:

Architect's Project Number: 16-19990

Proposal Request Number: 021

Proposal Request Date: August 18, 2020

OWNER: *(name and address)*

City of La Crosse

400 La Crosse Street
La Crosse, WI 54601

ARCHITECT: *(name and address)*

I+S Group, Inc.

201 Main St Suite 1020
La Crosse, WI 54601

CONTRACTOR: *(name and address)*

Kraus-Anderson Construction Company -
Madison

151 East Wilson Street, Suite 100
Madison, WI 53703

The Owner requests an itemized proposal for changes to the Contract Sum and Contract Time for proposed modifications to the Contract Documents described herein. The Contractor shall submit this proposal within Seven (7) days or notify the Architect in writing of the anticipated date of submission.

(Insert a detailed description of the proposed modifications to the Contract Documents and, if applicable, attach or reference specific exhibits.)

- Item 1: See revised plan sheet 3A1-22D – Concourse Level Floor Plan - Area D
 - a. Revised food service equipment based on revised food service plans.
- Item 2: See revised plan sheet 3A1-23C – Ballroom Level Floor Plan - Area C
 - a. Revised food service equipment based on revised food service plans.
- Item 3: See revised plan sheet 3A1-71 – Roof Plan - Overall
 - a. Added section markers at elevator roofs.
- Item 4: See revised plan sheet 3A1-72 – Roof Details
 - a. Revised detail 10 Roof Height Change At Elevator Shaft
- Item 5: See revised plan sheet 3A1-75 – Roof Details
 - a. Added waterproofing to details 2 and 6.
- Item 6: See revised plan sheet 3A5-15 – Enlarged Plans - Area D
 - a. Revised food service equipment based on revised food service plans.
- Item 7: See revised plan sheet 3P2-11D – Concourse Level Domestic Water Plans
 - a. Sanitary Piping layout updated for added handwash sinks and adjusted fixture layout.
- Item 8: See revised plan sheet 3P2-13C - Ballroom Level Domestic Water Plans
 - a. Sanitary Piping layout updated for added handwash sinks and adjusted fixture layout.
- Item 9: See revised plan sheet 3P2-21D – Concourse Level Domestic Water Plans
 - a. Domestic Water Piping layout updated for added handwash sinks and adjusted fixture layout.
- Item 10: See revised plan sheet 3P2-23C - Ballroom Level Domestic Water Plans
 - a. Domestic Water Piping layout updated for added handwash sinks and adjusted fixture layout.
- Item 11: See revised plan sheet 3P3-11 - Concourse Level Drain, Waste, and Vent Isometrics
 - a. Sanitary Piping layout updated for added handwash sinks and adjusted fixture layout.
- Item 12: See revised plan sheet 3P3-12 - Ballroom Drain, Waste, and Vent Isometrics
 - a. Sanitary Piping layout updated for added handwash sinks and adjusted fixture layout.
- Item 13: See revised plan sheet 3P3-21 – Concourse Level Domestic Water Isometrics
 - a. Piping layout updated for added handwash sinks and adjusted fixture layout.
 - b. Piping layout adjusted to serve soda and beer dispensers on counter.
- Item 14: See revised plan sheet 3P3-22 – Ballroom Domestic Water Isometrics
 - a. Piping layout updated for added handwash sinks and adjusted fixture layout.
 - b. Piping layout adjusted to serve dishwasher drain tempering and hot water requirements.
- Item 15: See revised plan sheet 3P4-11 – Plumbing Callouts, Sections and Elevations
 - a. Sanitary Piping layout updated for added handwash sinks and adjusted fixture layout.
- Item 16: See revised plan sheet 3P4-12 – Plumbing Callouts, Sections and Elevations
 - a. Domestic Water Piping layout updated for added handwash sinks and adjusted fixture layout.
- Item 17: See revised plan sheet 3E3-13 – Enlarged Power Plans – Area C
 - a. Updated Hand Sink Faucet receptacle location
 - b. Added Hand Sink Faucet receptacle
- Item 18: See revised plan sheet 3E3-14 – Enlarged Power Plans – Area D
 - a. Added Hand Sink Faucet receptacle
 - b. Revised food service equipment electrical device locations based on revised food service plans.
- Item 19: See revised plan sheet FS101 – Foodservice Ballroom Banquet Kitchen Plan & Schedule

- a. Revised kitchen equipment
- Item 20: See revised plan sheet FS102 – Foodservice Concourse Concession Arena Concessions & Walk-ins Plan & Schedule
 - a. Revised kitchen equipment
- Item 21: See revised plan sheet FS301 – Foodservice Elevations
 - a. Revised kitchen equipment
- Item 22: See revised plan sheet FS302 – Foodservice Elevations
 - a. Revised kitchen equipment
- Item 23: See revised plan sheet FS500 – Foodservice Ballroom Level & Concourse Level Plumbing Rough-In Plan
 - a. Revised plumbing rough-in location
- Item 24: See revised plan sheet FS501 – Foodservice Ballroom Level & Concourse Level Plumbing Schedule & Notes
 - a. Revised plumbing schedule
- Item 25: See revised plan sheet FS700 – Foodservice Ballroom Level Electrical Rough-In Plan
 - a. Revised electrical rough-in location
- Item 26: See revised plan sheet FS701 – Foodservice Concourse & Arena Level Electrical Rough-In Plan
 - a. Revised electrical rough-in location
- Item 27: See revised plan sheet FS702 – Foodservice Arena & Concourse Electrical Schedule
 - a. Revised electrical schedule

THIS IS NOT A CHANGE ORDER, A CONSTRUCTION CHANGE DIRECTIVE, OR A DIRECTION TO PROCEED WITH THE WORK DESCRIBED IN THE PROPOSED MODIFICATIONS.

REQUESTED BY THE ARCHITECT:

Pat Vos, Project Manager

PRINTED NAME AND TITLE




WALL LEGEND

	EXISTING CONSTRUCTION TO REMAIN
	NEW CONSTRUCTION

- SHEET NOTES**
- SHADE INDICATES NO WORK THIS AREA. REFER TO OTHER DISCIPLINES FOR ASSOCIATED WORK THIS AREA.
 - ALL INTERIOR PARTITION WALLS SHALL BE WALL TYPE A3, UNLESS OTHERWISE NOTED.
 - PITCH ALL NEW CONCRETE STOOPS 1/4" PER FOOT AWAY FROM BUILDING.
 - DIMENSIONS ARE FROM FACE OF MASONRY CONCRETE AND CENTER OF STUD FOR STUD WALL, UNLESS NOTED OTHERWISE.
 - REFER TO G-1-21 FOR RATED WALL LOCATIONS.
 - HOUSEKEEPING AND EQUIPMENT PADS BY GENERAL CONTRACTOR. SEE FIRE PROTECTION, PLUMBING, HVAC & ELECTRICAL PLANS FOR LOCATIONS.
 - FIRE STOP ALL PENETRATIONS INCLUDING BUT NOT LIMITED TO STEEL JOISTS & BEAMS, PIPING AND DUCTWORK THRU RATED WALLS.
 - SEE STRUCTURAL PLANS FOR MASONRY WALL BRACING DETAILS.
 - IDENTIFY WITH PAINTED LETTERING "FIRE WALL" AND "FIRE BARRIER WALL" ABOVE CEILING 20'-0" O.C. MAX. BOTH SIDES OF WALL. SEE G-1-21 FOR LOCATIONS OF RATED WALLS.
 - PROVIDE LINTELS AS SHOWN IN STRUCTURAL DRAWINGS ON NON-LOAD BEARING WALL LINTEL SCHEDULE AT ALL NON-BEARING WALL OPENINGS, INCLUDING DUCT OPENINGS.
 - ALL PIPING, CONDUITS AND RELATED MECHANICAL AND ELECTRICAL ITEMS SHALL BE CONCEALED WITHIN GYPSUM BOARD FURRING AS REQUIRED IN FINISHED AREAS WHETHER SHOWN ON DRAWINGS OR NOT, UNLESS NOTED OTHERWISE.
 - PROVIDE BULLNOSE CORNERS AT CMU VERTICAL CORNERS UNLESS OTHERWISE INDICATED. PROVIDE SQUARE EDGE CMU AT VERTICAL CORNERS WHERE CMU IS SCHEDULE TO RECEIVE CERAMIC TILE.
 - ALL NEW EXPOSED CMU TO MATCH BOND OF ADJACENT EXISTING CMU.

KEYNOTE LEGEND

12	INFILL WALL TO MATCH EXISTING ADJACENT WALLS
44	WALL-MOUNT MONITOR. REFER TO TECHNOLOGY DRAWINGS.
47	CONCRETE SLAB INFILL AT URINAL RECESS. REFER TO DETAIL.
50	GAS METER. REFER TO MECHANICAL DRAWINGS.
54	FLOOR DRAIN. REFER TO PLUMBING DRAWINGS.
65	FIN TUBE. REFER TO MECHANICAL DRAWINGS.
E1	EXISTING COLUMN TO REMAIN.

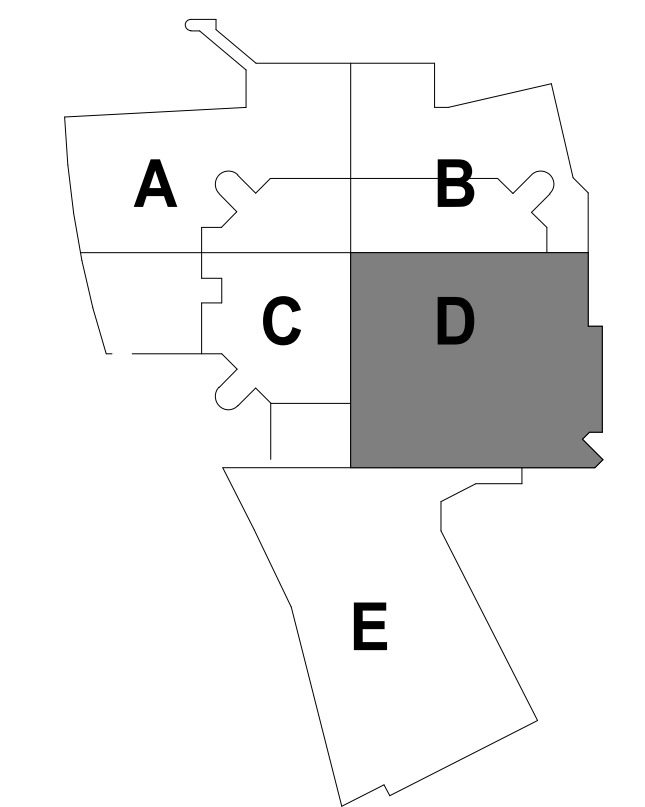

KEYPLAN

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PROJECT

LA CROSSE CENTER EXPANSION & RENOVATION

LA CROSSE WISCONSIN

REVISION SCHEDULE		
DATE	DESCRIPTION	BY
05/15/20	PR 13	JMB
06/05/20	PR 16	JMB
08/18/20	PR 21	JMB



PROJECT NO.	16-19990
FILE NAME	19990 Arch R18.rvt
DRAWN BY	JMB
DESIGNED BY	JPW/KMB
REVIEWED BY	JPW/ KMB
ORIGINAL ISSUE DATE	03/05/20
CLIENT PROJECT NO.	

TITLE


CONCOURSE LEVEL FLOOR PLAN - AREA D

SHEET

3A1-22D

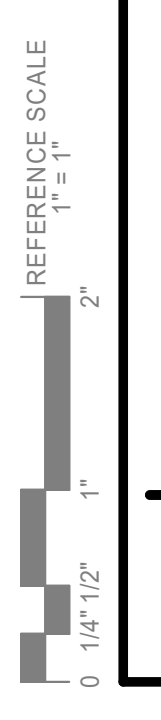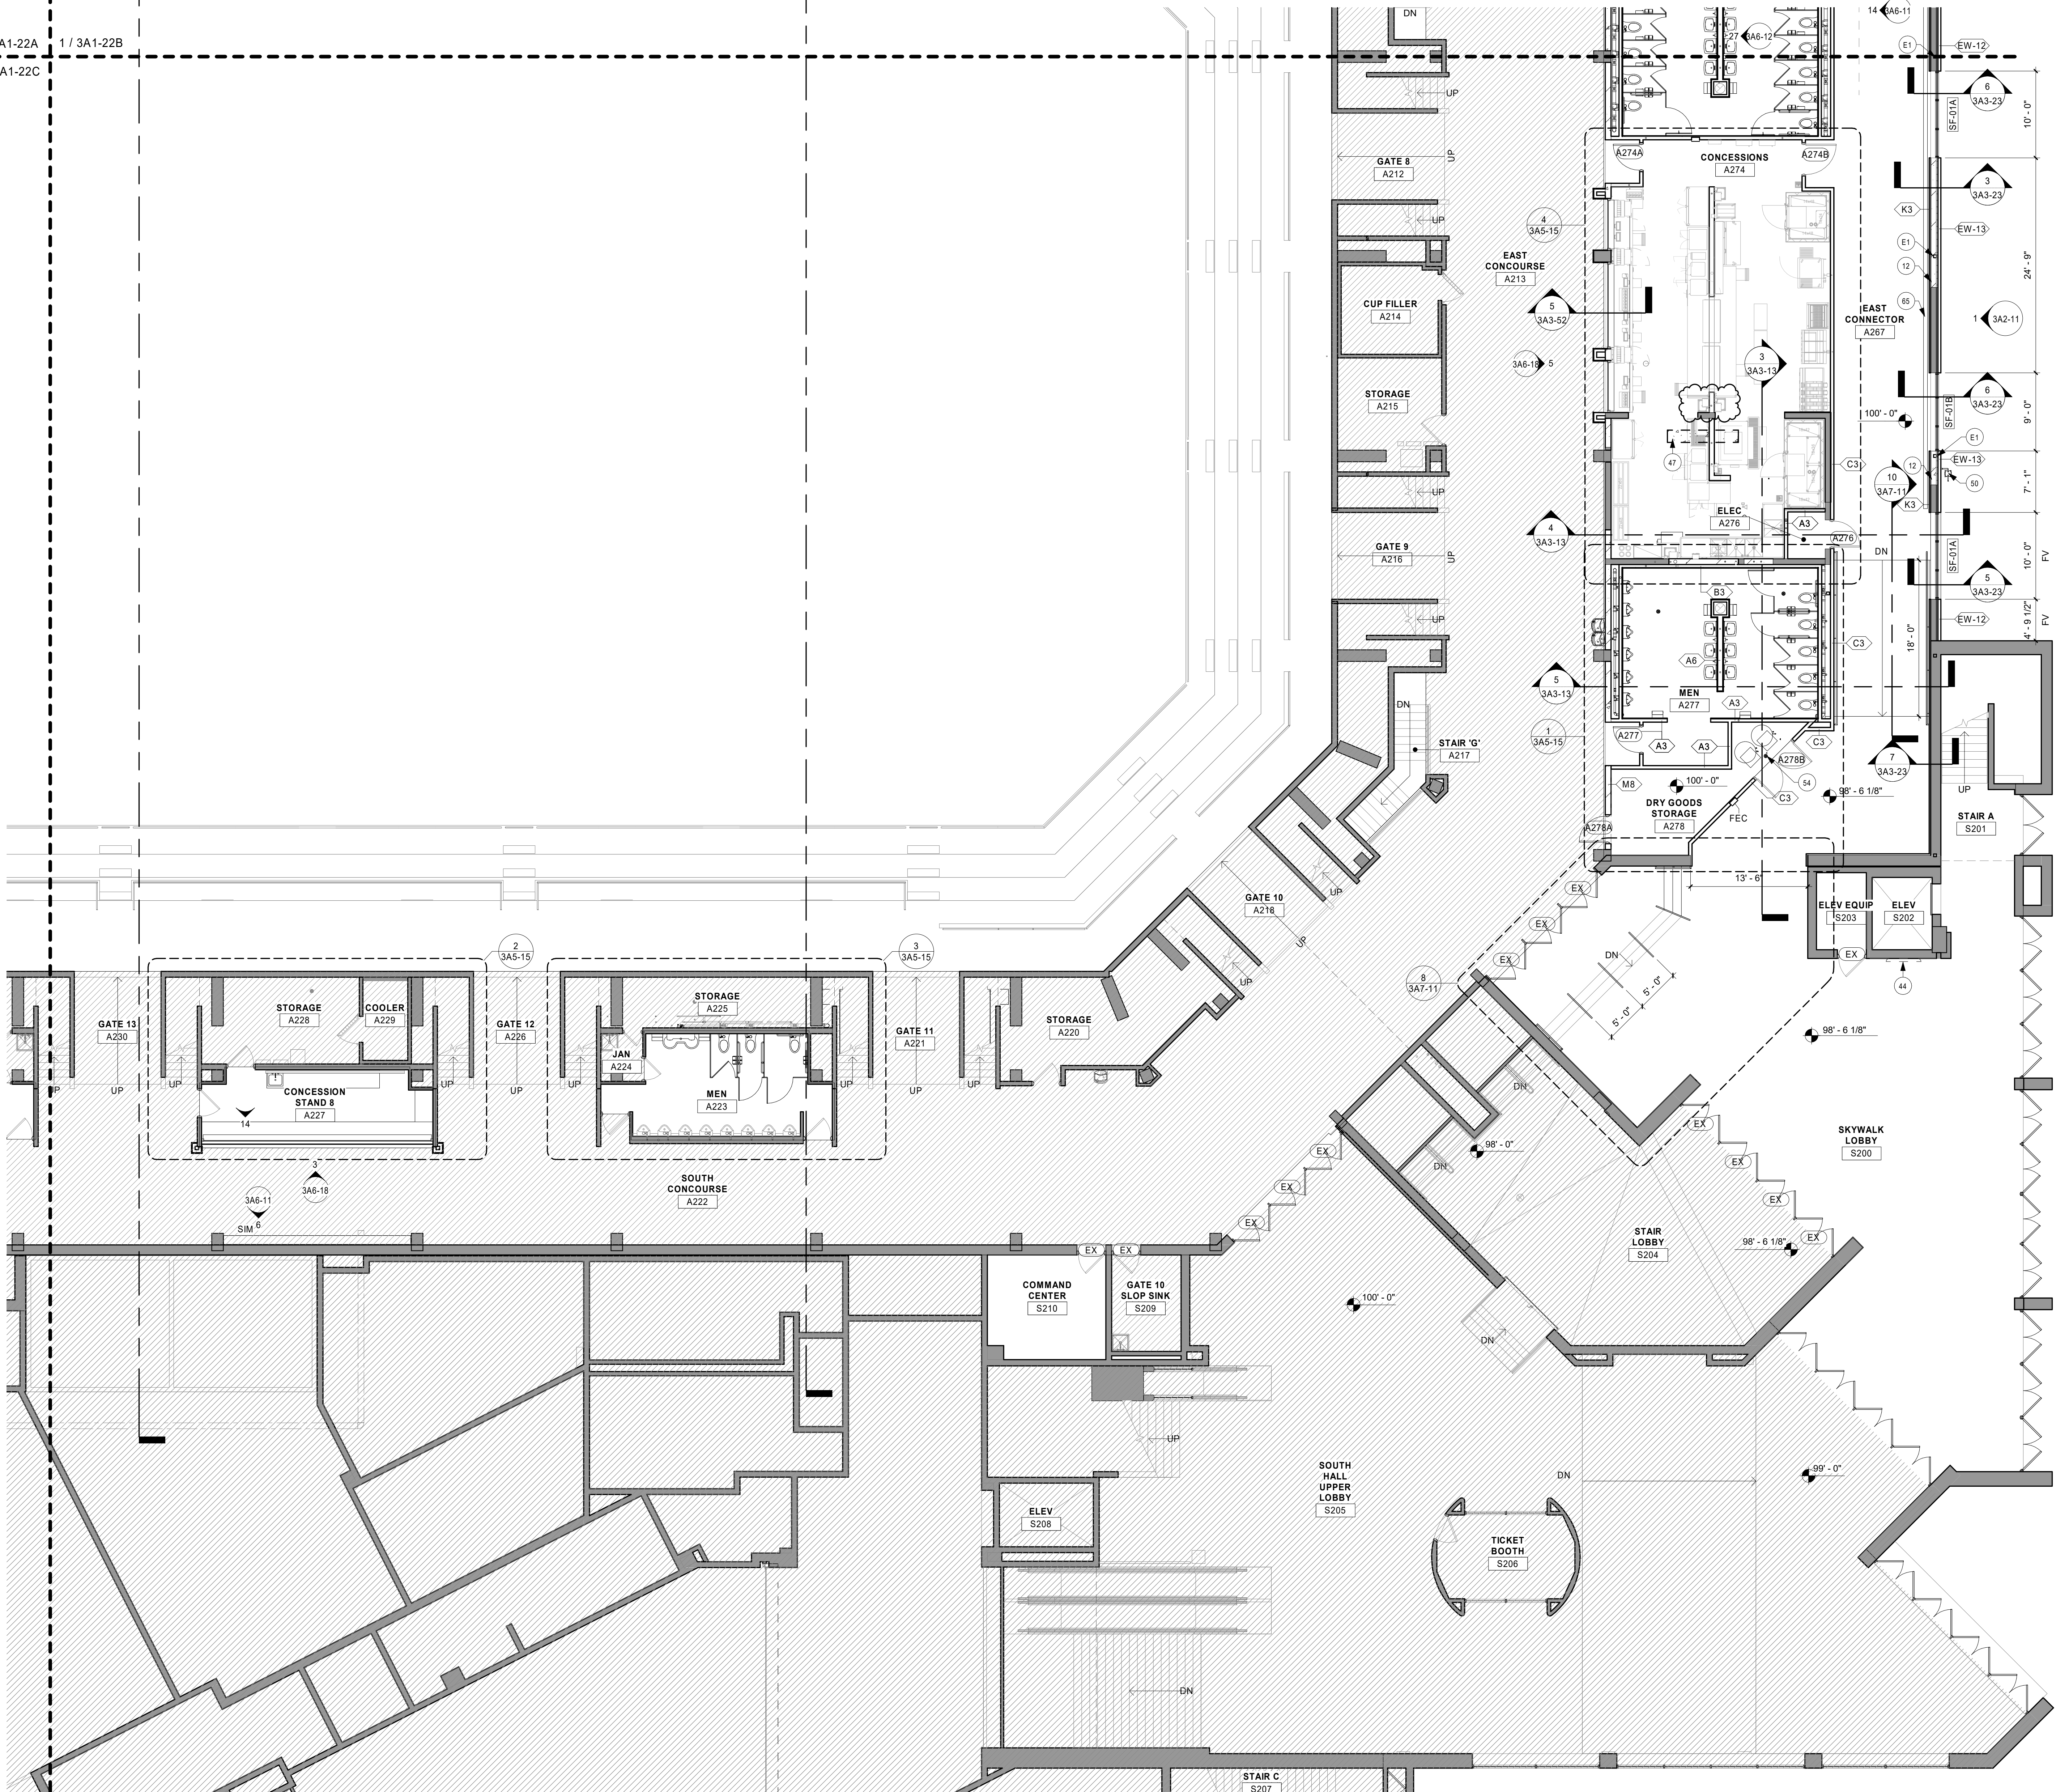


1 CONCOURSE LEVEL FLOOR PLAN - AREA D
1/8" = 1'-0"

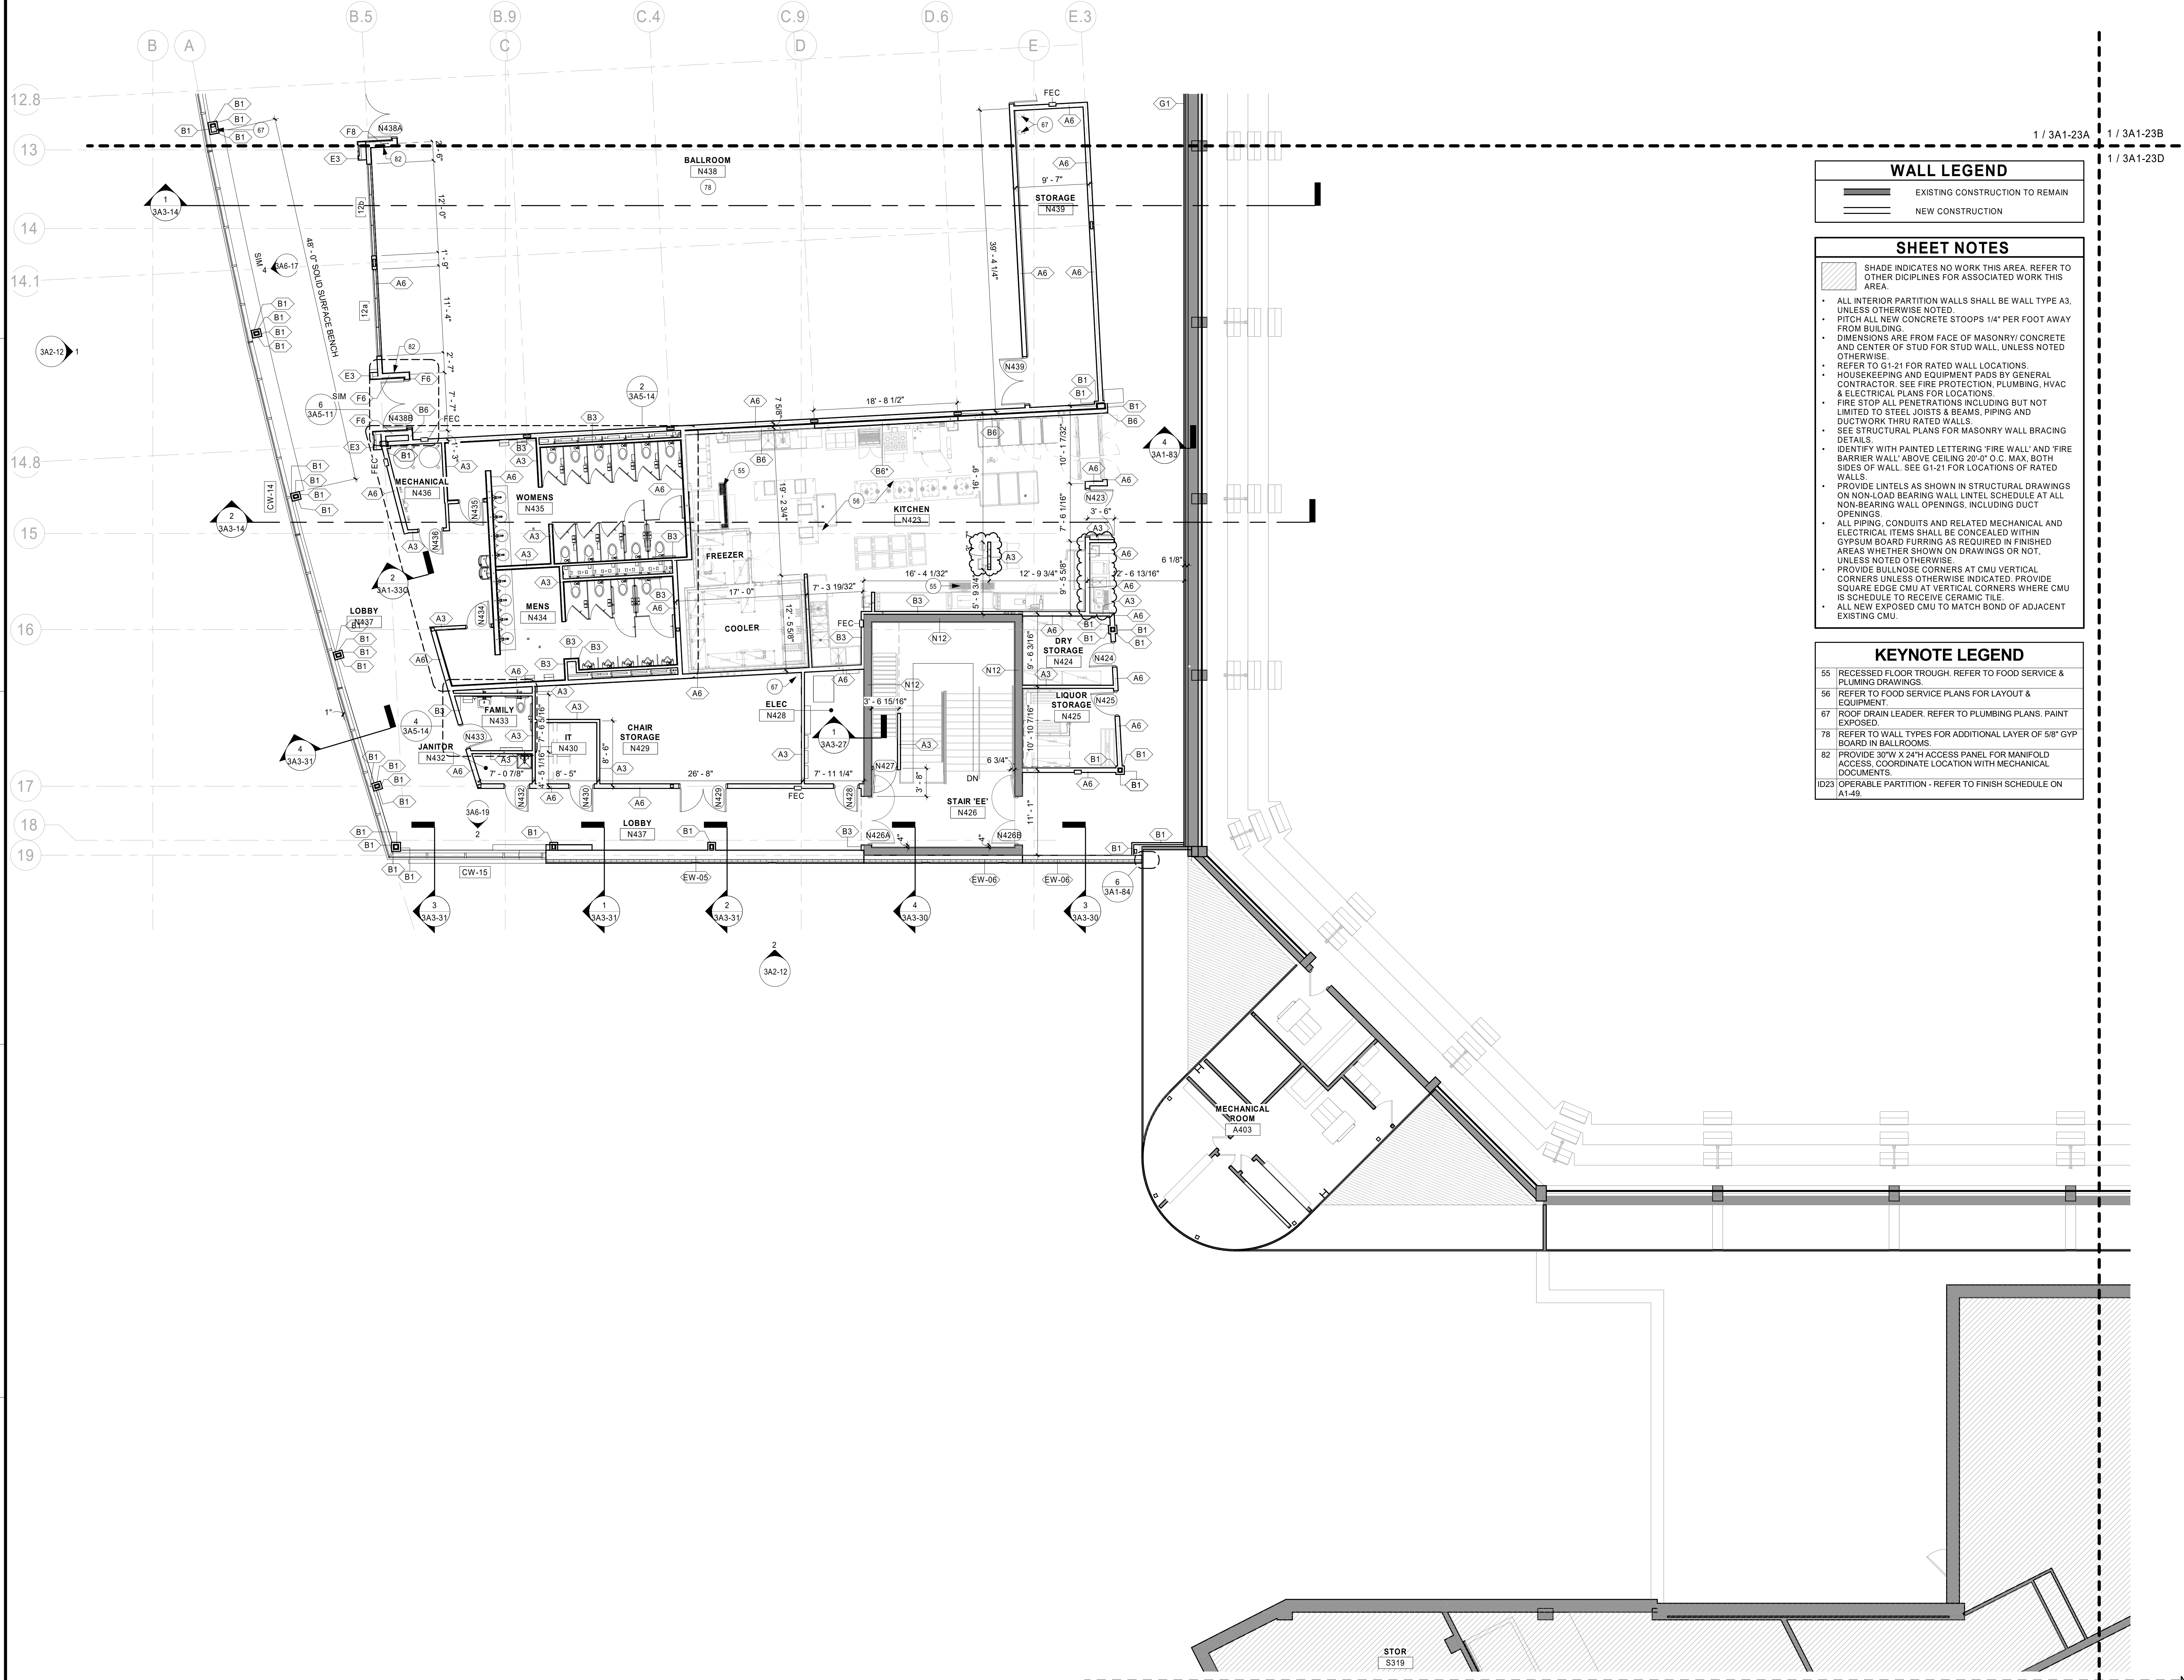

WALL LEGEND	
	EXISTING CONSTRUCTION TO REMAIN
	NEW CONSTRUCTION

- SHEET NOTES**
- SHADE INDICATES NO WORK THIS AREA. REFER TO OTHER DISCIPLINES FOR ASSOCIATED WORK THIS AREA.
 - ALL INTERIOR PARTITION WALLS SHALL BE WALL TYPE A3, UNLESS OTHERWISE NOTED.
 - PITCH ALL NEW CONCRETE STOOPS 1/4" PER FOOT AWAY FROM BUILDING.
 - DIMENSIONS ARE FROM FACE OF MASONRY/ CONCRETE AND CENTER OF STUD FOR STUD WALL, UNLESS NOTED OTHERWISE.
 - REFER TO 03-21 FOR RATED WALL LOCATIONS.
 - HOUSEKEEPING AND EQUIPMENT PADS BY GENERAL CONTRACTOR. SEE FIRE PROTECTION, PLUMBING, HVAC & ELECTRICAL PLANS FOR LOCATIONS.
 - FIRE STOP ALL PENETRATIONS INCLUDING BUT NOT LIMITED TO STEEL JOISTS & BEAMS, PIPING AND DUCTWORK THRU RATED WALLS.
 - SEE STRUCTURAL PLANS FOR MASONRY WALL BRACING DETAILS.
 - IDENTIFY WITH PAINTED LETTERING 'FIRE WALL' AND 'FIRE BARRIER WALL' ABOVE CEILING 20'-0" O.C. MAX. BOTH SIDES OF WALL. SEE G1-21 FOR LOCATIONS OF RATED WALLS.
 - PROVIDE LINTELS AS SHOWN IN STRUCTURAL DRAWINGS ON NON-LOAD BEARING WALL LINTEL SCHEDULE AT ALL NON-BEARING WALL OPENINGS, INCLUDING DUCT OPENINGS.
 - ALL PIPING, CONDUITS AND RELATED MECHANICAL AND ELECTRICAL ITEMS SHALL BE CONCEALED WITHIN GYPSUM BOARD FURRING AS REQUIRED IN FINISHED AREAS WHETHER SHOWN ON DRAWINGS OR NOT, UNLESS NOTED OTHERWISE.
 - PROVIDE BULLNOSE CORNERS AT CMU VERTICAL CORNERS UNLESS OTHERWISE INDICATED. PROVIDE SQUARE EDGE CMU AT VERTICAL CORNERS WHERE CMU IS SCHEDULE TO RECEIVE CERAMIC TILE.
 - ALL NEW EXPOSED CMU TO MATCH BOND OF ADJACENT EXISTING CMU.

- KEYNOTE LEGEND**
- 55 RECESSED FLOOR THROUGH. REFER TO FOOD SERVICE & PLUMBING DRAWINGS.
 - 56 REFER TO FOOD SERVICE PLANS FOR LAYOUT & EQUIPMENT.
 - 67 ROOF DRAIN LEADER. REFER TO PLUMBING PLANS. PAINT EXPOSED.
 - 78 REFER TO WALL TYPES FOR ADDITIONAL LAYER OF 5/8" GYP BOARD IN BALLROOMS.
 - 82 PROVIDE 30"W X 24"H ACCESS PANEL FOR MANIFOLD ACCESS. COORDINATE LOCATION WITH MECHANICAL DOCUMENTS.
 - ID23 OPERABLE PARTITION - REFER TO FINISH SCHEDULE ON A1-49.

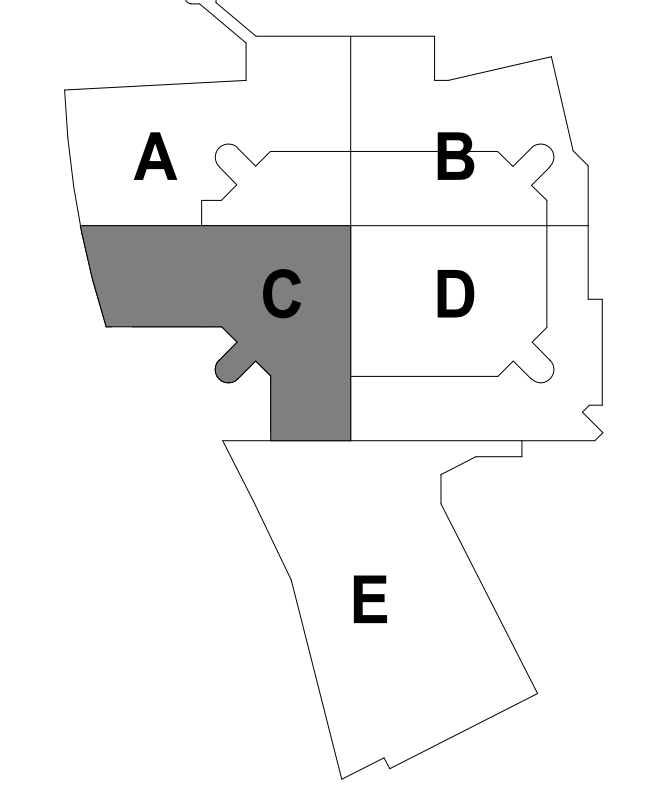

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LA CROSSE CENTER EXPANSION & RENOVATION

REVISION SCHEDULE		
DATE	DESCRIPTION	BY
03/19/20	BP3 ADDENDUM 07	JMB
03/26/20	BP3 ADDENDUM 08	JMB
07/10/20	PR 19	JMB
08/18/20	PR 21	JMB

PROJECT NO.	16-19990
FILE NAME	19990 Arch R18.rvt
DRAWN BY	JMB
DESIGNED BY	JPW/KMB
REVIEWED BY	JPW/ KMB
ORIGINAL ISSUE DATE	03/05/20
CLIENT PROJECT NO.	

BALLROOM LEVEL FLOOR PLAN - AREA C

SHEET
3A1-23C



REFERENCE SCALE
1" = 1'-0"
0 1/4" 1/2" 1" 2"

1 BALLROOM LEVEL FLOOR PLAN - AREA C
1/8" = 1'-0"



- SHEET NOTES**
- INDICATES TAPERED RIGID INSULATION. REFER TO ROOF PLAN FOR INSULATION THICKNESS. (AVERAGE OF R-5.6")
 - INDICATES TAPERED RIGID INSULATION SADDLE. REFER TO DETAIL.
 - RD ROOF DRAIN. REFER TO PLUMBING DRAWINGS.
 - OD OVERFLOW ROOF DRAIN. REFER TO PLUMBING DRAWINGS.
 - EF EXHAUST FAN. REFER TO MECH DRAWINGS.
 - CU CONDENSING UNIT. REFER TO FOOD SERVICE DRAWINGS.
 - RTU ROOF TOP MECHANICAL UNIT. REFER TO MECH DRAWINGS.
1. FIELD VERIFY EXACT QUANTITY, SIZE AND LOCATIONS OF ROOF HOODS, VENTS, DRAINS, EQUIPMENT, ETC.
 2. ALL VENT-THRU PIPES SHALL BE EXTENDED AS NECESSARY TO PROTECT MINIMUM OF 12" ABOVE FINISHED ELEVATION OF ROOFING. FLASH ALL VENTS WITH PREMOLDED PIPE BOOTS WITH STAINLESS STEEL CLAMPING RING. ANY THAT EXTEND ABOVE THE PARAPET HEIGHT AND ARE VISIBLE FROM GROUND LEVEL SHALL BE PAINTED, UNLESS NOTED OTHERWISE.
 3. ALL ROOF TOP CURBS TO BE SADDLES WITH MINIMUM 1/2" PER FOOT PITCH.
 4. WALKWAY PADS TO BE INSTALLED AT ROOF ACCESS POINTS, TOP AND BOTTOM OF LADDERS, AND AT SERVICE LOCATIONS AROUND ROOF TOP MECHANICAL UNITS.

- KEYNOTE LEGEND**
- R1 OVERFLOW SCUPPER. REFER TO DETAIL THIS SHEET.
 - R6 ATTACH ROOF ACCESS LADDER TO EXISTING STRUCTURE, ADD ADDITIONAL SUPPORT AS REQUIRED.
 - R7 ROOF ACCESS LADDER. REFER TO ROOF LADDER DETAIL. PAINT TO MATCH ADJACENT WALL.
 - R8 NEW OVERFLOW DRAIN IN EXISTING ROOF. REFER TO MECHANICAL DOCUMENTS.
 - R10 HATCH INDICATES TPO LAYER OVER EPDM ROOF MEMBRANE AT KITCHEN EQUIPMENT WITH GREASE. EXTEND TPO TO ROOF DRAIN.
 - R11 GRAY SILICON COATING OVER EPDM ROOF MEMBRANE USED ON SLOPED STRUCTURE ROOF. REFER TO SPECIFICATION.
 - R12 NEW TRASH CHUTE VENT THRU ROOF.

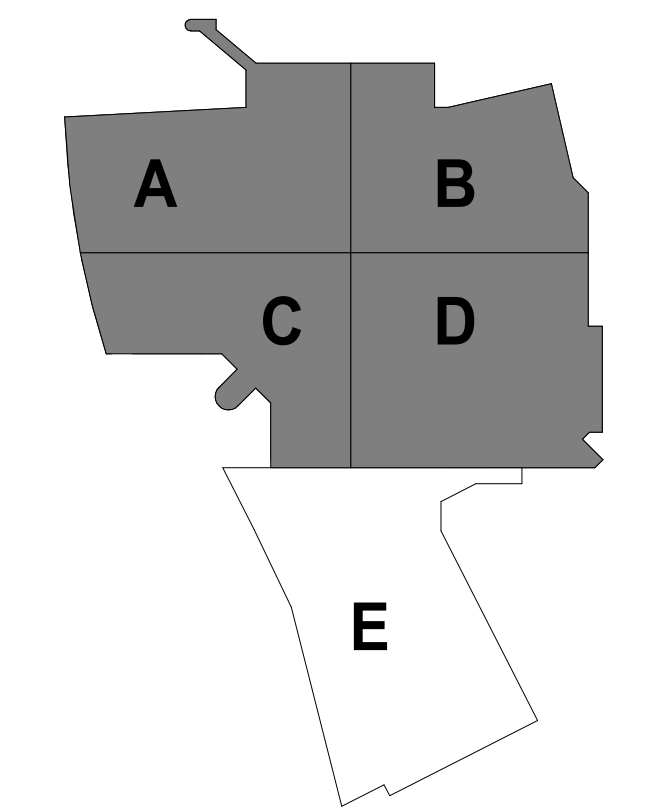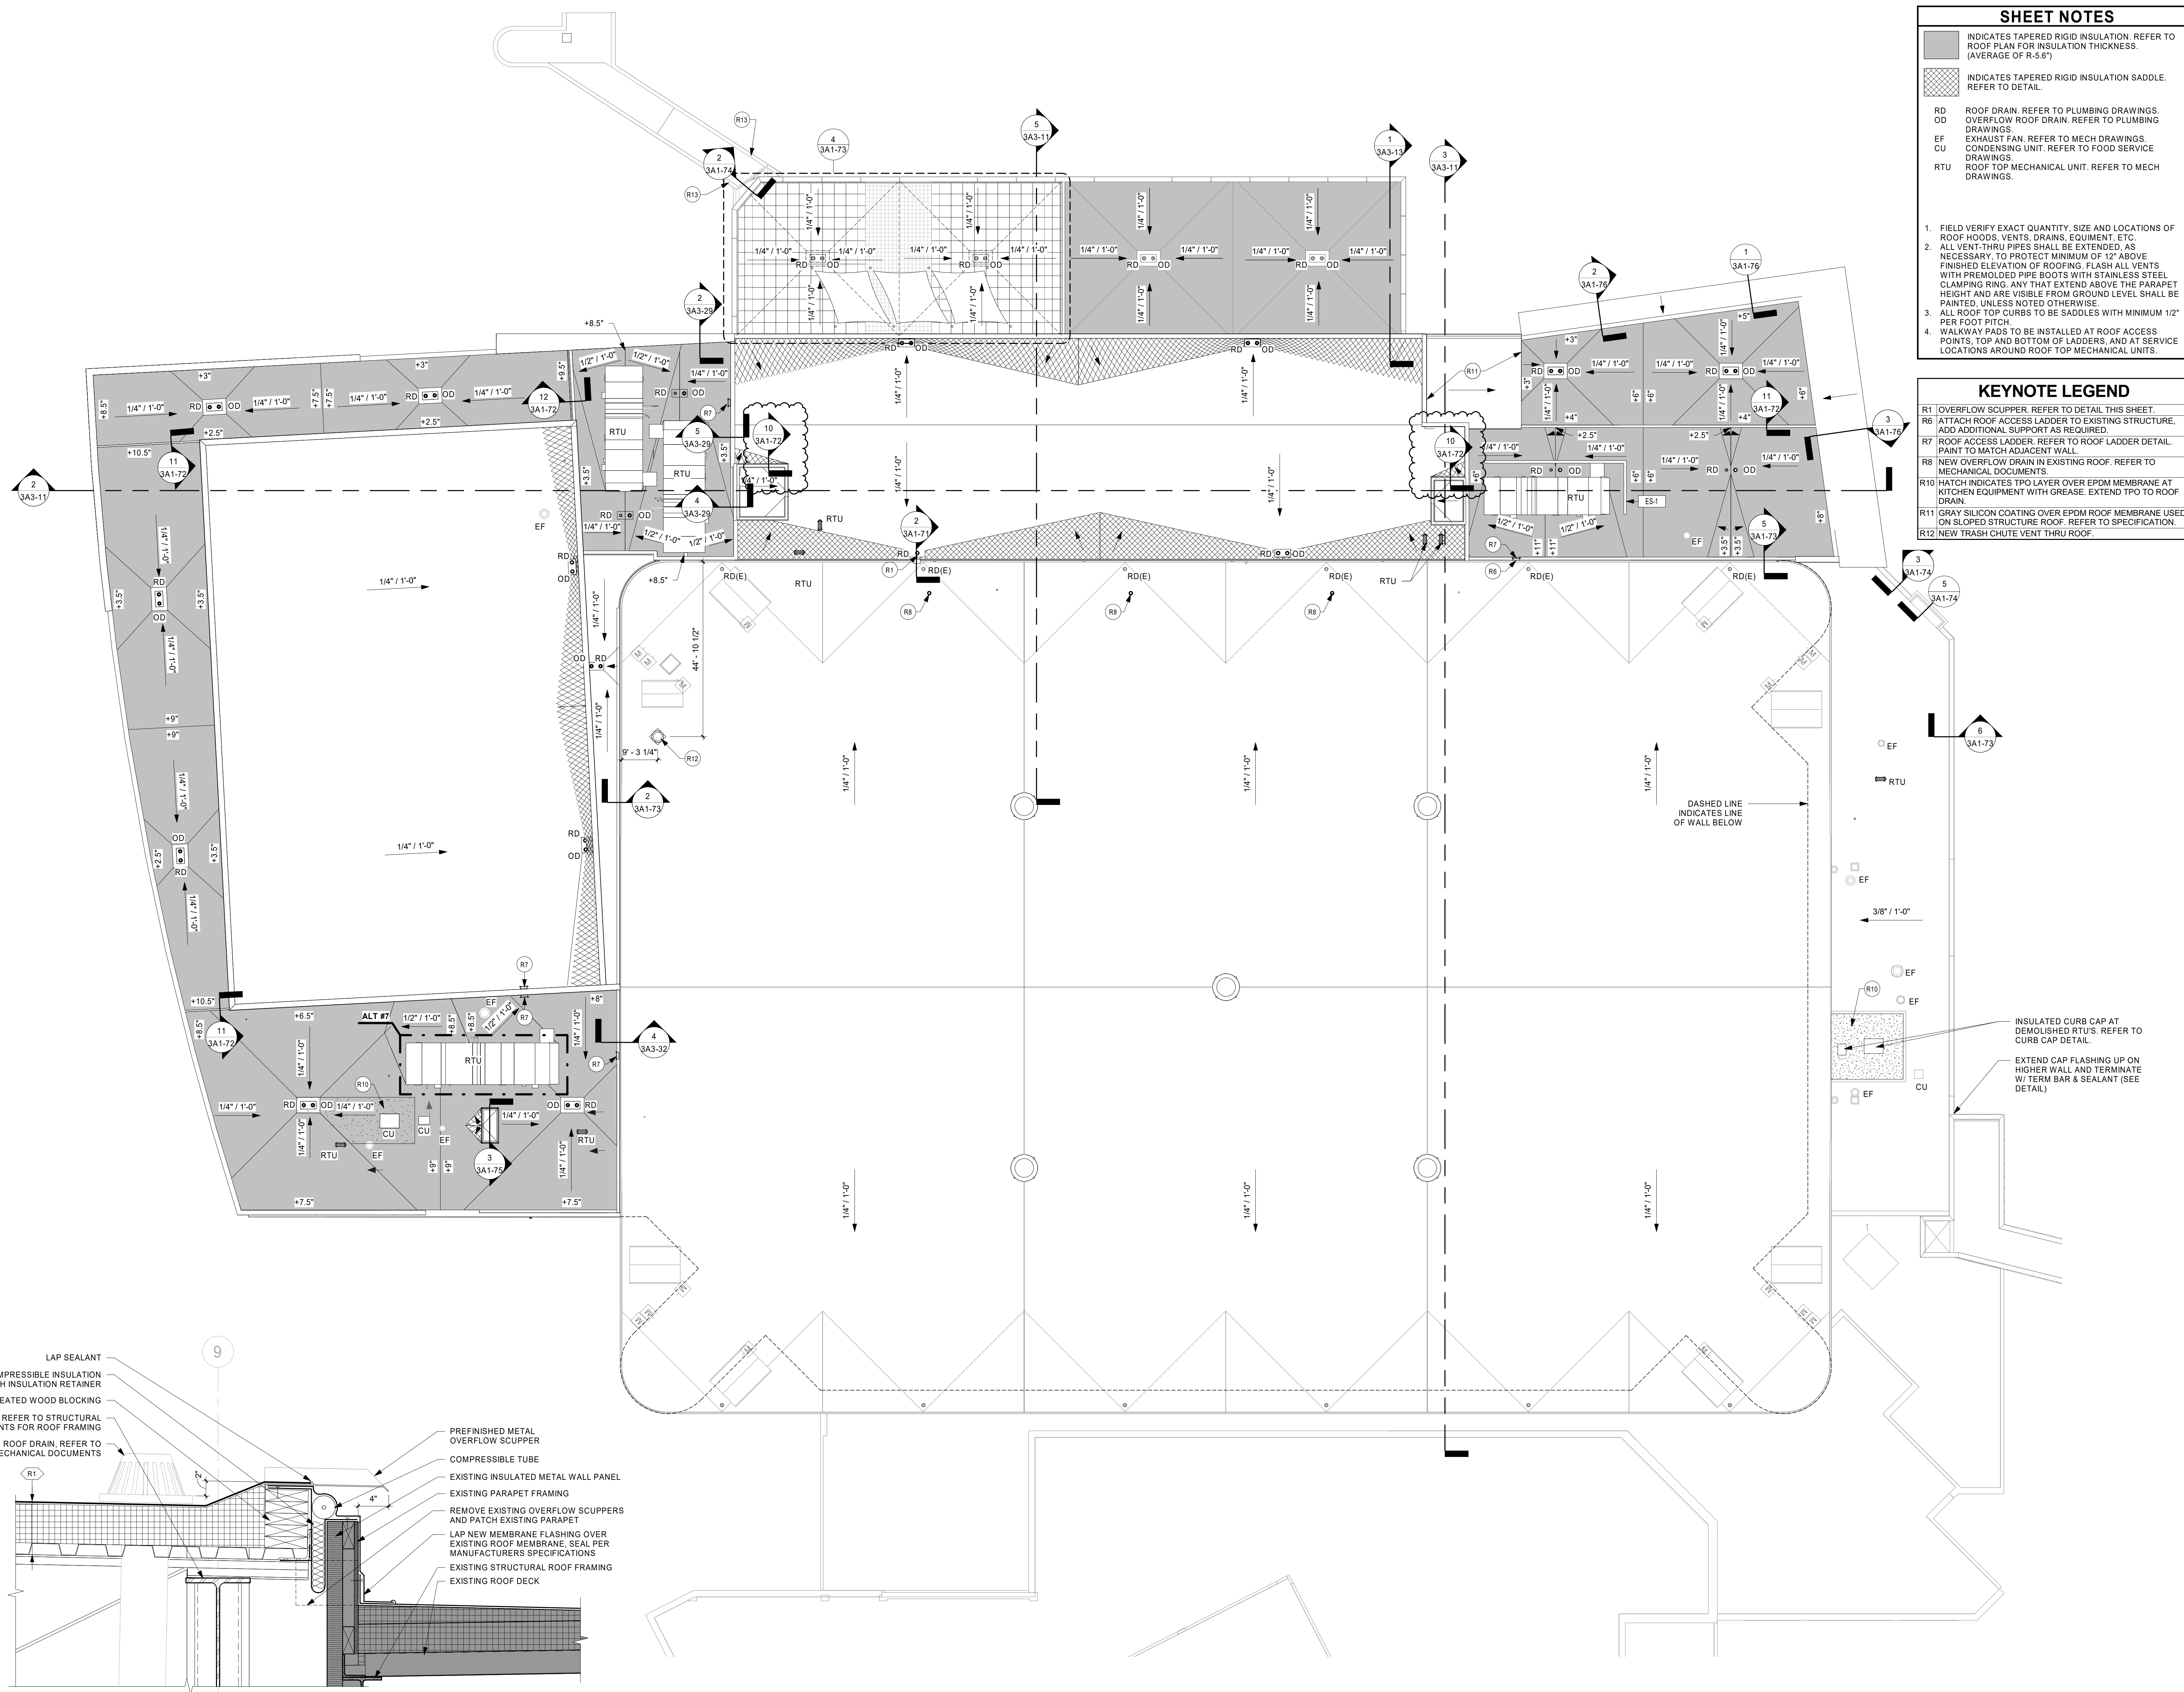

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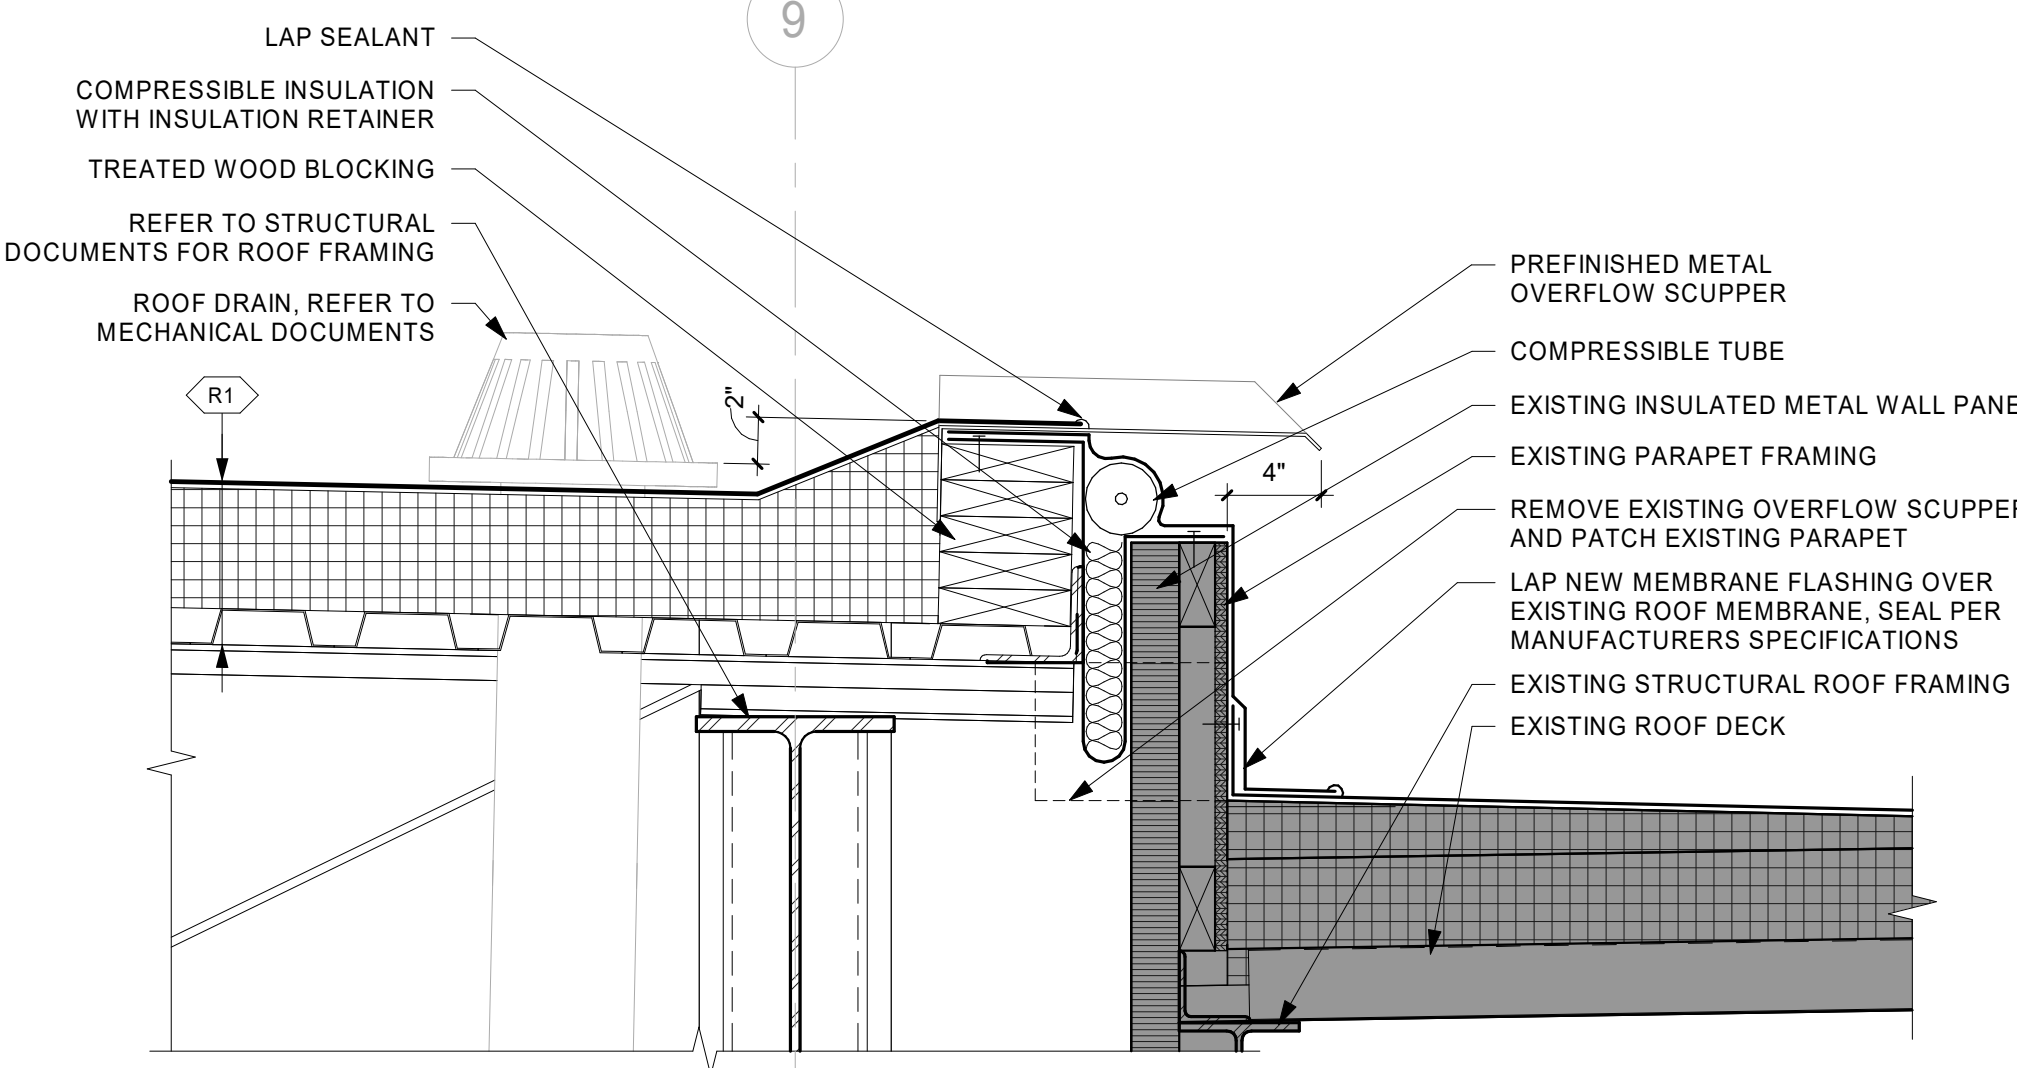
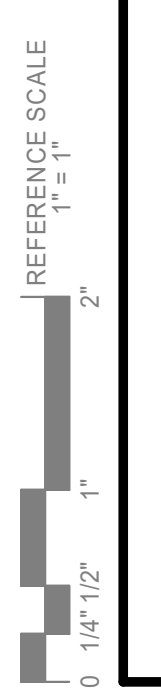
PROJECT
LA CROSSE CENTER EXPANSION & RENOVATION
 LA CROSSE WISCONSIN

REVISION SCHEDULE		
DATE	DESCRIPTION	BY
03/19/20	BP3 ADDENDUM 07	JMB
03/30/20	PR 10	JMB
03/26/20	BP3 ADDENDUM 08	JMB
04/30/20	PR 12	JMB
08/07/20	PR 20	KMB
08/18/20	PR 21	JMB

PROJECT NO. 16-19990
 FILE NAME 19990 Arch R18.rvt
 DRAWN BY JMB
 DESIGNED BY JPW/KMB
 REVIEWED BY JPW/KMB
 ORIGINAL ISSUE DATE 03/05/20

CLIENT PROJECT NO.
 TITLE
ROOF PLAN - OVERALL

SHEET
3A1-71




2 OVERFLOW SCUPPER DETAIL
 1/12" = 1'-0"


1 ROOF PLAN - OVERALL
 1/16" = 1'-0"




SHEET NOTE:
FIREPROOFING OF STRUCTURAL MEMBERS NOT SHOWN FOR CLARITY. REFER TO CODE DATA PLANS FOR FIREPROOFING REQUIREMENTS.

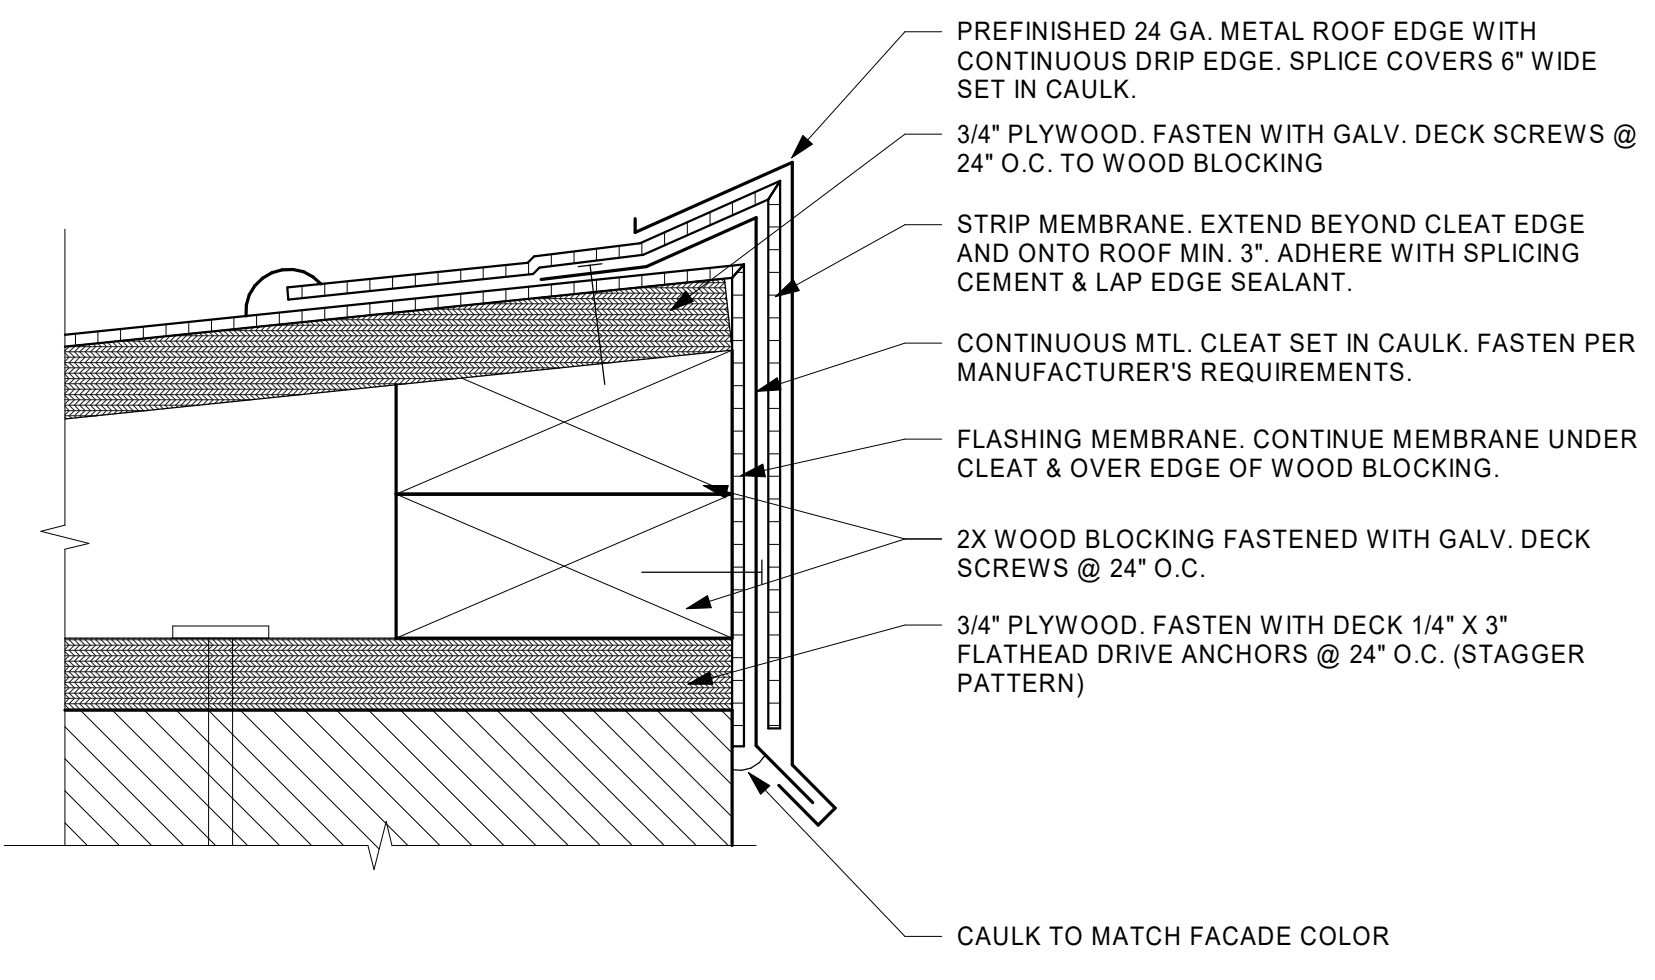


1 ENLARGED ROOF EDGE DETAIL
6" = 1'-0"

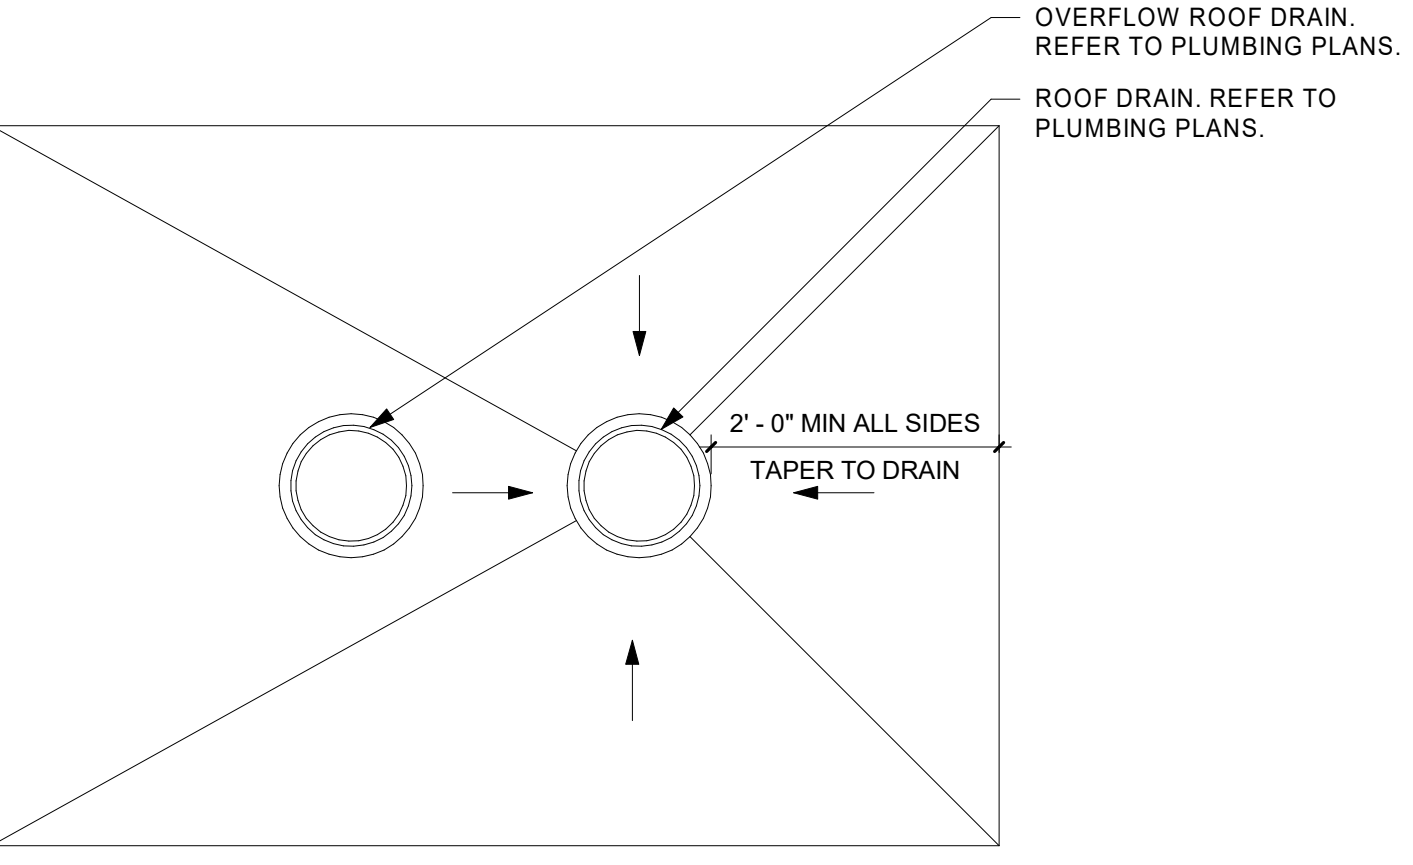


2 ROOF DRAIN AND OVERFLOW PLAN DETAIL
3/4" = 1'-0"

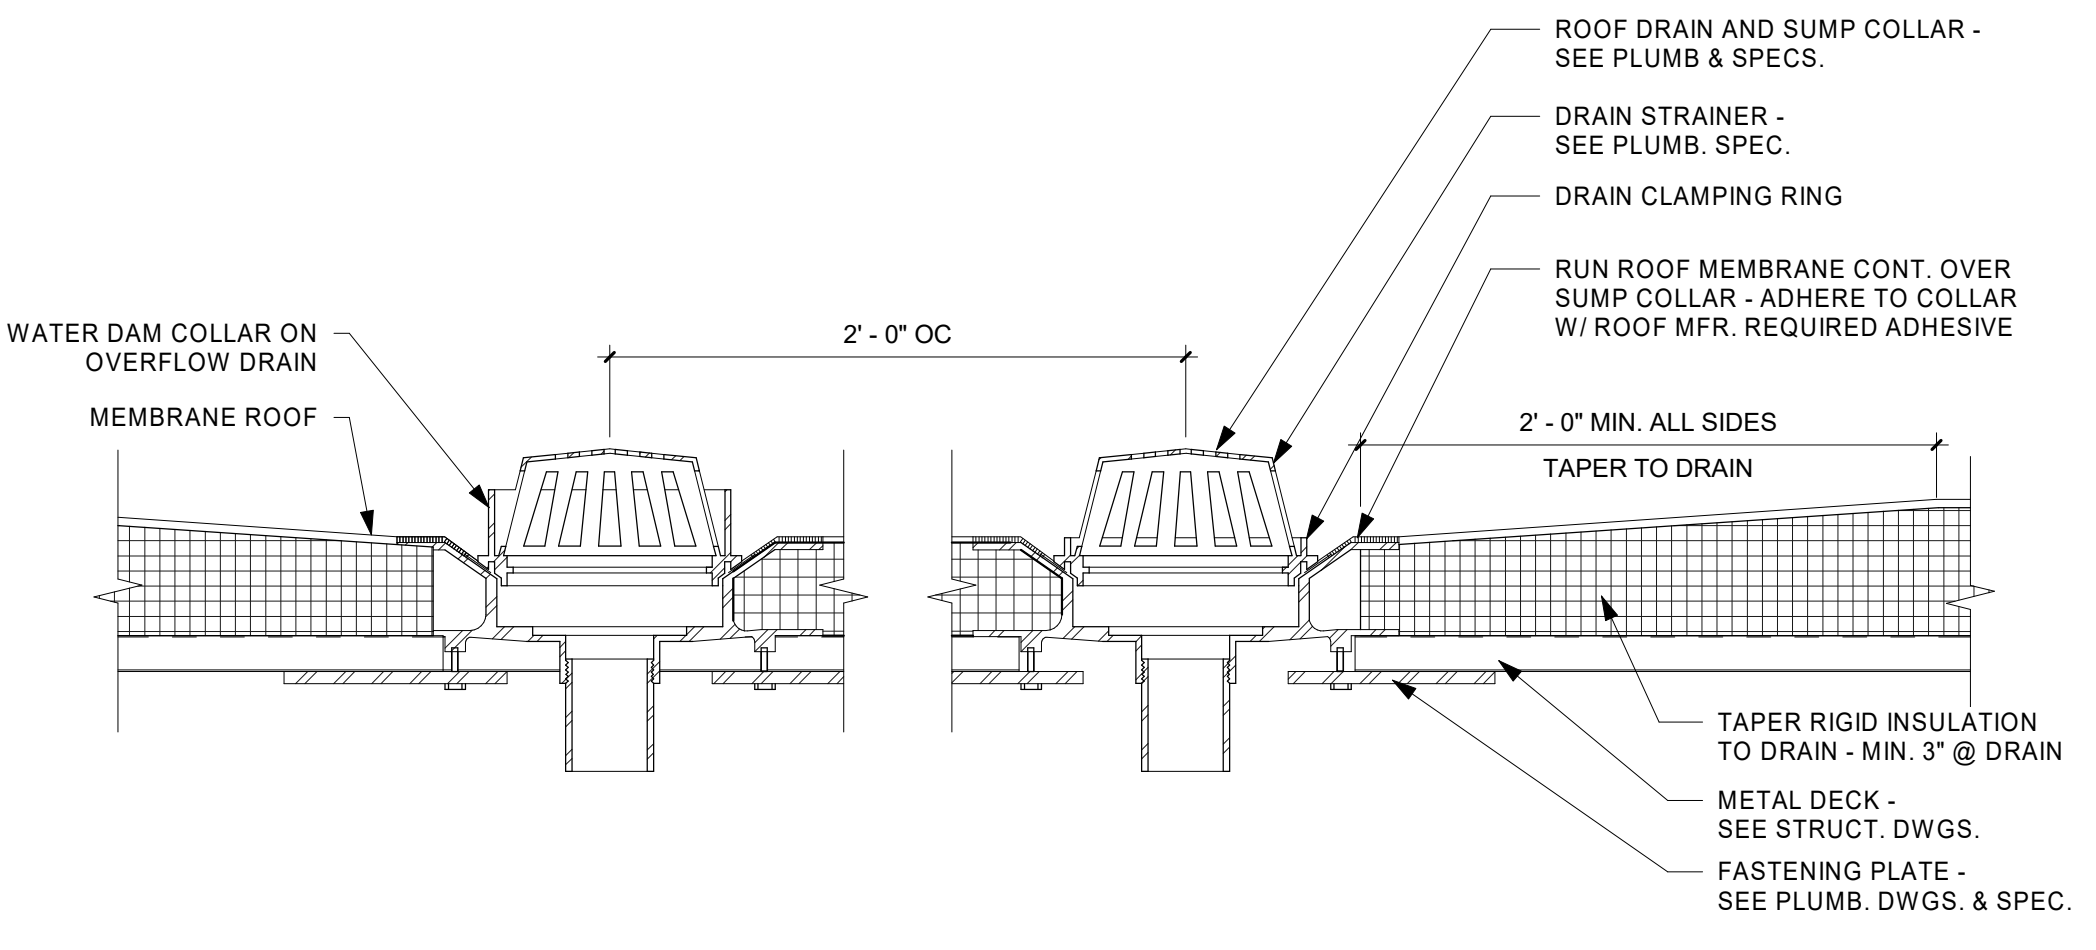


3 ROOF DRAIN AND OVERFLOW DETAIL
1 1/2" = 1'-0"

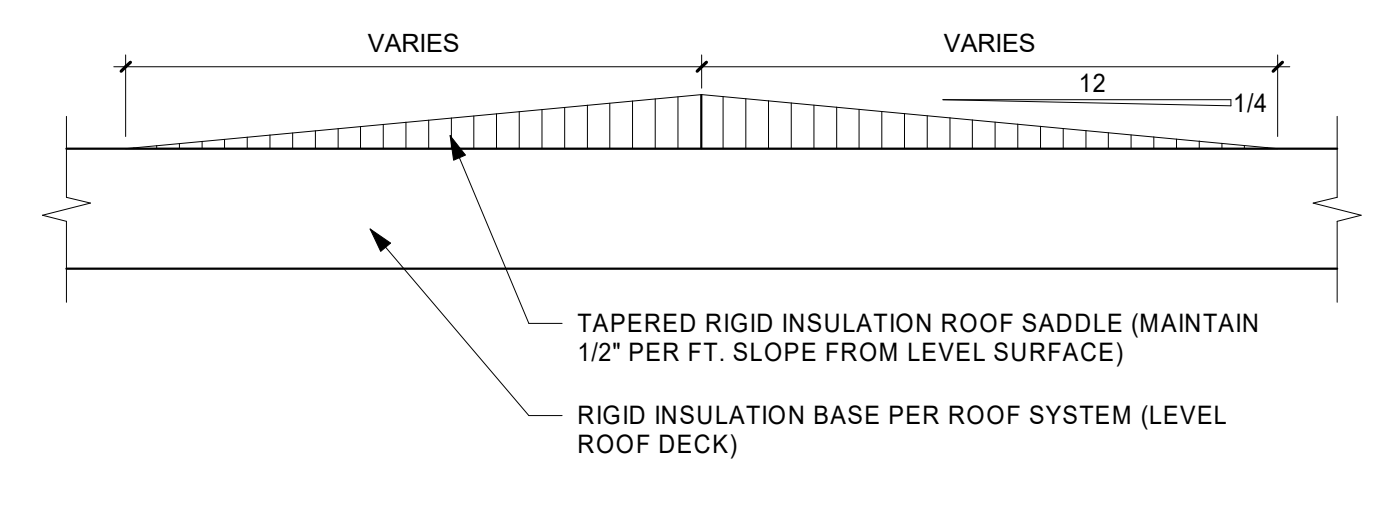


4 ROOF SADDLE DETAIL
1 1/2" = 1'-0"

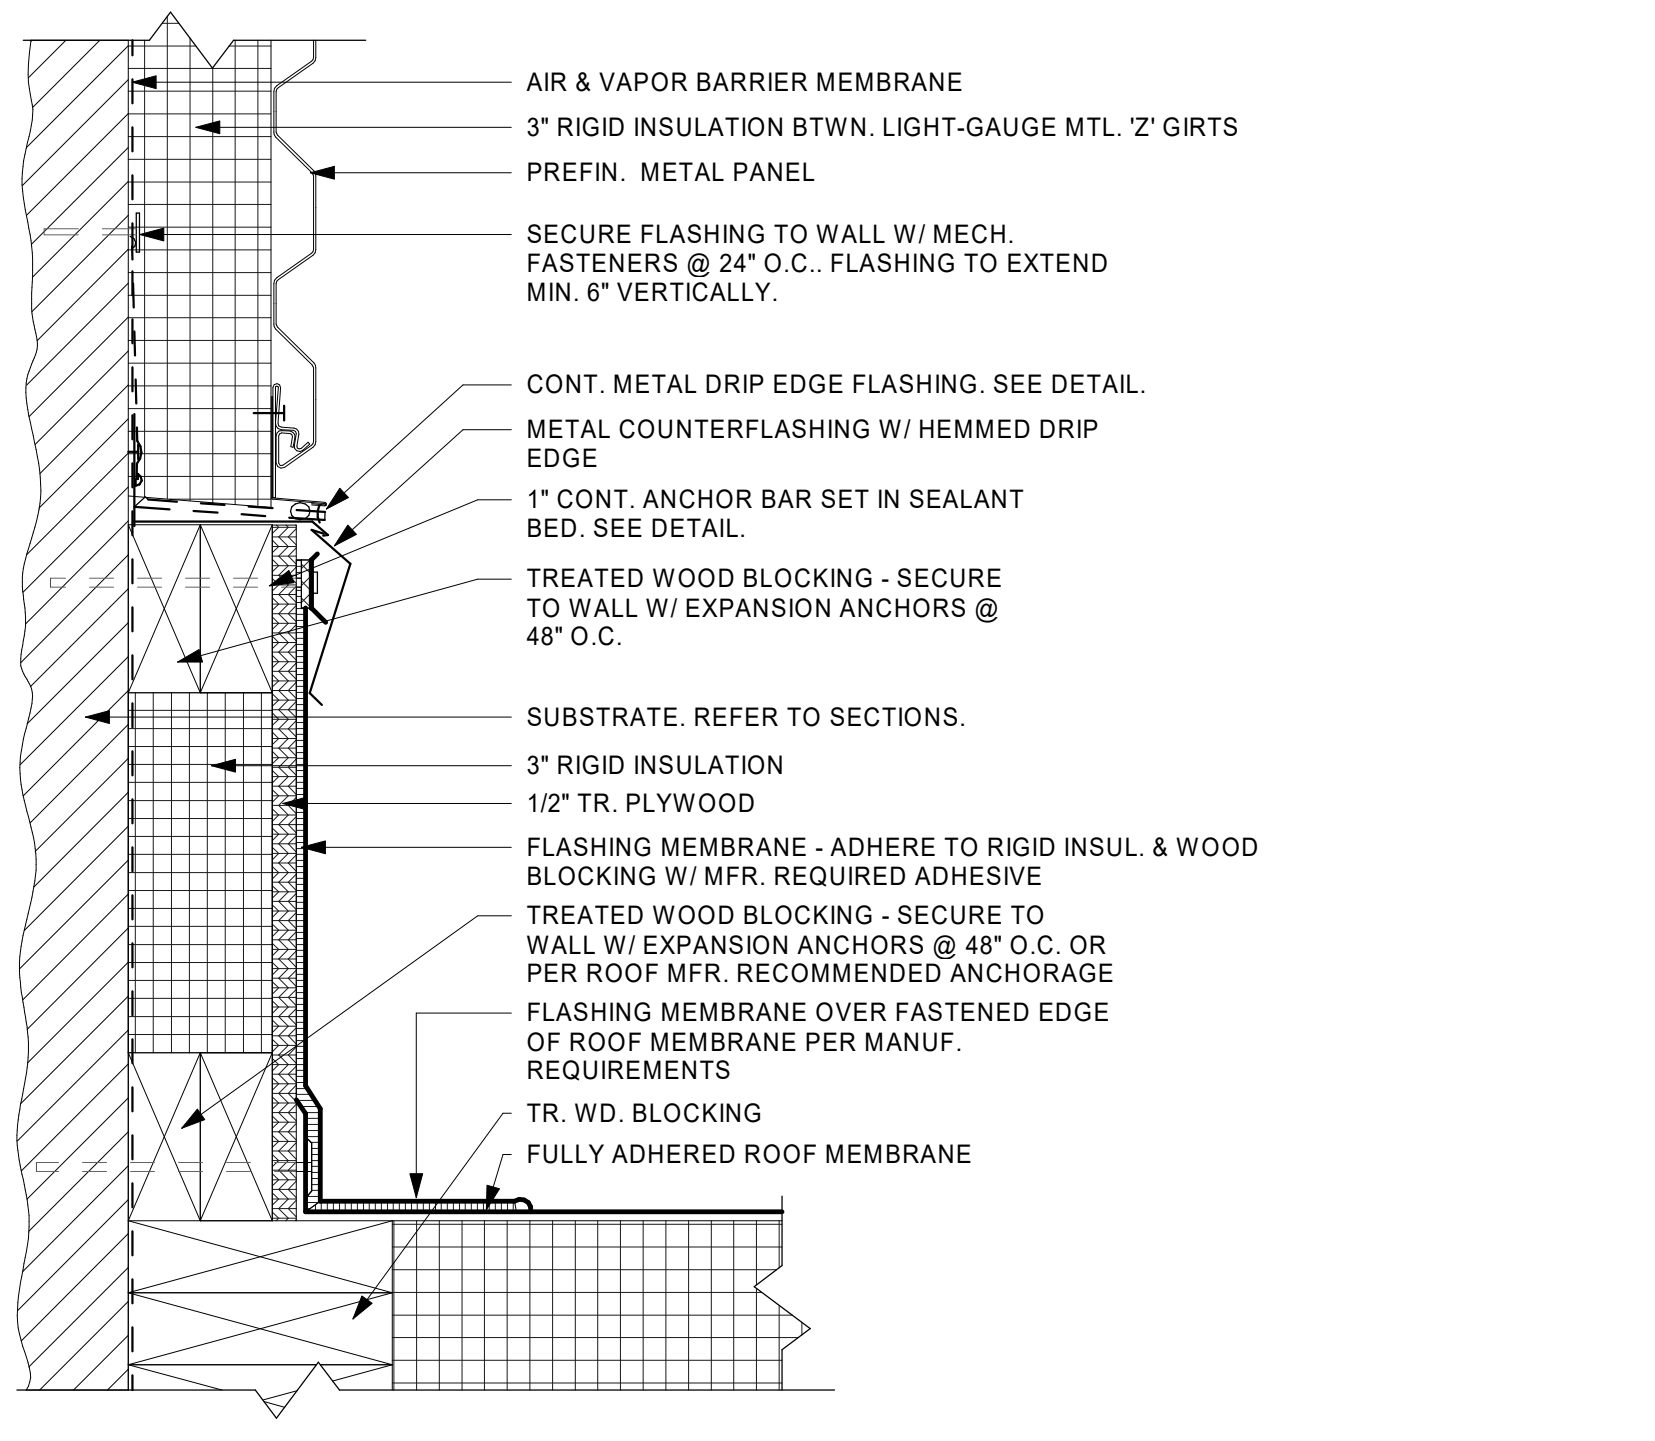


5 ROOF TO WALL COUNTERFLASHING DETAILS
3" = 1'-0"

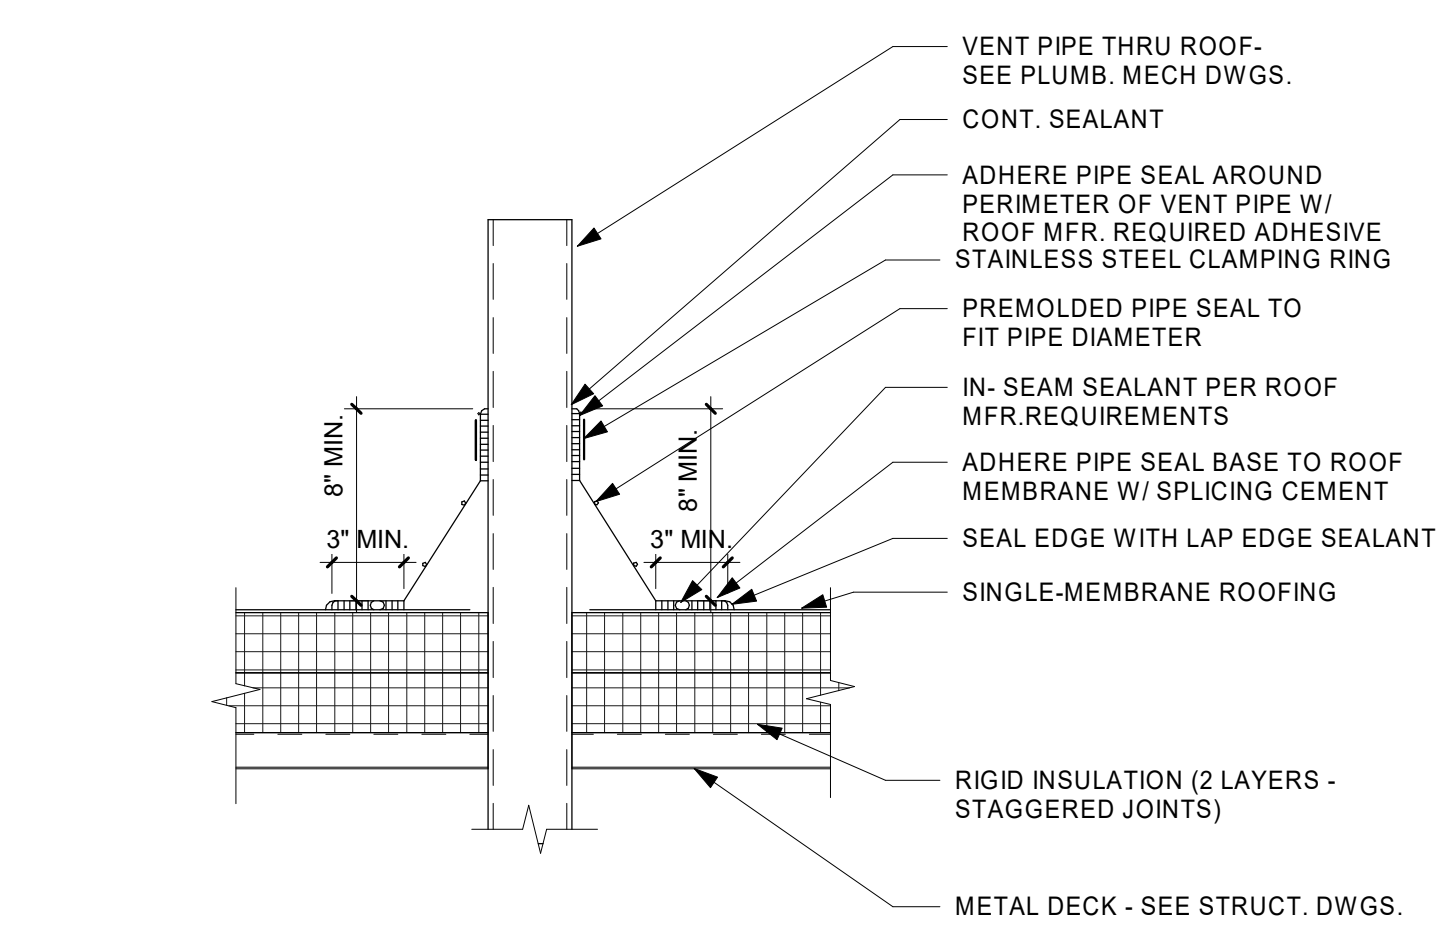


6 VENT PIPE FLASHING DETAIL
1 1/2" = 1'-0"

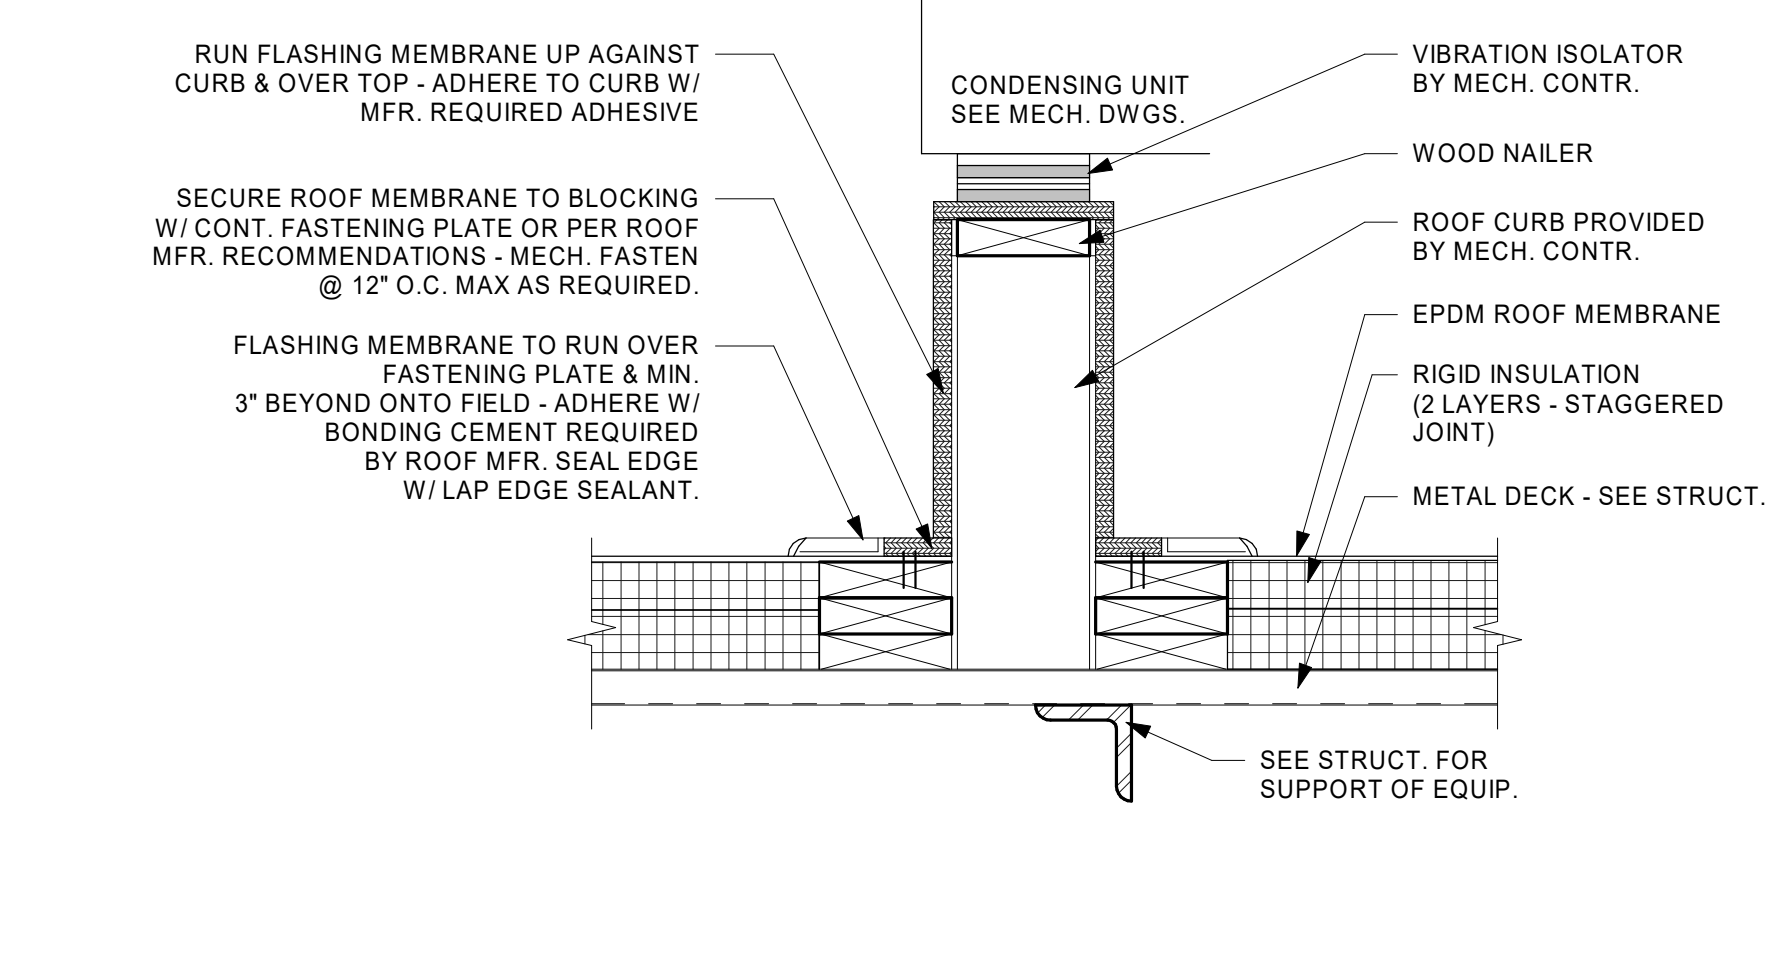


7 CONDENSOR CURB DETAIL
1 1/2" = 1'-0"

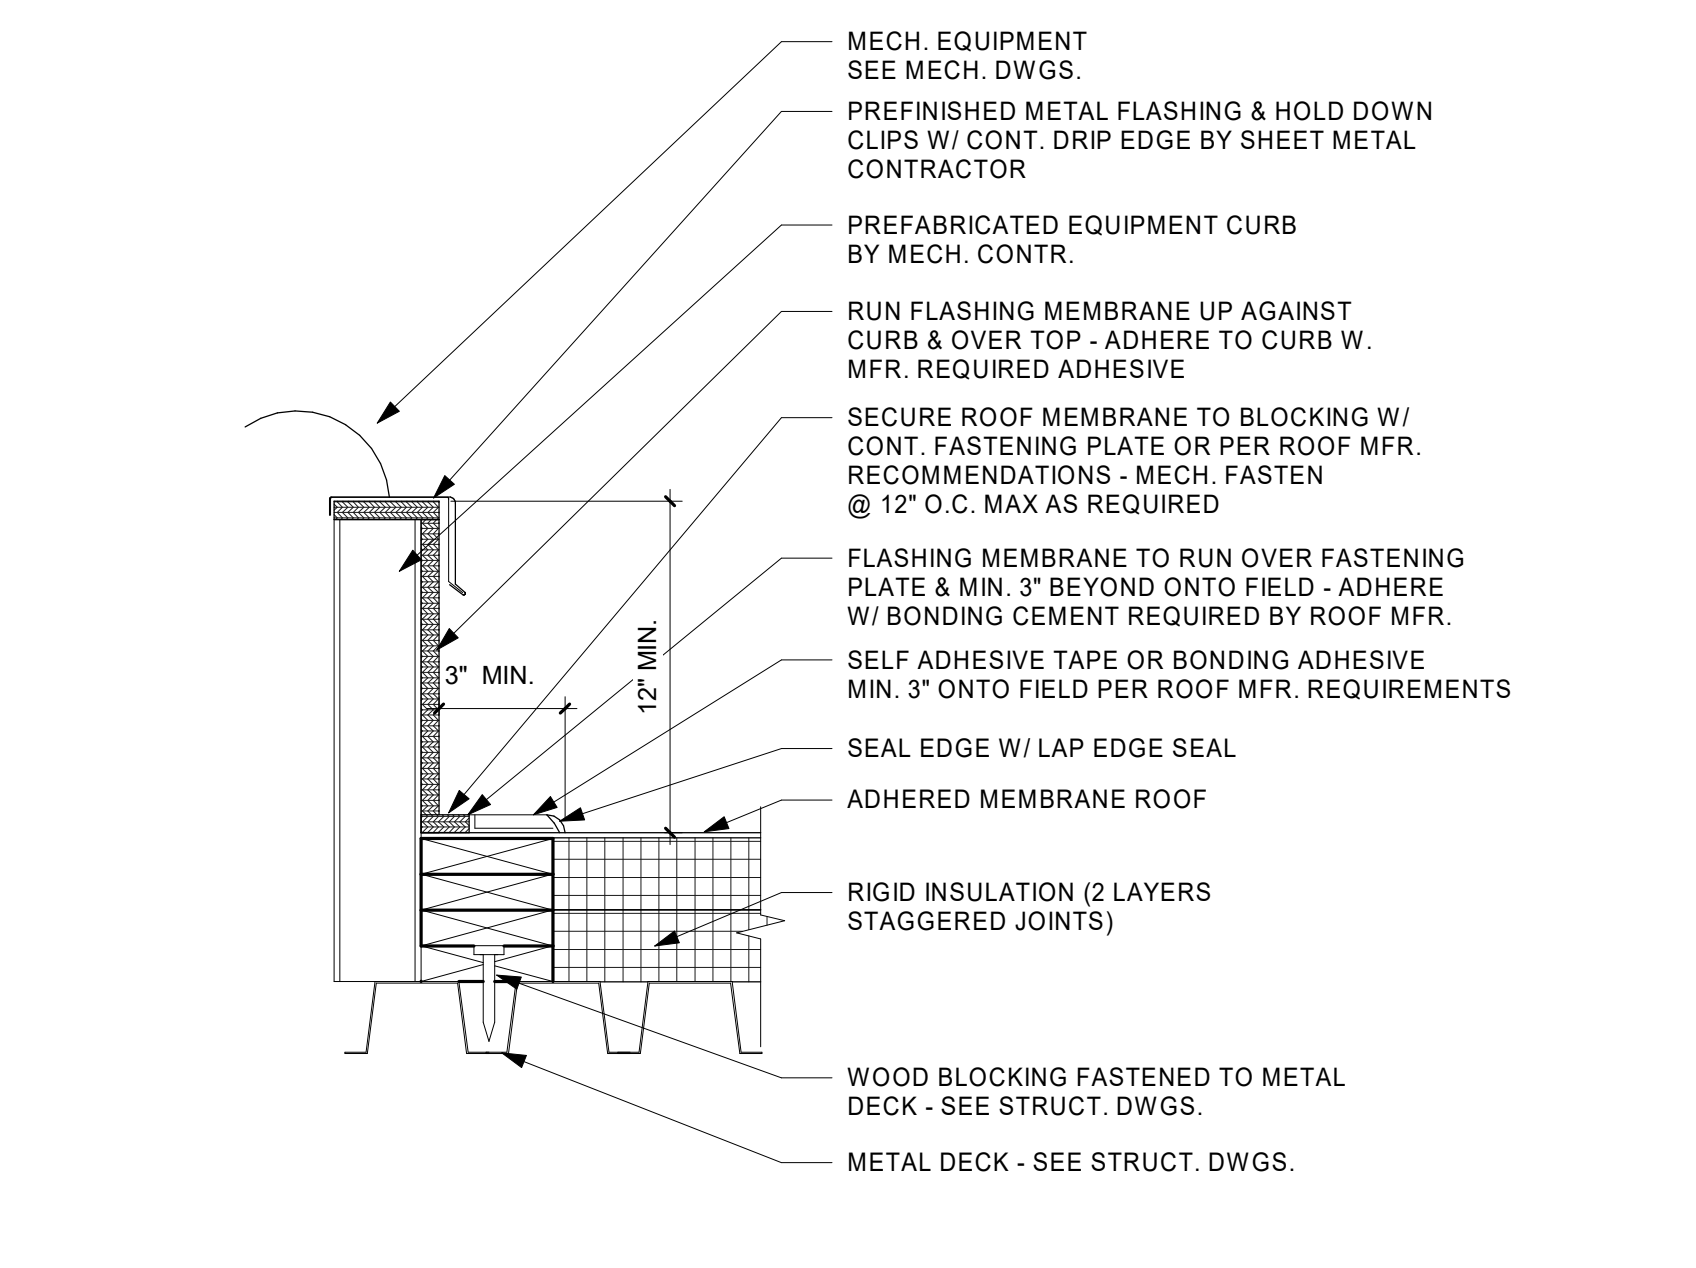


8 CURB FLASHING DETAIL
1 1/2" = 1'-0"

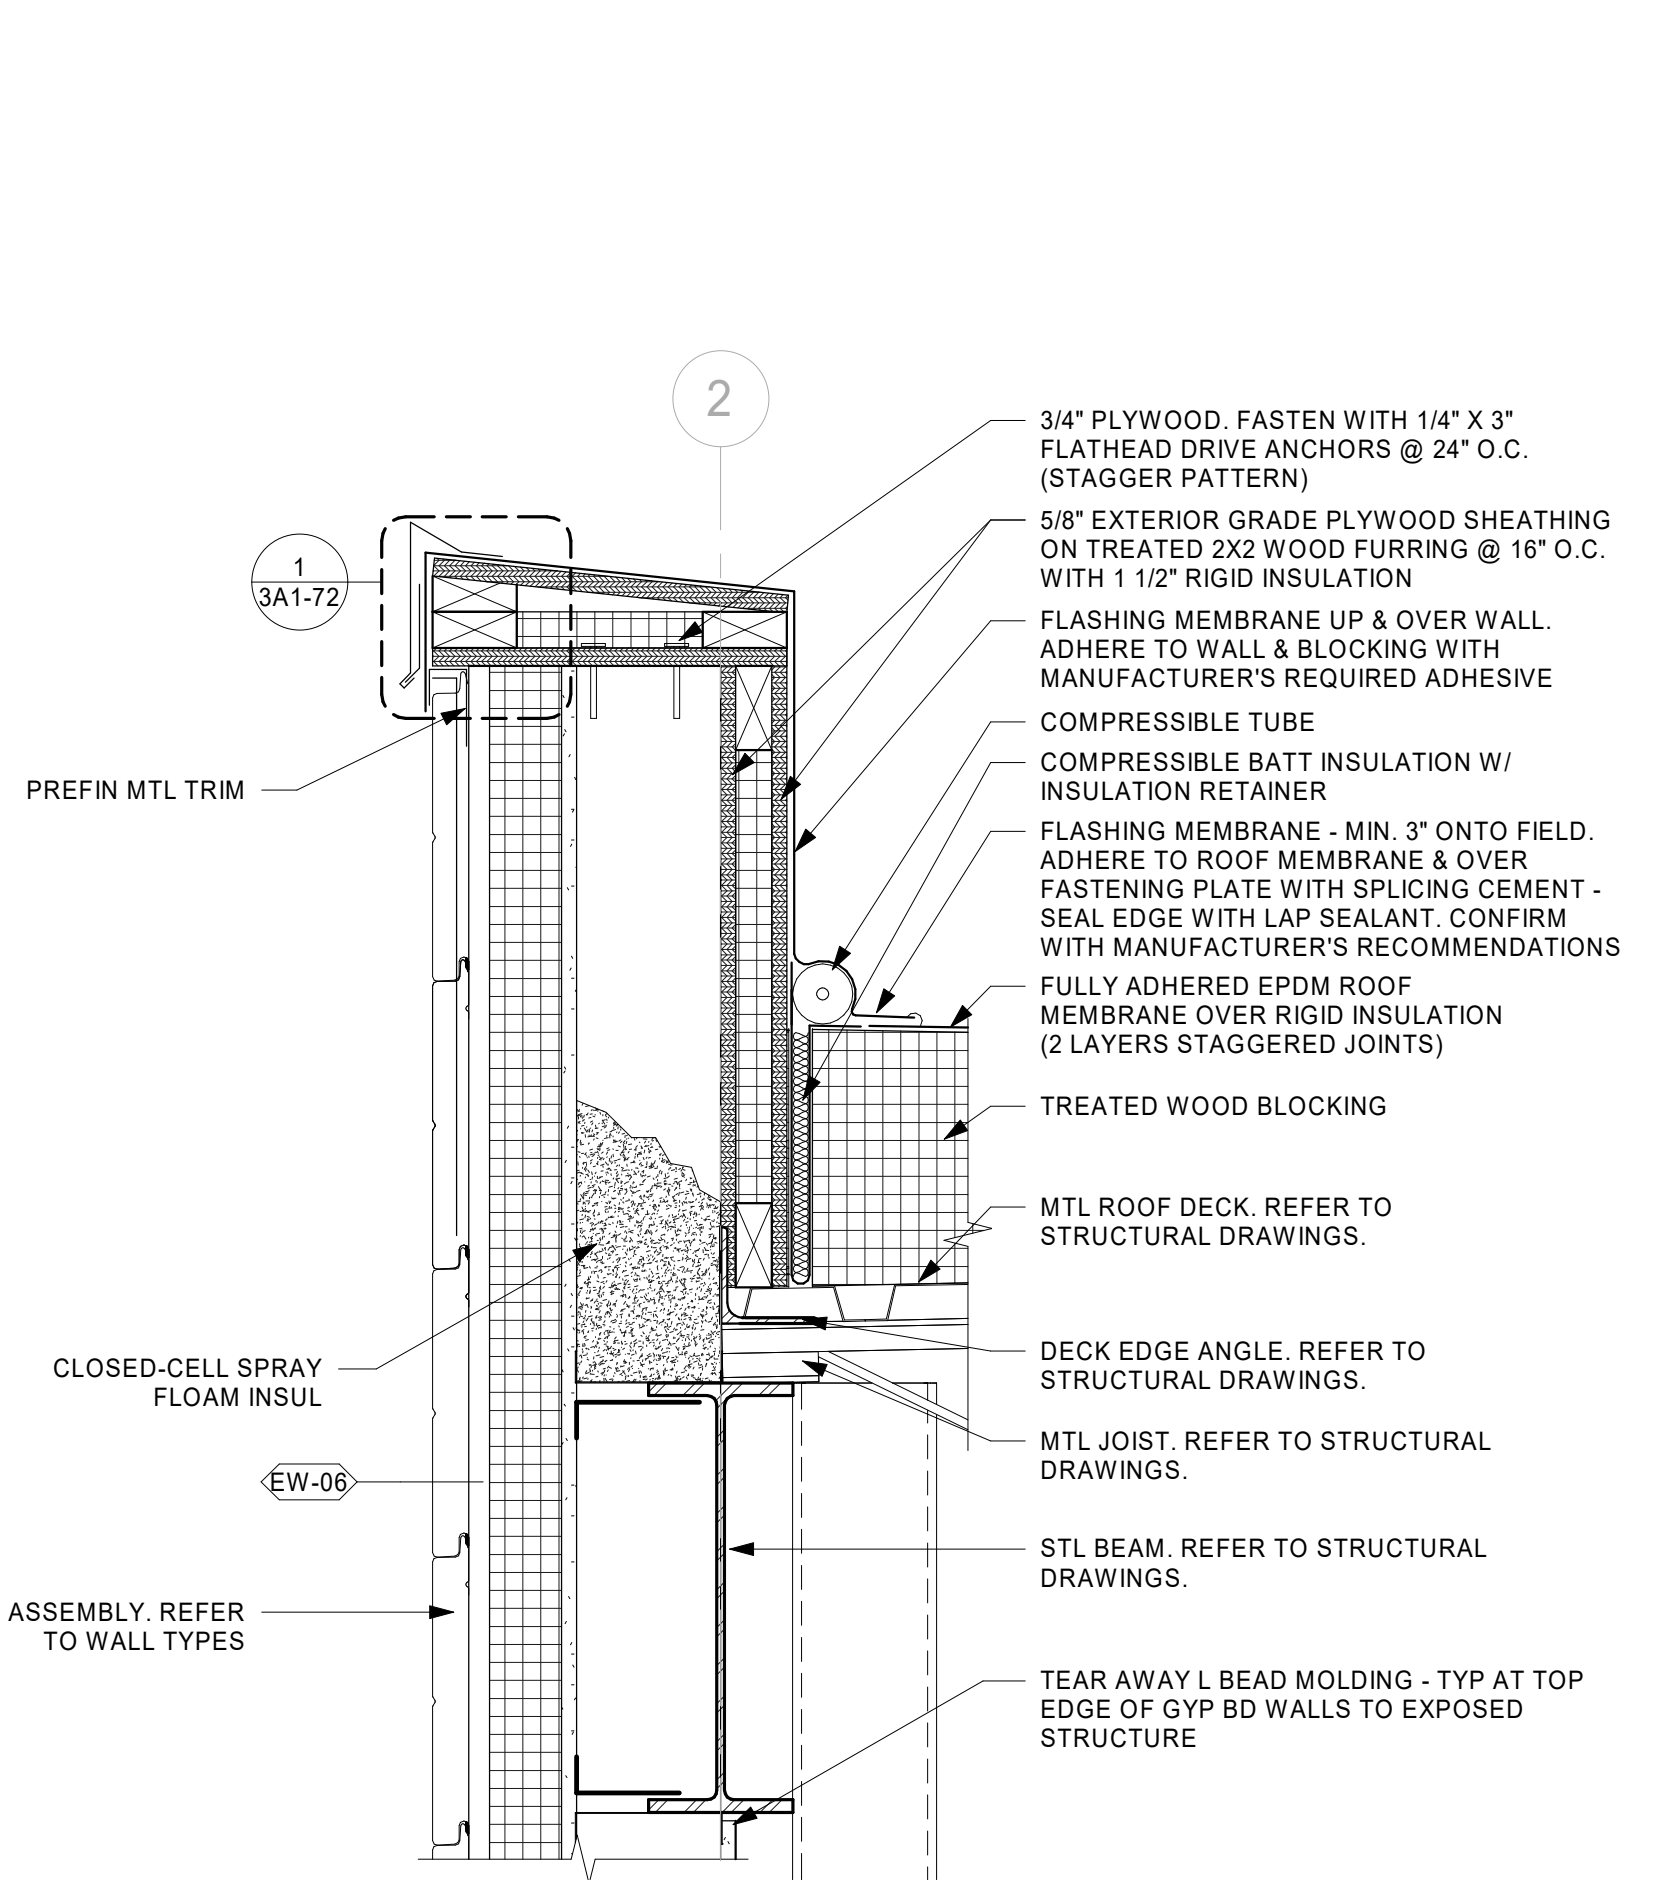


9 PARAPET DETAIL - NORTH PRE-FUNCTION
1 1/2" = 1'-0"

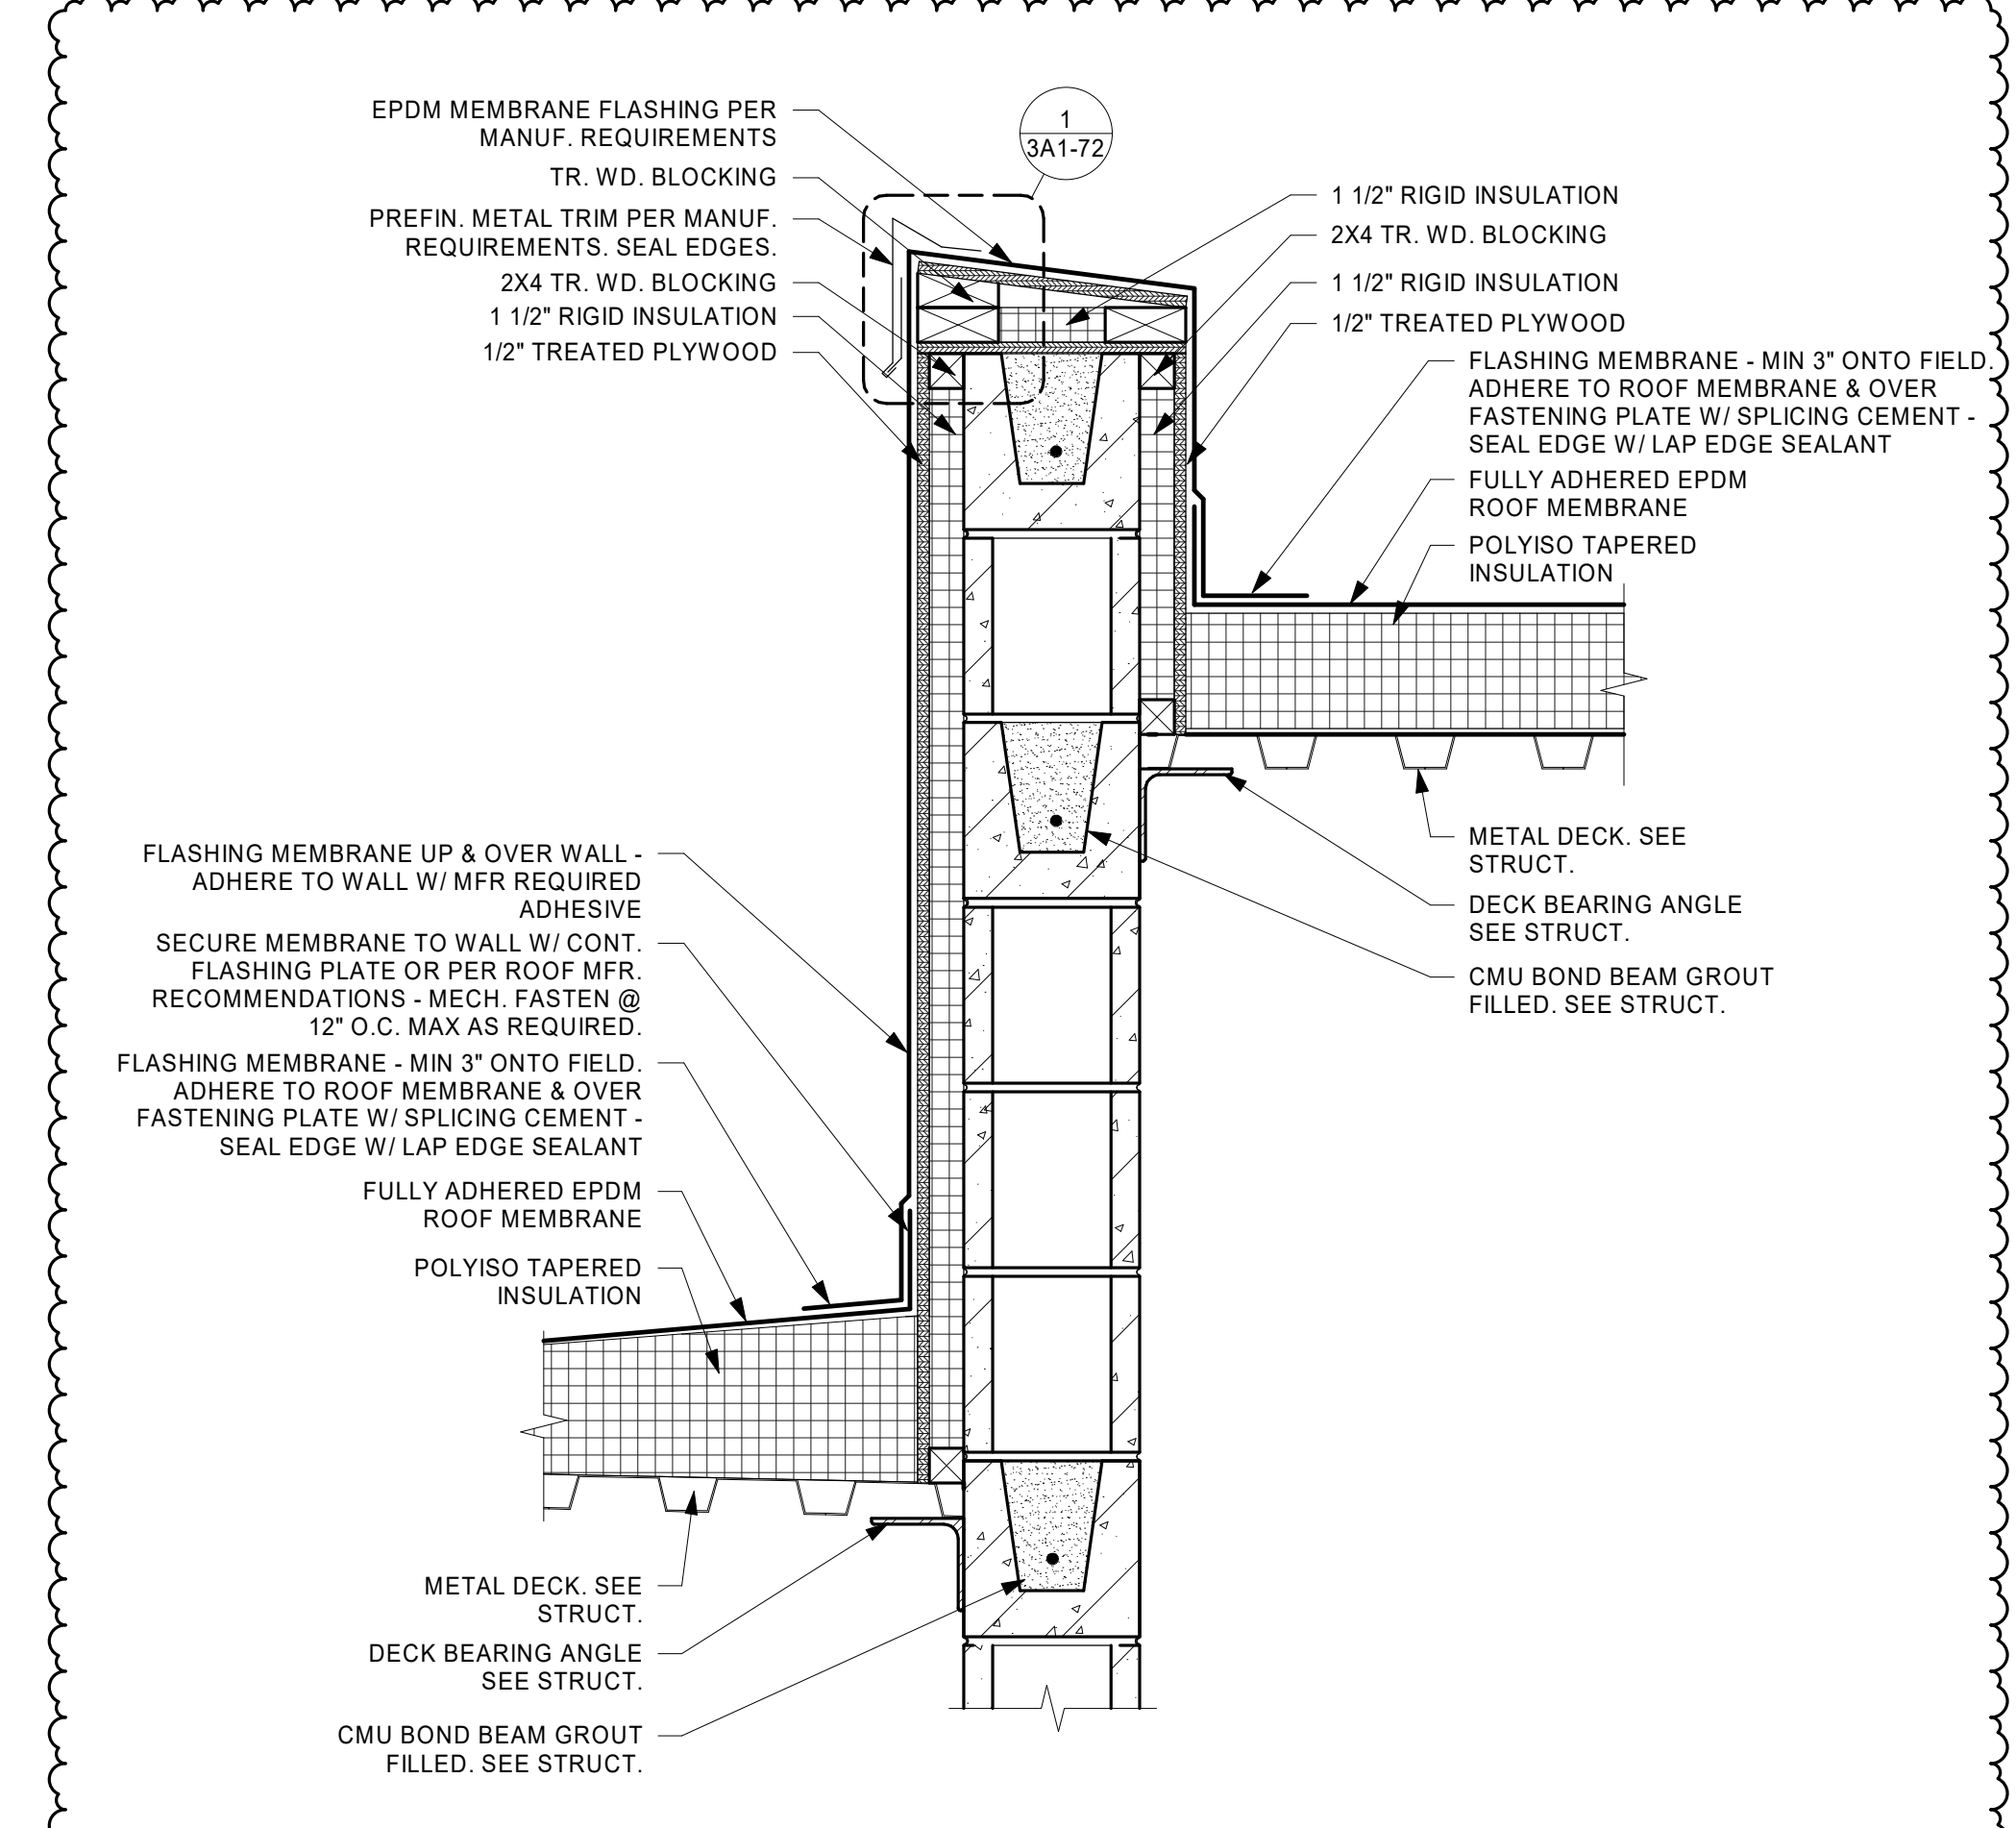


10 ROOF HEIGHT CHANGE AT ELEV SHAFT
1 1/2" = 1'-0"

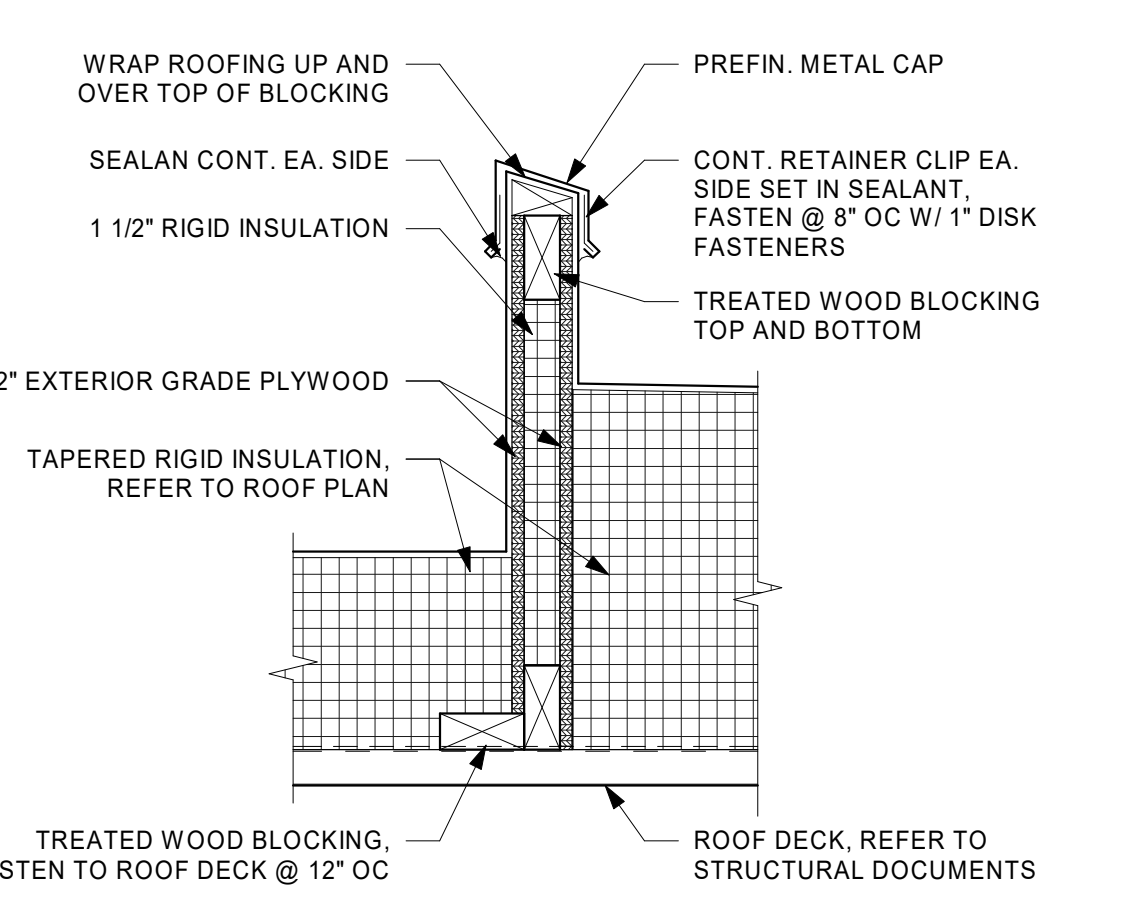

11 ROOF CONTROL JOINT
1 1/2" = 1'-0"

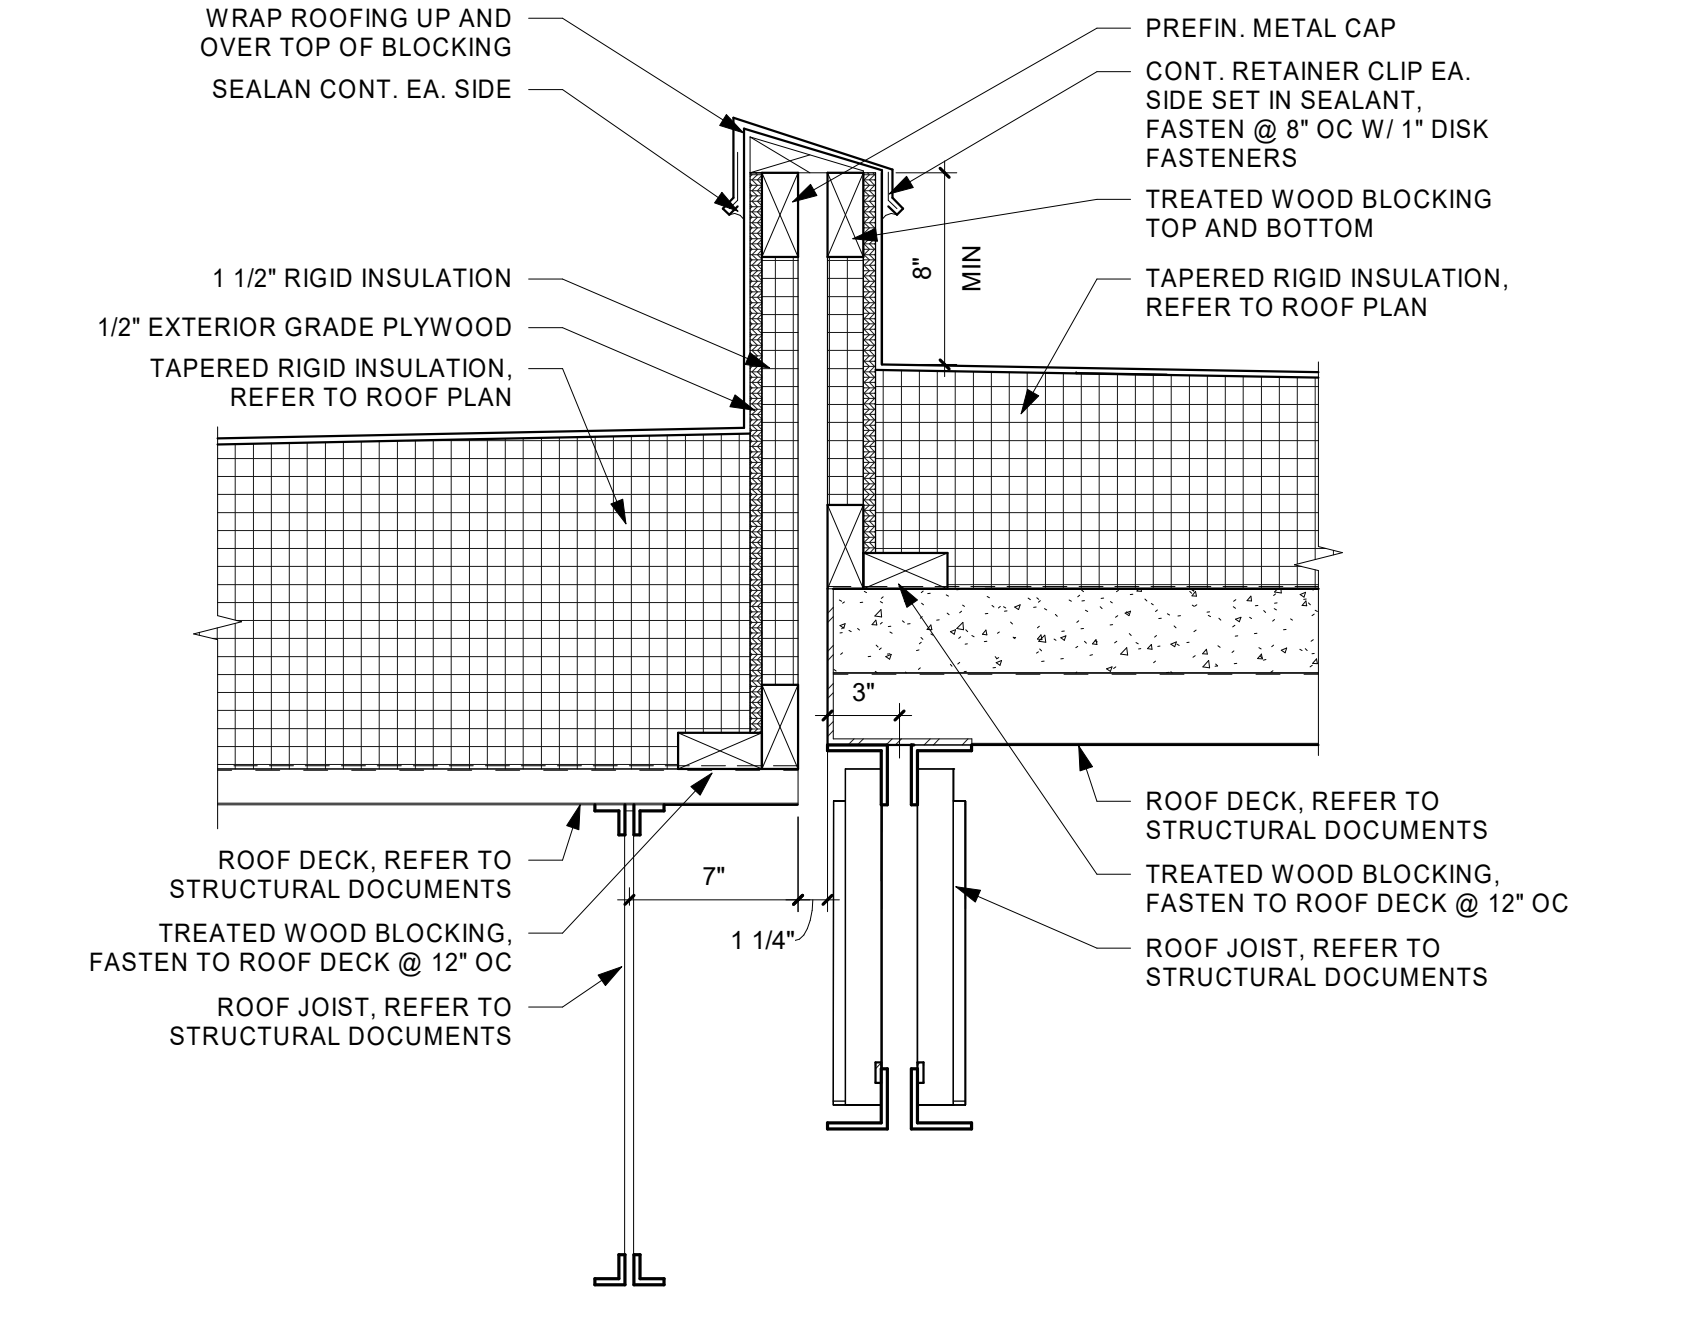

12 ROOF CONTROL JOINT
1 1/2" = 1'-0"

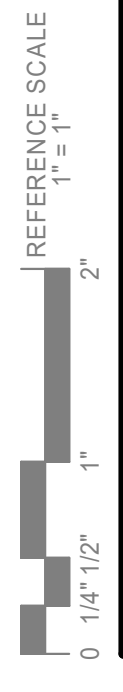

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PROJECT
LA CROSSE CENTER EXPANSION & RENOVATION

LA CROSSE WISCONSIN

REVISION SCHEDULE		
DATE	DESCRIPTION	BY
03/19/20	BP3 ADDENDUM 07	JMB
03/26/20	BP3 ADDENDUM 08	JMB
04/30/20	PR12	JMB
08/19/20	PR 21	JMB

PROJECT NO. 16-19990
FILE NAME 19990 Arch R18.rvt
DRAWN BY JMB
DESIGNED BY JPW/KMB
REVIEWED BY JPW/KMB
ORIGINAL ISSUE DATE 03/05/20







CLIENT PROJECT NO.

TITLE

ROOF DETAILS



SHEET NOTE:
FIREPROOFING OF STRUCTURAL MEMBERS NOT SHOWN FOR CLARITY. REFER TO CODE DATA PLANS FOR FIREPROOFING REQUIREMENTS.

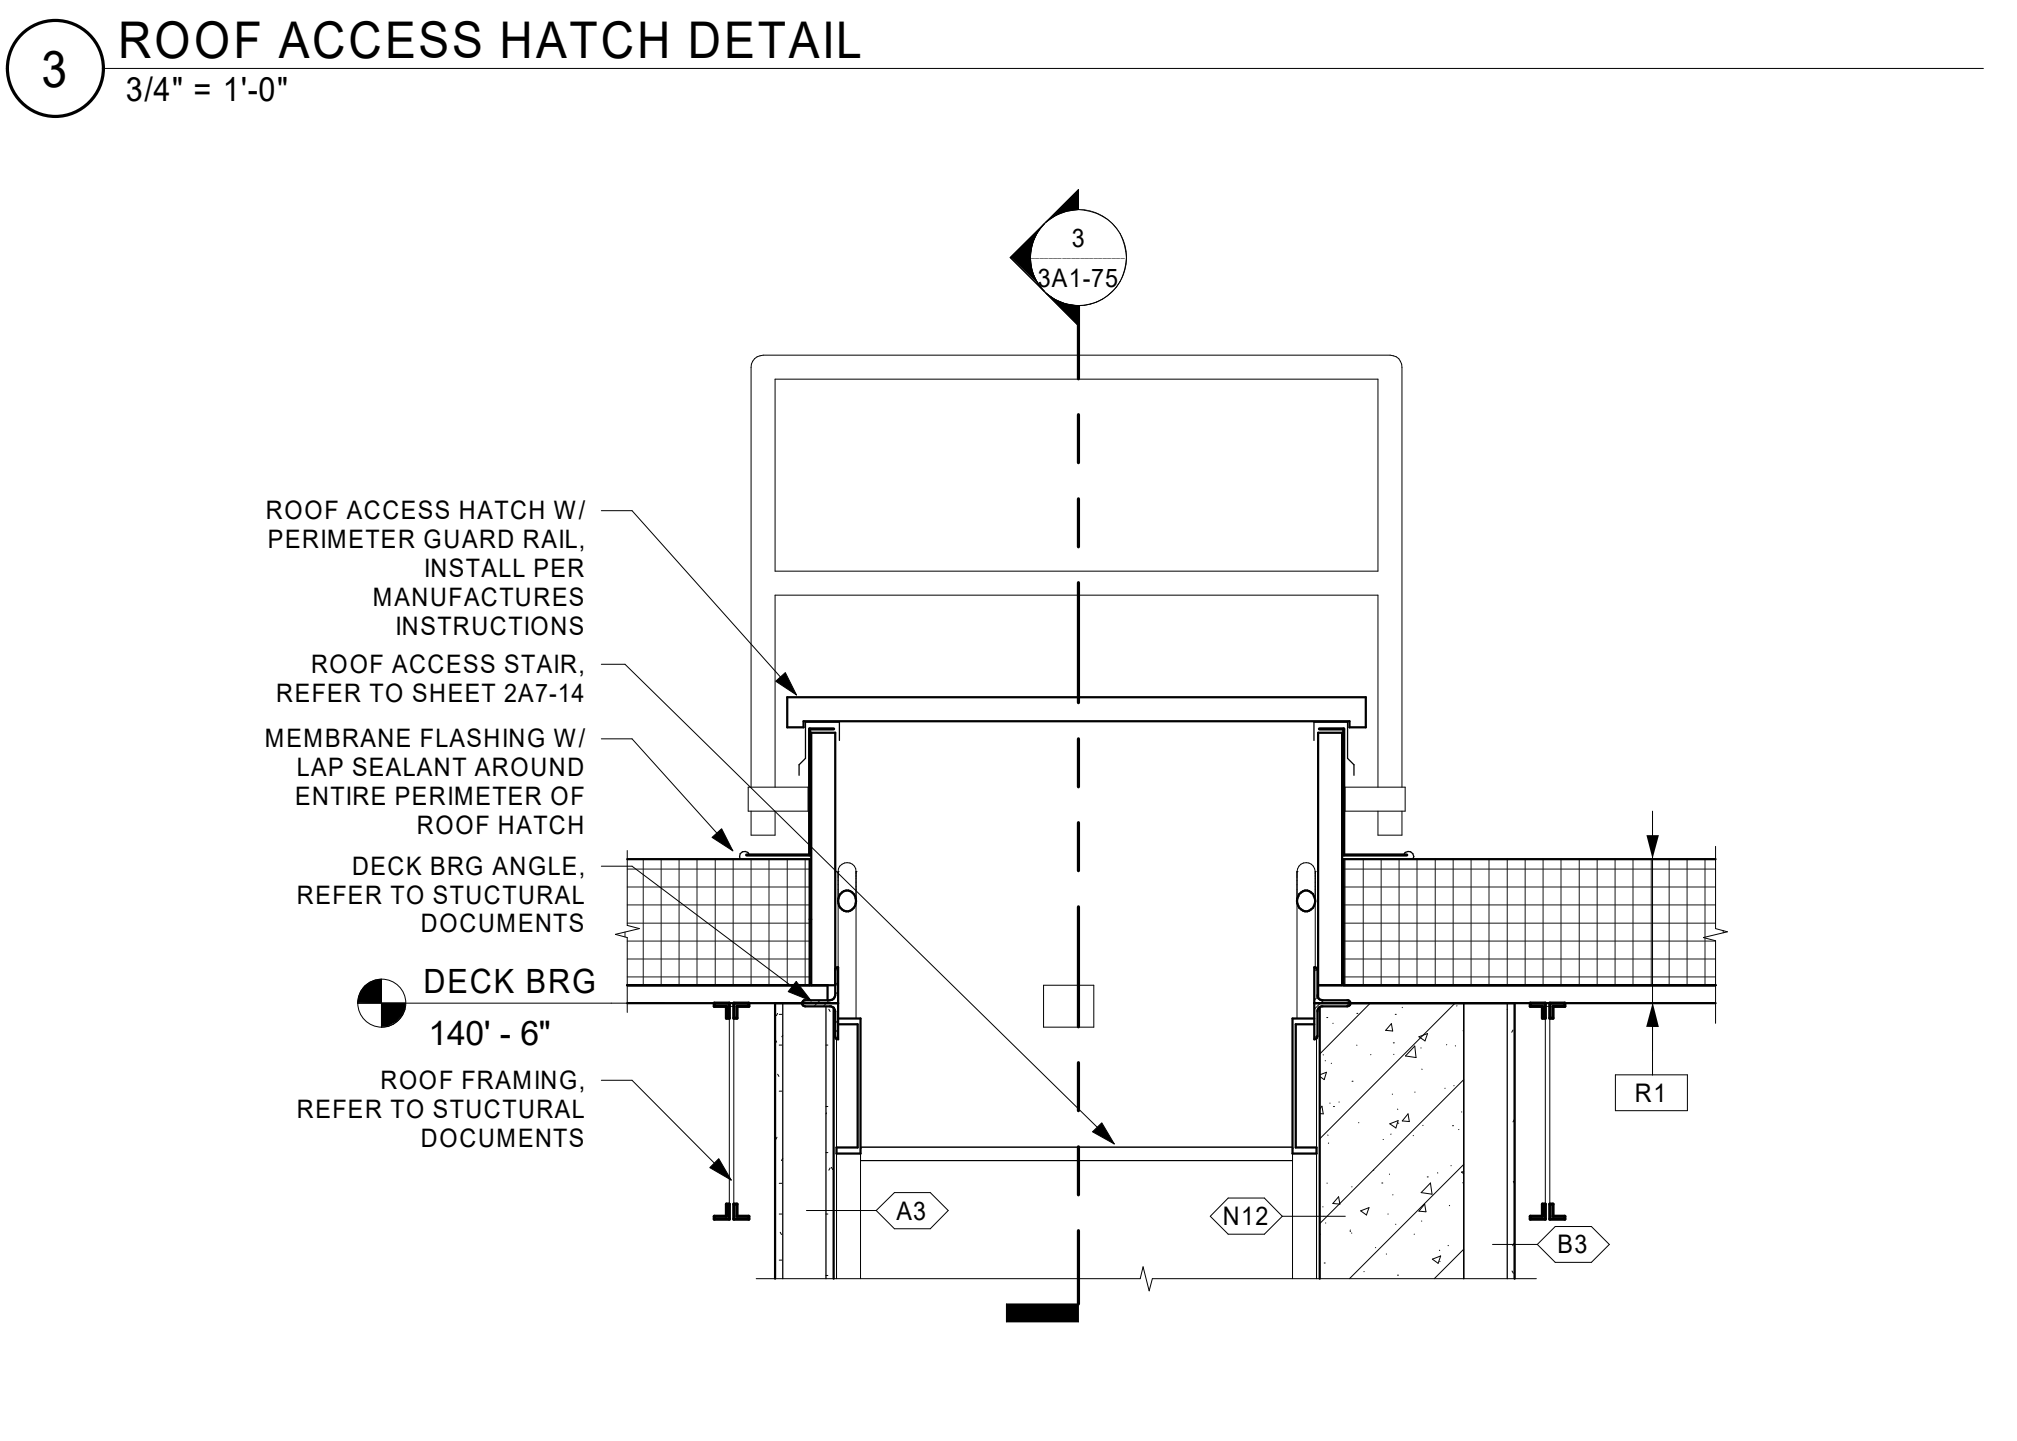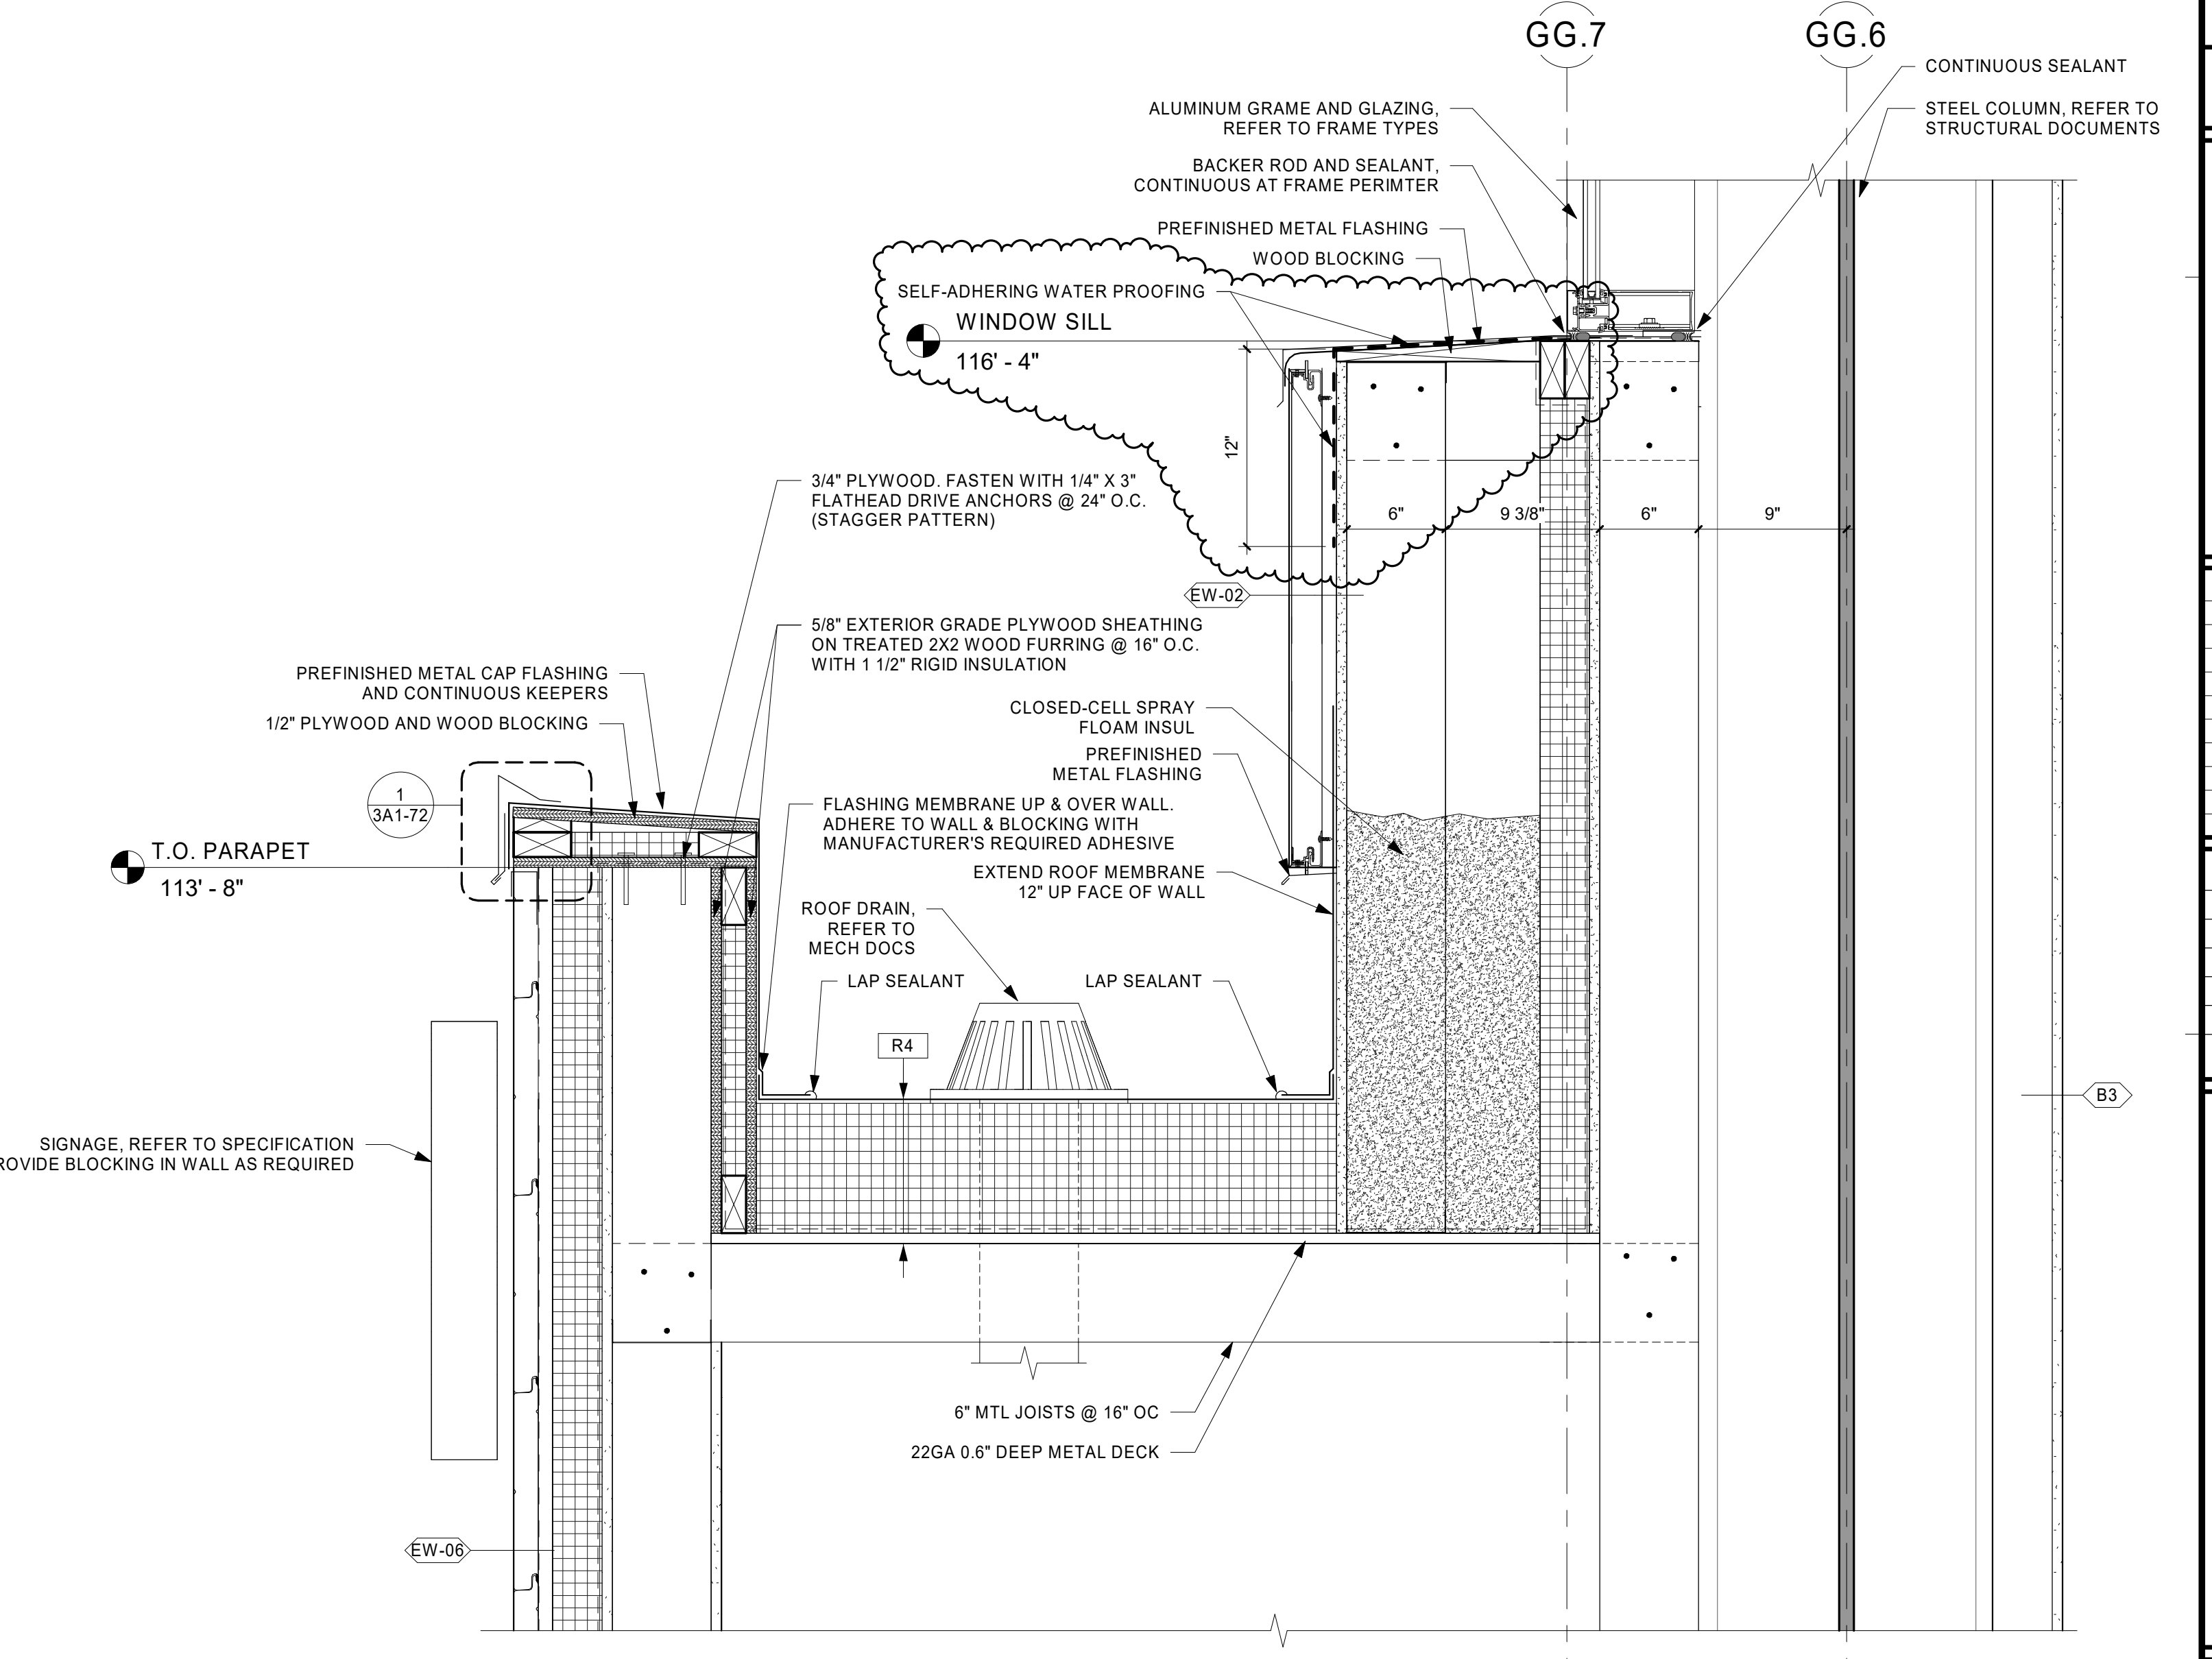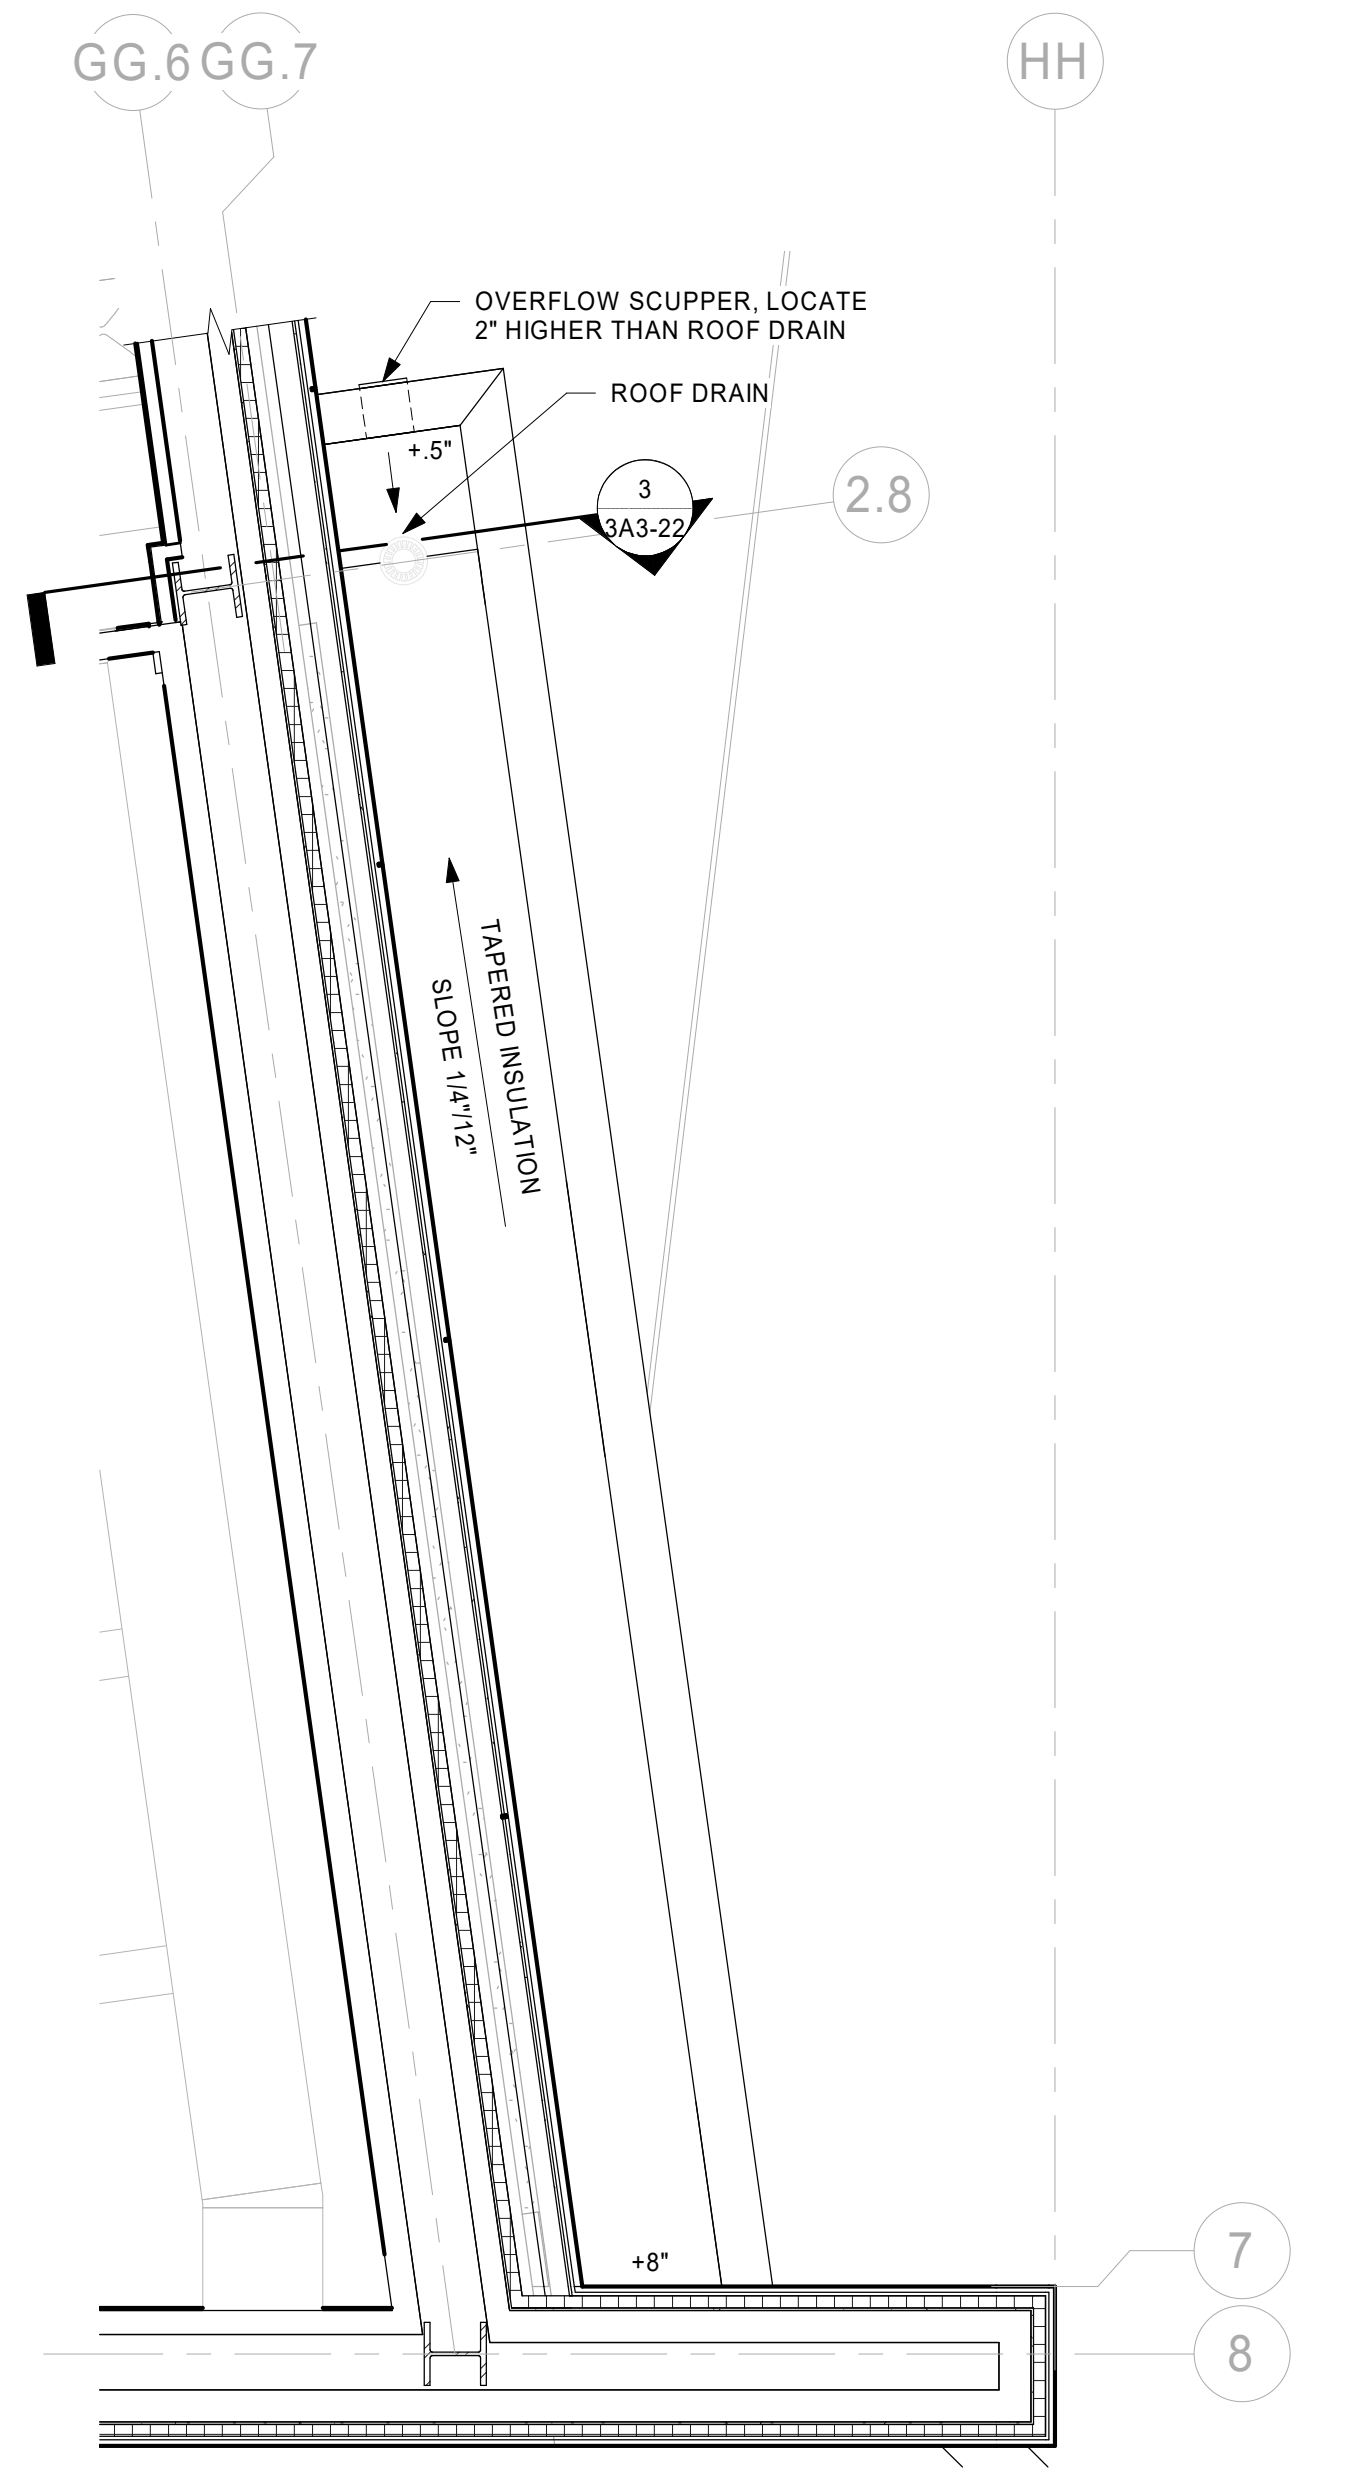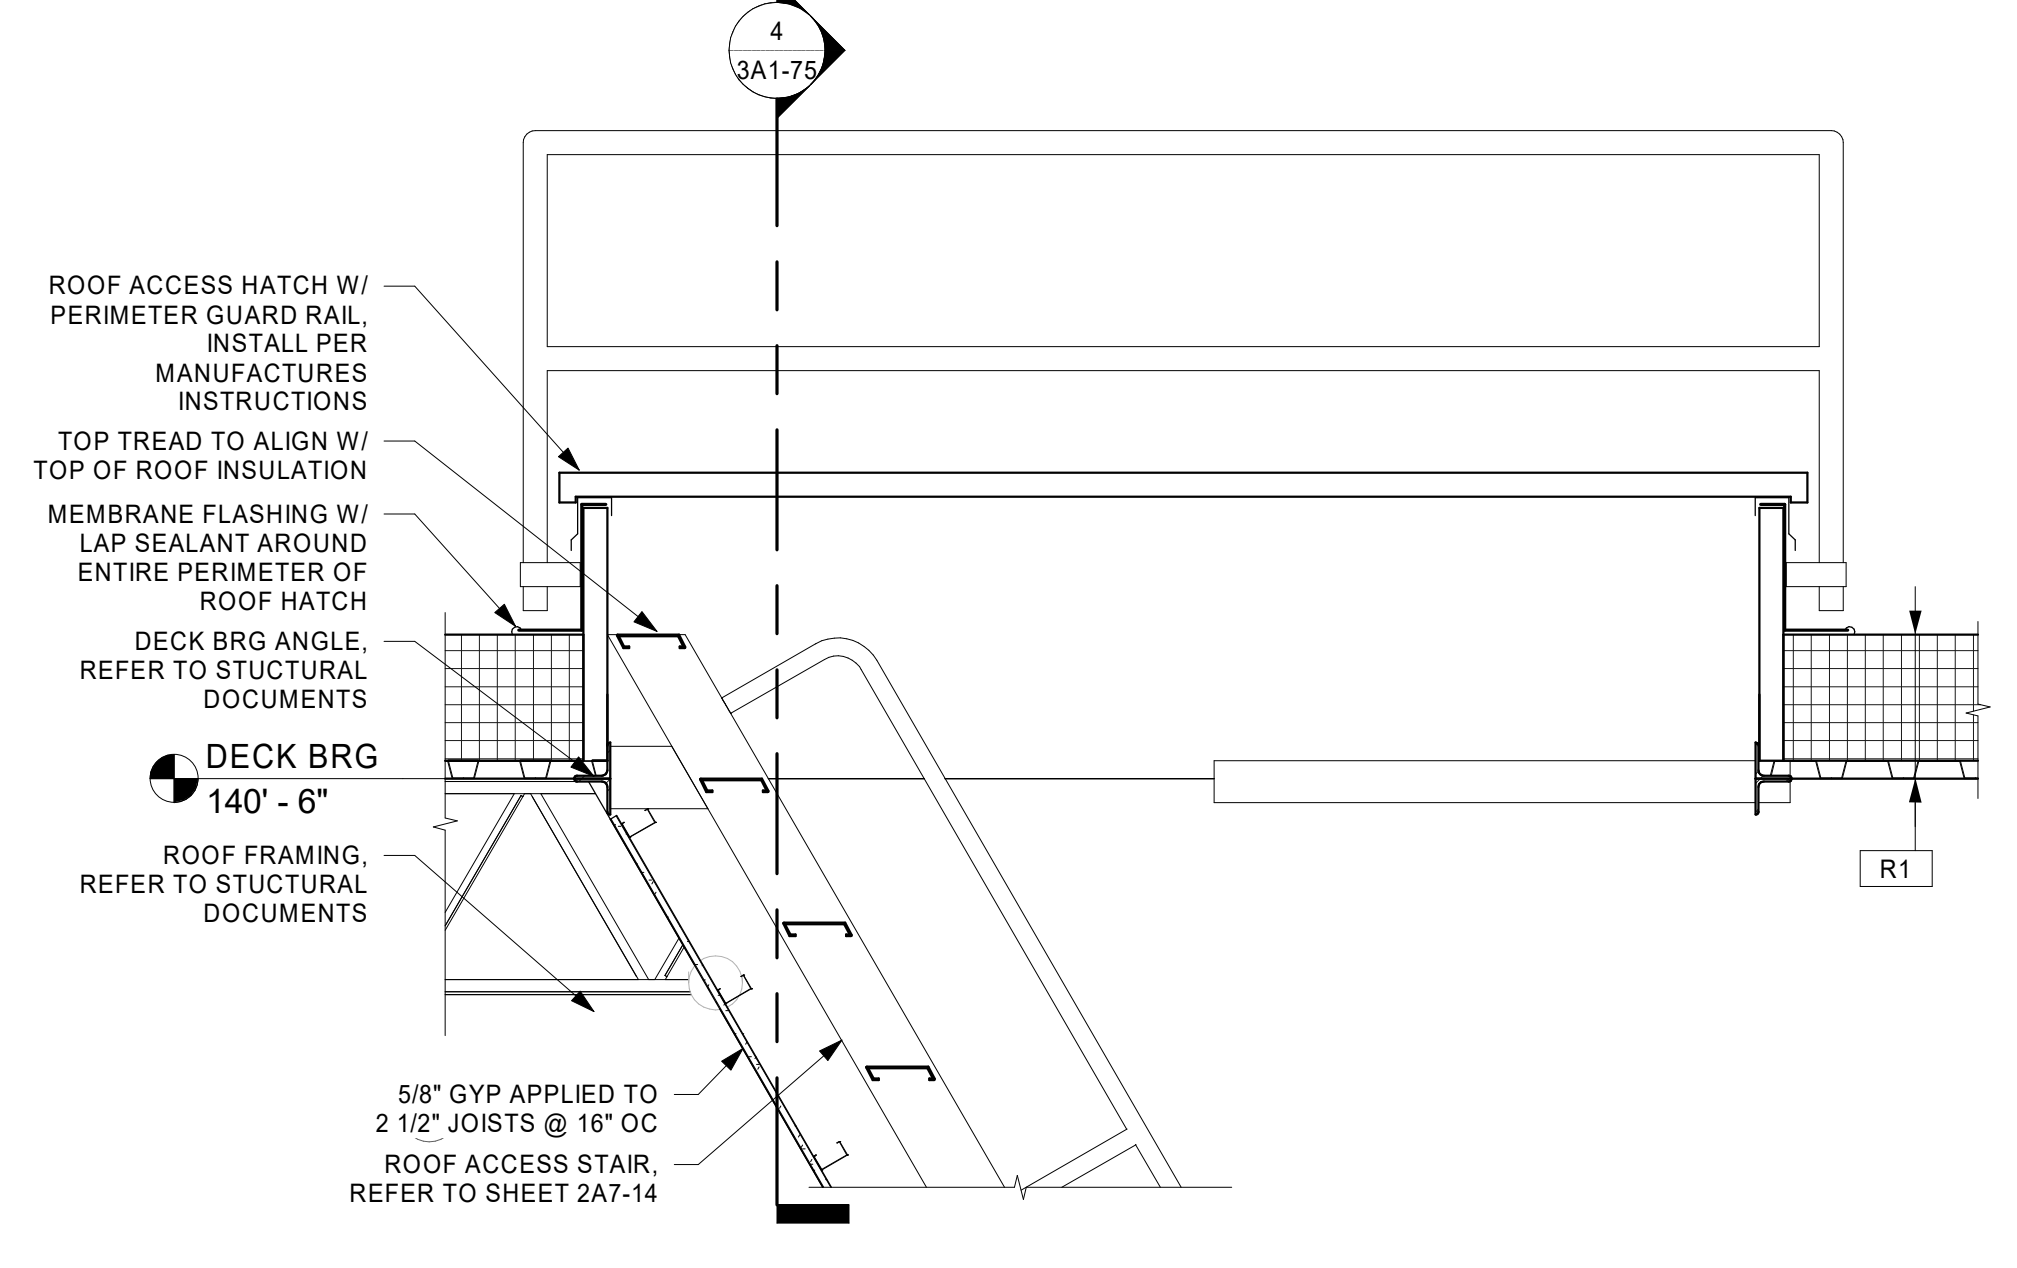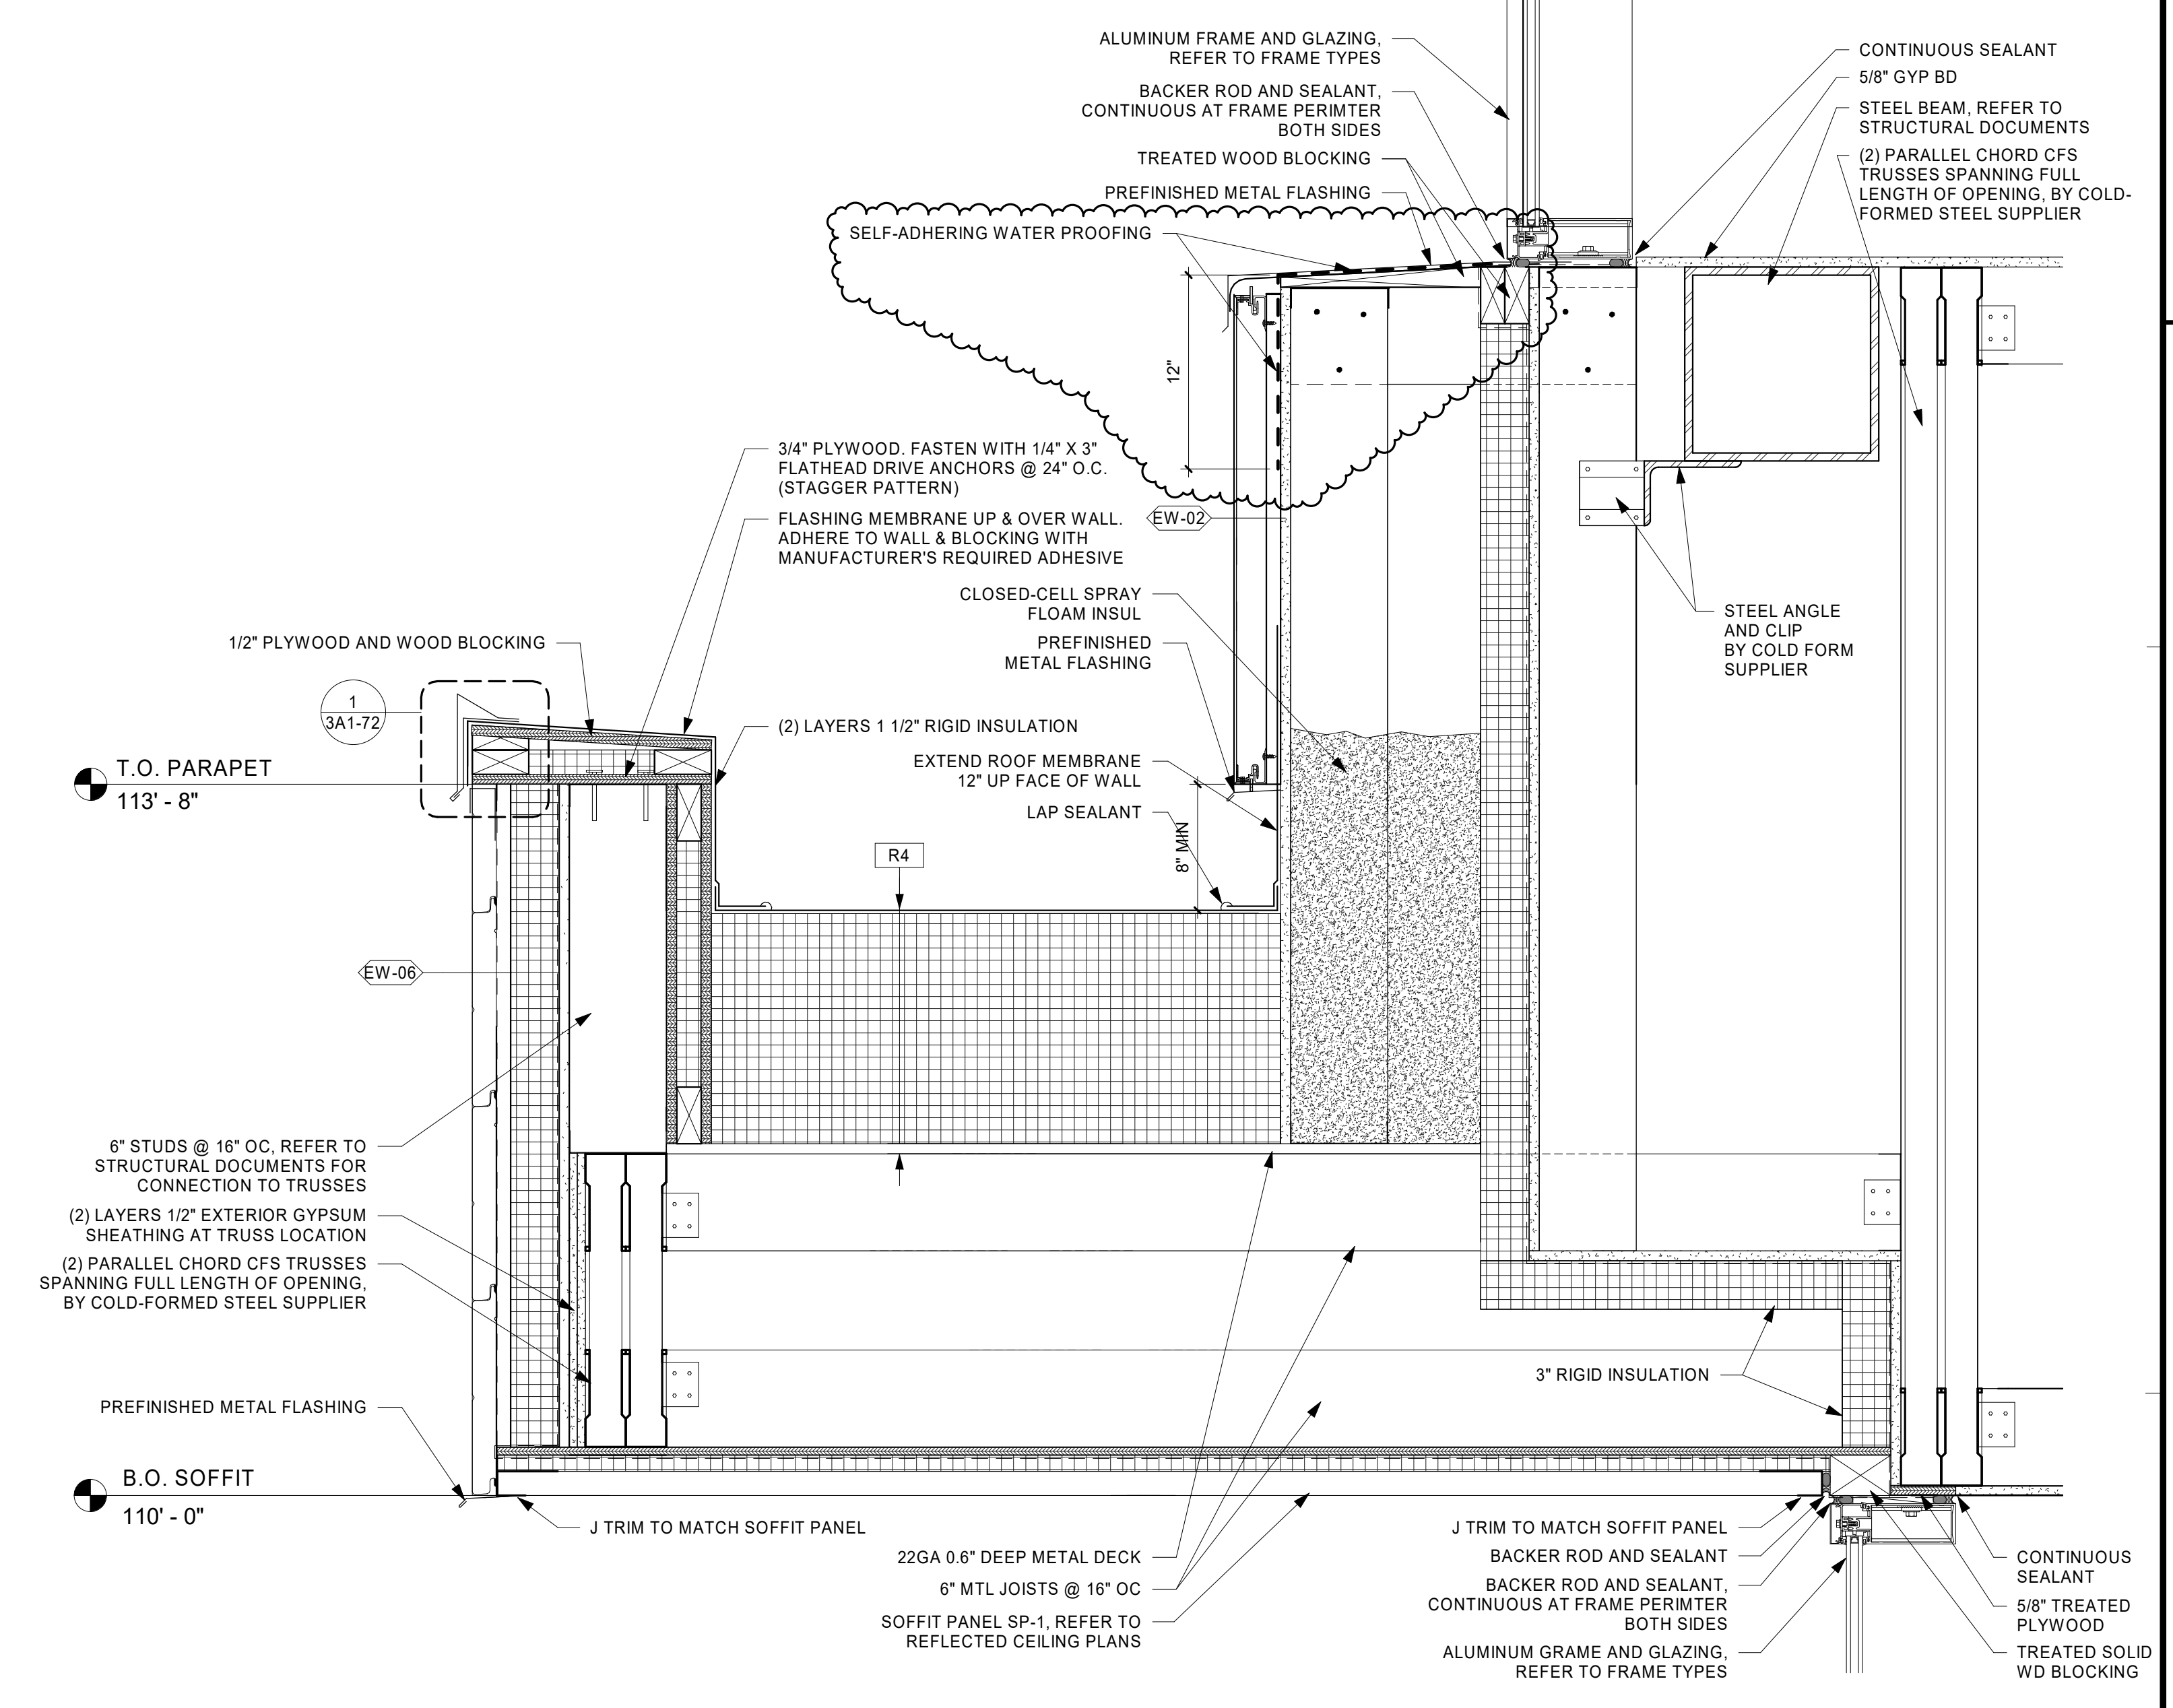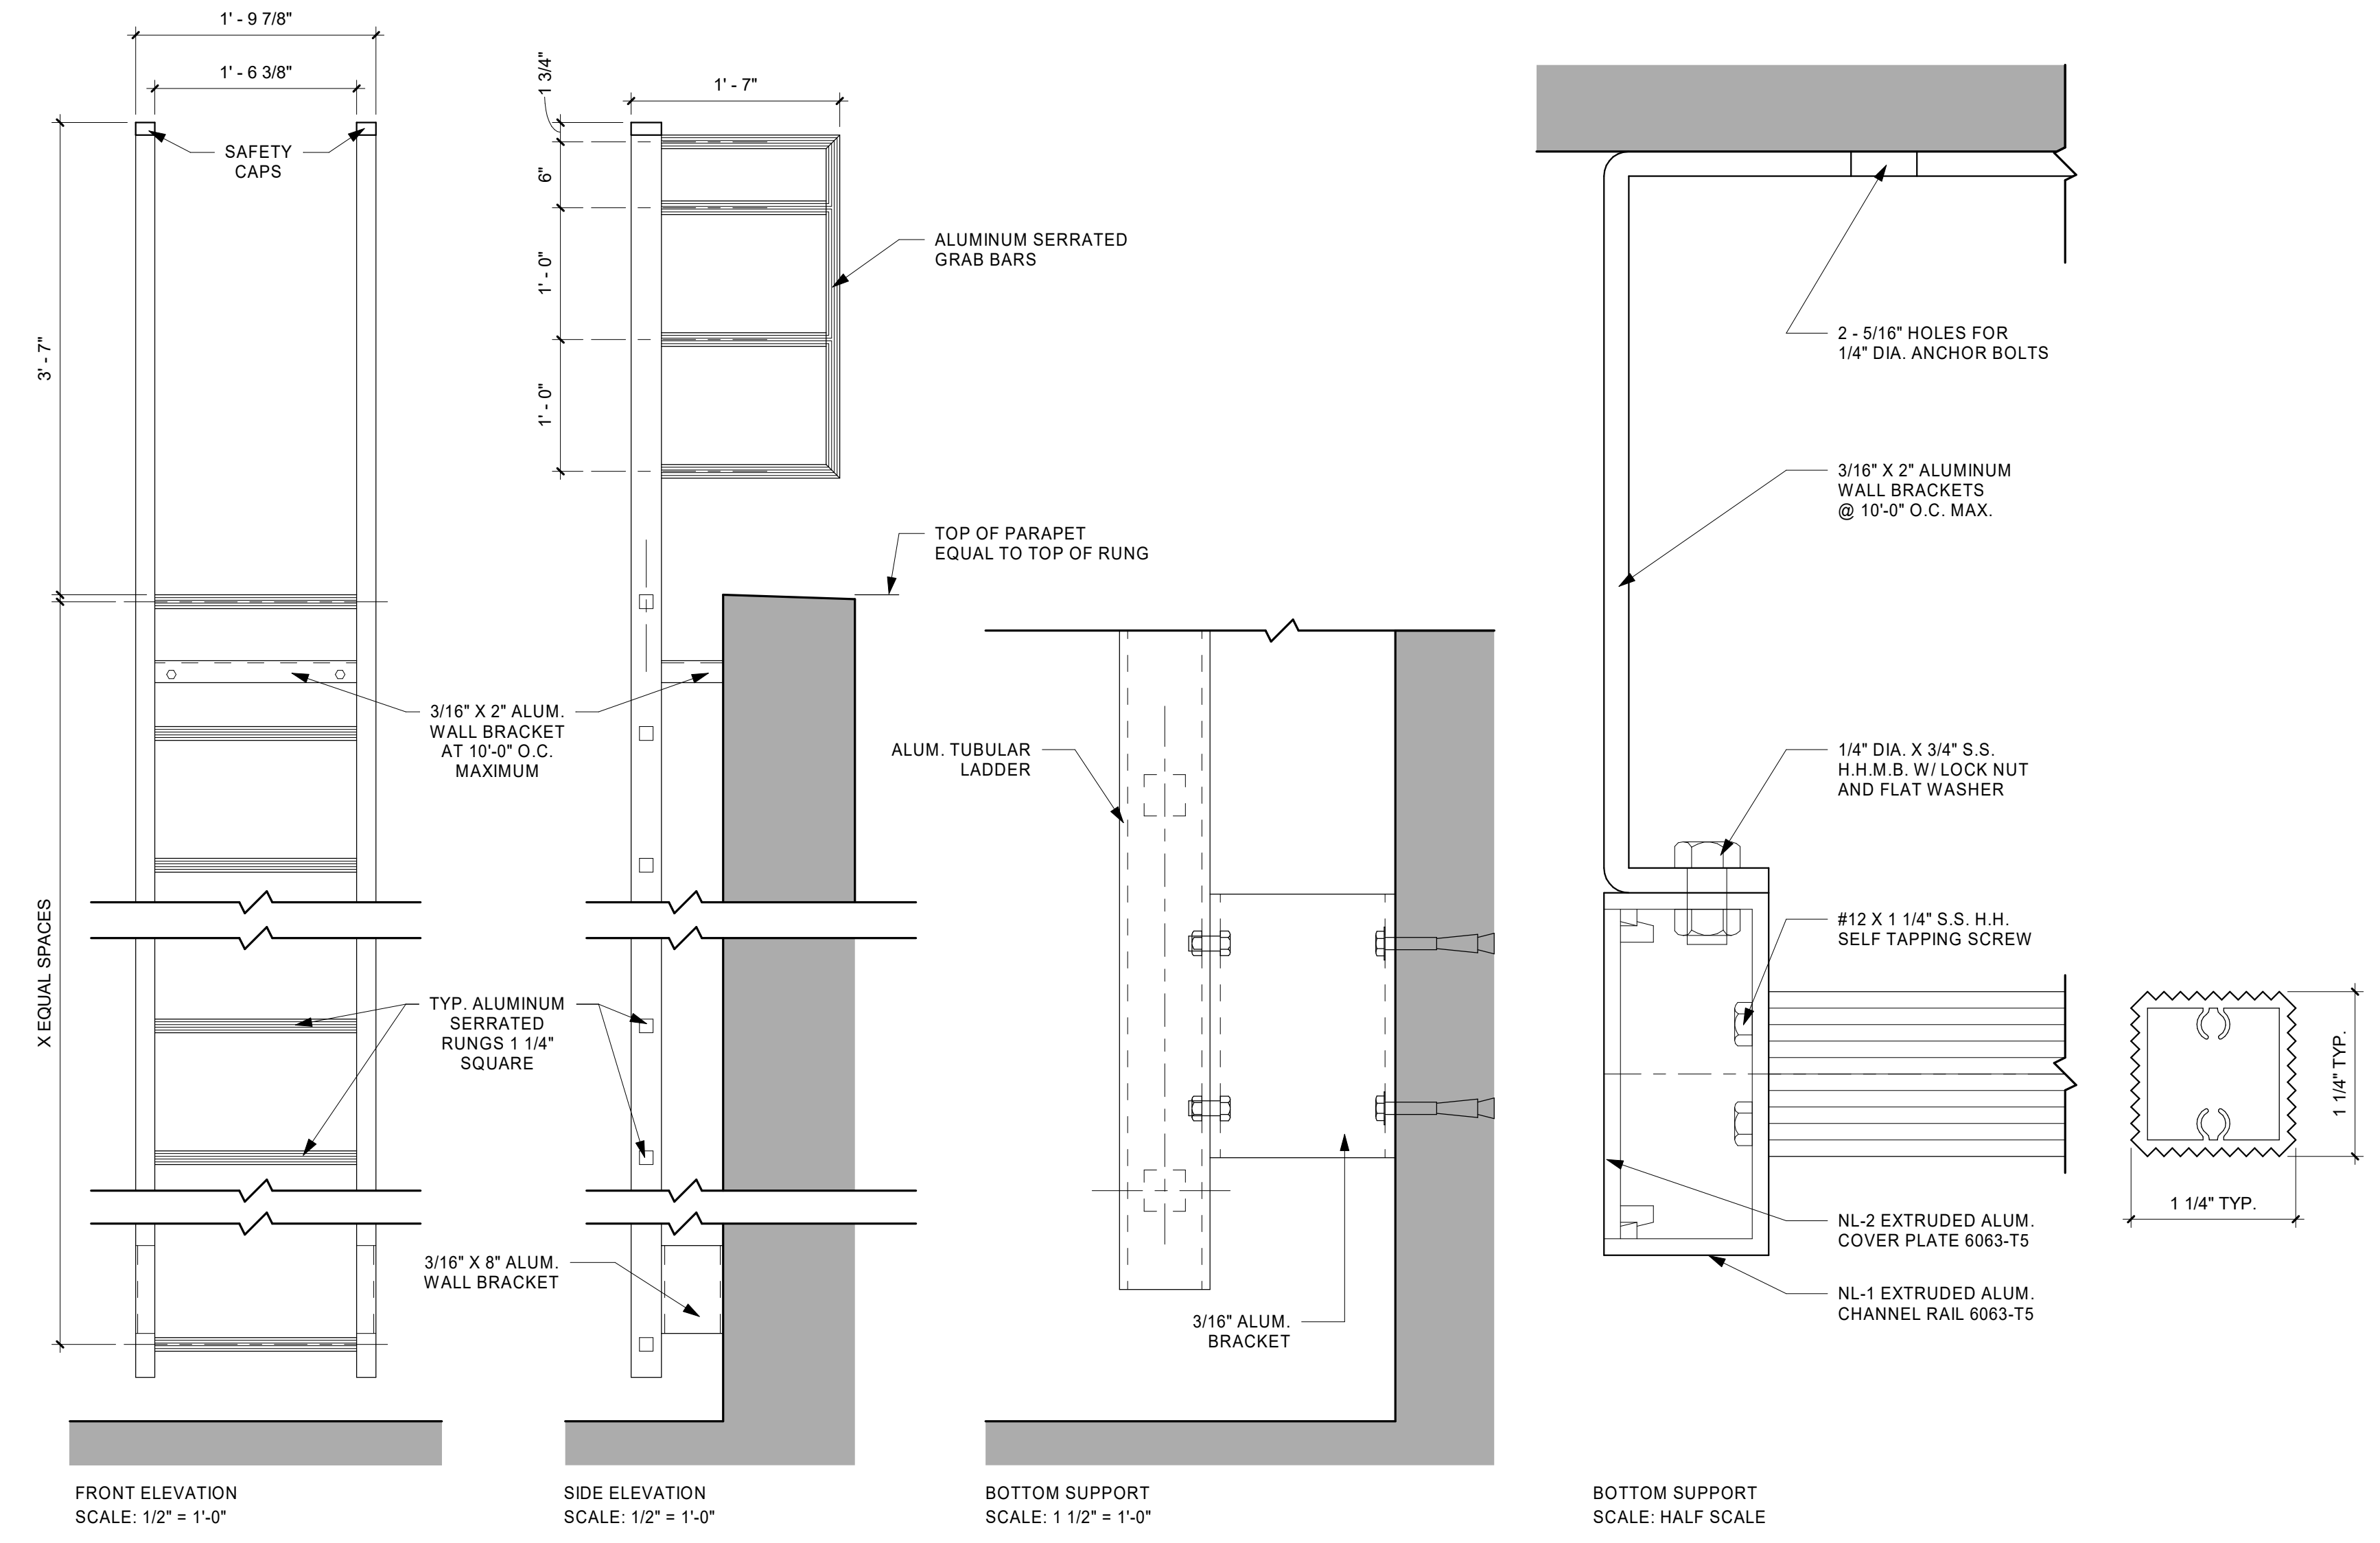

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PROJECT

LA CROSSE CENTER EXPANSION & RENOVATION

LA CROSSE WISCONSIN

REVISION SCHEDULE		
DATE	DESCRIPTION	BY
03/19/20	BP3 ADDENDUM 07	JMB
03/26/20	BP3 ADDENDUM 08	JMB
05/15/20	PR 13	JMB
08/05/20	PR 16	JMB
08/18/20	PR 21	JMB

PROJECT NO. 16-19990
FILE NAME 19990 Arch R18.rvt
DRAWN BY JMB
DESIGNED BY JPW/KMB
REVIEWED BY JPW/KMB
ORIGINAL ISSUE DATE 03/05/20

CLIENT PROJECT NO.

TITLE

ROOF DETAILS

SHEET

3A1-75

REFERENCE SCALE
1" = 1'-0"
1/4" = 1'-0"
1/2" = 1'-0"
3/4" = 1'-0"
1" = 1'-0"
2" = 1'-0"




EQUIPMENT SCHEDULE			
MARK	DESCRIPTION	PROVIDED BY	INSTALLED BY
ADA UREF	UNDER COUNTER REFRIGERATOR	CONTRACTOR	CONTRACTOR
CH	COAT HOOK	OWNER	OWNER
COF	COFFEE MAKER	OWNER	OWNER
MB	MAGNETIC FABRIC BULLETIN BOARD 4' X 3'	CONTRACTOR	CONTRACTOR
MW	MICROWAVE	OWNER	OWNER
REF	REFRIGERATOR	OWNER	OWNER
TB1	4' X 4' TACK BOARD	CONTRACTOR	CONTRACTOR
TB2	3' X 4' TACK BOARD	CONTRACTOR	CONTRACTOR
TC	TIME CLOCK	OWNER	OWNER
TOAST	TOASTER OVEN	OWNER	OWNER
TV	TELEVISION MONITOR	OWNER	OWNER
VEN	VENDING MACHINE	OWNER	OWNER


RESTROOM ACCESSORY SCHEDULE			
MARK	DESCRIPTION	PROVIDED BY	INSTALLED BY
BCS	BABY CHANGING STATION - SURFACE MOUNTED	CONTRACTOR	CONTRACTOR
GB	36" GRAB BAR, 24" GRAB BAR & 18" MIN VERT GRAB BAR	CONTRACTOR	CONTRACTOR
GBS	48" GRAB BAR & (2) 30" GRAB BARS	CONTRACTOR	CONTRACTOR
MR-1	4' X 3' MIRROR, REFER TO SPECS	CONTRACTOR	CONTRACTOR
MR-2	2' X 3' MIRROR, REFER TO SPECS	CONTRACTOR	CONTRACTOR
PT	PAPER TOWEL DISPENSER - ROLL	OWNER	OWNER
SD	SOAP DISPENSER	OWNER	OWNER
SN	SANITARY NAPKIN DISPOSAL - SURFACE MOUNTED	CONTRACTOR	CONTRACTOR
TP-2	TOILET TISSUE DISPENSER - DOUBLE	CONTRACTOR	CONTRACTOR

WALL LEGEND	
	EXISTING CONSTRUCTION TO REMAIN
	NEW CONSTRUCTION


KEYNOTE LEGEND	
12	INFILL WALL TO MATCH EXISTING ADJACENT WALLS
55	RECESSED FLOOR TROUGH, REFER TO FOOD SERVICE & PLUMBING DRAWINGS
56	REFER TO FOOD SERVICE PLANS FOR LAYOUT & EQUIPMENT, LAMINATE WALL FULL HEIGHT WITH 1 LAYER OF 5/8" CEMENT BOARD.
59	CUT & PATCH EXISTING WALL FOR PLUMBING WORK, REFER TO PLUMBING DRAWINGS.
64	REINSTALL SALVAGED OVERHEAD COILING DOOR AND TRACK AFTER WALL MODIFICATIONS HAVE BEEN COMPLETED AND NEW COUNTERTOP HAS BEEN INSTALLED.
79	ACCESSIBLE MOUNTED FIXTURE, REFER TO ACCESSIBLE MOUNTING HEIGHTS SHEET 303-111
80	WALL TO UNDERSIDE OF COUNTER, REFER TO FOOD SERVICE DRAWINGS.
81	CUT COUNTERTOP TO ACCOMMODATE EQUIPMENT, VERIFY DIMENSIONS WITH EQUIPMENT.
E5	EXISTING PLUMBING FIXTURE TO REMAIN, REFER TO MECHANICAL DOCUMENTS.
ID36	ALL TOILET PARTITIONS AND/OR URINAL PARTITIONS IN THIS ROOM TO BE SP-1, REFER TO FINISH SCHEDULES.

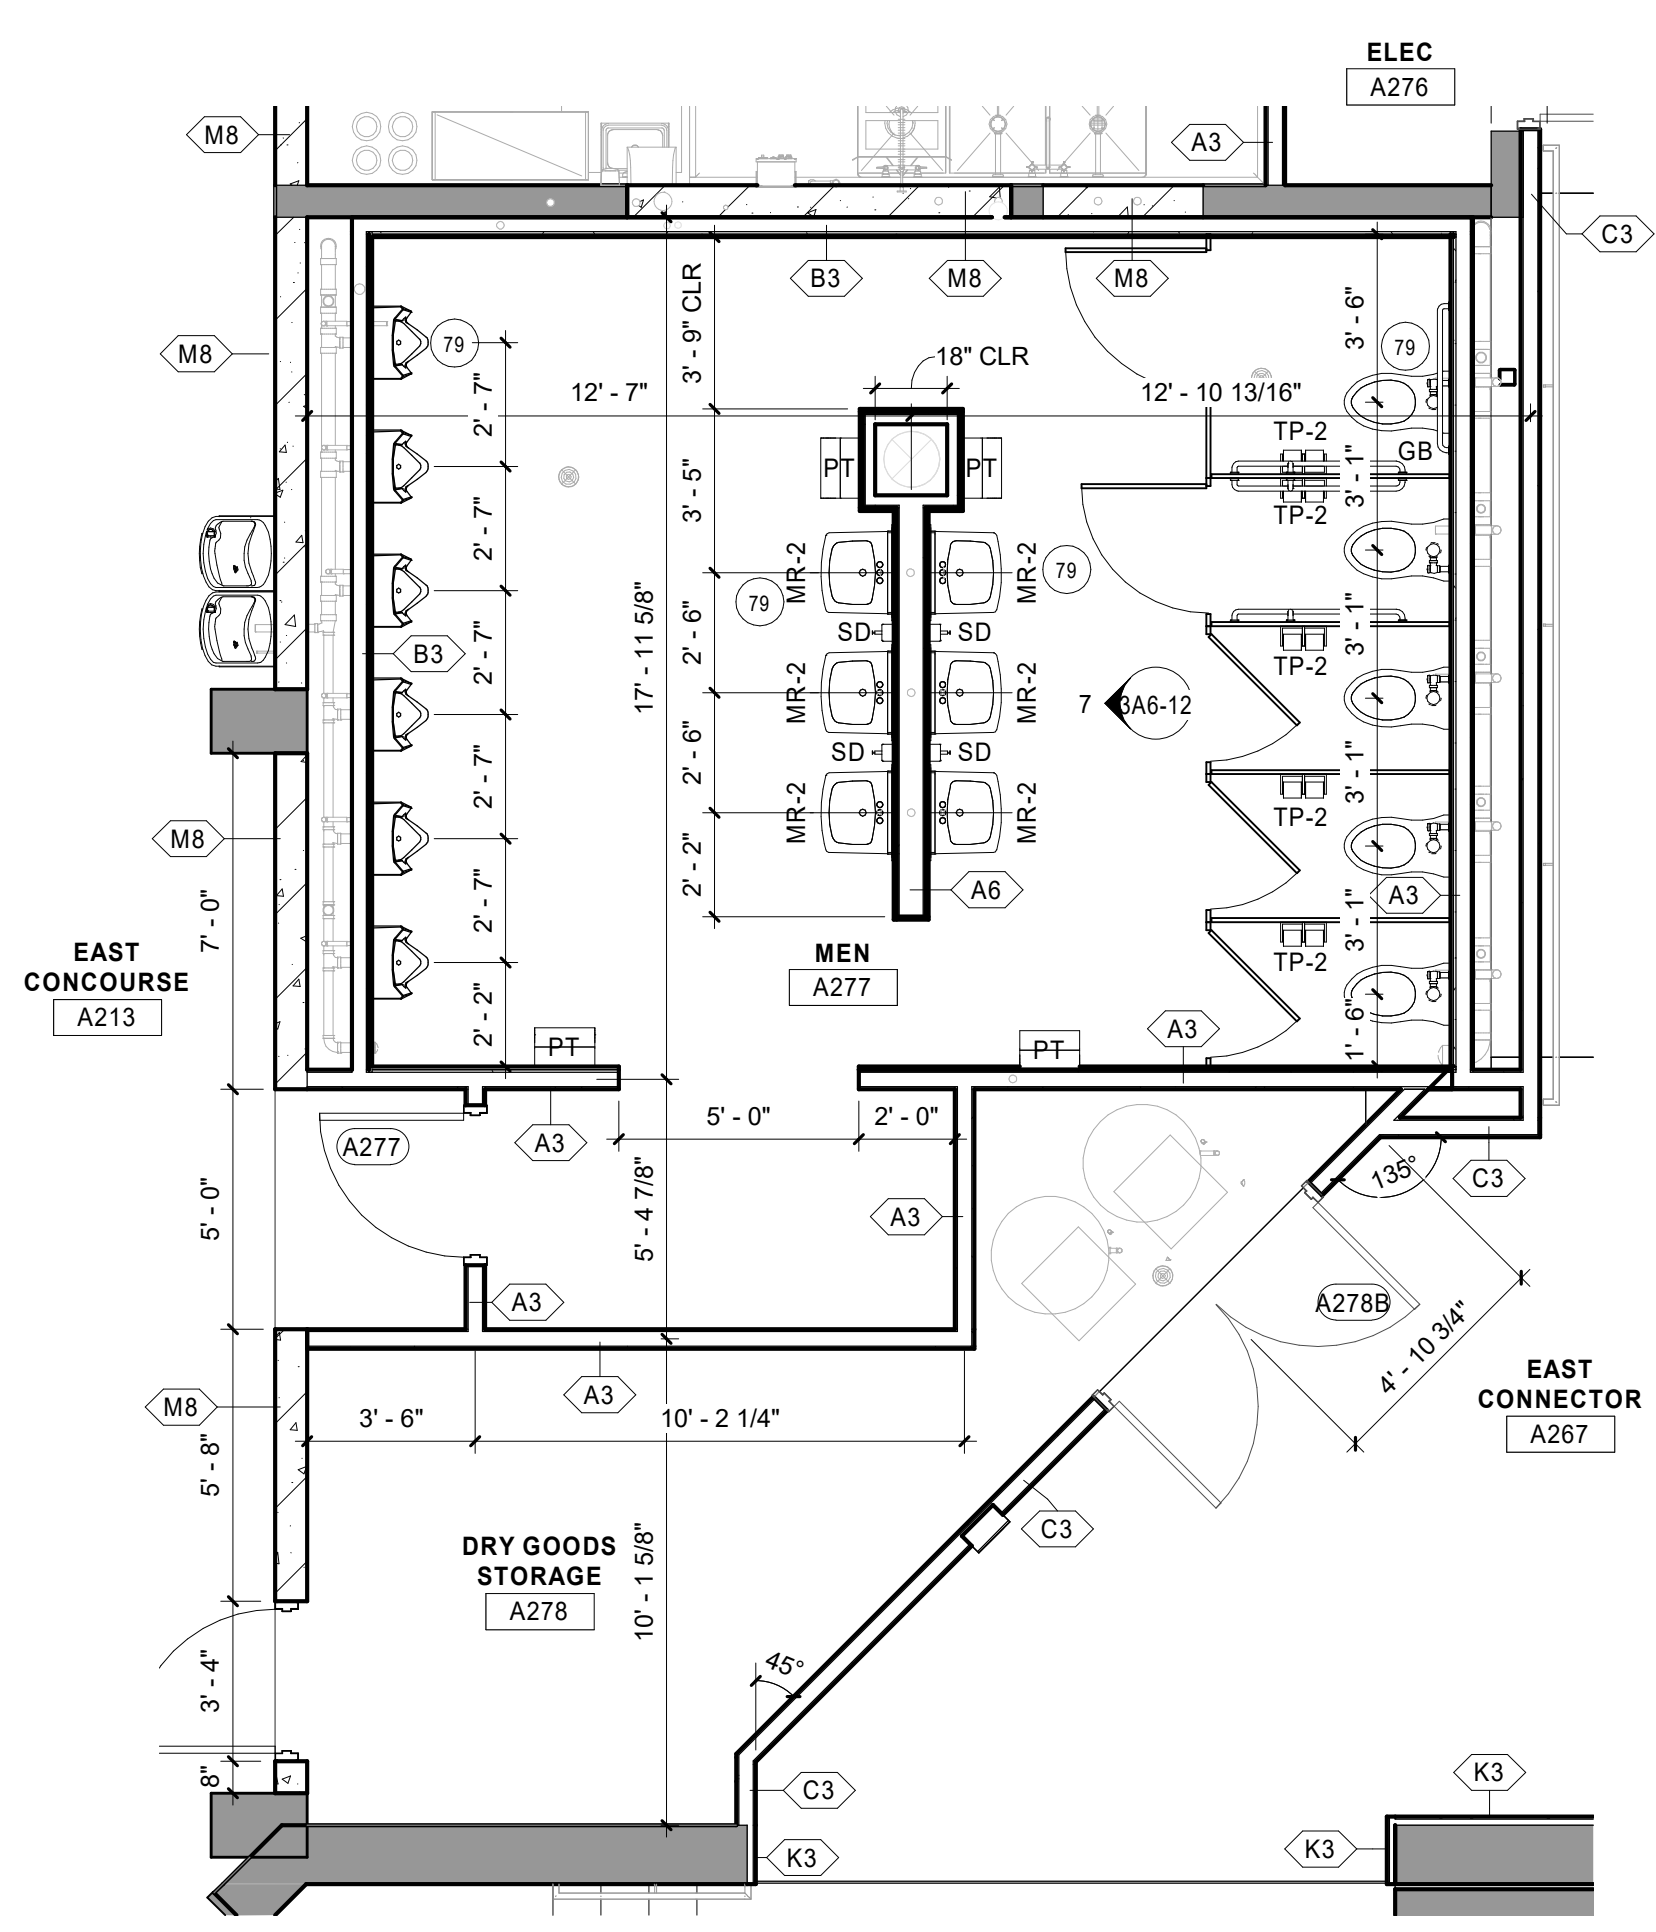


1 CONCOURSE LEVEL - EAST MEN'S RESTROOM - AREA D
1/4" = 1'-0"

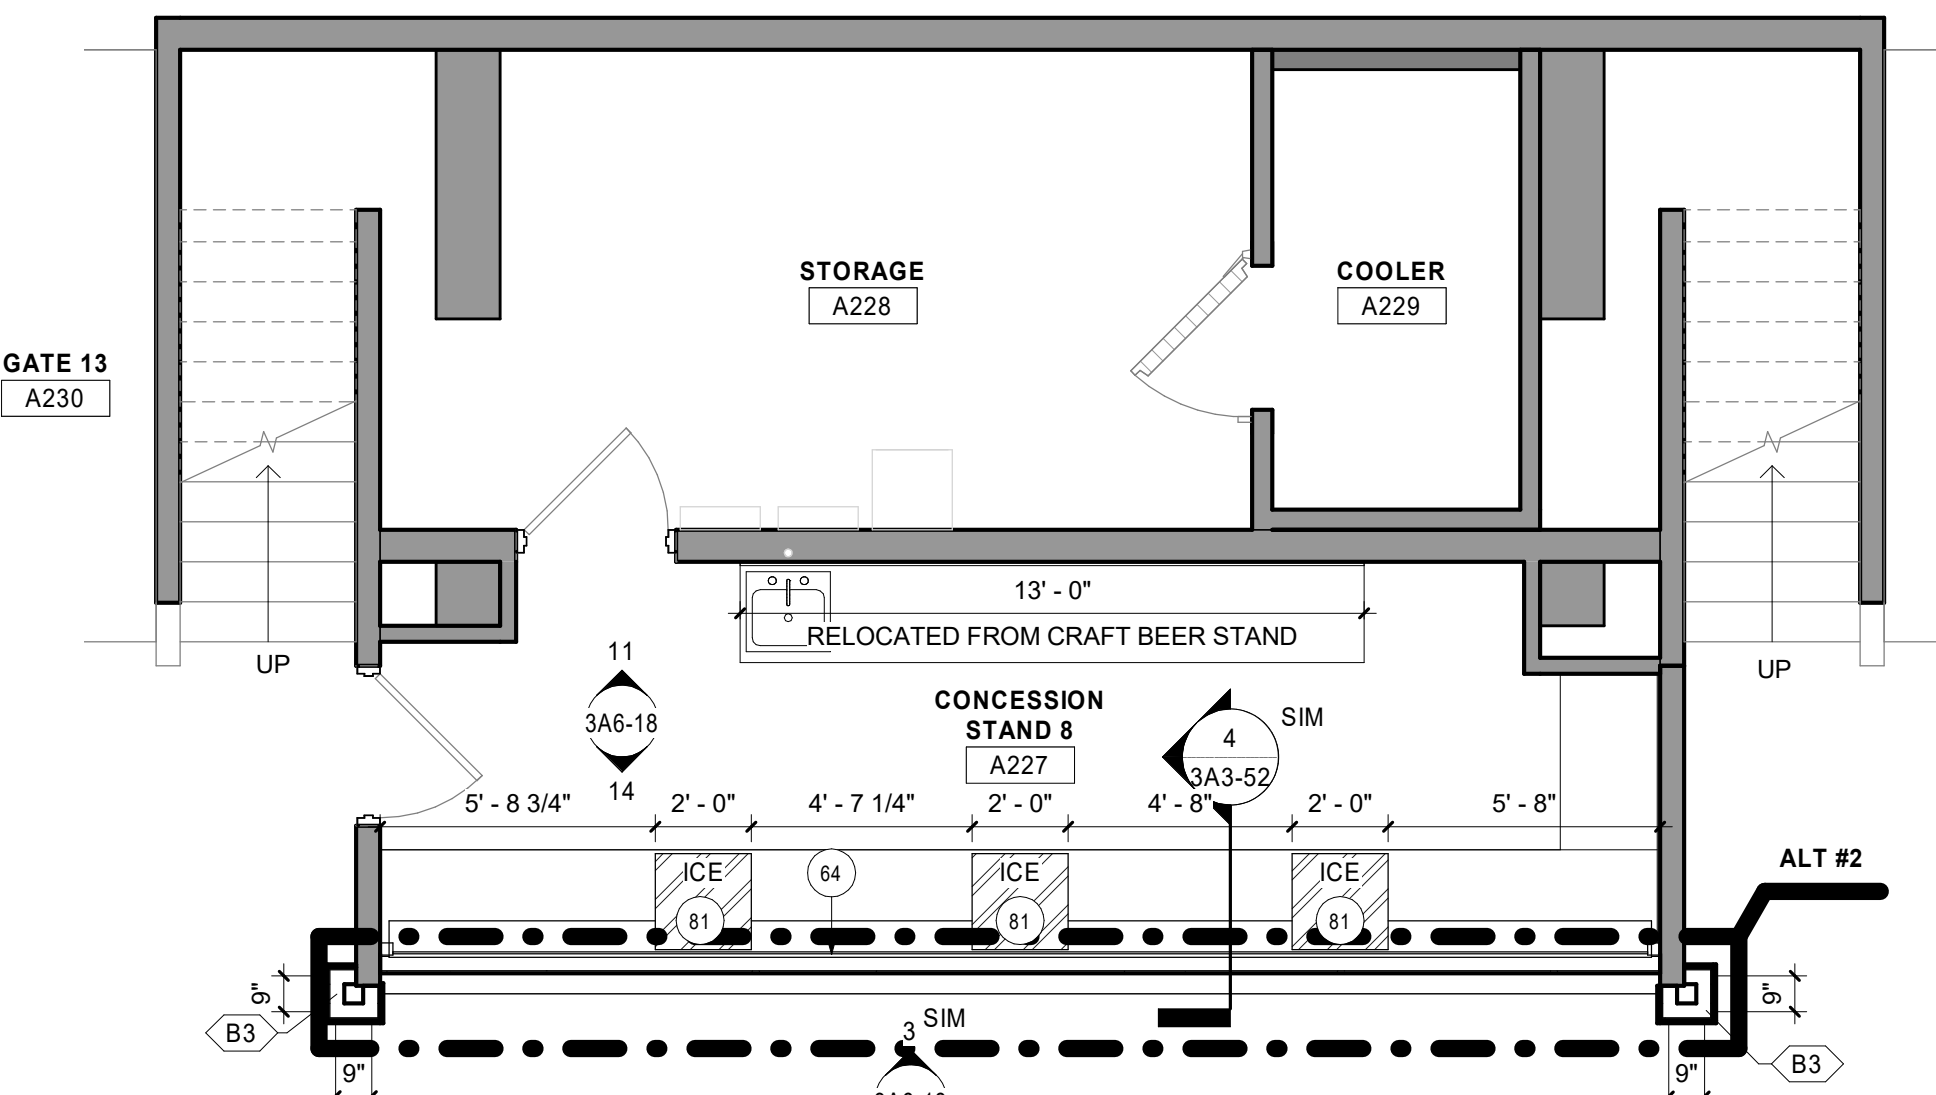

2 CONCOURSE LEVEL - SOUTH CONCESSION STAND - AREA D
1/4" = 1'-0"

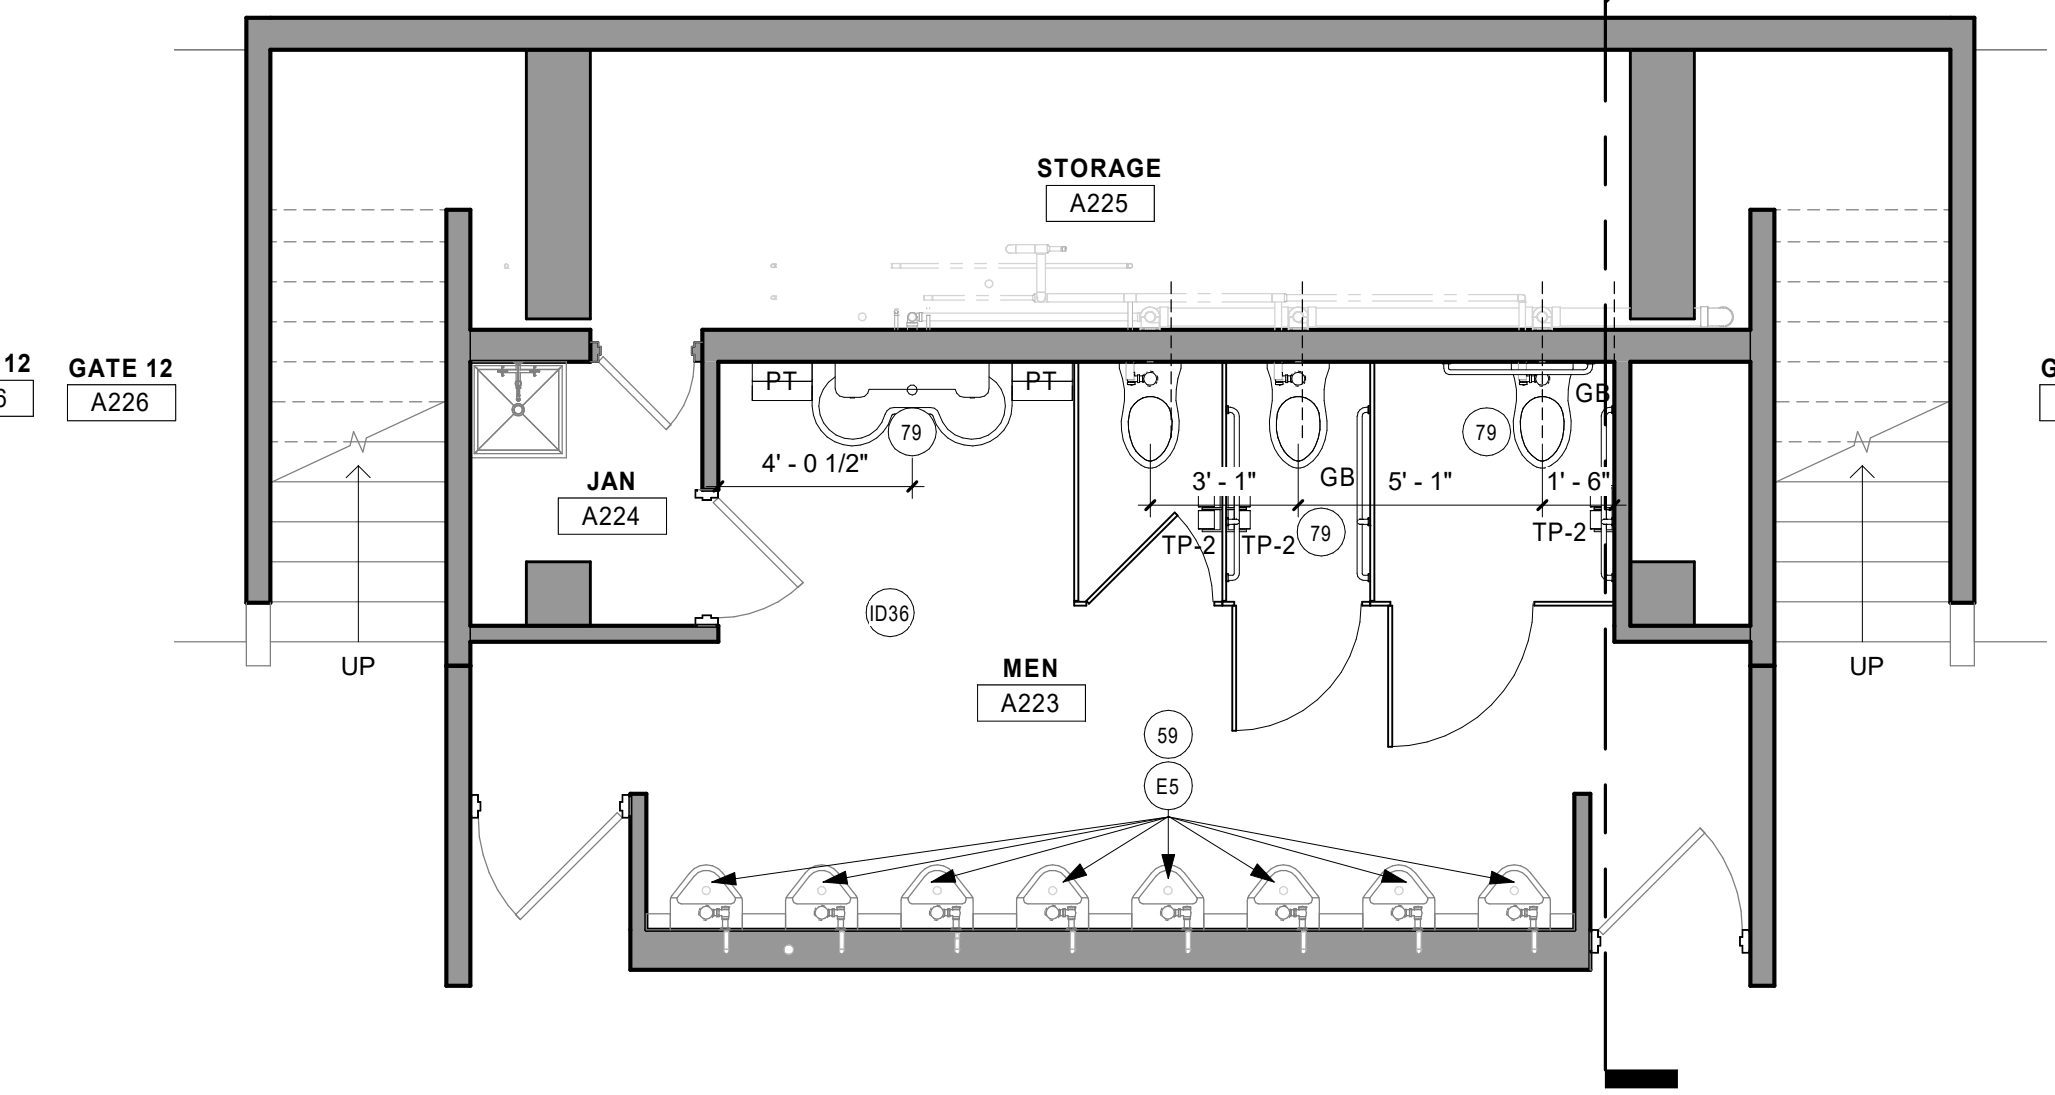

3 CONCOURSE LEVEL - MEN'S RESTROOM - AREA D
1/4" = 1'-0"

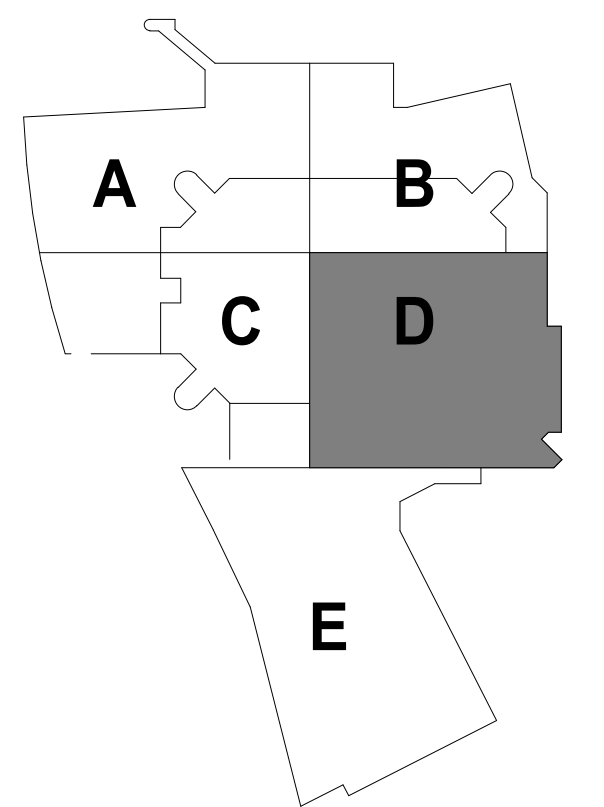

KEYPLAN

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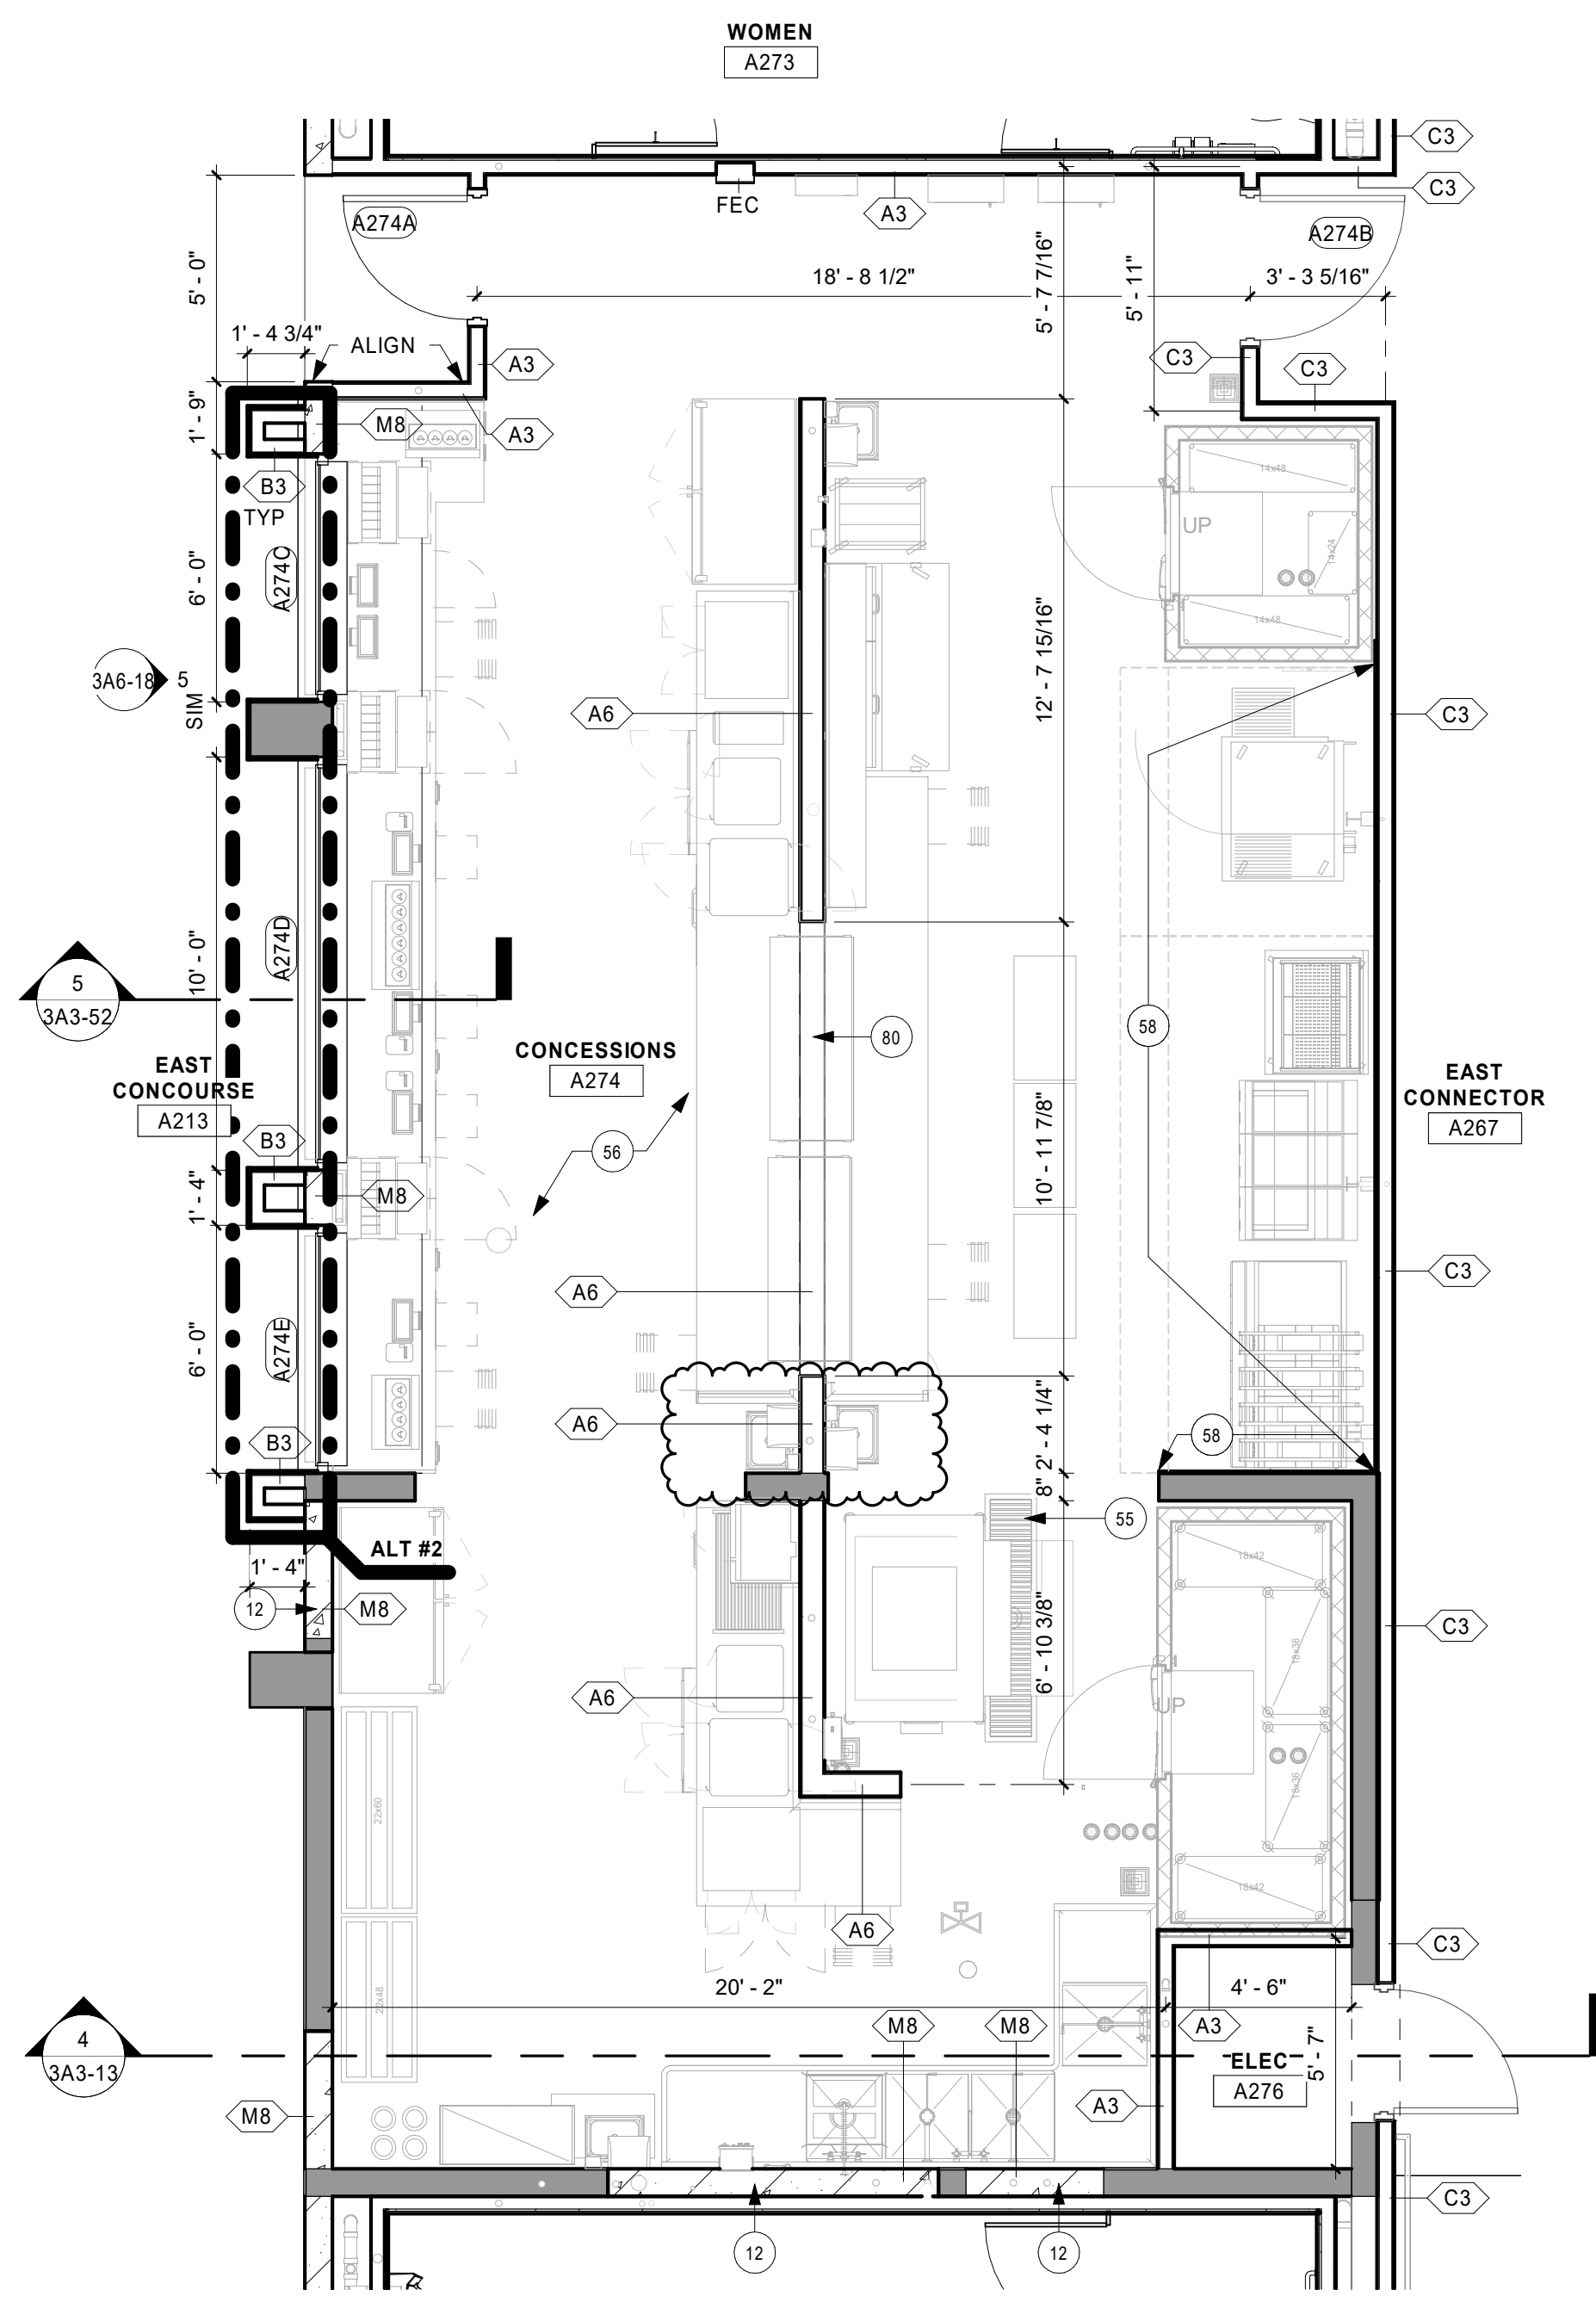
PROJECT

LA CROSSE CENTER EXPANSION & RENOVATION


LA CROSSE WISCONSIN

REVISION SCHEDULE		
DATE	DESCRIPTION	BY
03/26/20	BP3 ADDENDUM 08	JMB
04/30/20	PR 12	JMB
05/15/20	PR 13	JMB
06/05/20	PR 15	JMB
06/05/20	PR 16	JMB
08/18/20	PR 21	JMB


PROJECT NO.	16-19990
FILE NAME	19990 Arch R18.rvt
DRAWN BY	JMB
DESIGNED BY	JPW/KMB
REVIEWED BY	JPW/KMB
ORIGINAL ISSUE DATE	03/05/20
CLIENT PROJECT NO.	





4 CONCOURSE LEVEL - EAST CONCESSION STAND - AREA D
1/4" = 1'-0"

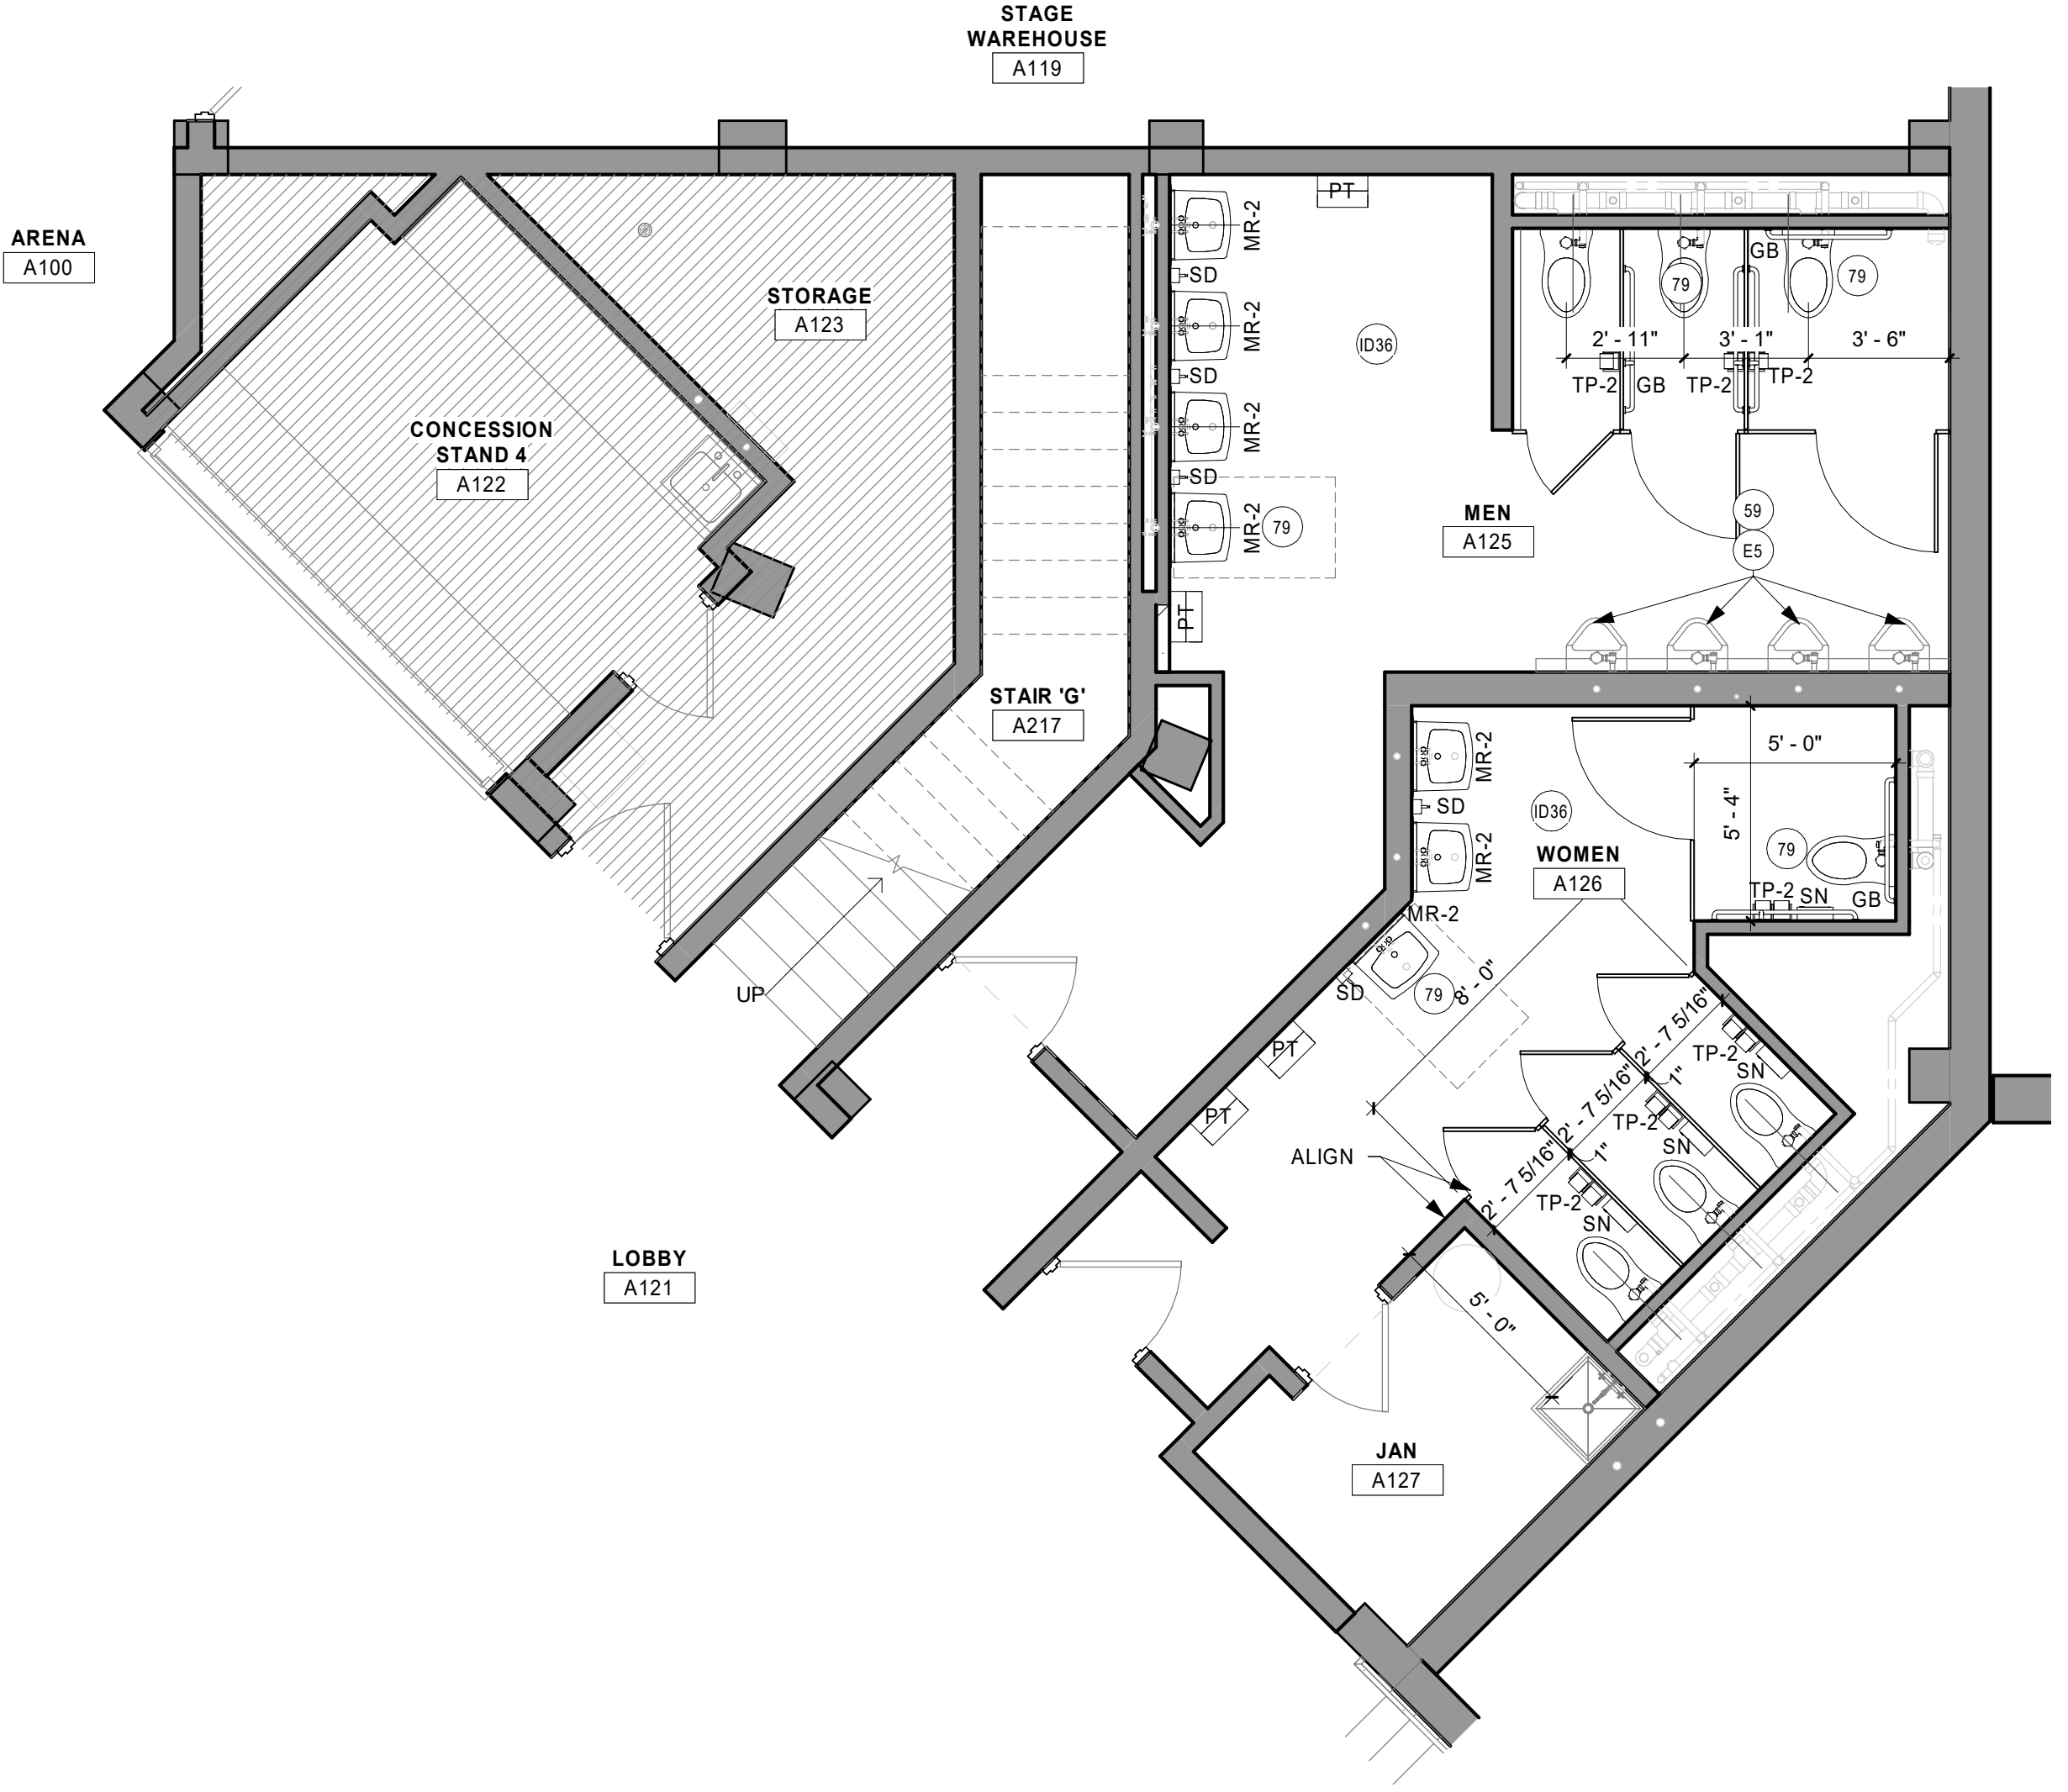

5 ARENA LEVEL CONCESSIONS AND RESTROOM PLANS - AREA D
1/4" = 1'-0"

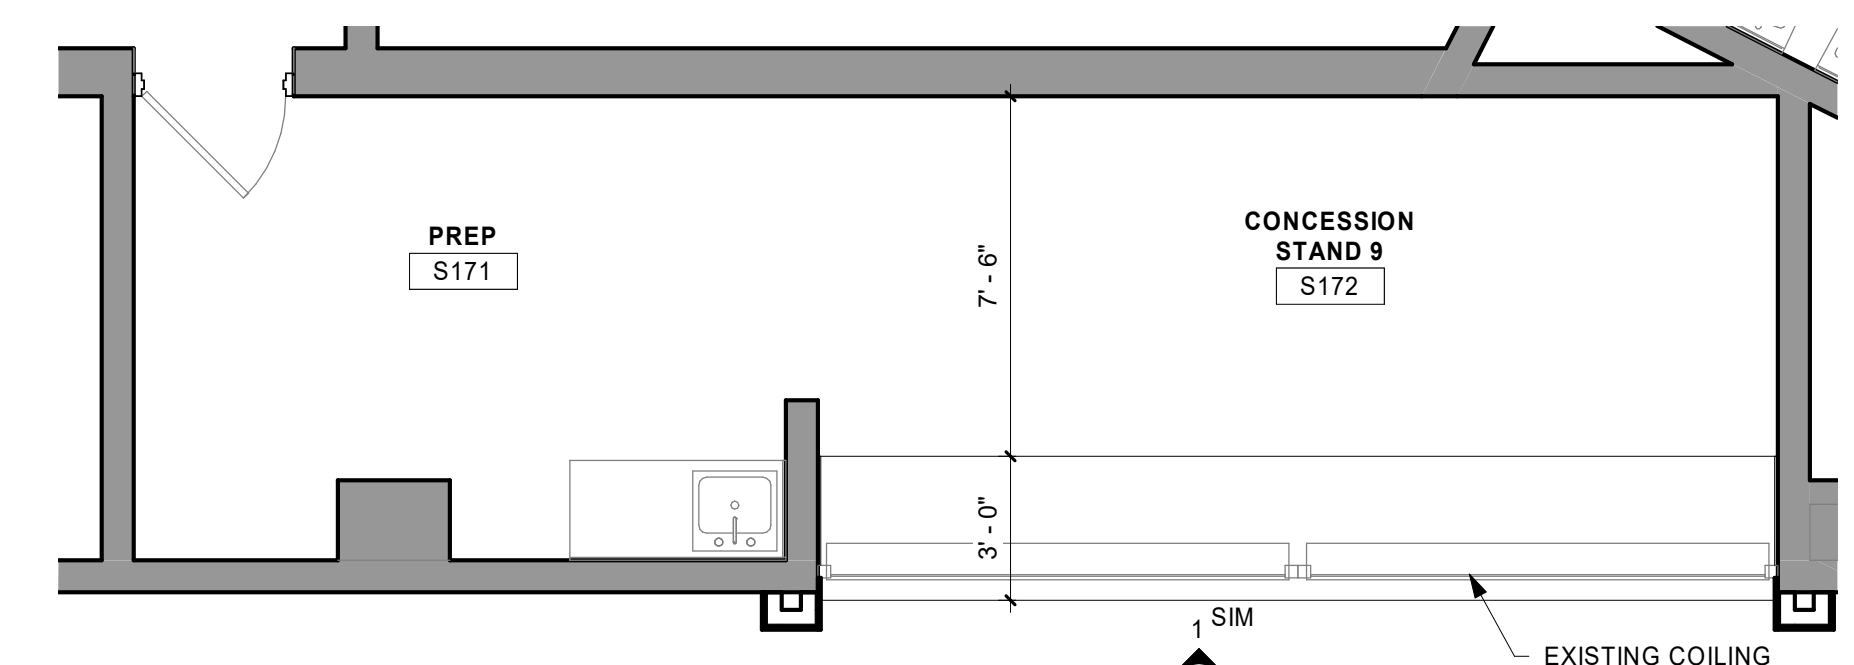

6 CONCESSION STAND 9
1/4" = 1'-0"

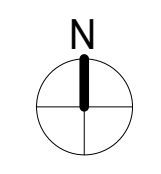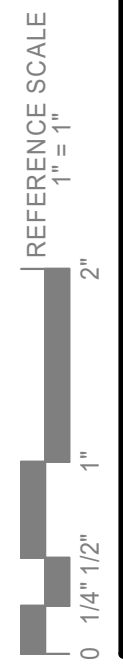

ENLARGED PLANS - AREA D



SHEET 3A5-15

SHEET NOTES

1. ALL DUCTWORK, PIPING, EQUIPMENT, ETC. INDICATED ON PLANS ARE BASED ON INFORMATION FROM CONSTRUCTION DOCUMENTS AND FIELD VERIFICATION OF THE EXISTING BUILDING. FIELD VERIFY ALL EXISTING CONDITIONS.
2. SANITARY PIPING OF SIZE 2" OR LESS TO BE SLOPED AT 1/4" 12".
3. SANITARY PIPING OF SIZE 3" AND GREATER TO BE SLOPED AT 1/8" 12".

KEYNOTE LEGEND

- 2 INSTALL NEW PLUMBING FIXTURE AND CONNECT TO EXISTING SANITARY AND DOMESTIC PIPING. TYP.
- 111 FIXTURES NOT TAGGED SHOWN ON ADJACENT PLAN.

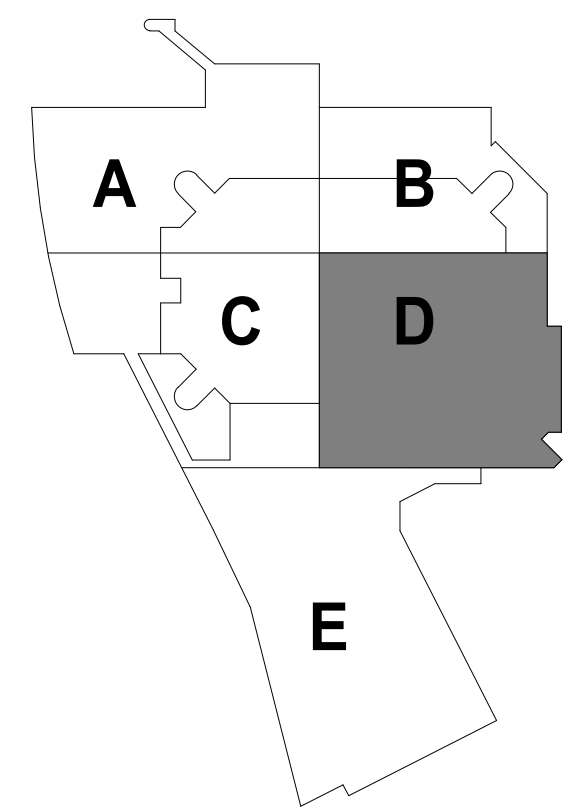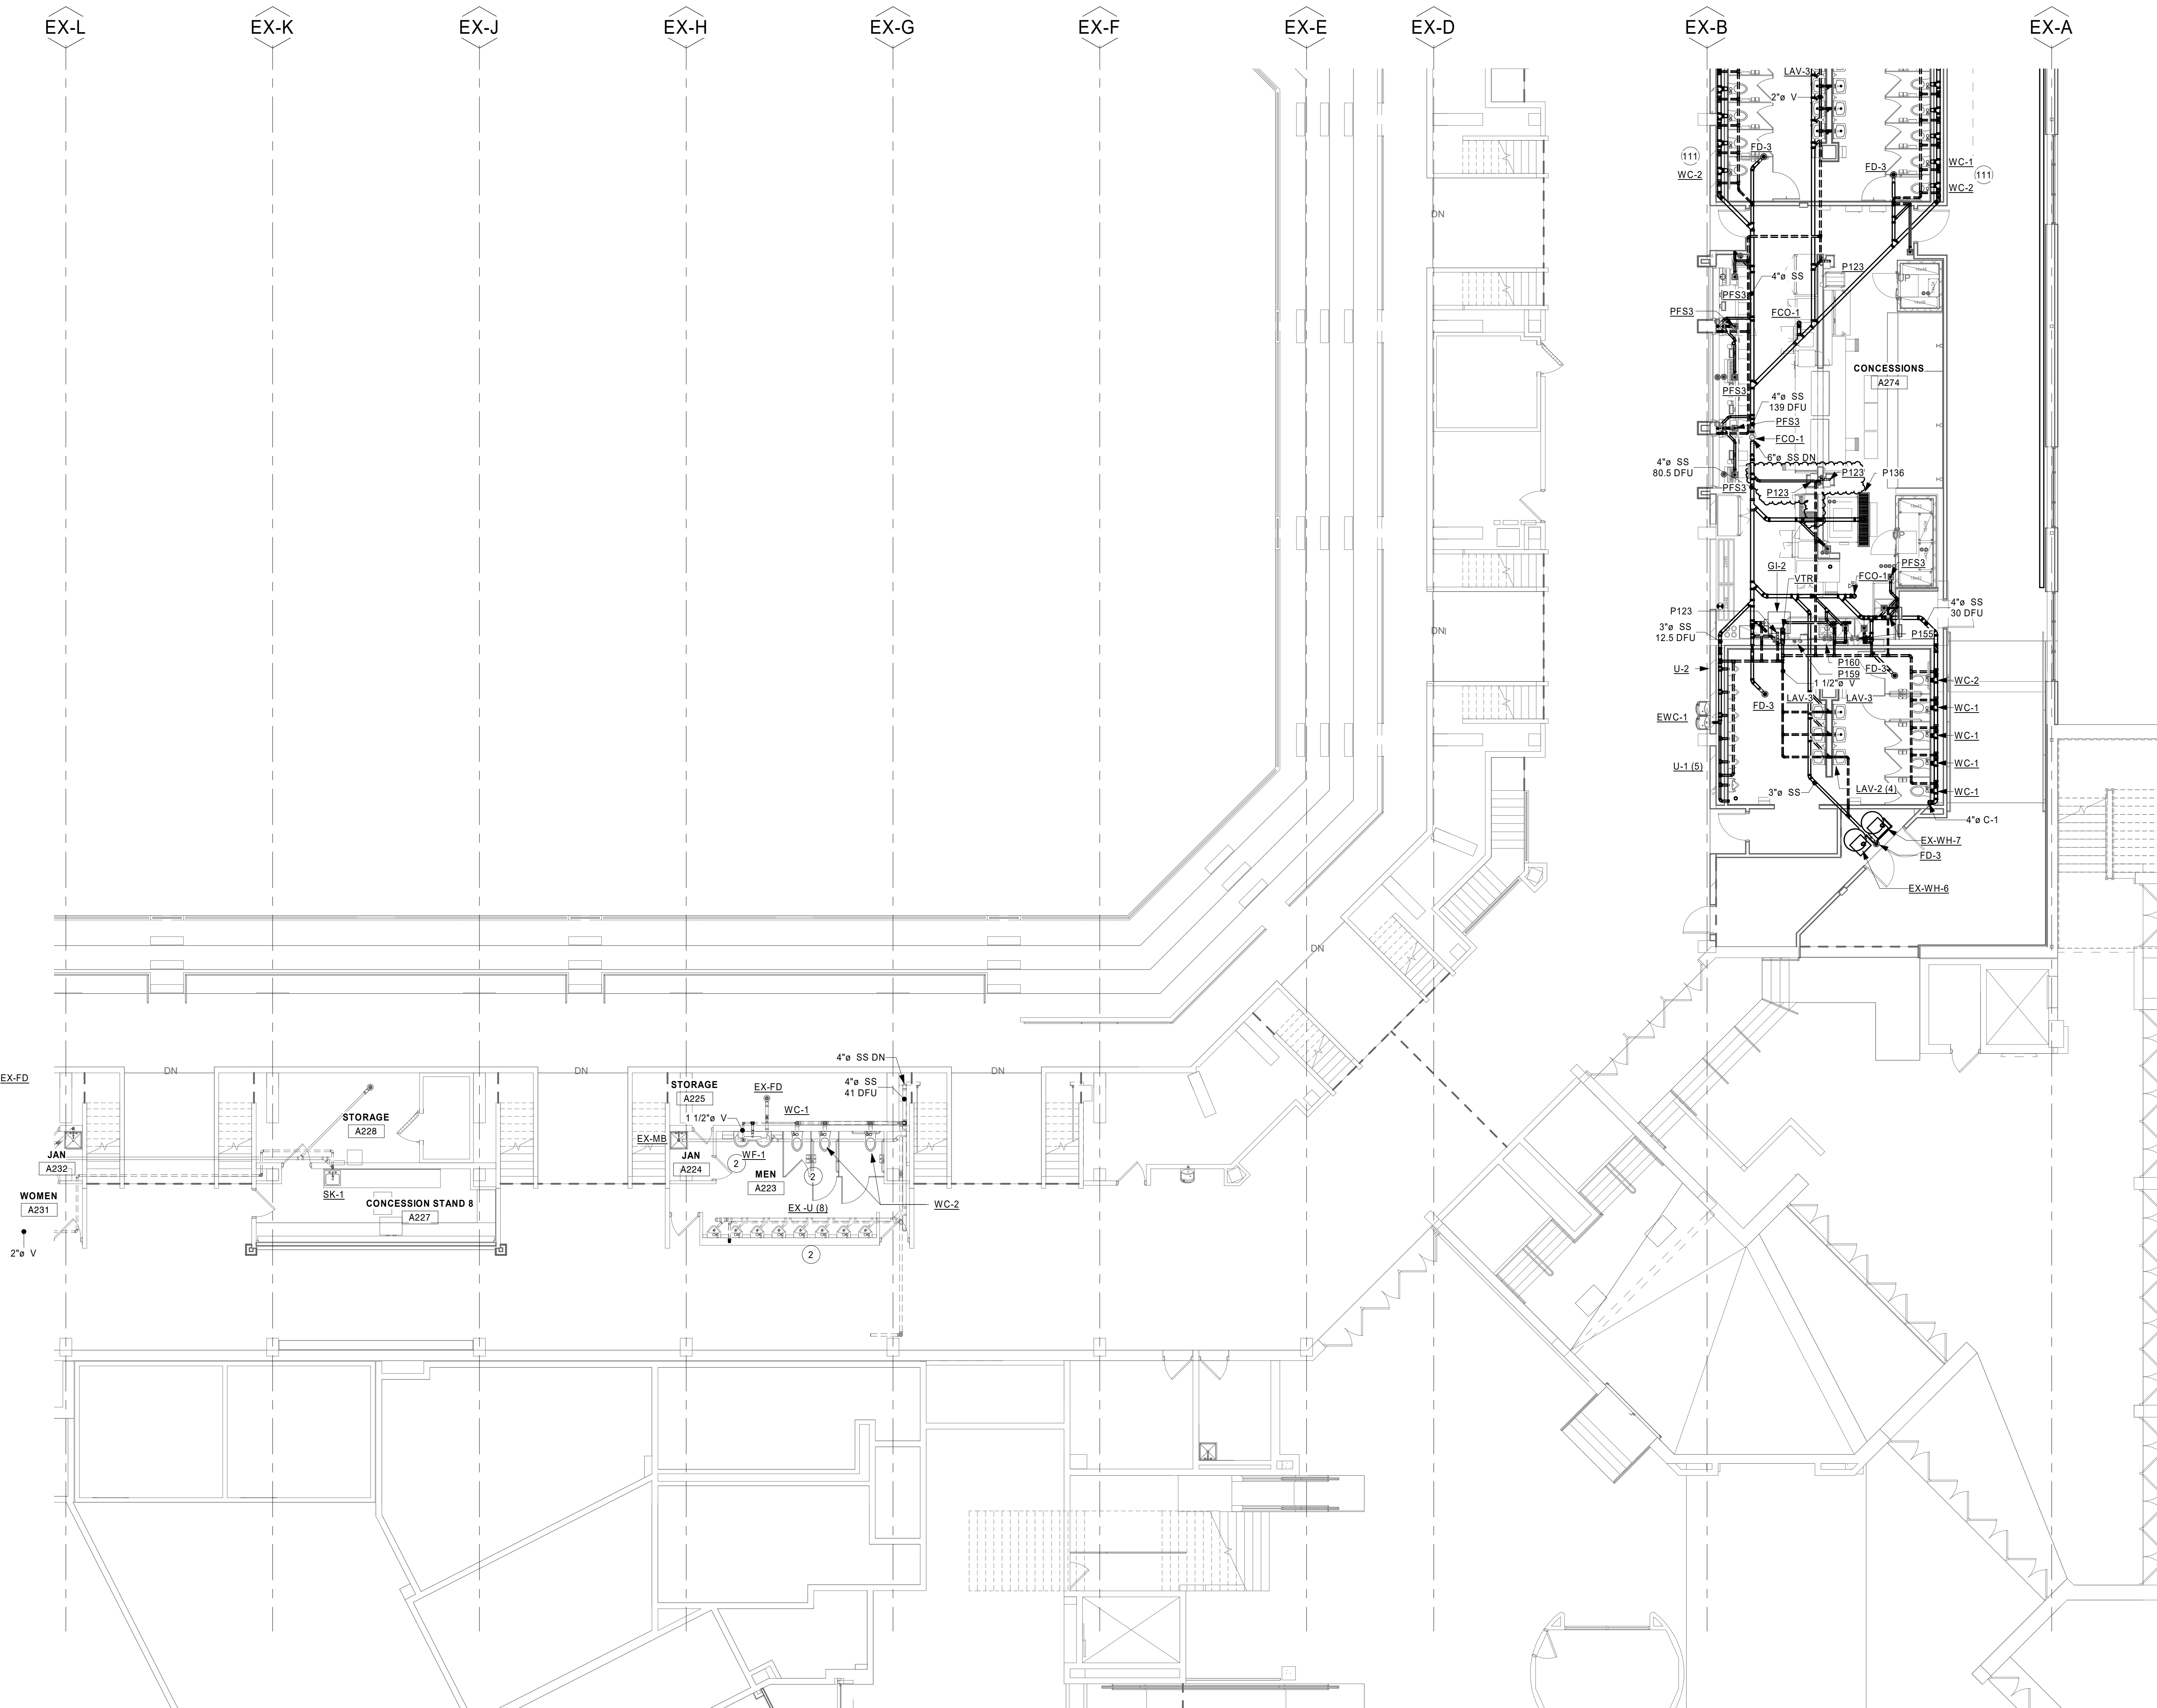

KEYPLAN

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PROJECT

LA CROSSE CENTER EXPANSION & RENOVATION

LA CROSSE WISCONSIN


REVISION SCHEDULE		
DATE	DESCRIPTION	BY
2020/02/24	ADDENDUM #03	JMH
2020/02/27	ADDENDUM #04	JMH
2020/03/30	PR #10	JMH
2020/06/05	PR #16	JMH
2020/08/18	PR #21	JMH

PROJECT NO.	16-19990
FILE NAME	19990 Arch R18.rvt
DRAWN BY	JMH
DESIGNED BY	RKD
REVIEWED BY	SMS
ORIGINAL ISSUE DATE	02/06/20
CLIENT PROJECT NO.	

TITLE

CONCOURSE LEVEL SANITARY PLAN - AREA D

SHEET
3P2-11D

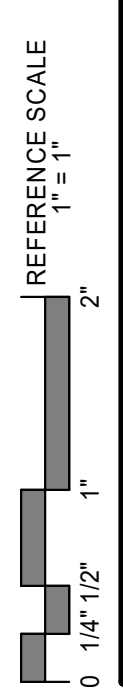



1 CONCOURSE LEVEL SANITARY PLAN - AREA D
1/8" = 1'-0"

SHEET NOTES

1. ALL DUCTWORK, PIPING, EQUIPMENT, ETC. INDICATED ON PLANS ARE BASED ON INFORMATION FROM CONSTRUCTION DOCUMENTS AND FIELD VERIFICATION OF THE EXISTING BUILDING. FIELD VERIFY ALL EXISTING CONDITIONS.
2. SANITARY PIPING OF SIZE 2" OR LESS TO BE SLOPED AT 1/4" / 12".
3. SANITARY PIPING OF SIZE 3" AND GREATER TO BE SLOPED AT 1/8" / 12".

KEYNOTE LEGEND

80 PROVIDE EXPANSIONS CONNECTIONS FOR HVAC AND PIPING. COORDINATE EXPANSION LOOPS TO BE AT BUILDING EXPANSION LOCATIONS WHERE POSSIBLE. TYPICAL OF ALL HVAC AND PIPING THAT CROSS BUILDING EXPANSION JOINTS. COORDINATE ALL LOCATIONS WITH EXPANSION JOINTS PLANS.

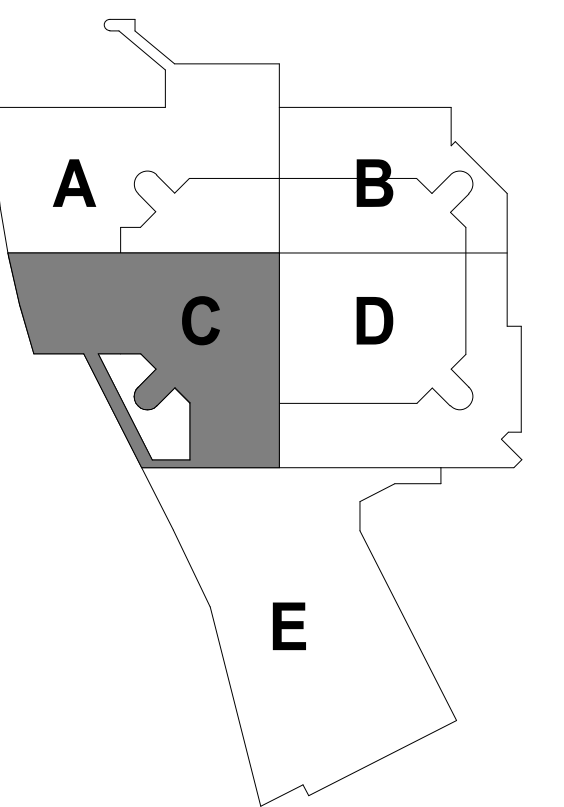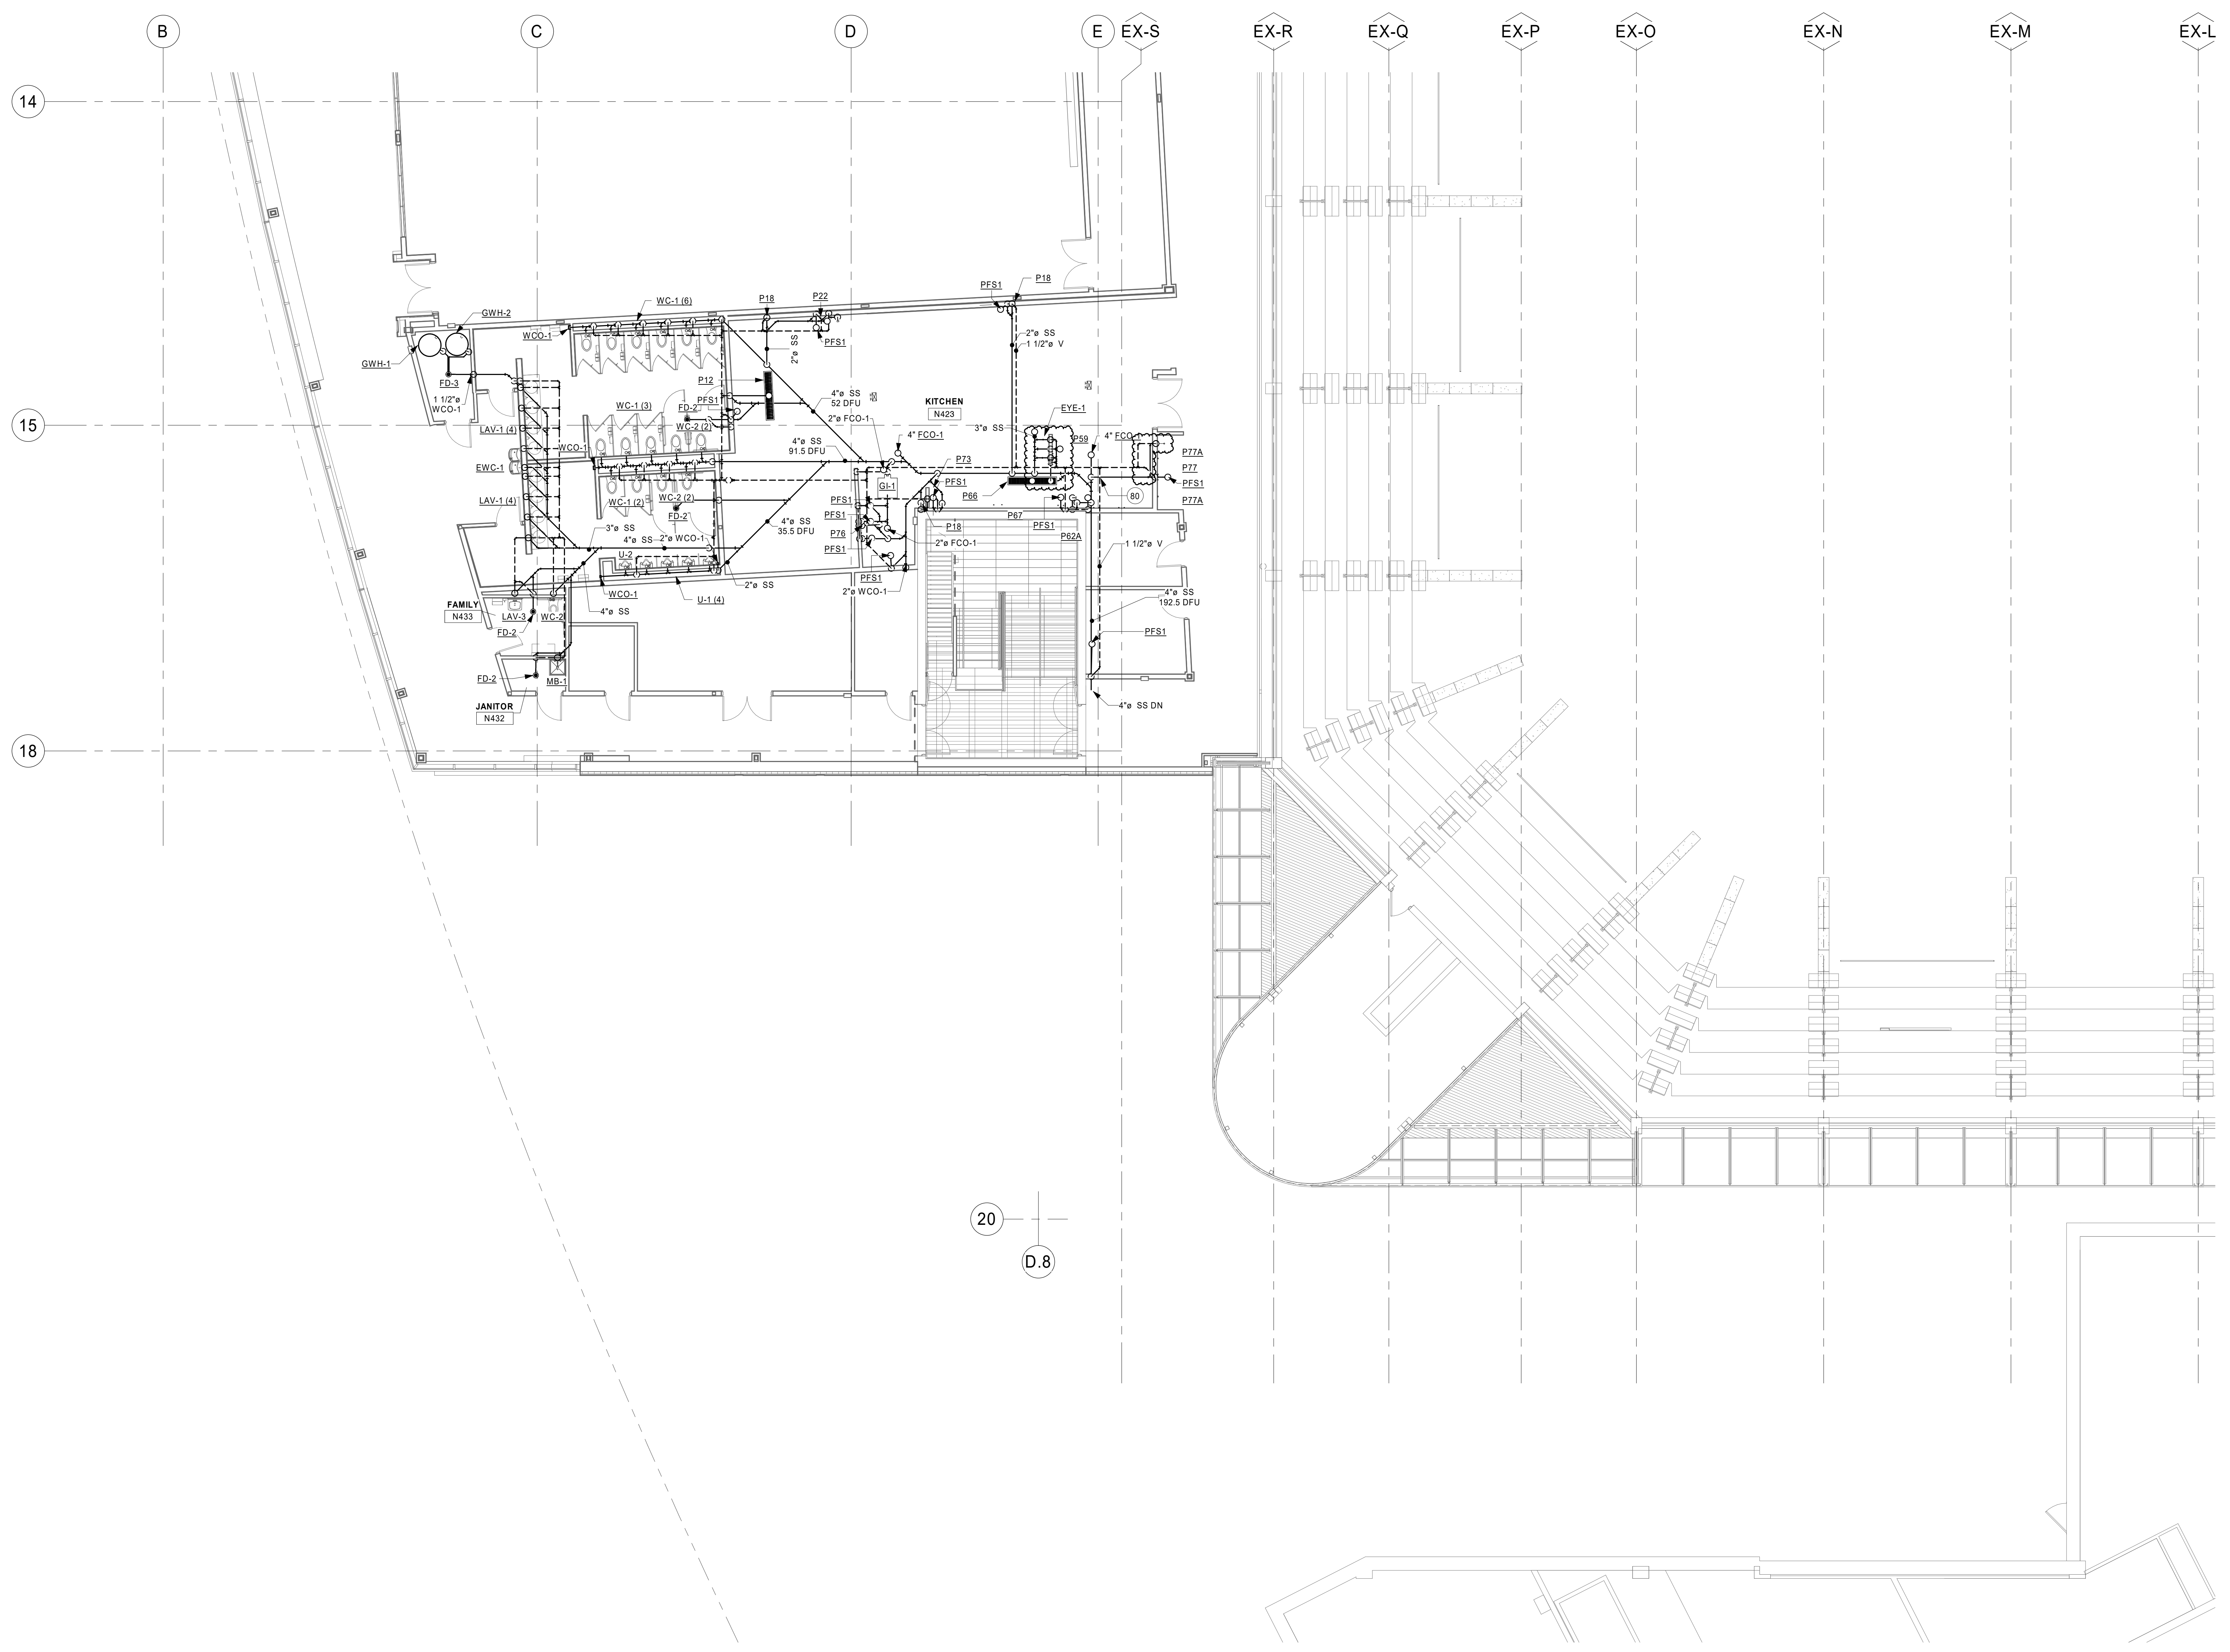

KEYPLAN

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PROJECT

LA CROSSE CENTER EXPANSION & RENOVATION

LA CROSSE WISCONSIN


REVISION SCHEDULE		
DATE	DESCRIPTION	BY
2020/02/24	ADDENDUM #03	JMH
2020/02/27	ADDENDUM #04	JMH
2020/03/30	PR #10	JMH
2020/06/16	PR #17	JMH
2020/08/18	PR #21	JMH

PROJECT NO.	16-19990
FILE NAME	19990 Arch R18.rvt
DRAWN BY	JMH
DESIGNED BY	RKD
REVIEWED BY	SMS
ORIGINAL ISSUE DATE	02/06/20
CLIENT PROJECT NO.	


TITLE

BALLROOM LEVEL SANITARY PLAN - AREA C

SHEET
3P2-13C

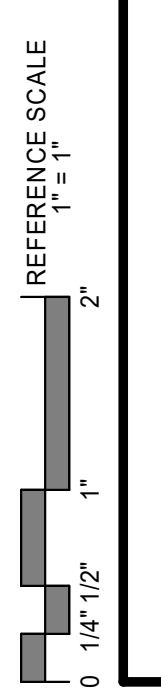

1 BALLROOM LEVEL SANITARY PLAN - AREA C
1/8" = 1'-0"


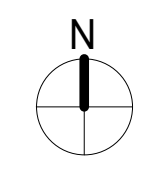


SHEET NOTES

- ALL DUCTWORK, PIPING, EQUIPMENT, ETC. INDICATED ON PLANS ARE BASED ON INFORMATION FROM CONSTRUCTION DOCUMENTS AND FIELD VERIFICATION OF THE EXISTING BUILDING. FIELD VERIFY ALL EXISTING CONDITIONS.
- SANITARY PIPING OF SIZE 2" OR LESS TO BE SLOPED AT 1/4" / 12".
- SANITARY PIPING OF SIZE 3" AND GREATER TO BE SLOPED AT 1/8" / 12".

KEYNOTE LEGEND

- INSTALL REUSED WATER HEATERS AND CONNECT TO PIPING AS SHOWN.
- INSTALL THERMOSTATIC MIXING VALVE AS SHOWN TO PROVIDE 120°F DOMESTIC HOT WATER FOR LAVATORIES FROM 140°F WATER HEATER.
- EXISTING MOP BASIN TO REMAIN.
- FIXTURES NOT TAGGED SHOWN ON ADJACENT PLAN.

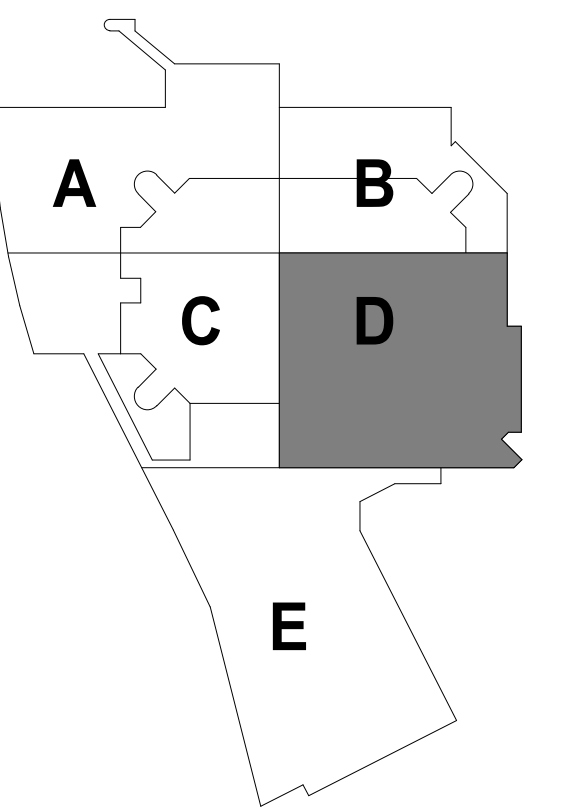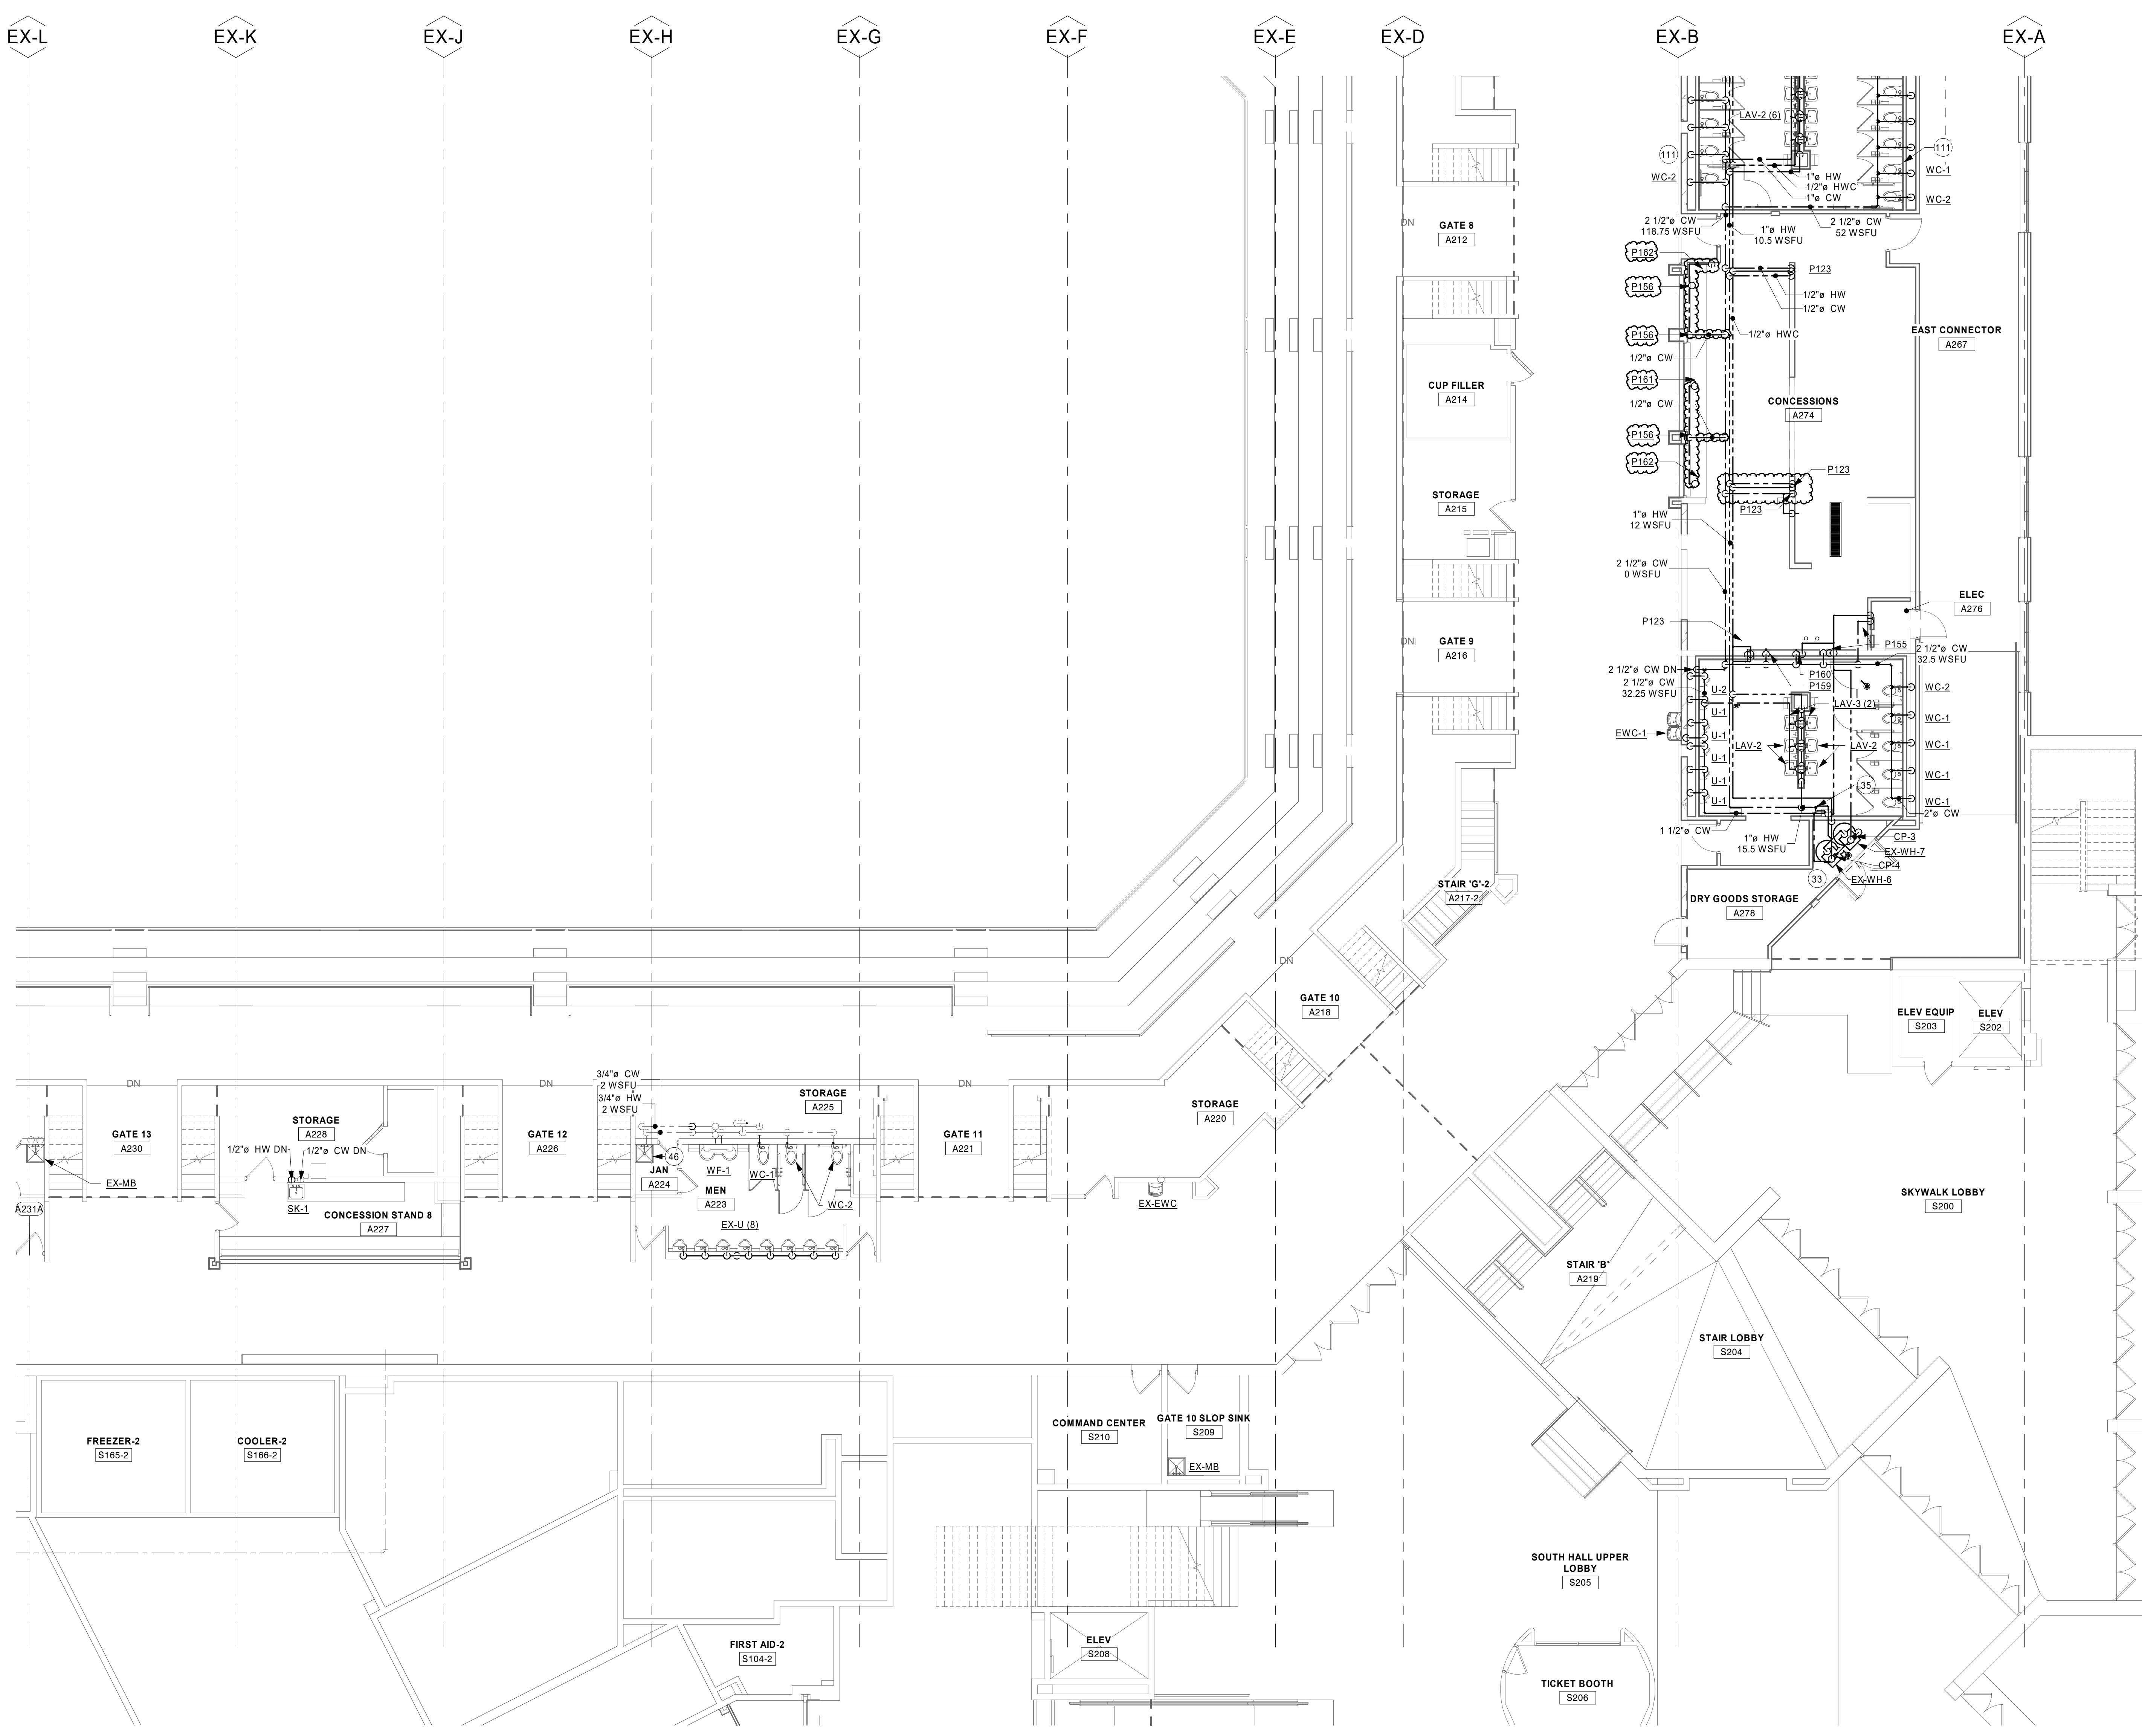

KEYPLAN

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PROJECT

LA CROSSE CENTER EXPANSION & RENOVATION


LA CROSSE WISCONSIN

REVISION SCHEDULE		
DATE	DESCRIPTION	BY
2020/02/24	ADDENDUM #03	JMH
2020/03/30	PR #10	JMH
2020/06/05	PR #16	JMH
2020/08/10	PR #21	JMH


PROJECT NO.	16-19990
FILE NAME	19990 Arch R18.rvt
DRAWN BY	JMH
DESIGNED BY	RKD
REVIEWED BY	SMS
ORIGINAL ISSUE DATE	02/06/20
CLIENT PROJECT NO.	

CONCOURSE LEVEL DOMESTIC WATER - AREA D

SHEET
3P2-21D

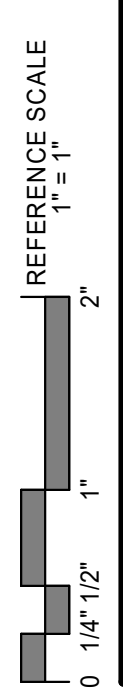

1 CONCOURSE LEVEL DOMESTIC WATER - AREA D
1/8" = 1'-0"

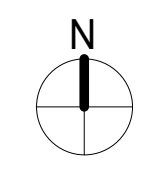



SHEET NOTES

1. ALL DUCTWORK, PIPING, EQUIPMENT, ETC. INDICATED ON PLANS ARE BASED ON INFORMATION FROM CONSTRUCTION DOCUMENTS AND FIELD VERIFICATION OF THE EXISTING BUILDING. FIELD VERIFY ALL EXISTING CONDITIONS.
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3. SANITARY PIPING OF SIZE 3" AND GREATER TO BE SLOPED AT 1/8" / 12".

KEYNOTE LEGEND

80 PROVIDE EXPANSION CONNECTIONS FOR HVAC AND PIPING. COORDINATE EXPANSION LOOPS TO BE AT BUILDING EXPANSION LOCATIONS WHERE POSSIBLE. TYPICAL OF ALL HVAC AND PIPING THAT CROSS BUILDING EXPANSION JOINTS. COORDINATE ALL LOCATIONS WITH EXPANSION JOINTS PLANS.

109 INSTALL WATTS LF288A VACUUM BREAKER PER MANUFACTURER'S INSTRUCTIONS TO SATISFY ASSE 1001 REQUIREMENT.

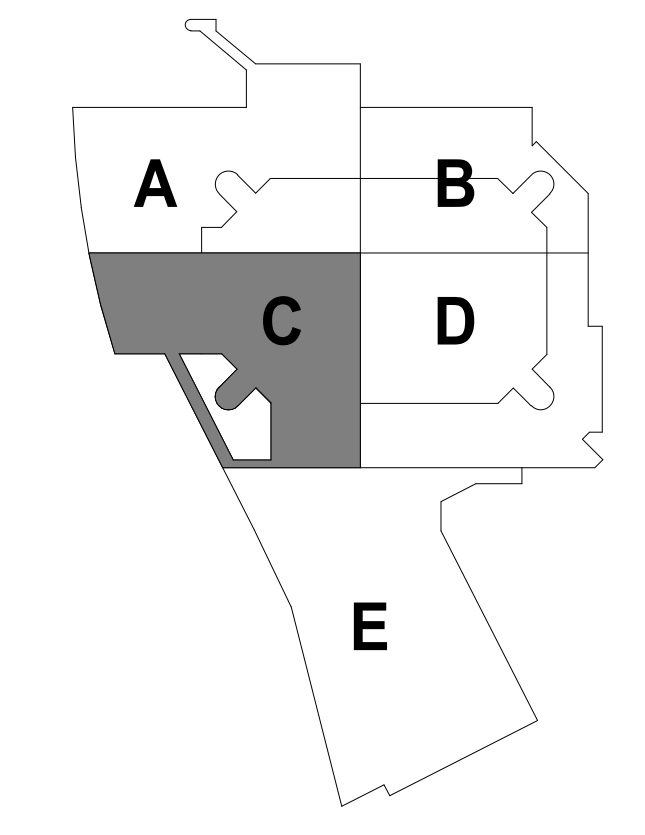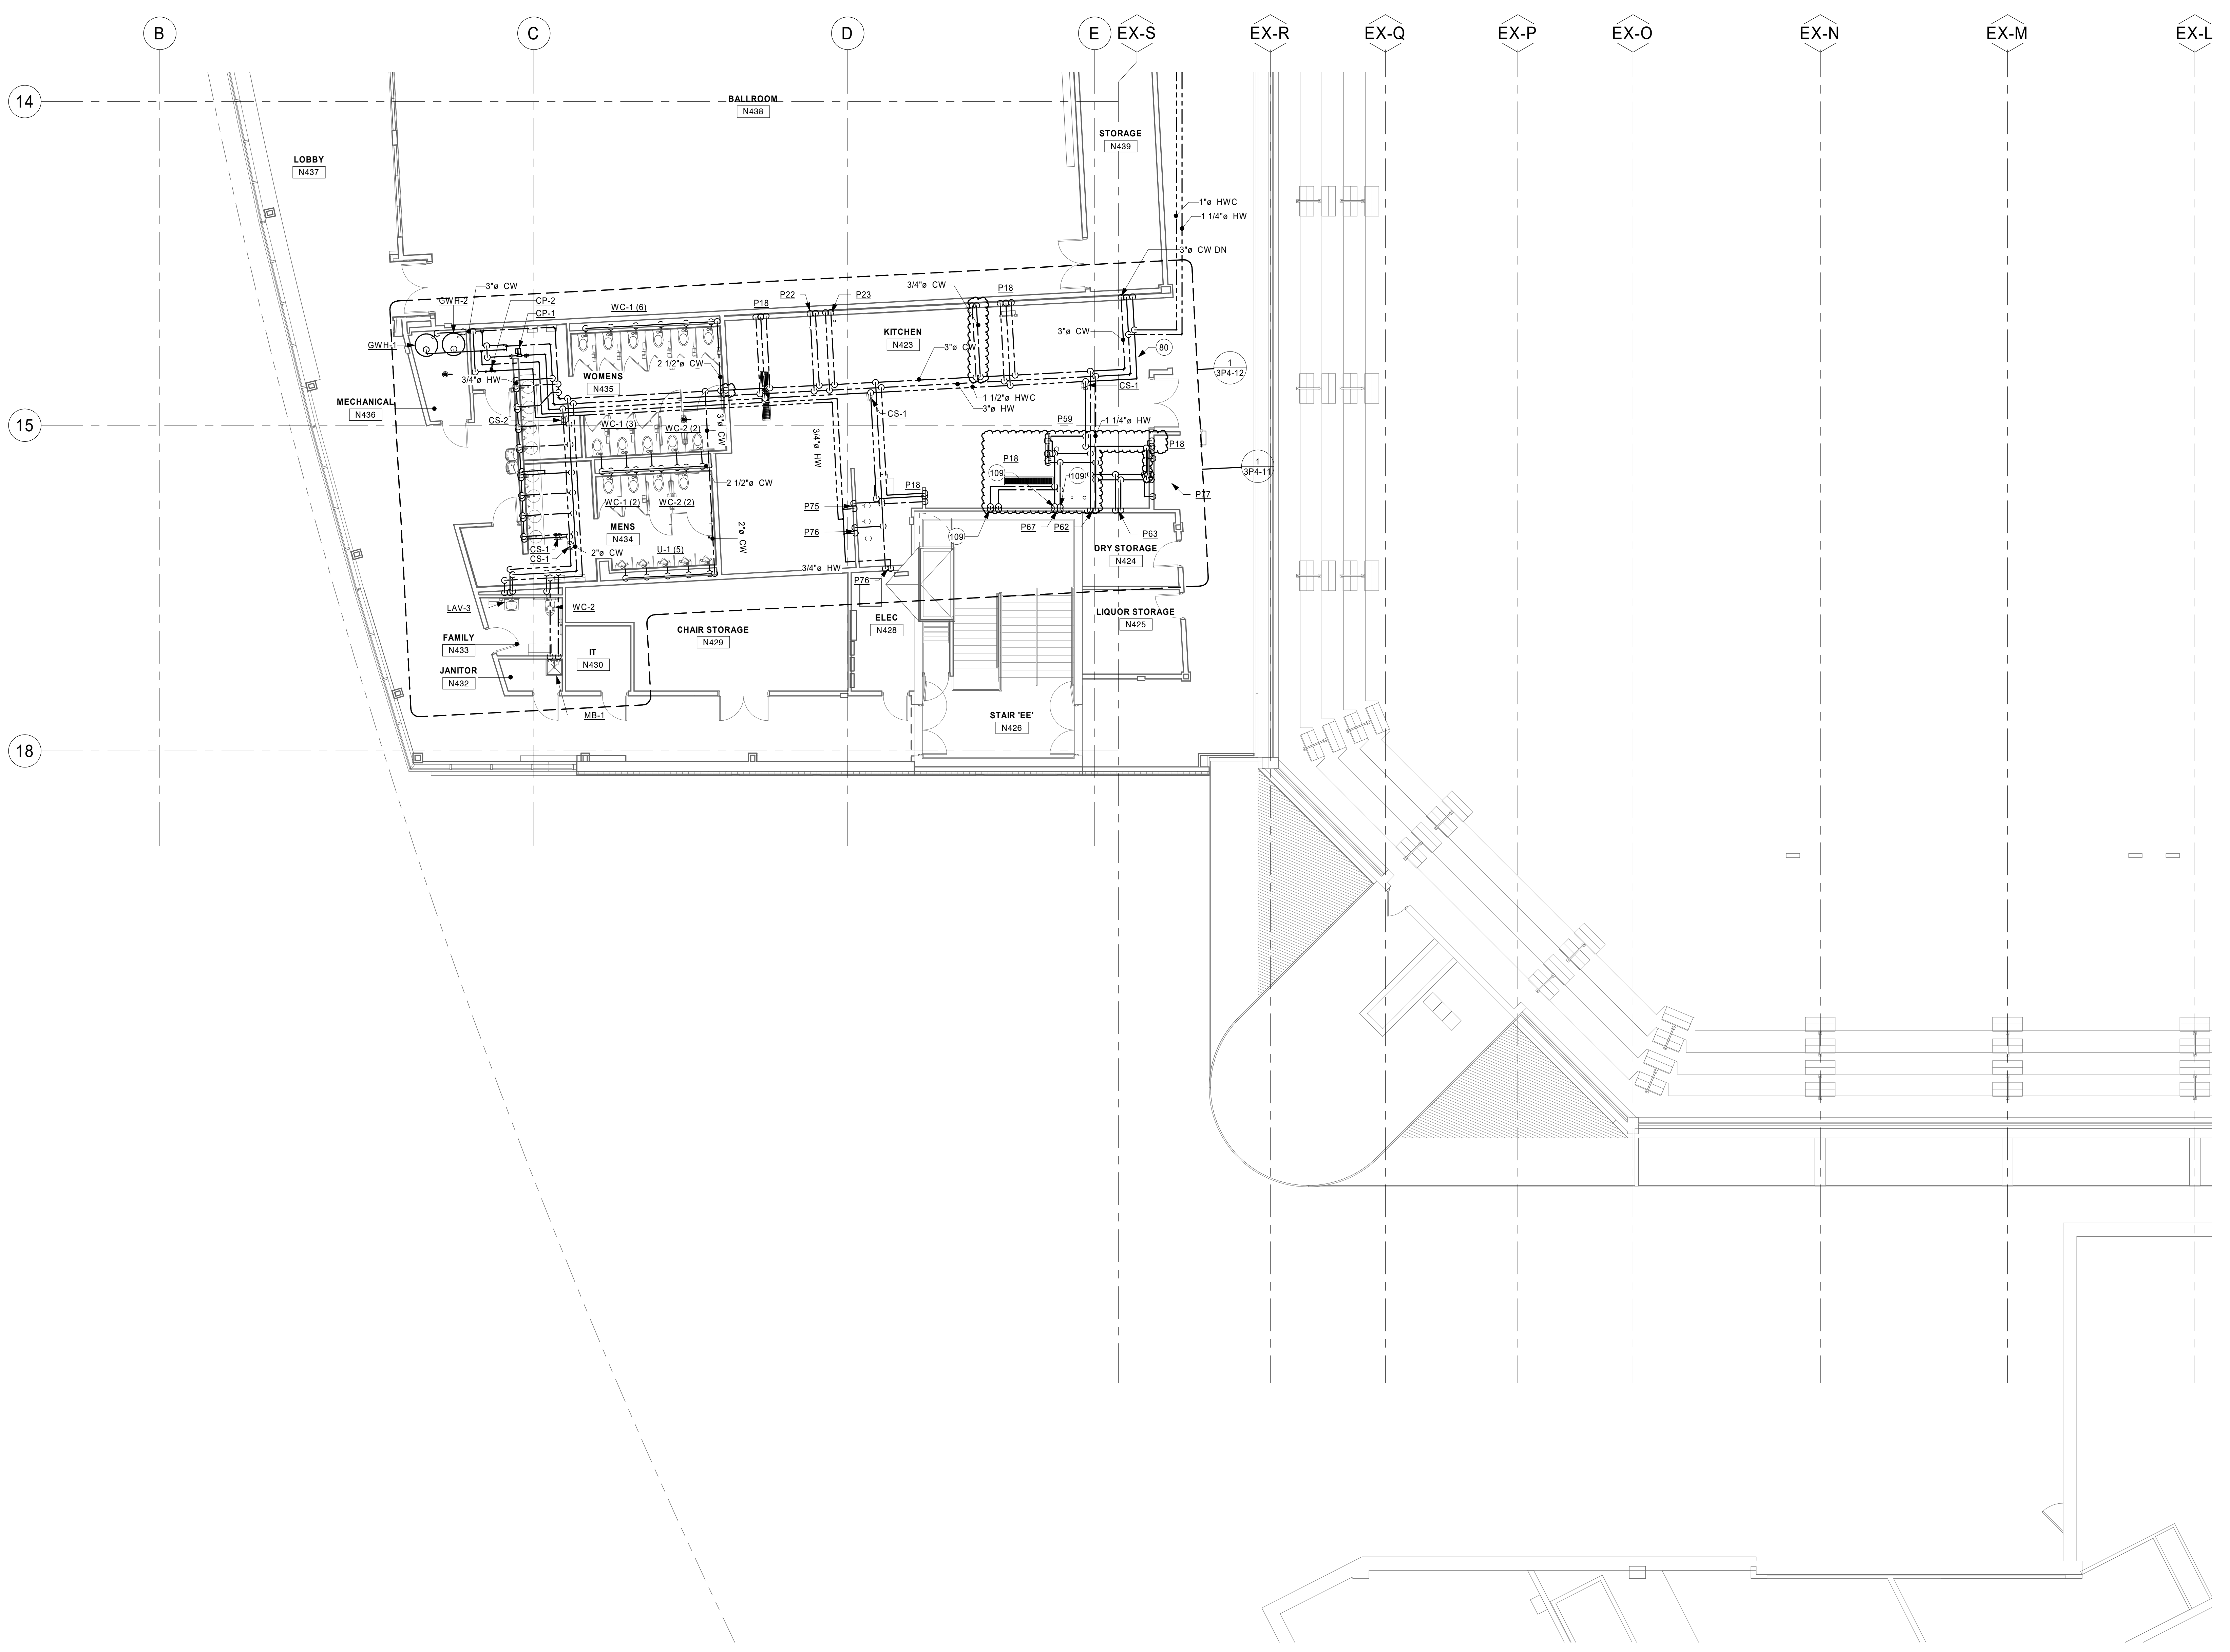

KEYPLAN

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PROJECT

LA CROSSE CENTER EXPANSION & RENOVATION

LA CROSSE WISCONSIN

REVISION SCHEDULE		
DATE	DESCRIPTION	BY
2020/03/30	PR #10	JMH
2020/08/18	PR #21	JMH


PROJECT NO.	16-19990
FILE NAME	19990 Arch R18.rvt
DRAWN BY	JMH
DESIGNED BY	RKD
REVIEWED BY	SMS
ORIGINAL ISSUE DATE	02/06/20
CLIENT PROJECT NO.	

TITLE

BALLROOM LEVEL DOMESTIC WATER - AREA C

SHEET

3P2-23C

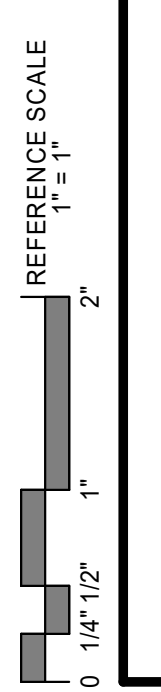

1 BALLROOM LEVEL AREA C - KITCHEN & RESTROOMS
1/8" = 1'-0"

FIXTURE CONNECTION SIZE LEGEND


WC-X:	4" SAN,	2" VENT	6 DFU
U-1:	2" SAN,	1 1/2" VENT	2 DFU
LAV-X:	1 1/2" SAN,	1 1/2" VENT	1 DFU
SK-1:	1 1/2" SAN,	1 1/2" VENT	1 DFU
MB-1:	2" SAN,	1 1/2" VENT	3 DFU
EWC-X:	1 1/2" SAN,	1 1/2" VENT	0.5 DFU
FD-2:	2" SAN,	1 1/4" VENT	2 DFU
FD-3:	3" SAN,	1 1/2" VENT	3 DFU

SHEET NOTES


1. ALL DUCTWORK, PIPING, EQUIPMENT, ETC. INDICATED ON PLANS ARE BASED ON INFORMATION FROM CONSTRUCTION DOCUMENTS AND FIELD VERIFICATION OF THE EXISTING BUILDING. FIELD VERIFY ALL EXISTING CONDITIONS.
2. SANITARY PIPING OF SIZE 2" OR LESS TO BE SLOPED AT 1/4" / 12"
3. SANITARY PIPING OF SIZE 3" AND GREATER TO BE SLOPED AT 1/8" / 12"

KEYNOTE LEGEND


- 20 | CONNECT NEW PIPE TO EXISTING.
- 21 | CAP EXISTING PIPE.
- 25 | ALL PIPING PAST THIS POINT EXISTING TO REMAIN. ALL FIXTURE UNITS ARE CALCULATED FROM THIS POINT FOR EXISTING FIXTURES.
- 120 | INSTALL CLEANOUT BELOW DOUBLE SANITARY TEE. TYPICAL OF ALL.

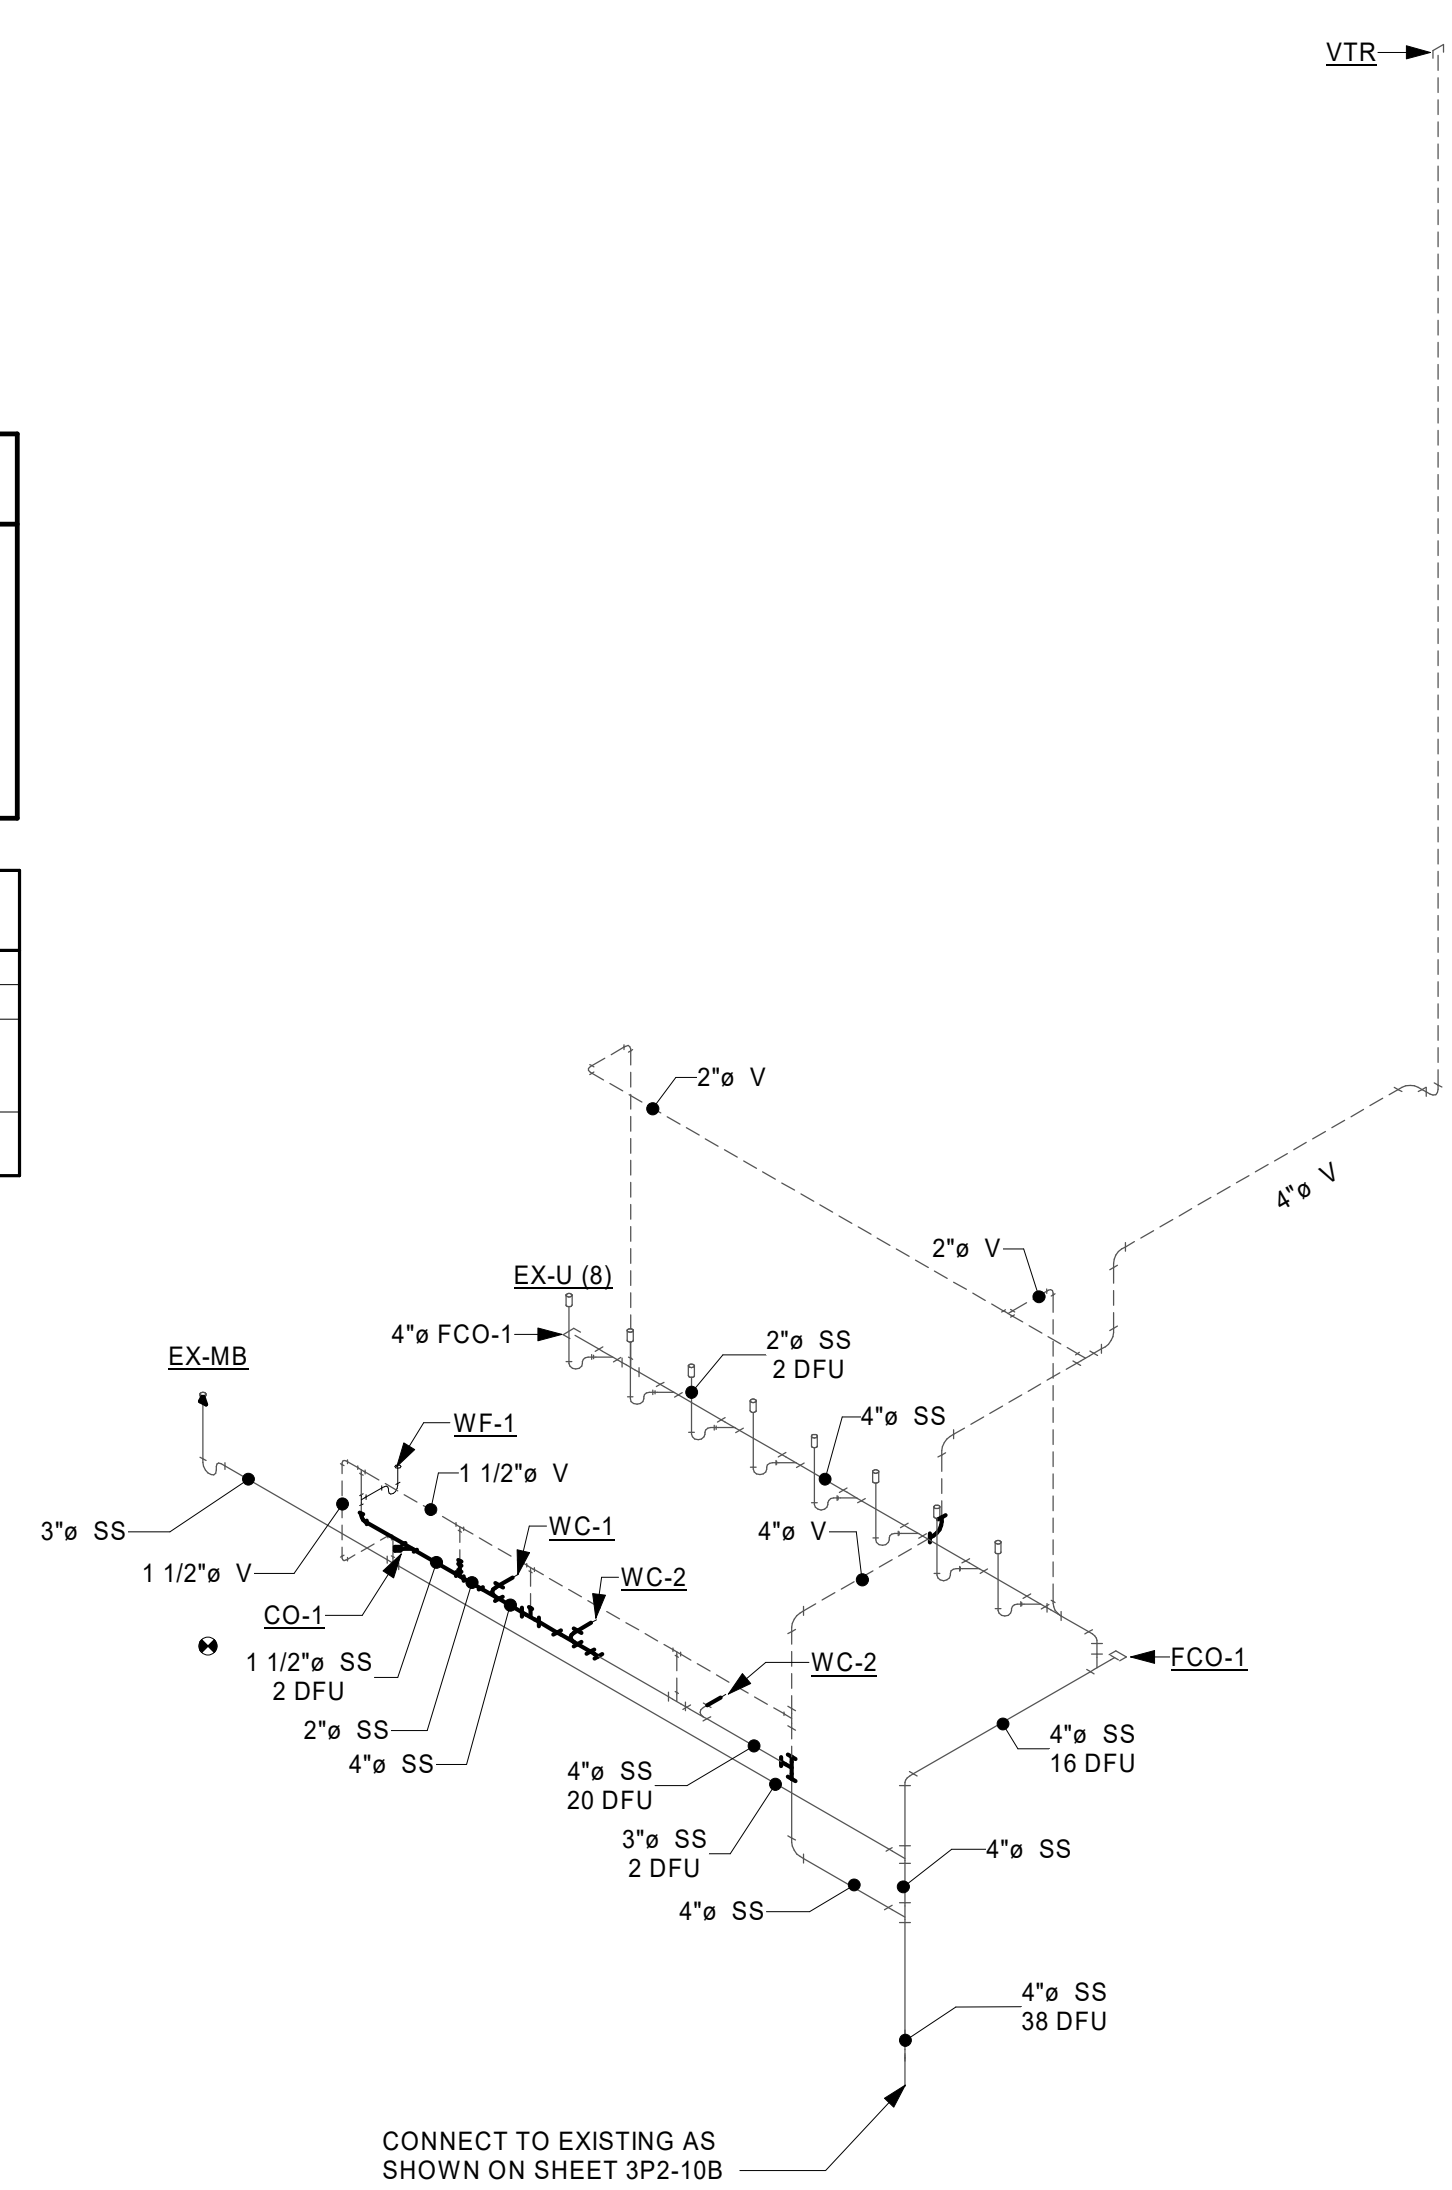


1 CONOURSE LEVEL - A205 MENS

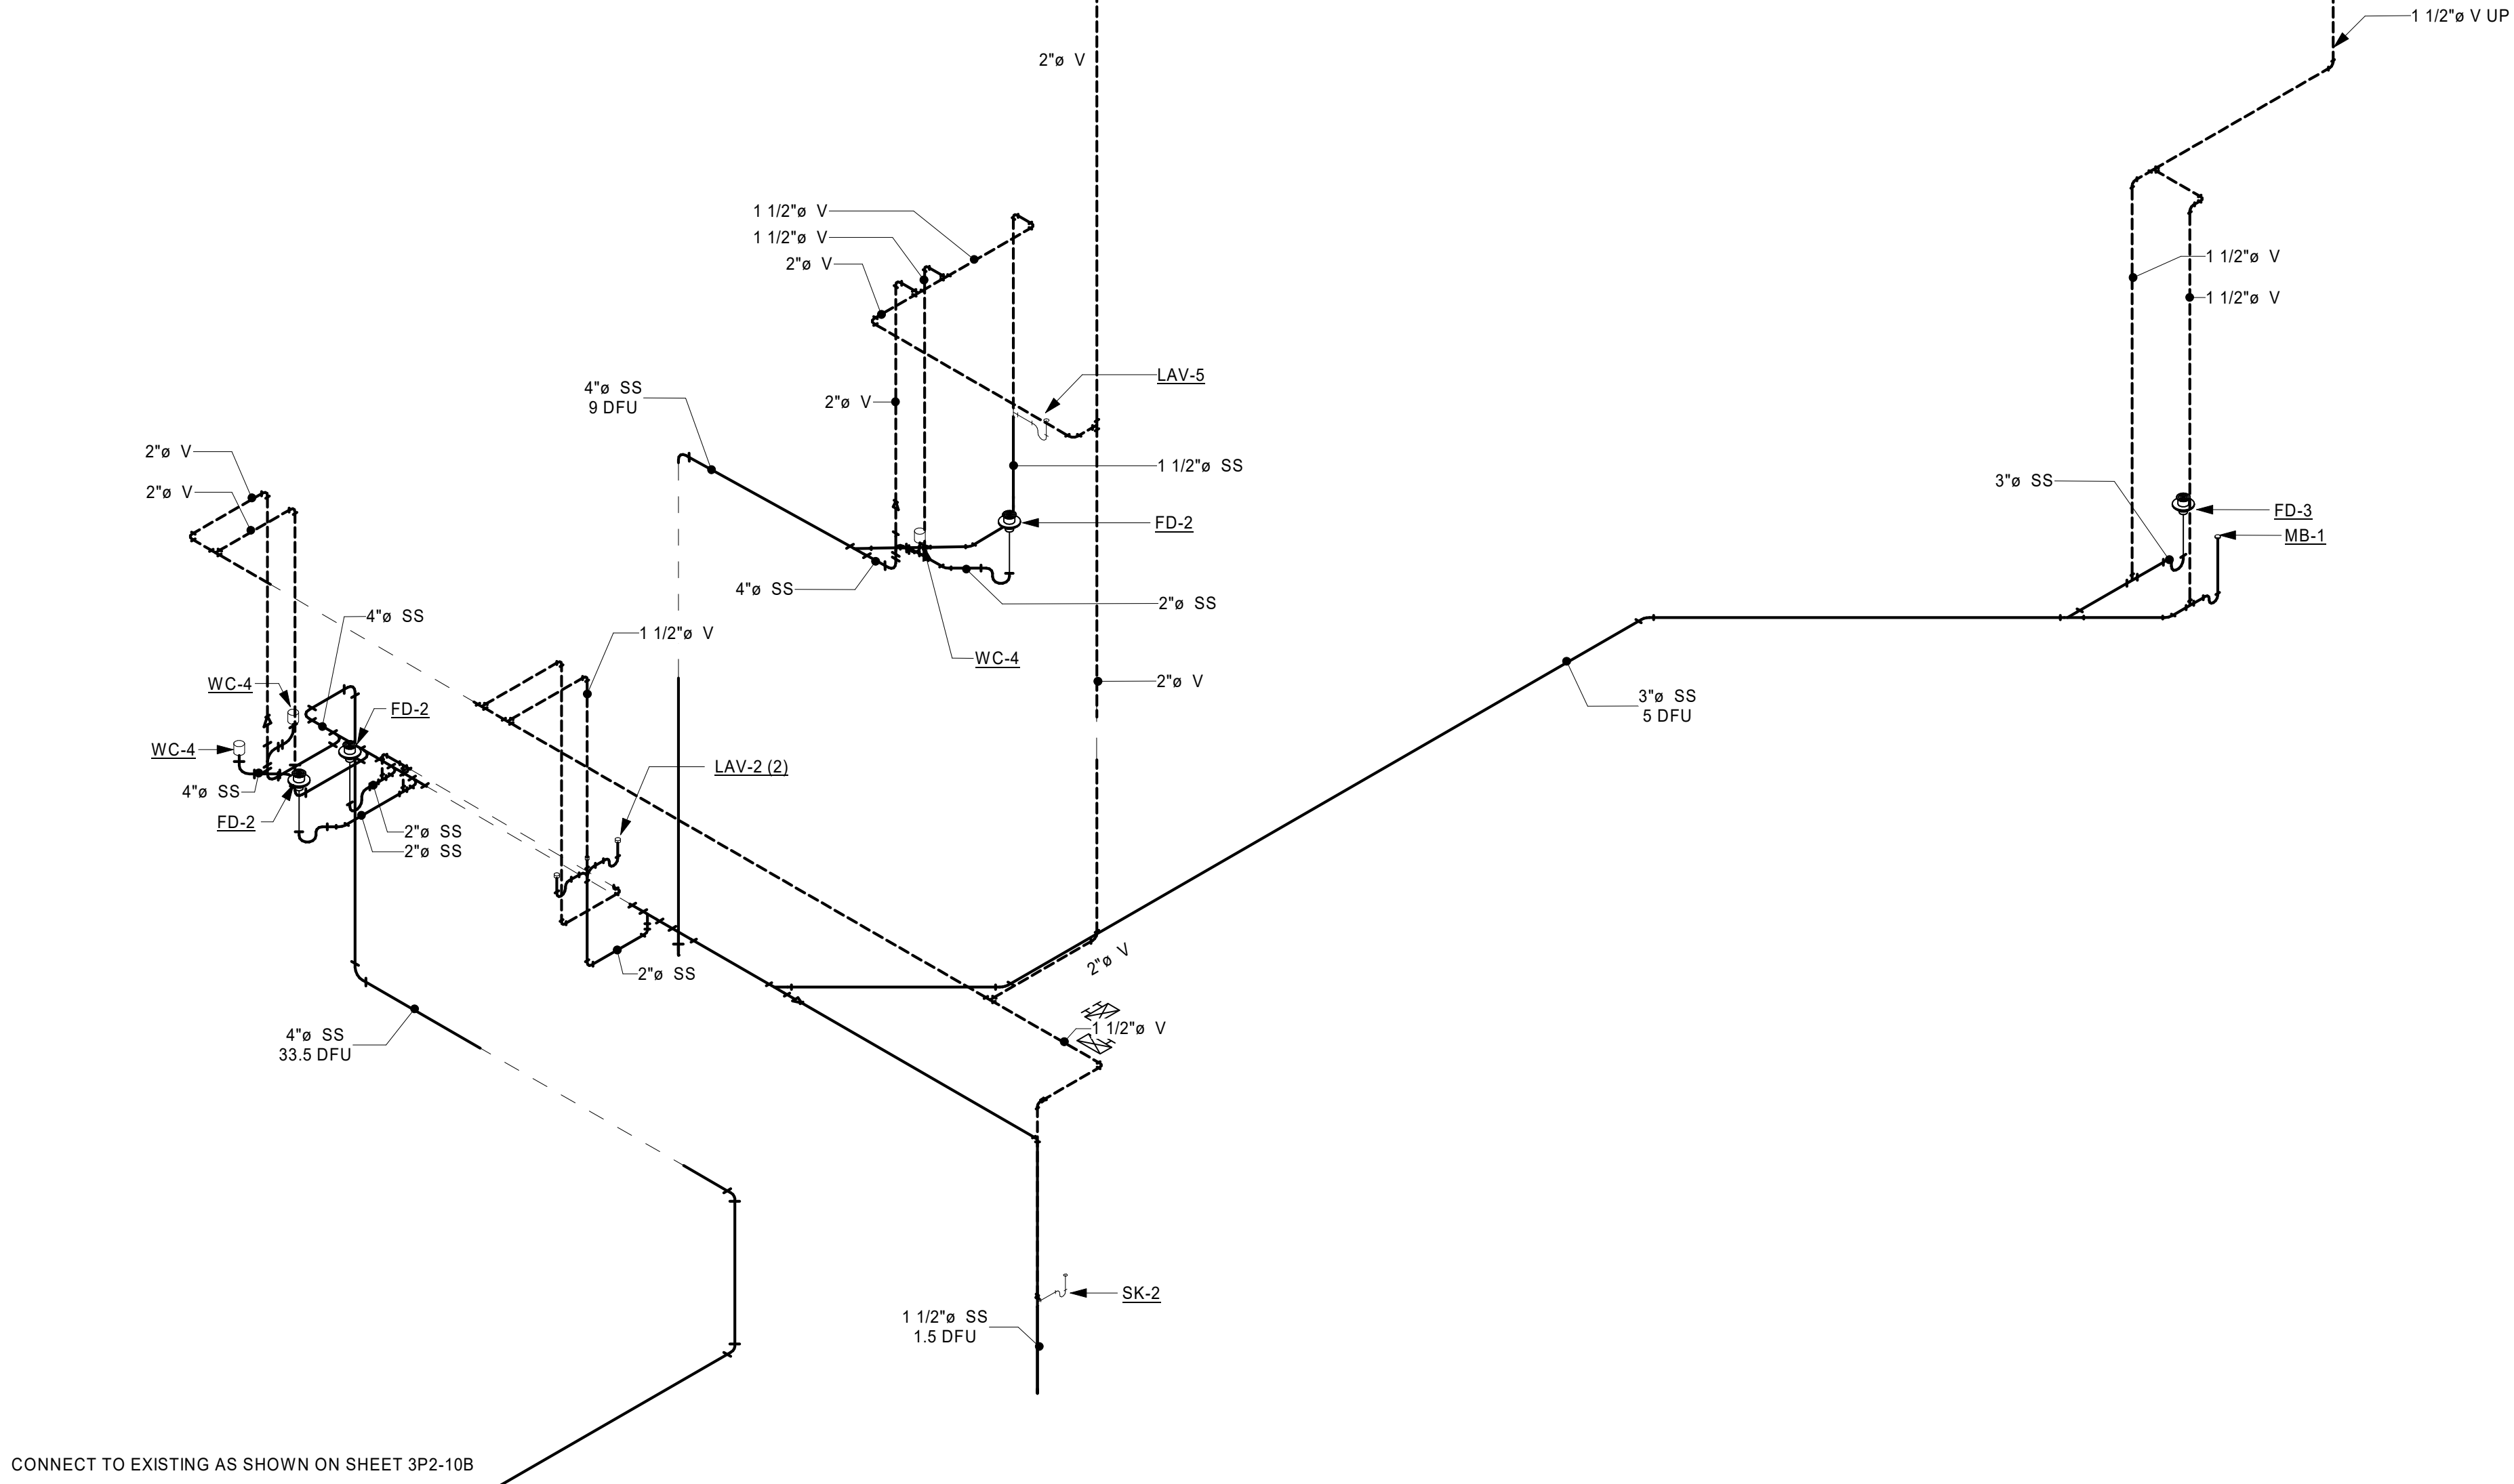


2 OFFICES - CONOURSE LEVEL

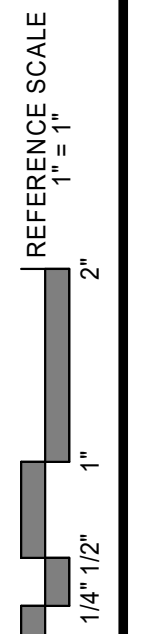

3 A231 - WOMENS - SANITARY ISOMETRIC

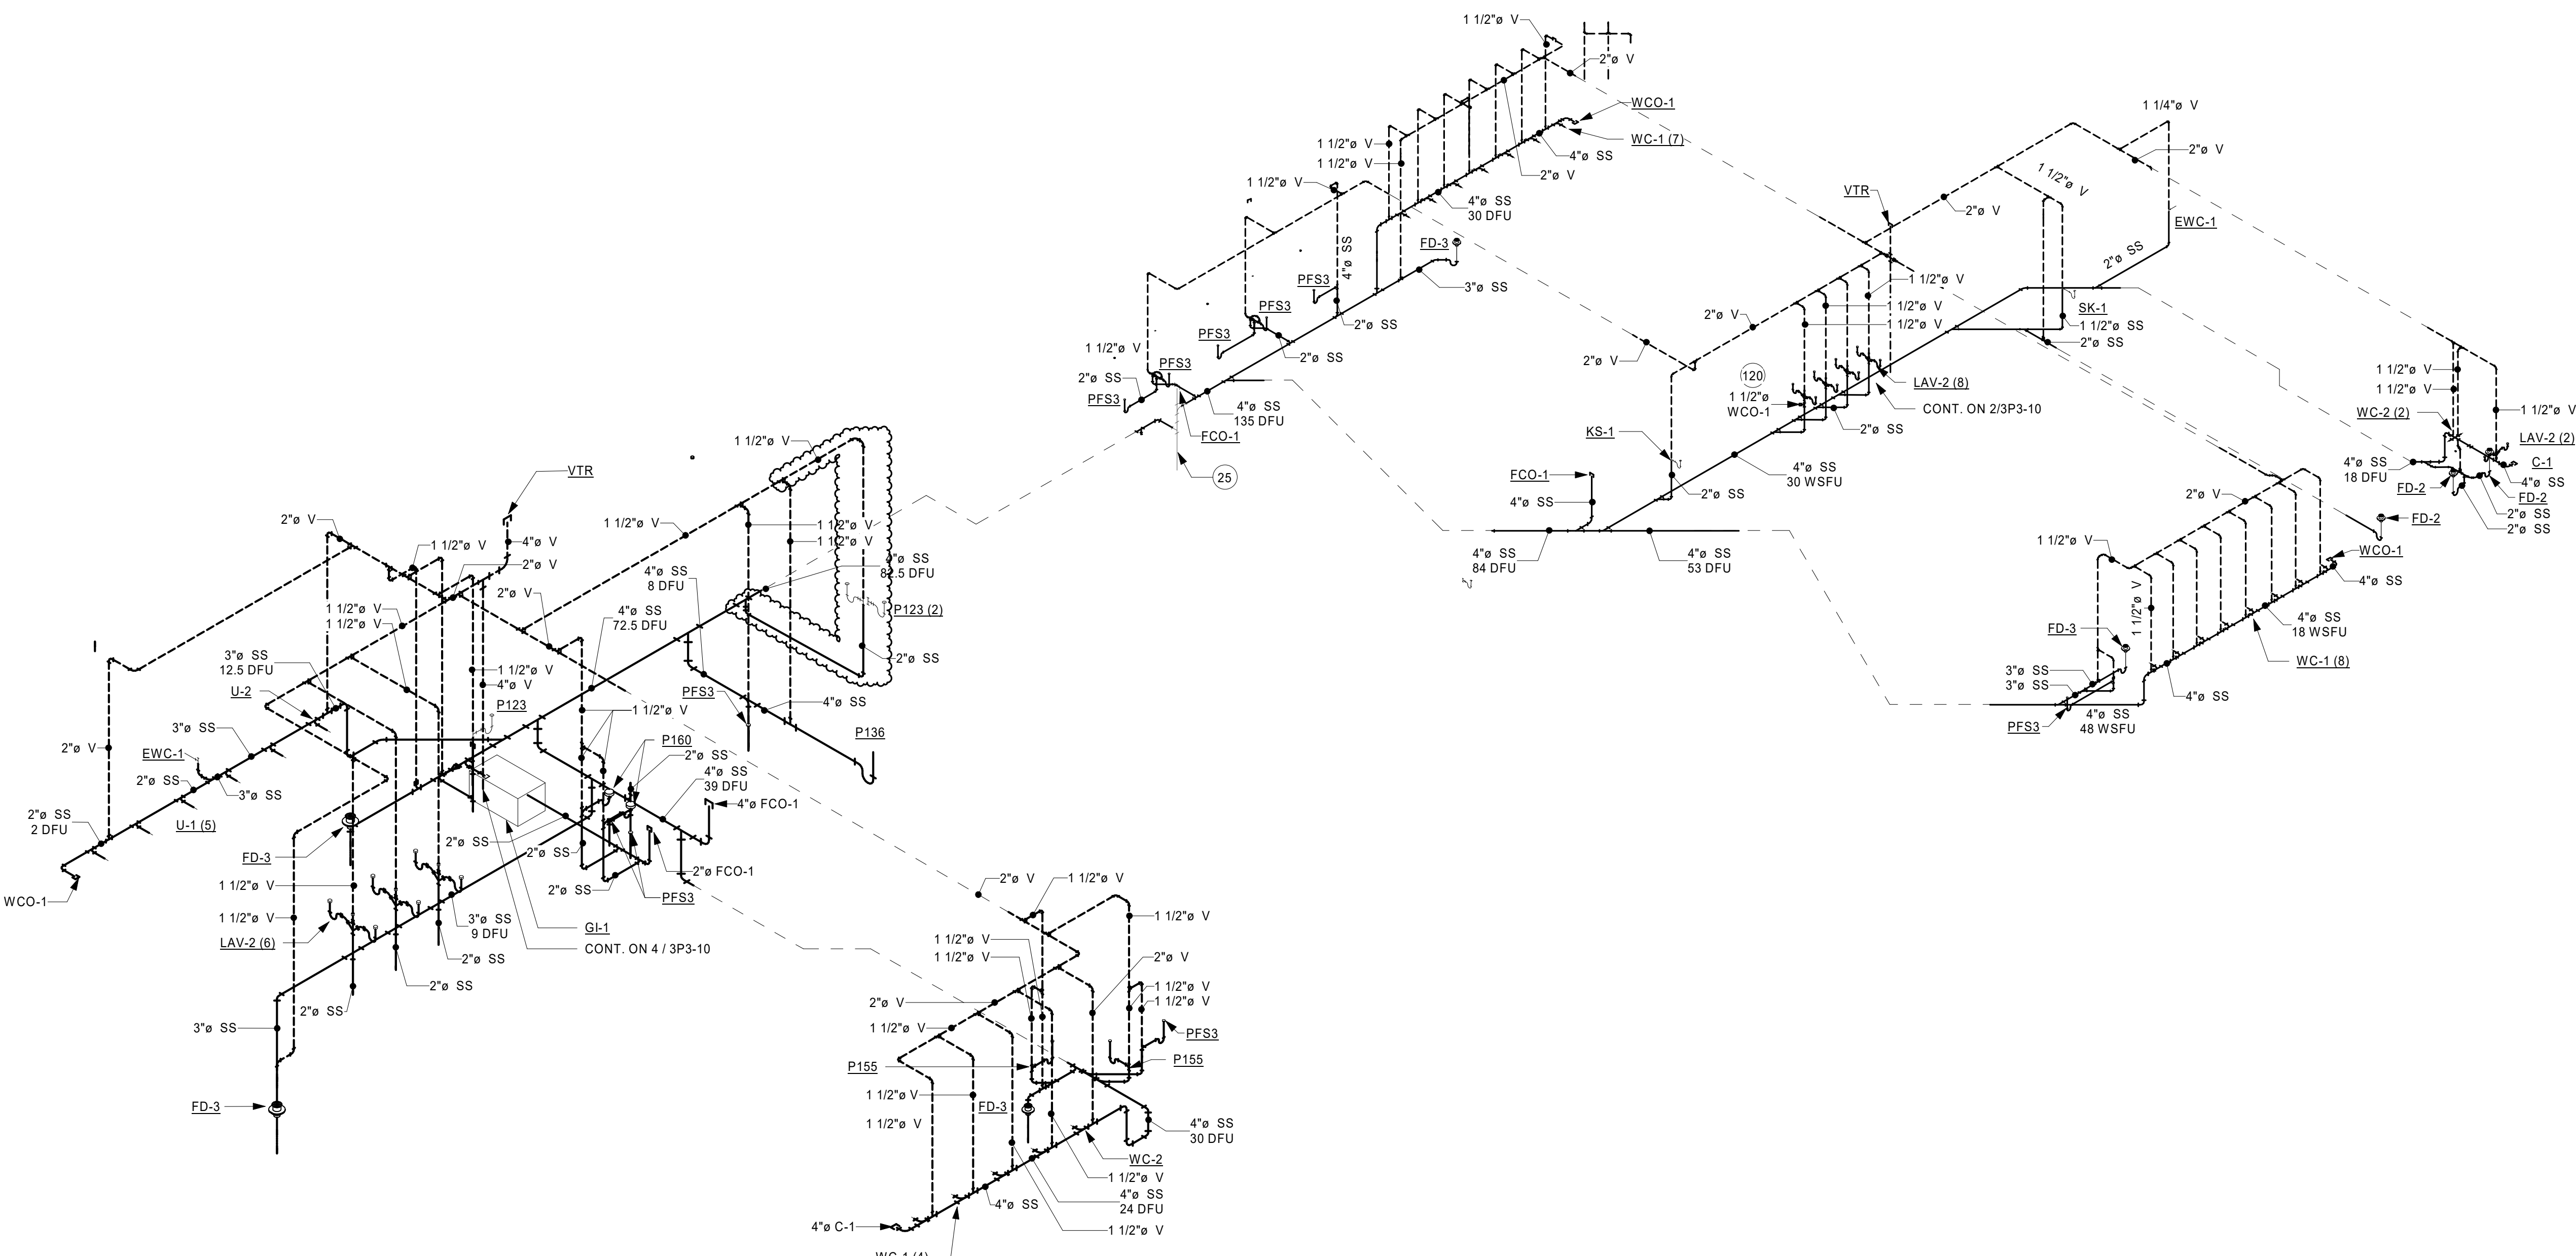

4 A277 - MENS - SANITARY ISOMETRIC

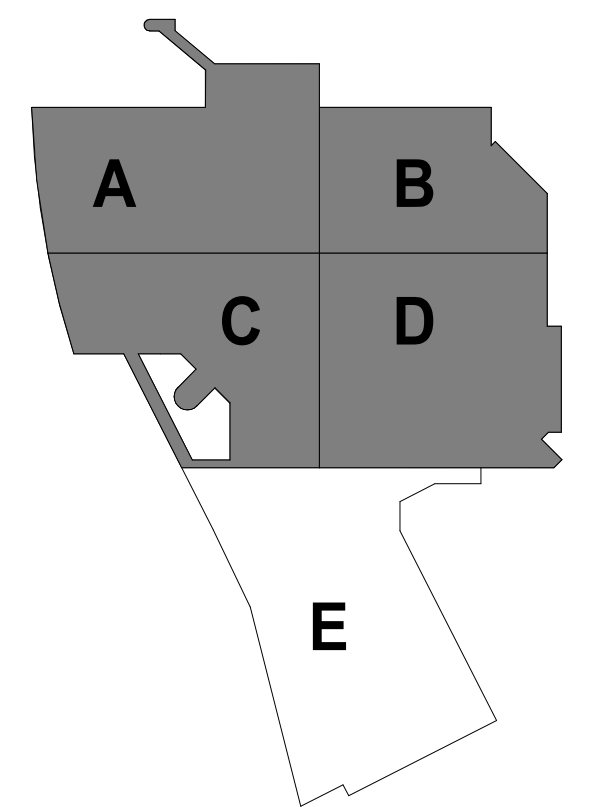

KEYPLAN

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PROJECT

LA CROSSE CENTER EXPANSION & RENOVATION

LA CROSSE WISCONSIN

REVISION SCHEDULE		
DATE	DESCRIPTION	BY
2020/02/27	ADDENDUM #04	JMH
2020/03/30	PR #10	JMH
2020/05/15	PR #14	JMH
2020/06/05	PR #16	JMH
2020/06/16	PR #17	JMH
2020/08/18	PR #21	JMH

PROJECT NO.	16-19990
FILE NAME	19990 Arch R18.rvt
DRAWN BY	JMH
DESIGNED BY	RKD
REVIEWED BY	SMS
ORIGINAL ISSUE DATE	02/06/20
CLIENT PROJECT NO.	

TITLE

CONCOURSE LEVEL DRAIN, WASTE, AND VENT ISOMETRICS

SHEET

3P3-11

FIXTURE CONNECTION SIZE LEGEND

WC-X:	4" SAN,	2" VENT	6 DFU
U-1:	2" SAN,	1 1/2" VENT	2 DFU
LAV-X:	1 1/2" SAN,	1 1/2" VENT	1 DFU
SK-1:	1 1/2" SAN,	1 1/2" VENT	1 DFU
MB-1:	2" SAN,	1 1/2" VENT	3 DFU
EWC-X:	1 1/2" SAN,	1 1/2" VENT	0.5 DFU
FD-2:	2" SAN,	1 1/4" VENT	2 DFU
FD-3:	3" SAN,	1 1/2" VENT	3 DFU

SHEET NOTES

1. ALL DUCTWORK, PIPING, EQUIPMENT, ETC. INDICATED ON PLANS ARE BASED ON INFORMATION FROM CONSTRUCTION DOCUMENTS AND FIELD VERIFICATION OF THE EXISTING BUILDING. FIELD VERIFY ALL EXISTING CONDITIONS.
2. SANITARY PIPING OF SIZE 2" OR LESS TO BE SLOPED AT 1/4" / 12".
3. SANITARY PIPING OF SIZE 3" AND GREATER TO BE SLOPED AT 1/8" / 12".



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PROJECT		
LA CROSSE CENTER EXPANSION & RENOVATION		
LA CROSSE WISCONSIN		
REVISION SCHEDULE		
DATE	DESCRIPTION	BY
2020/02/27	ADDENDUM #04	JMH
2020/03/30	PR #10	JMH
2020/06/16	PR #17	JMH
2020/08/10	PR #21	JMH



PROJECT NO.	16-19990
FILE NAME	19990 Arch R18.rvt
DRAWN BY	JMH
DESIGNED BY	RKD
REVIEWED BY	SMS
ORIGINAL ISSUE DATE	02/06/20
CLIENT PROJECT NO.	

TITLE

BALLROOM DRAIN, WASTE, AND VENT ISOMETRICS

SHEET

3P3-12

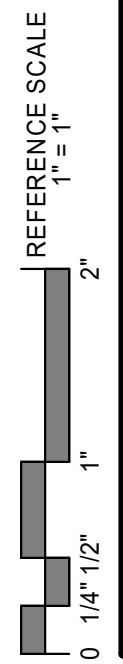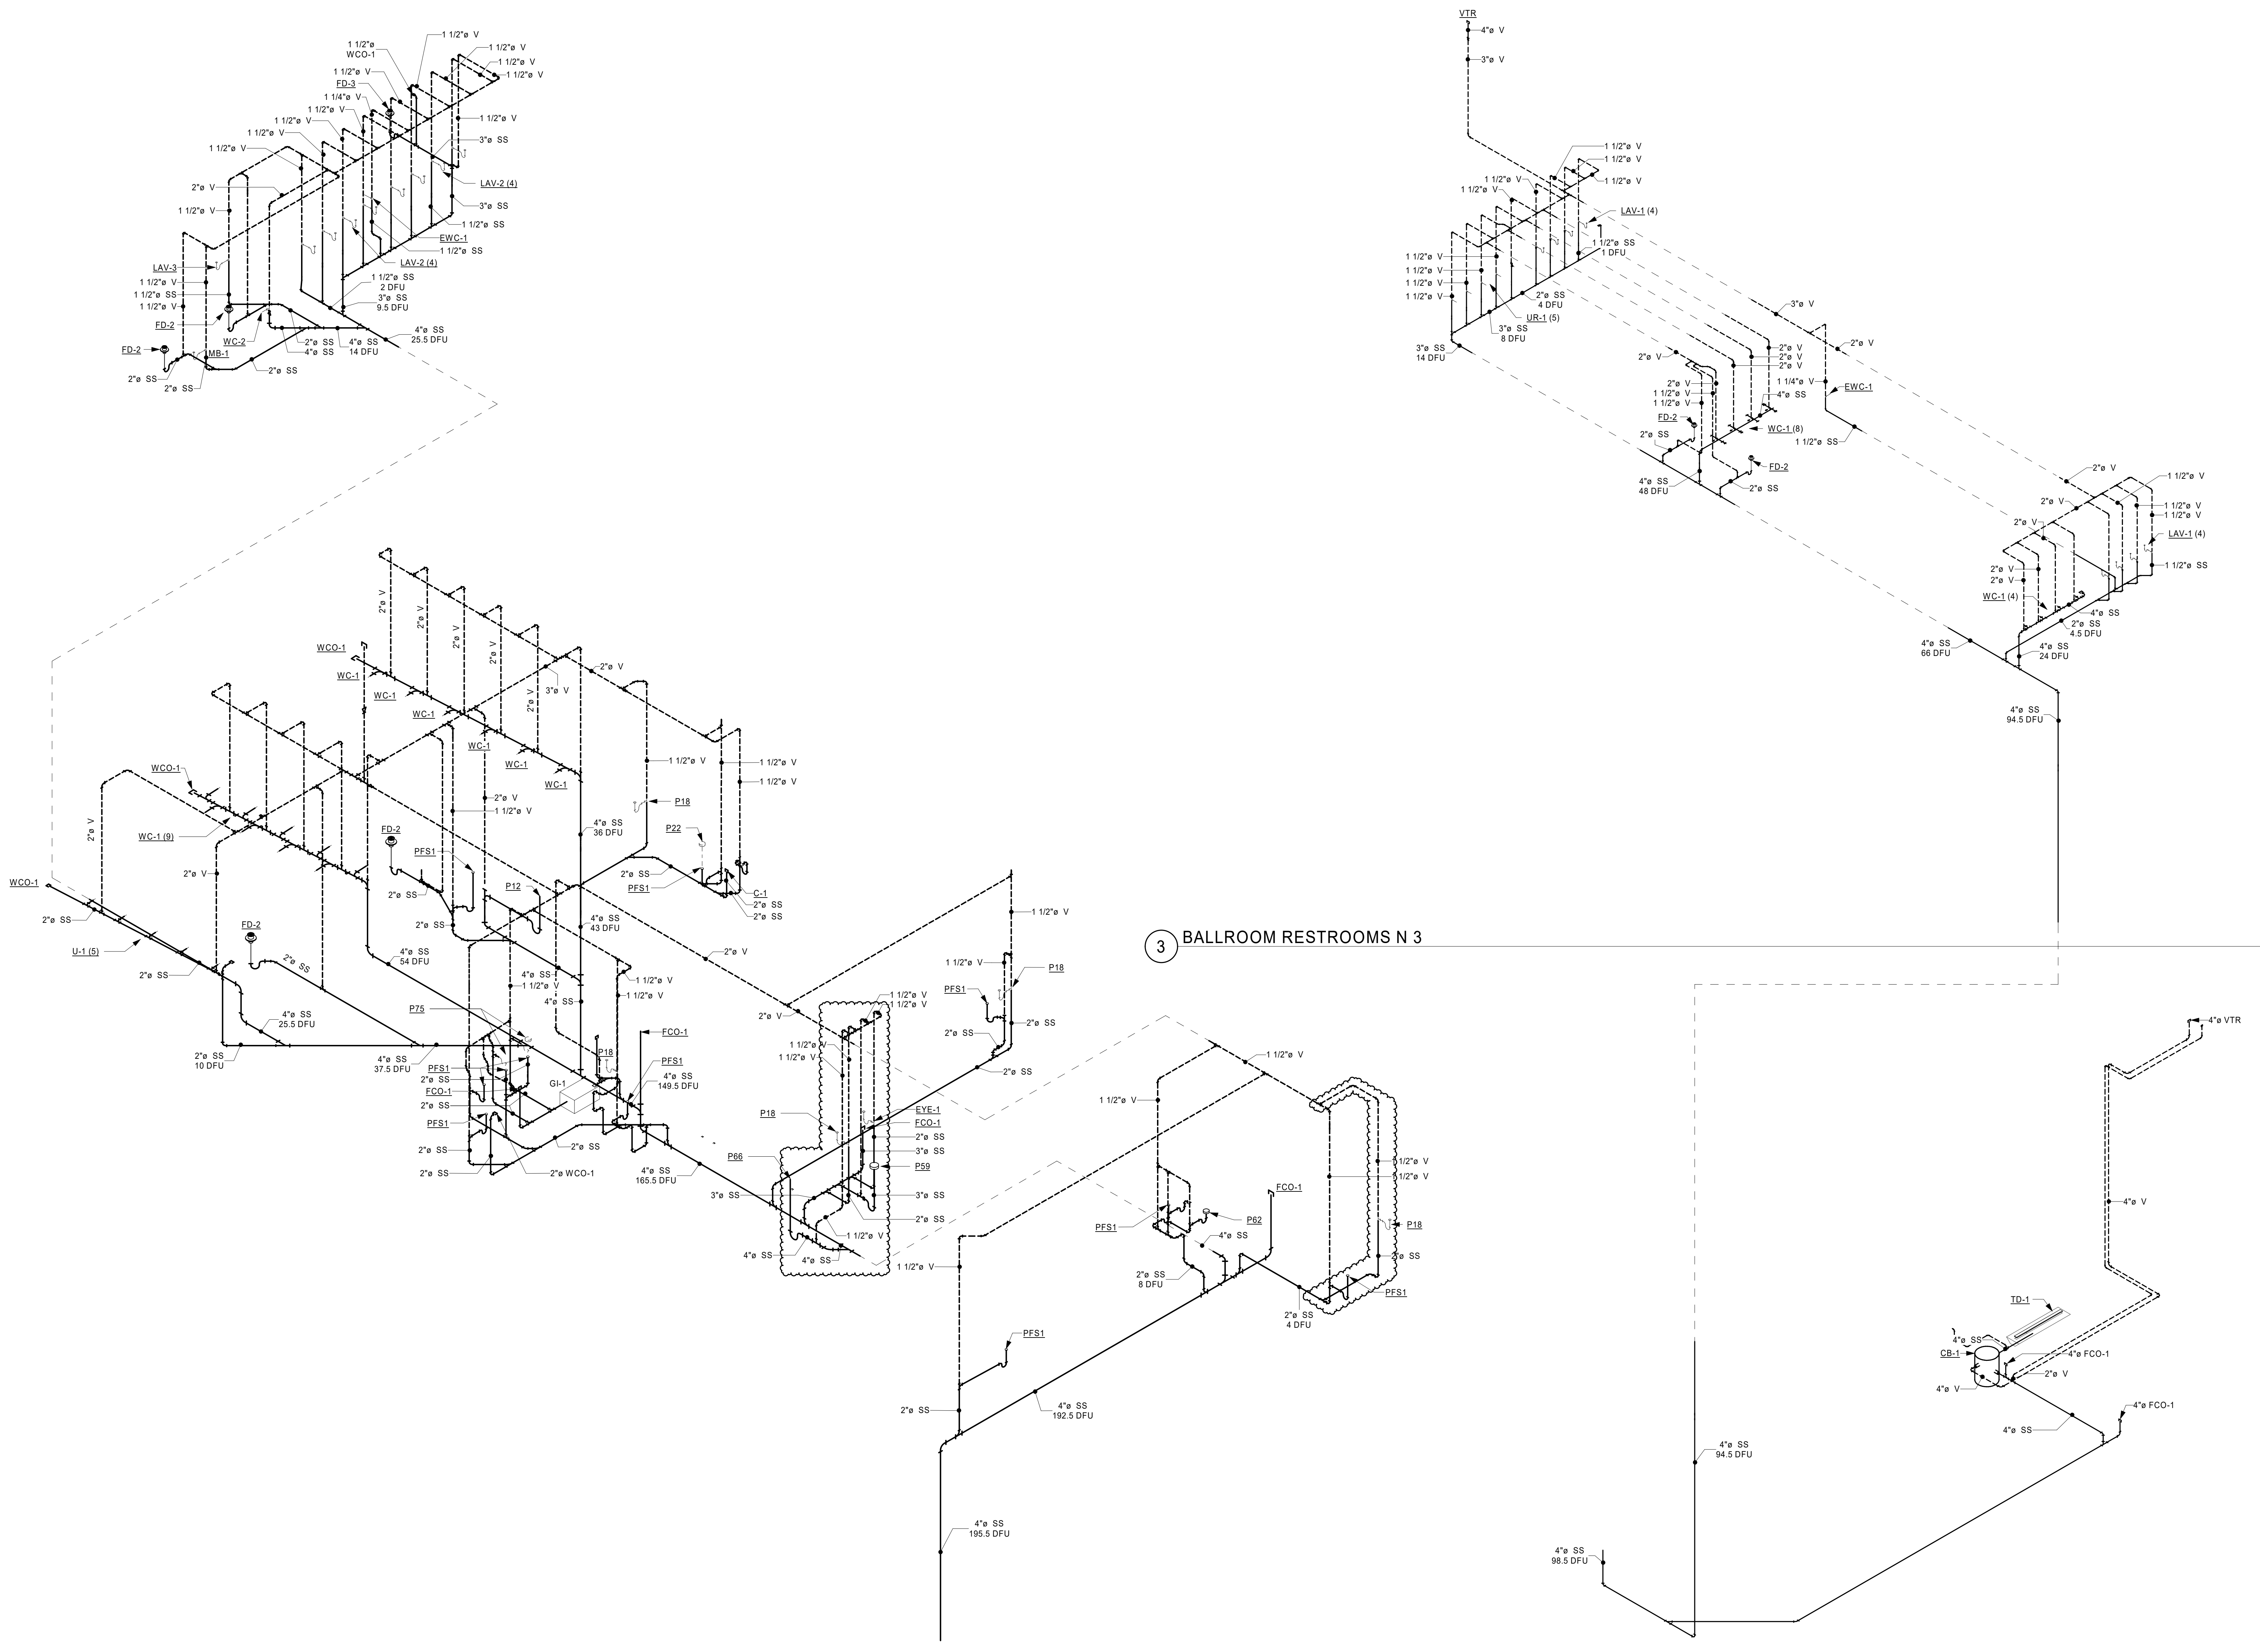

6 BALLROOM RESTROOMS S 4

3 BALLROOM RESTROOMS N 3

4 NORTH HALL TRENCH DRAIN - ISOMETRIC

PLUMBING FIXTURE DOMESTIC WATER CONNECTION SIZE LEGEND

WC-X:	DCW - 2"	6.5 WSFU
U-1:	DCW - 1"	2 WSFU
LAV-X:	DCW - 1/2"	DHW - 1/2"
SK-1:	DCW - 1/2"	DHW - 1/2"
MB-1:	DCW - 3/4"	DHW - 3/4"
EWC-X:	DCW - 1/2"	0.25 WSFU
WF:	DCW - 1/2"	DHW - 1/2"

SHEET NOTES

1. ALL DUCTWORK, PIPING, EQUIPMENT, ETC. INDICATED ON PLANS ARE BASED ON INFORMATION FROM CONSTRUCTION DOCUMENTS AND FIELD VERIFICATION OF THE EXISTING BUILDING. FIELD VERIFY ALL EXISTING CONDITIONS.
2. SANITARY PIPING OF SIZE 2" OR LESS TO BE SLOPED AT 1/4" / 12".
3. SANITARY PIPING OF SIZE 3" AND GREATER TO BE SLOPED AT 1/8" / 12".



KEYNOTE LEGEND

78 BRADLEY THERMOSTATIC MIXING VALVE MODEL - TMV25.



CONT. ON 1 / 3P3-20B

2 OFFICES DOMESTIC WATER ISOMETRIC

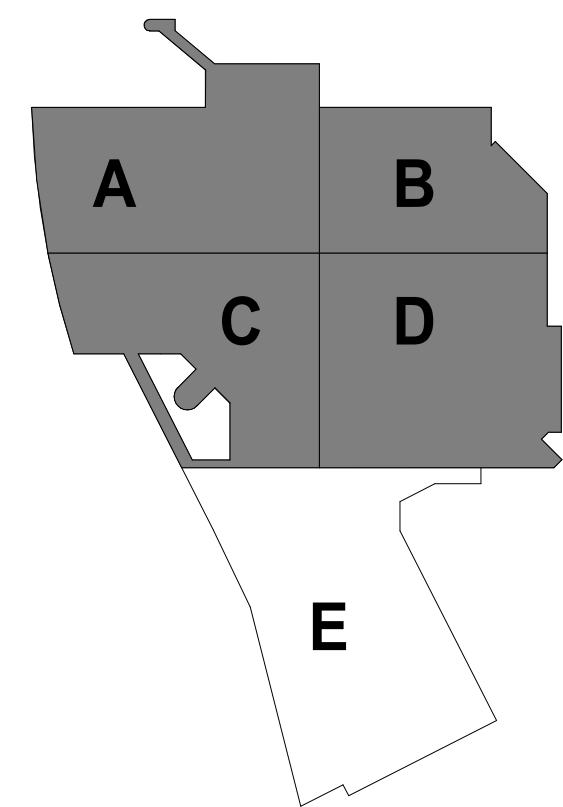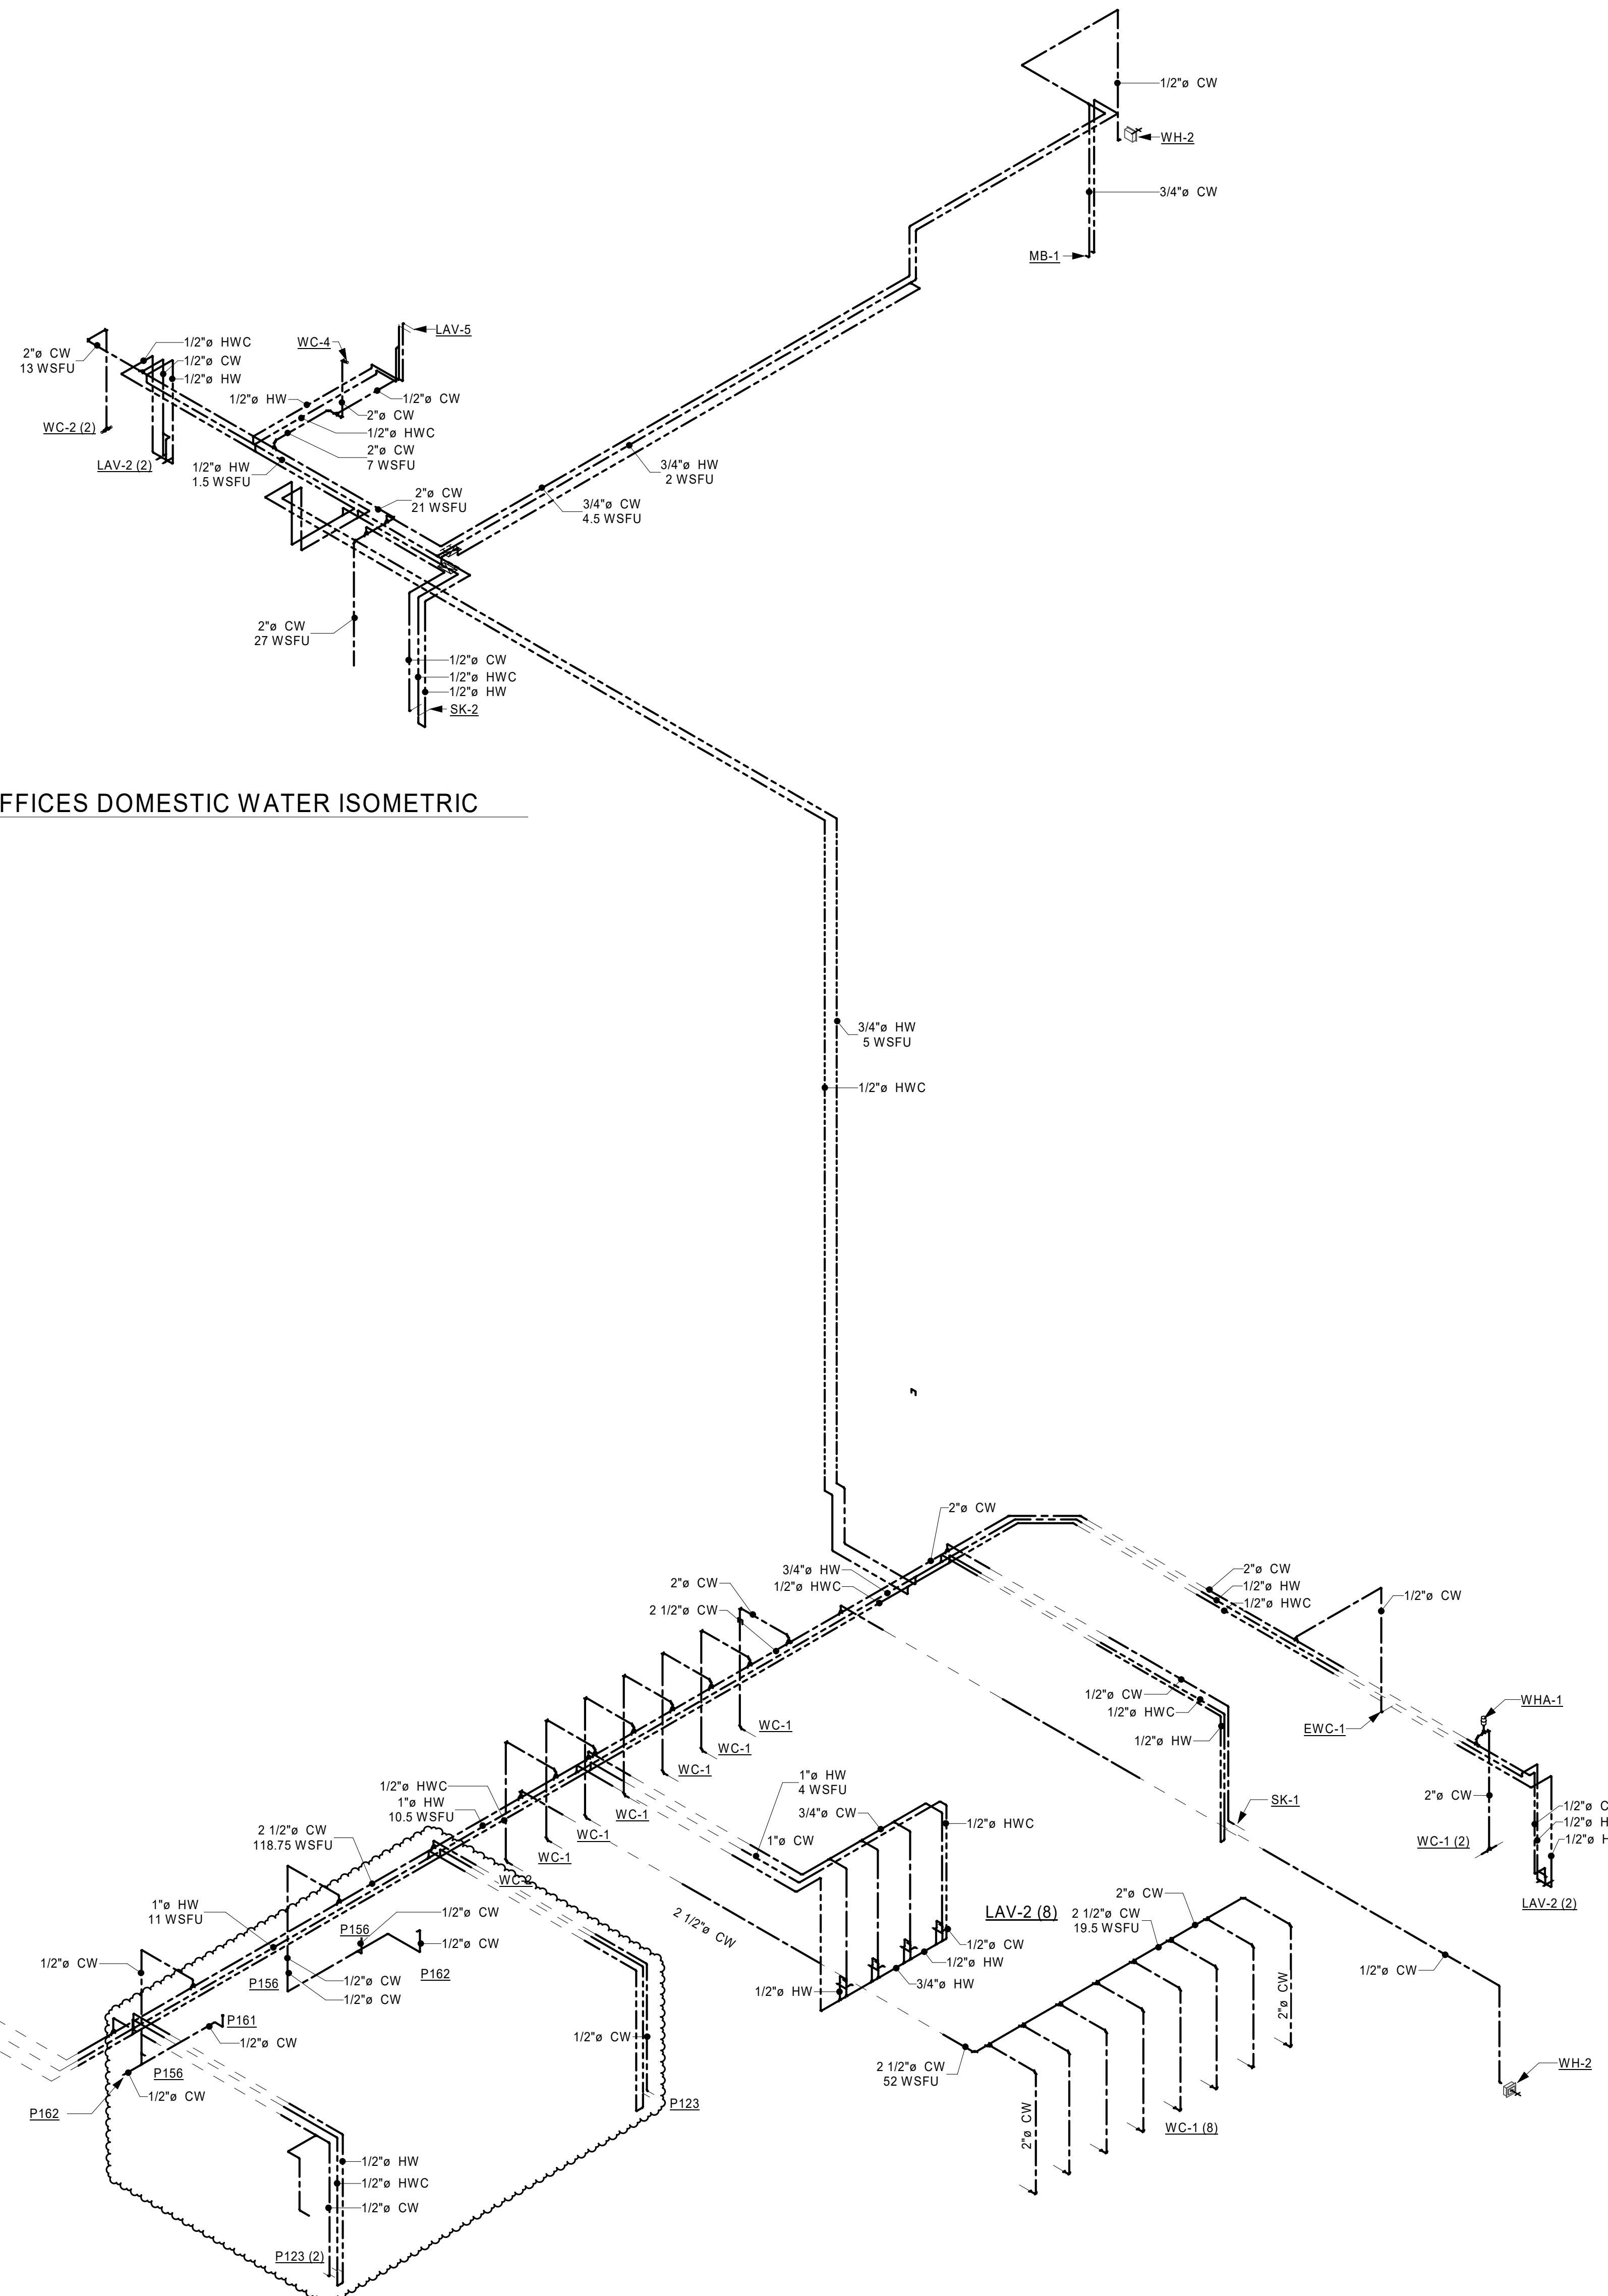

KEYPLAN

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PROJECT

LA CROSSE CENTER EXPANSION & RENOVATION

LA CROSSE WISCONSIN


REVISION SCHEDULE		
DATE	DESCRIPTION	BY
2020/03/30	PR #10	JMH
2020/05/15	PR #14	JMH
2020/06/05	PR #16	JMH
2020/08/10	PR #21	JMH

PROJECT NO.	16-19990
FILE NAME	19990 Arch R18.rvt
DRAWN BY	JMH
DESIGNED BY	RKD
REVIEWED BY	SMS
ORIGINAL ISSUE DATE	02/06/20


CLIENT PROJECT NO.

CONCOURSE LEVEL DOMESTIC WATER ISOMETRICS

SHEET
3P3-21

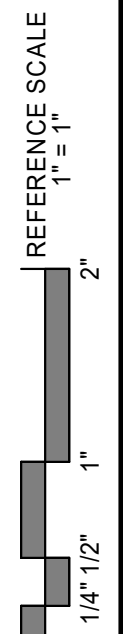

1 EAST CONCOURSE DOMESTIC WATER ISOMETRIC

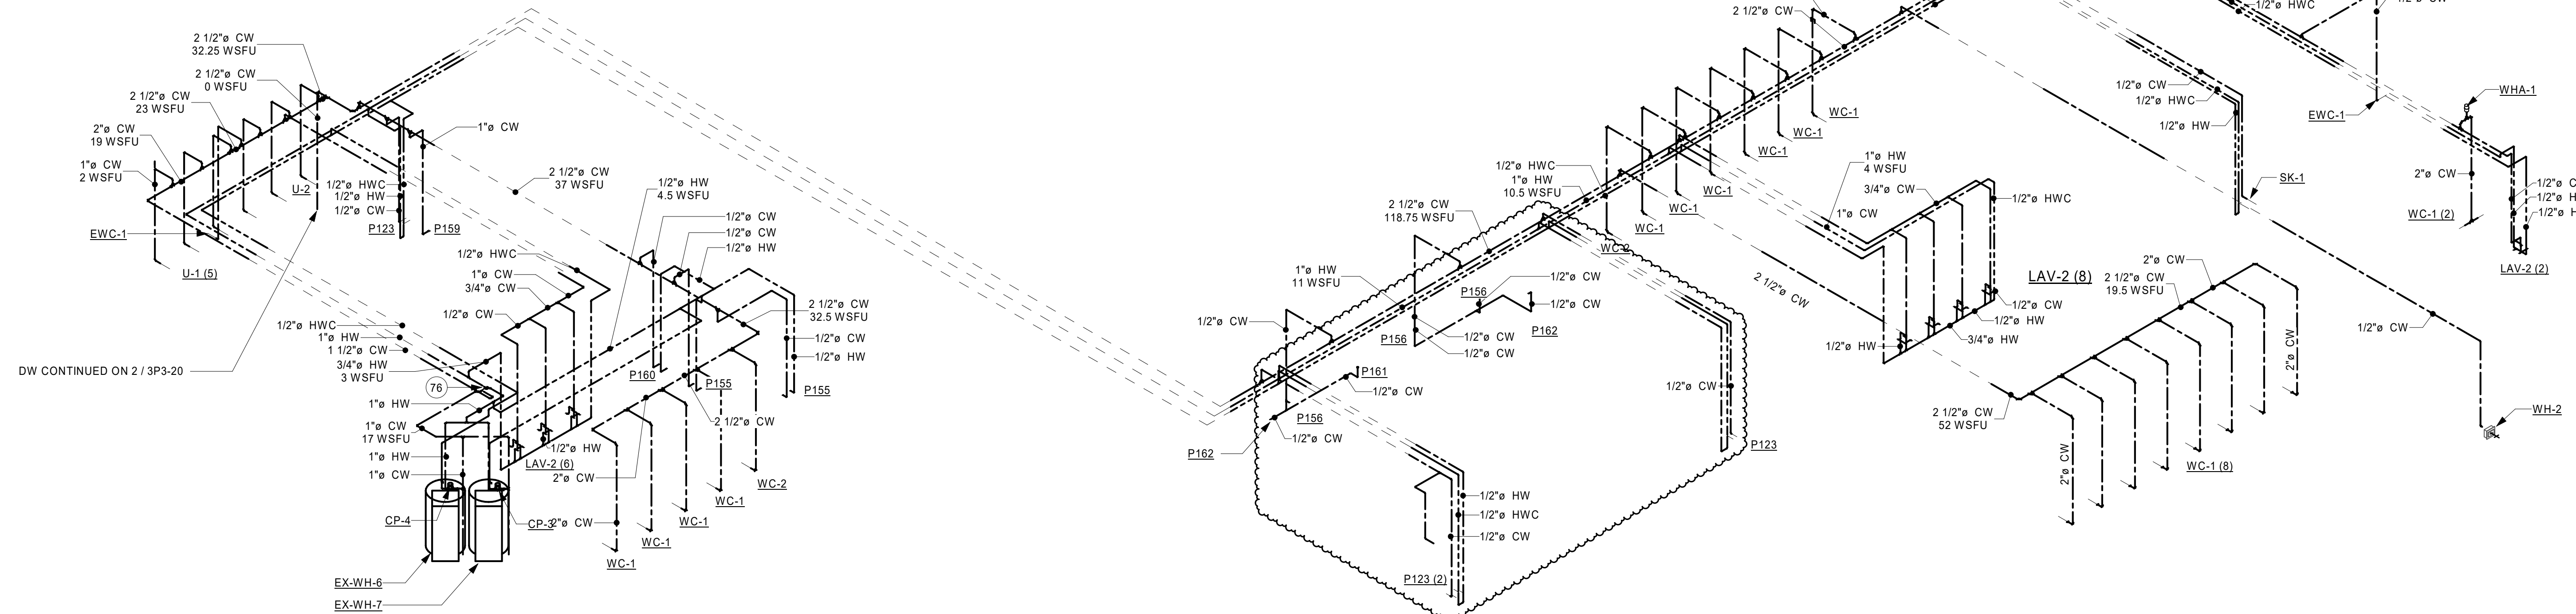

PLUMBING FIXTURE DOMESTIC WATER CONNECTION SIZE LEGEND


WC-X:	DCW - 2"	6.5 WSFU	
U-1:	DCW - 1"	2 WSFU	
LAV-X:	DCW - 1/2"	DHW - 1/2"	0.5 WSFU EACH
SK-1:	DCW - 1/2"	DHW - 1/2"	0.5 WSFU EACH
MB-1:	DCW - 3/4"	DHW - 3/4"	2 WSFU EACH
EWC-X:	DCW - 1/2"	DHW - 1/2"	0.25 WSFU
WF:	DCW - 1/2"	DHW - 1/2"	1.5 WSFU EACH

SHEET NOTES

1. ALL DUCTWORK, PIPING, EQUIPMENT, ETC. INDICATED ON PLANS ARE BASED ON INFORMATION FROM CONSTRUCTION DOCUMENTS AND FIELD VERIFICATION OF THE EXISTING BUILDING. FIELD VERIFY ALL EXISTING CONDITIONS.
2. SANITARY PIPING OF SIZE 2" OR LESS TO BE SLOPED AT 1/4" / 12".
3. SANITARY PIPING OF SIZE 3" AND GREATER TO BE SLOPED AT 1/8" / 12".



KEYNOTE LEGEND

75	BRADLEY THERMOSTATIC MIXING VALVE MODEL - TMV45.
106	3/4" HOT AND COLD WATER TO WASHER CONNECTION.
109	INSTALL WATTS LF288A VACUUM BREAKER PER MANUFACTURER'S INSTRUCTIONS TO SATISFY ASSE 1001 REQUIREMENT.
113	INSTALL WATER HAMMER ARRESTOR (WHA-1).

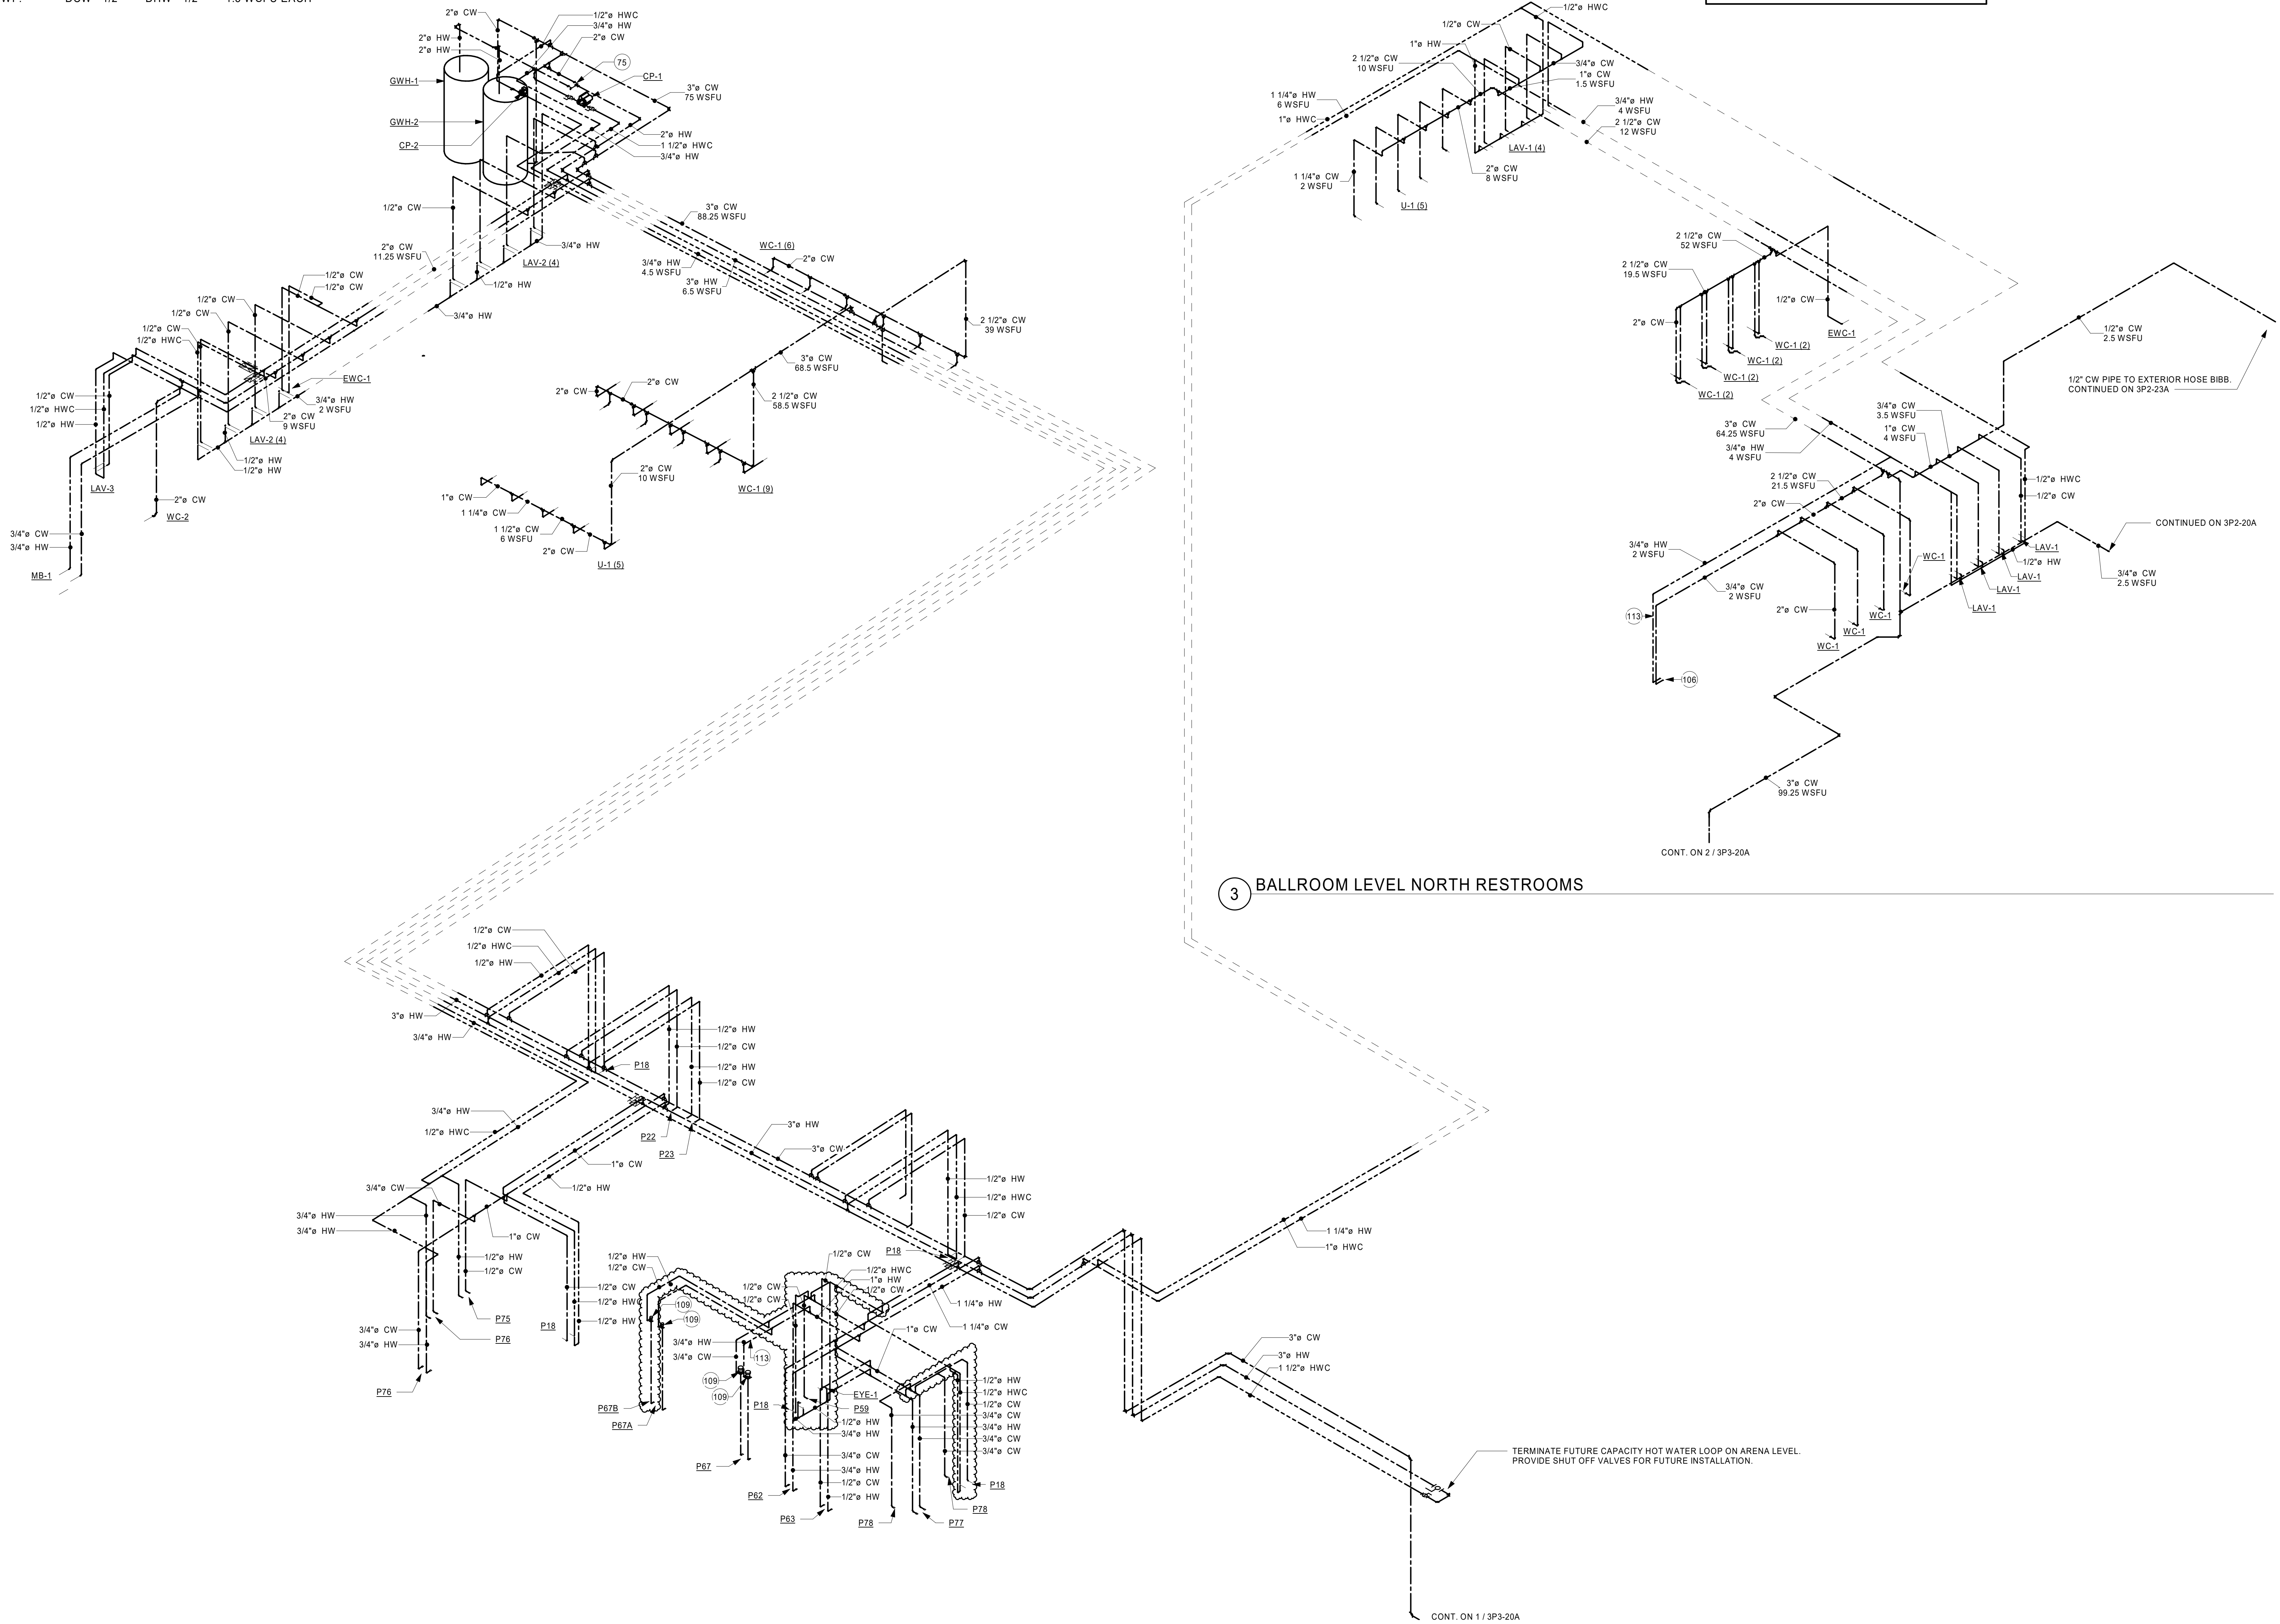

1 BALLROOM LEVEL KITCHEN

3 BALLROOM LEVEL NORTH RESTROOMS

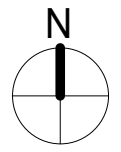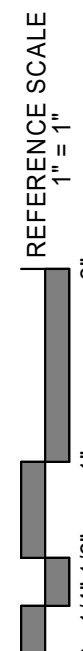

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PROJECT

LA CROSSE CENTER EXPANSION & RENOVATION

LA CROSSE WISCONSIN

REVISION SCHEDULE

DATE	DESCRIPTION	BY
2020/03/30	PR #10	JMH
2020/08/18	PR #21	JMH

PROJECT NO.	16-19990
FILE NAME	19990 Arch R18.rvt
DRAWN BY	JMH
DESIGNED BY	RKD
REVIEWED BY	SMS
ORIGINAL ISSUE DATE	02/06/20

CLIENT PROJECT NO.


TITLE

BALLROOM DOMESTIC WATER ISOMETRICS




FIXTURE CONNECTION SIZE LEGEND

WC-X:	4" SAN,	2" VENT	6 DFU
U-1:	2" SAN,	1 1/2" VENT	2 DFU
LAV-X:	1 1/2" SAN,	1 1/2" VENT	1 DFU
SK-1:	1 1/2" SAN,	1 1/2" VENT	1 DFU
MB-1:	2" SAN,	1 1/2" VENT	3 DFU
EWC-X:	1 1/2" SAN,	1 1/2" VENT	0.5 DFU
FD-2:	2" SAN,	1 1/4" VENT	2 DFU
FD-3:	3" SAN,	1 1/2" VENT	3 DFU

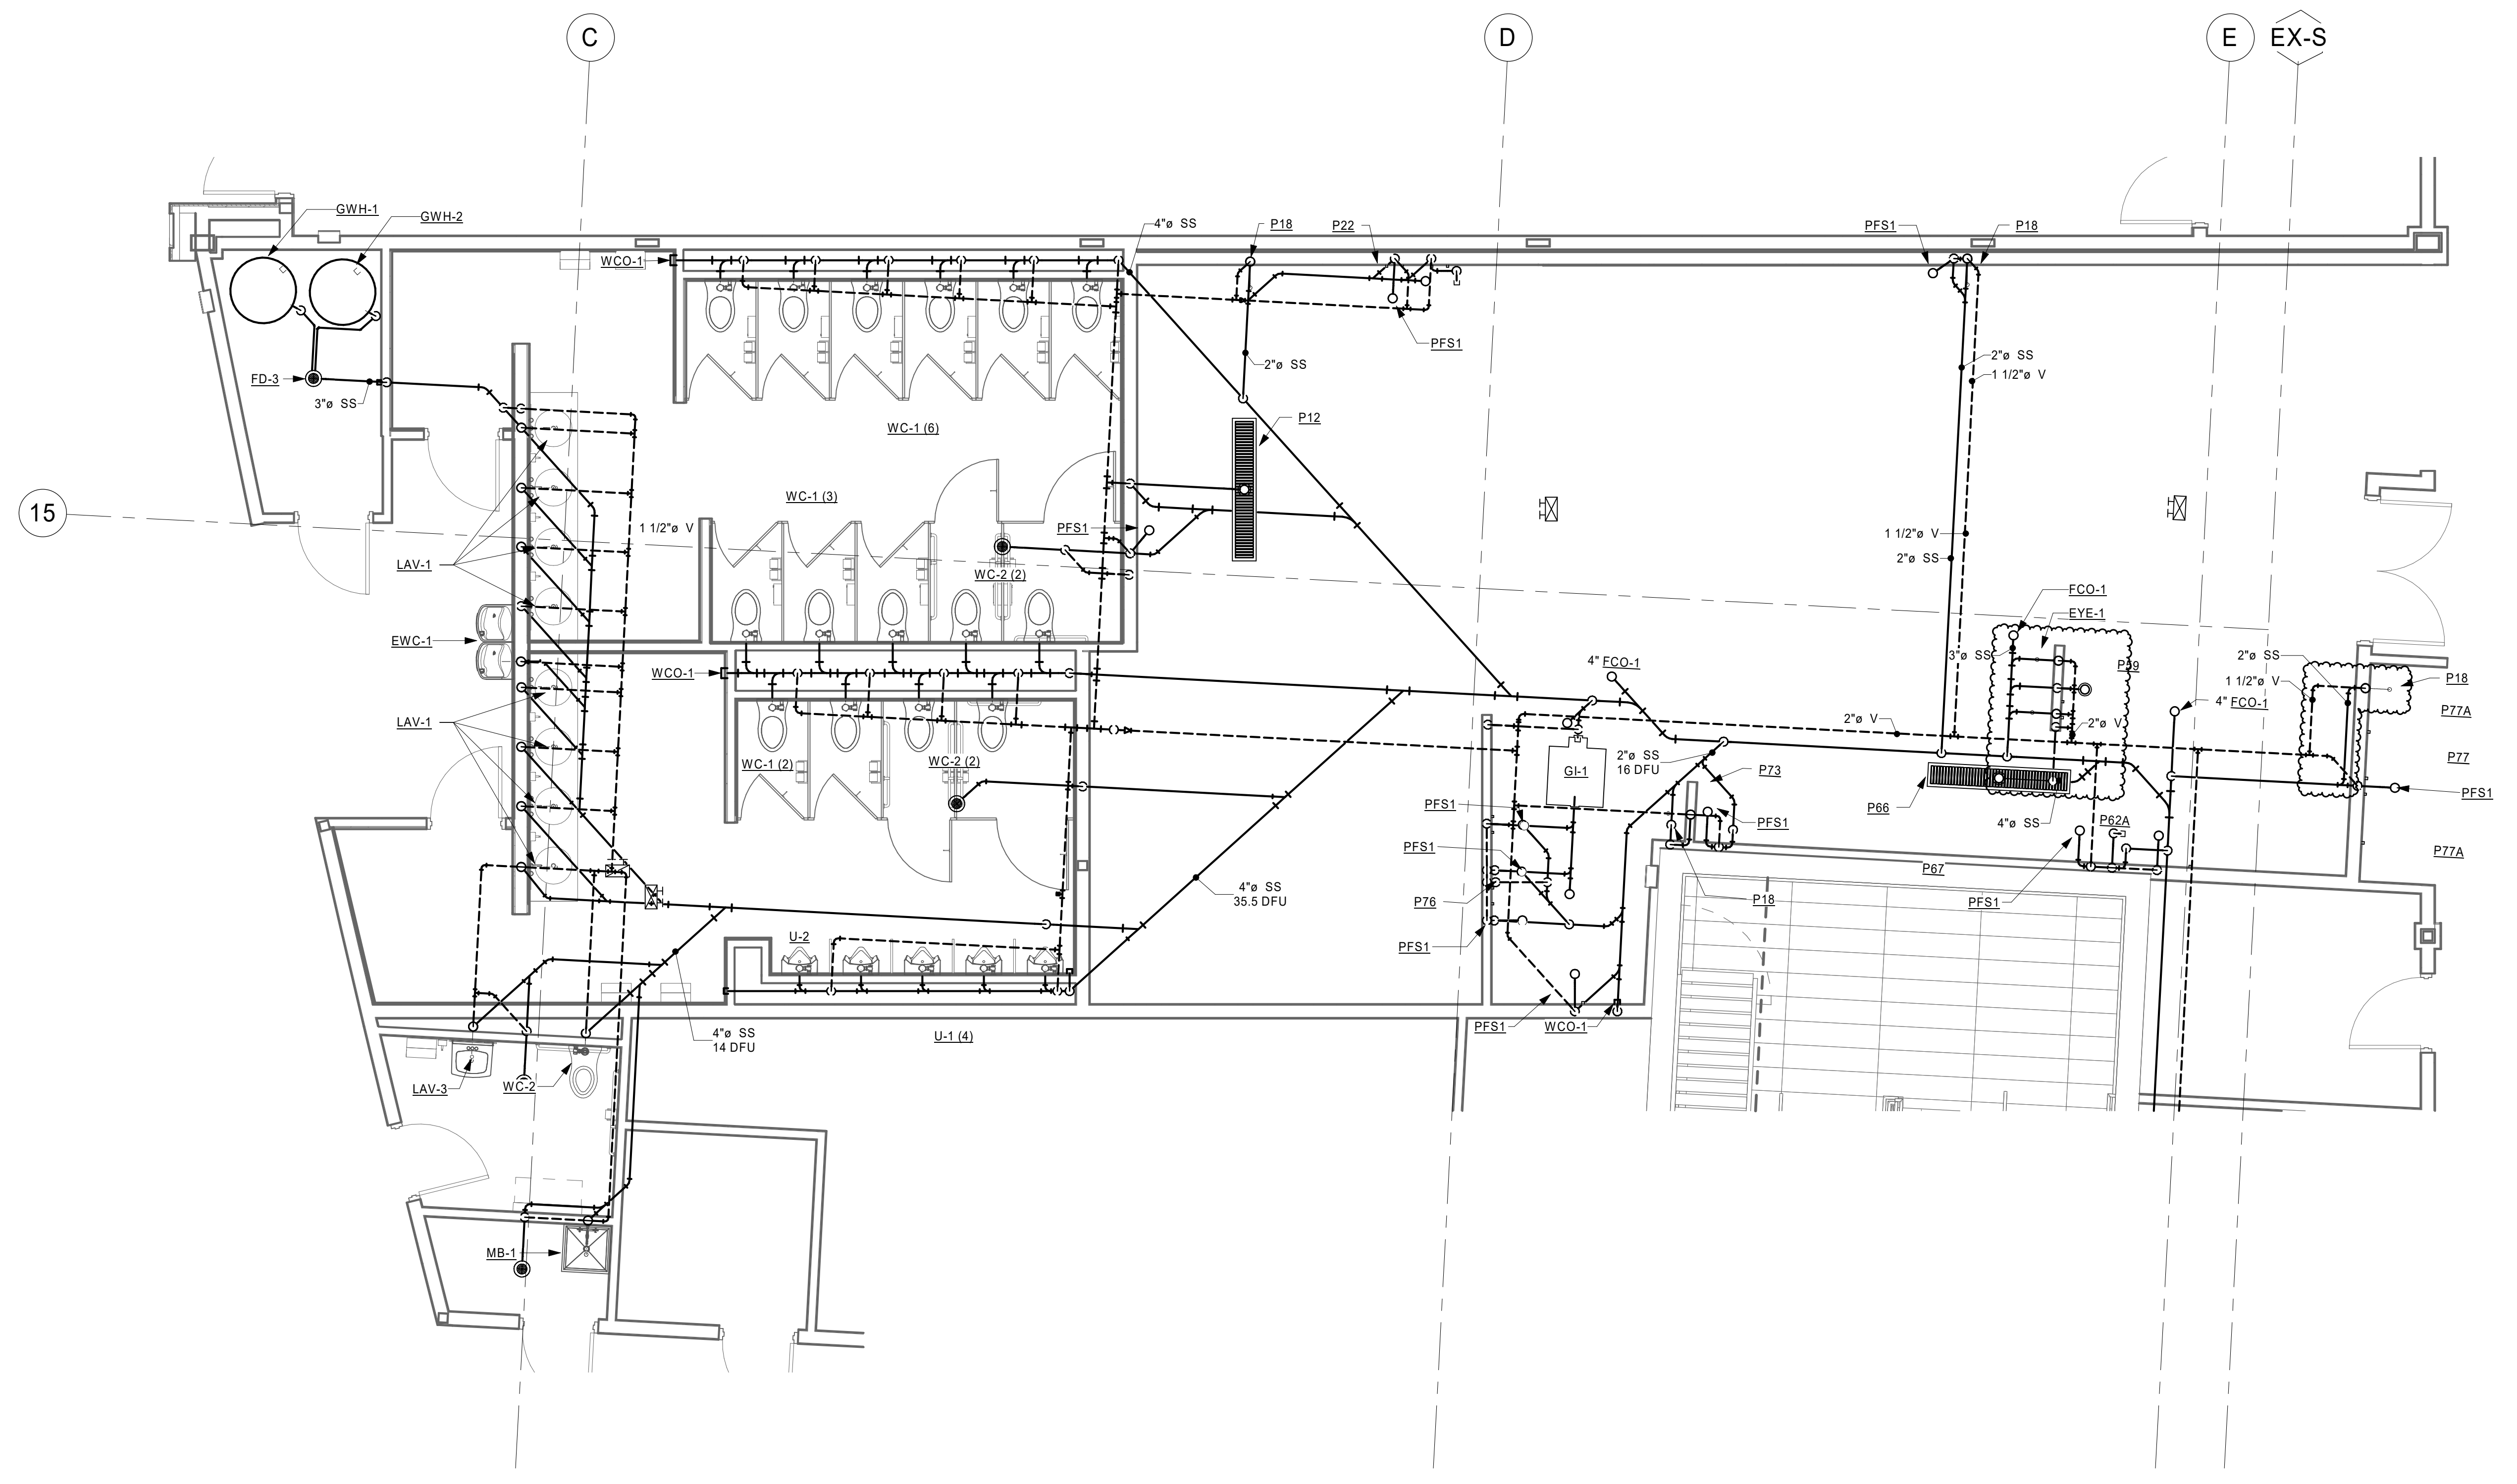

1 BALLROOM LEVEL KITCHEN & RESTROOMS - ENLARGED SANITARY PLAN
1/4" = 1'-0"

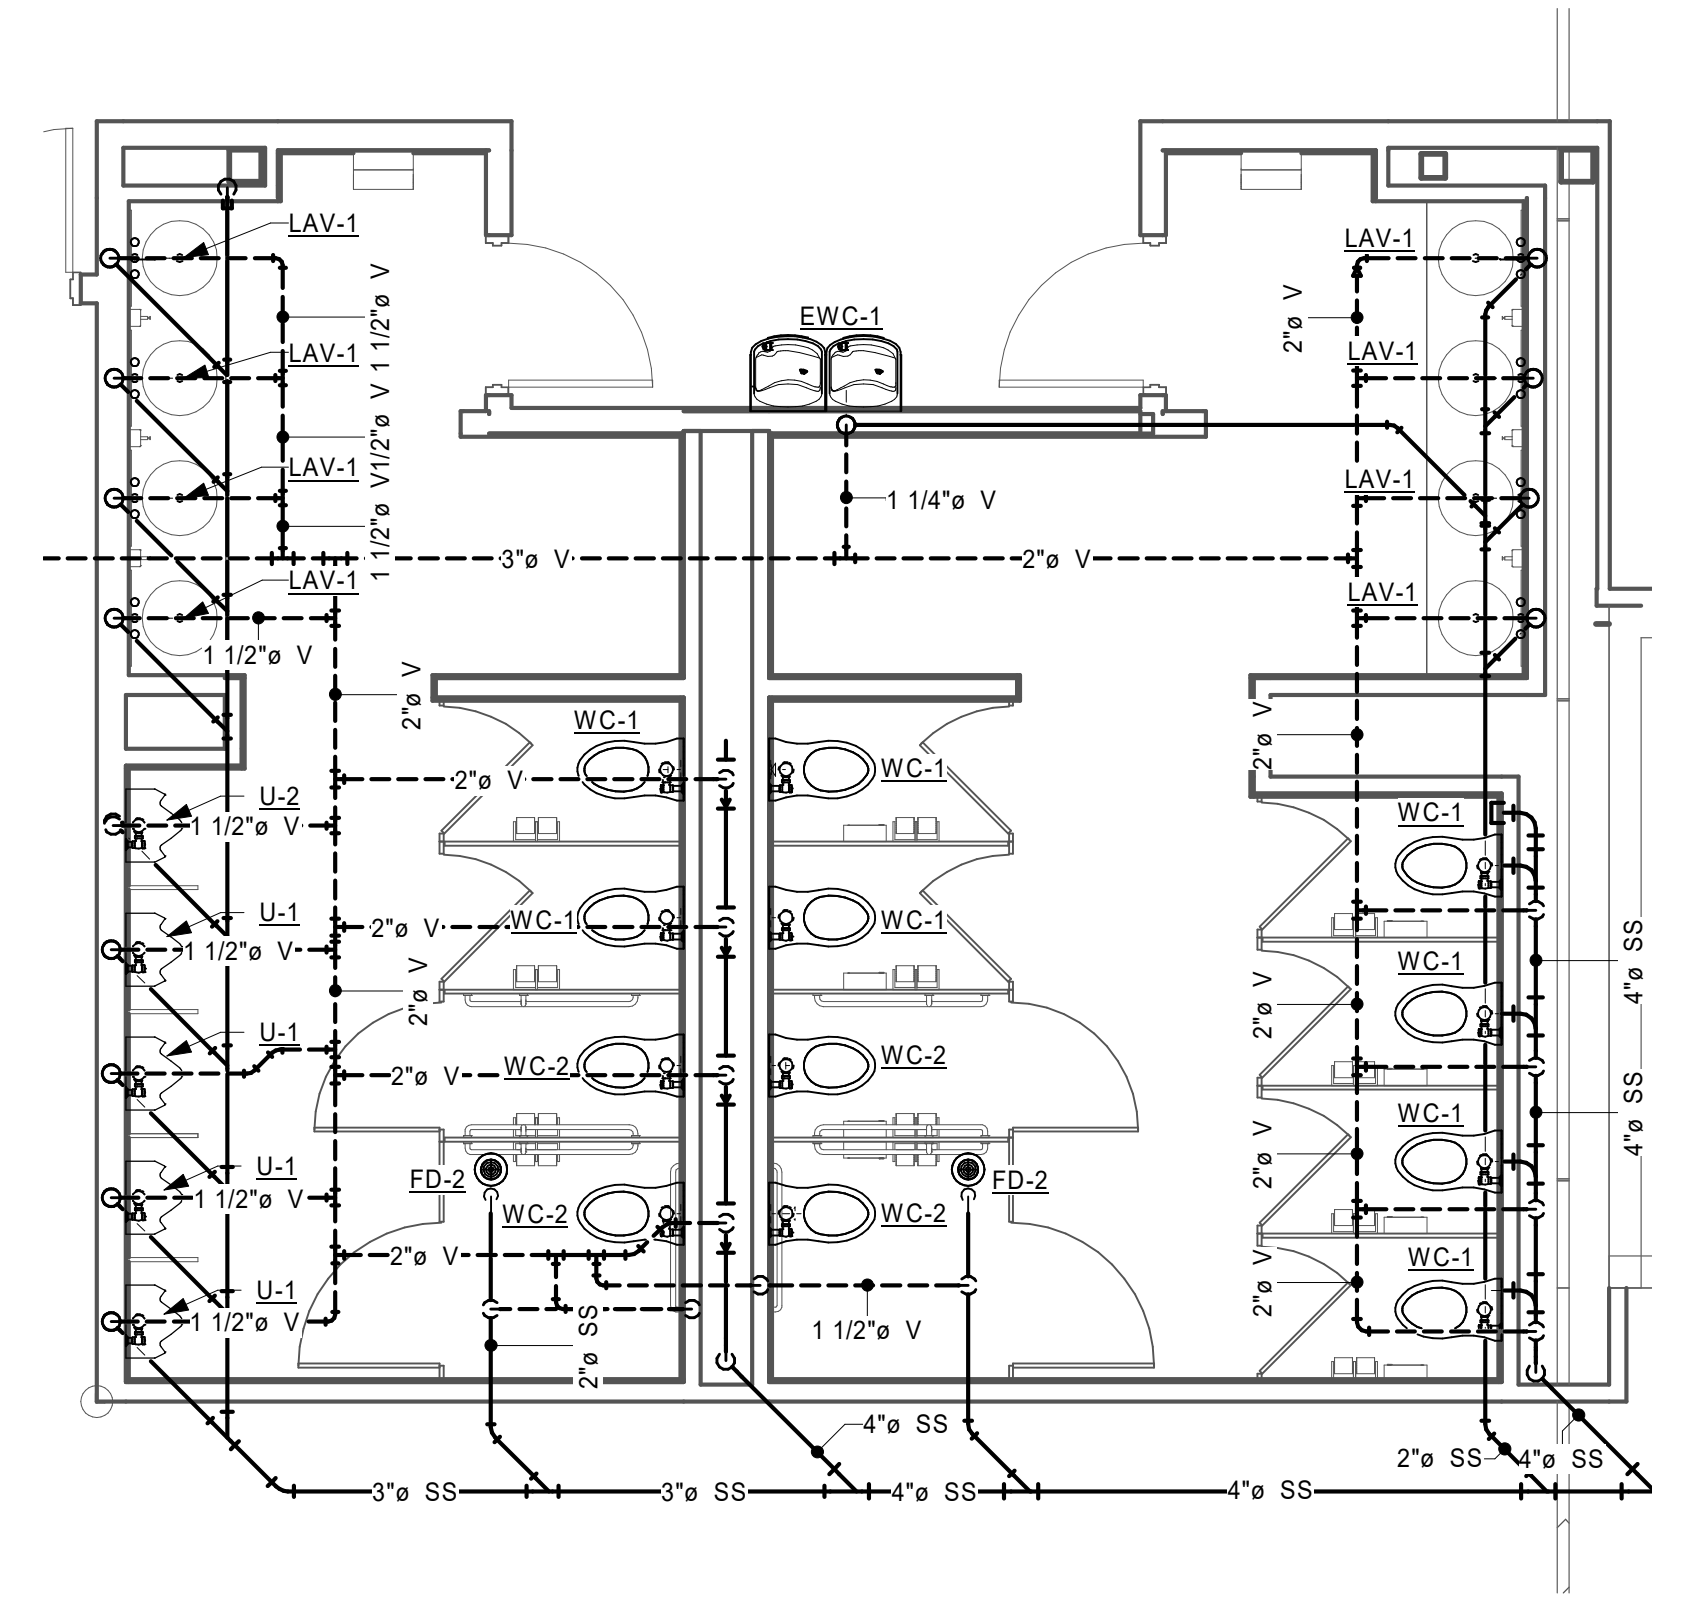

2 BALLROOM LEVEL AREA A RESTROOMS - ENLARGED SANITARY PLAN
1/4" = 1'-0"

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PROJECT

LA CROSSE CENTER EXPANSION & RENOVATION

LA CROSSE WISCONSIN

REVISION SCHEDULE		
DATE	DESCRIPTION	BY
2020/03/30 PR #10		JMH
2020/08/18 PR #21		JMH



PROJECT NO.	16-19990
FILE NAME	19990 Arch R18.rvt
DRAWN BY	JMH
DESIGNED BY	RKD
REVIEWED BY	SMS
ORIGINAL ISSUE DATE	02/06/20
CLIENT PROJECT NO.	

TITLE

PLUMBING CALLOUTS, SECTIONS, AND ELEVATIONS

SHEET


3P4-11

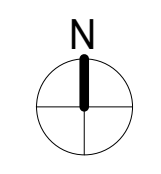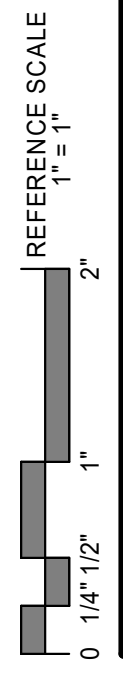




PLUMBING FIXTURE DOMESTIC WATER CONNECTION SIZE LEGEND

WC-X:	DCW - 2"	6.5 WSFU
U-1:	DCW - 1"	2 WSFU
LAV-X:	DCW - 1/2"	0.5 WSFU EACH
SK-1:	DCW - 1/2"	DHW - 1/2"
MB-1:	DCW - 3/4"	DHW - 3/4"
EWC-X:	DCW - 1/2"	2 WSFU EACH
WF:	DCW - 1/2"	0.25 WSFU
		1.5 WSFU EACH

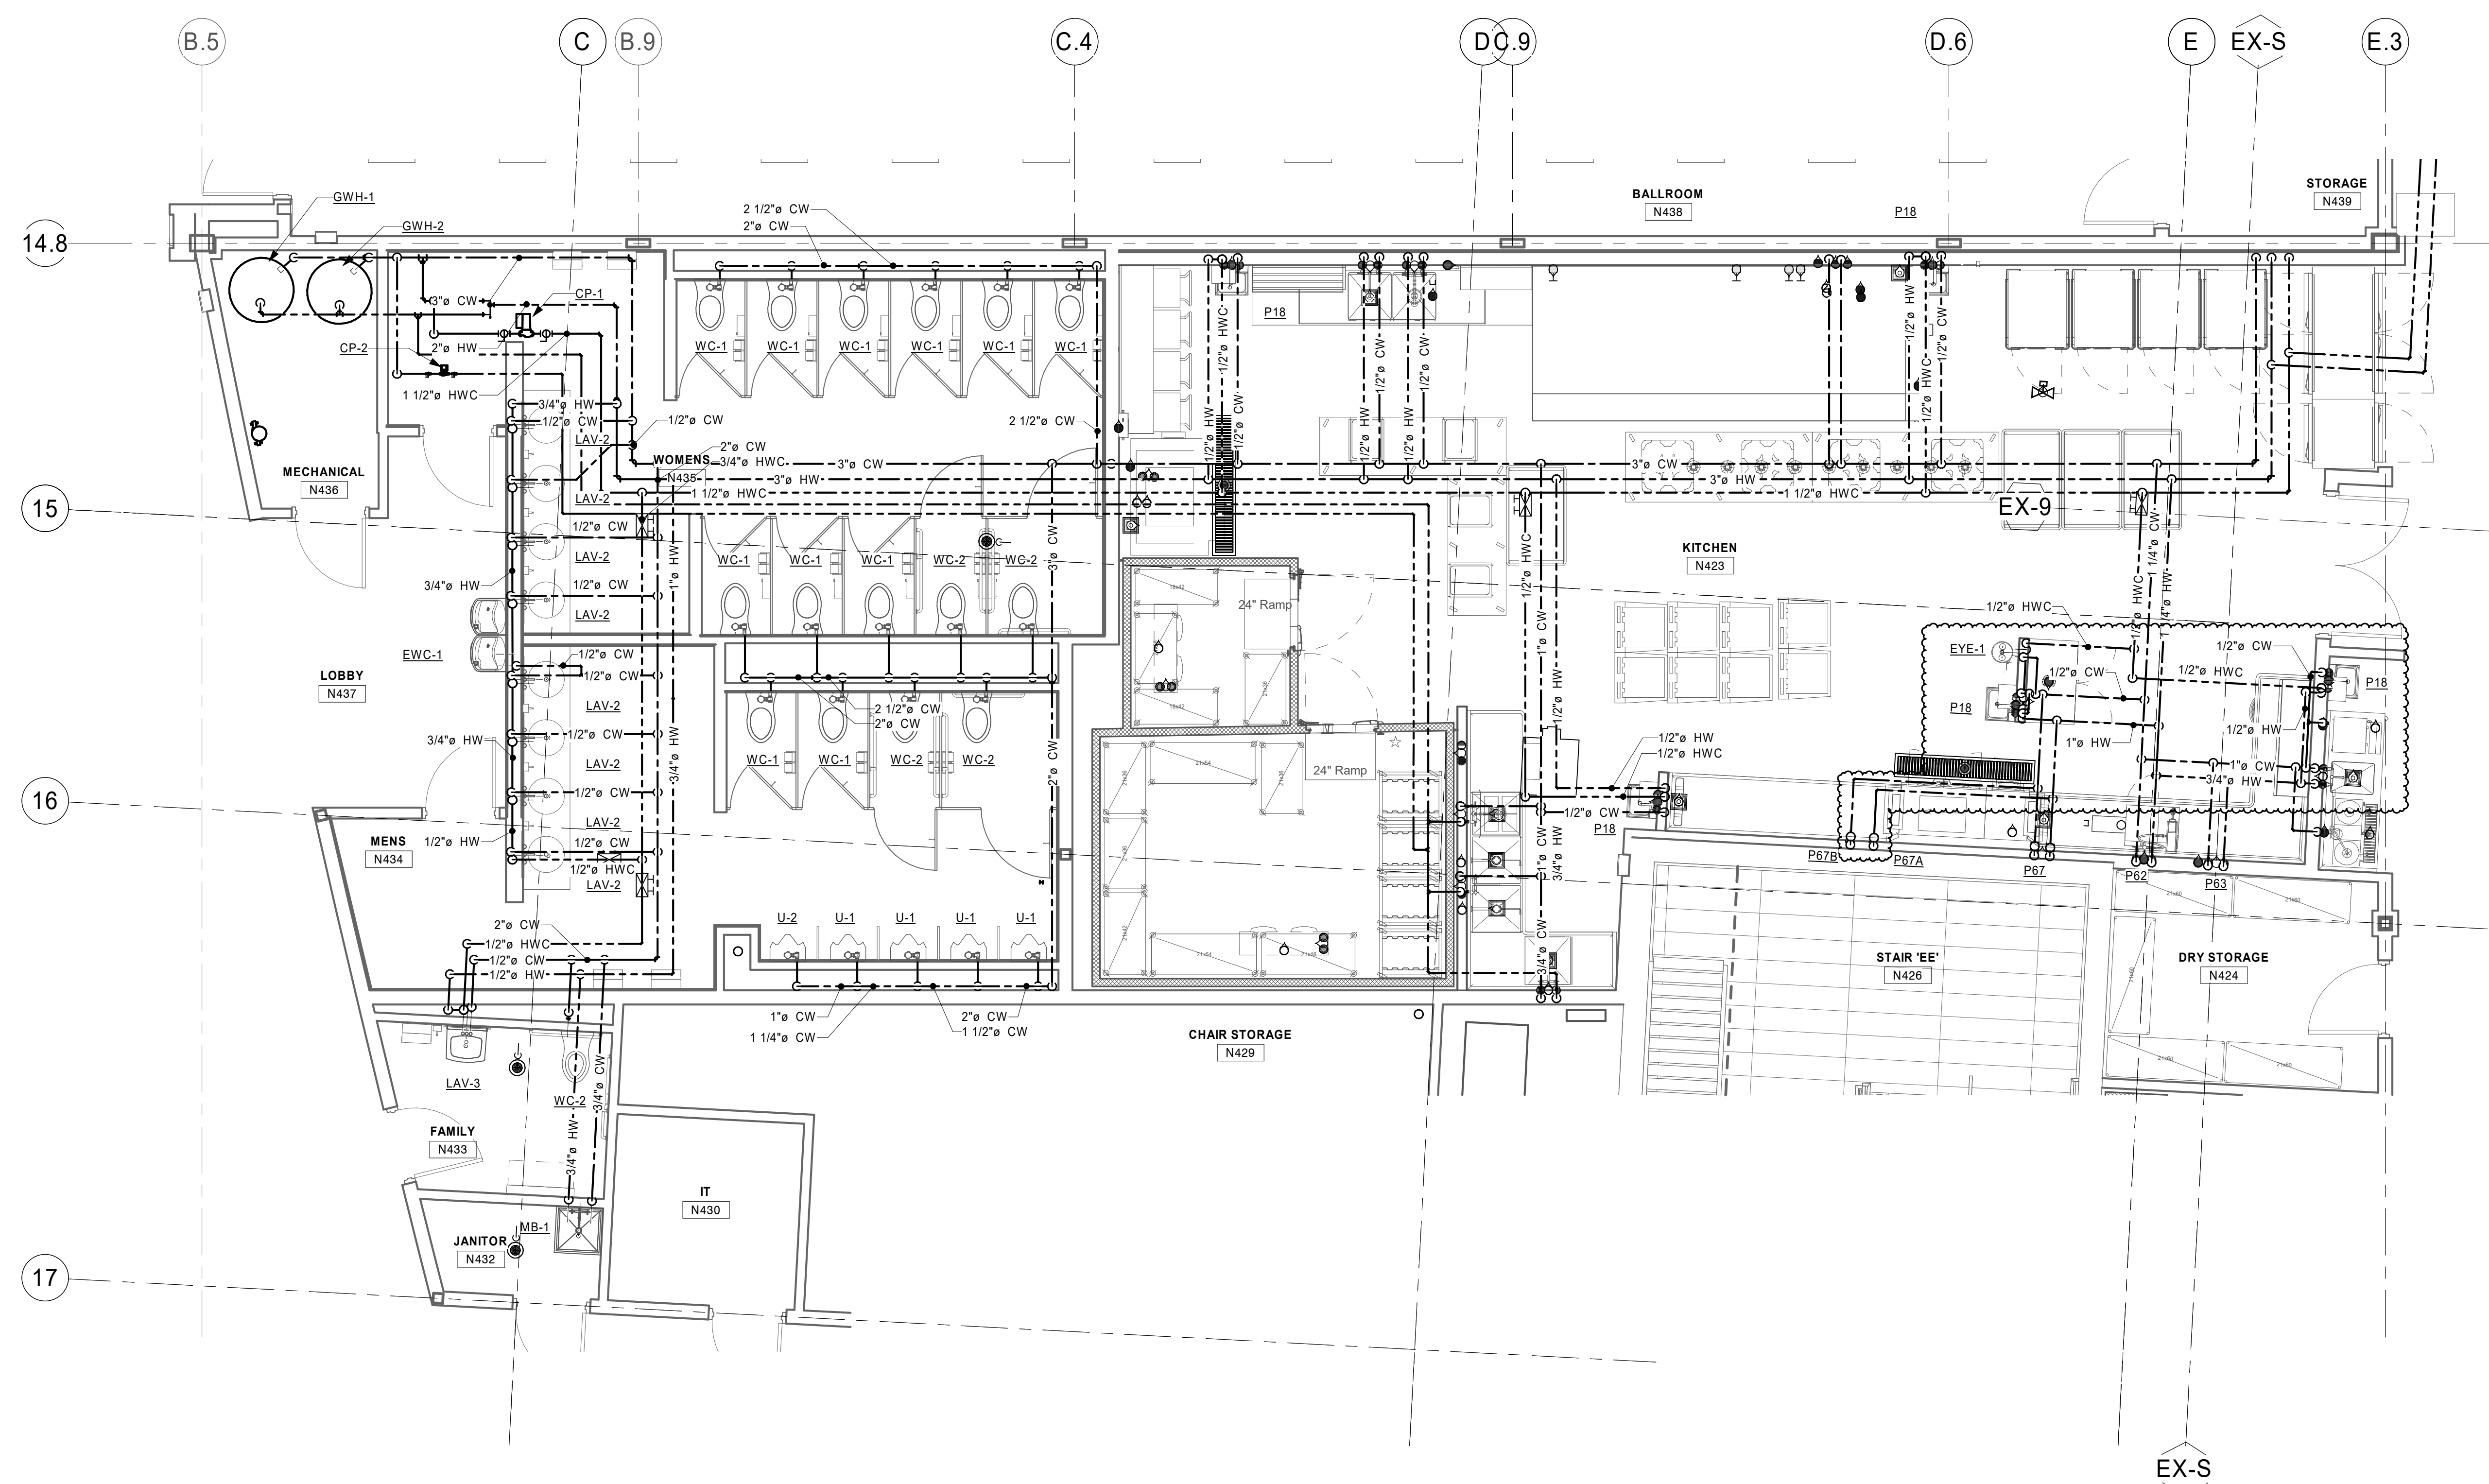

1 NEW BALLROOM LEVEL DW - KITCHEN & RESTROOMS
1/4" = 1'-0"

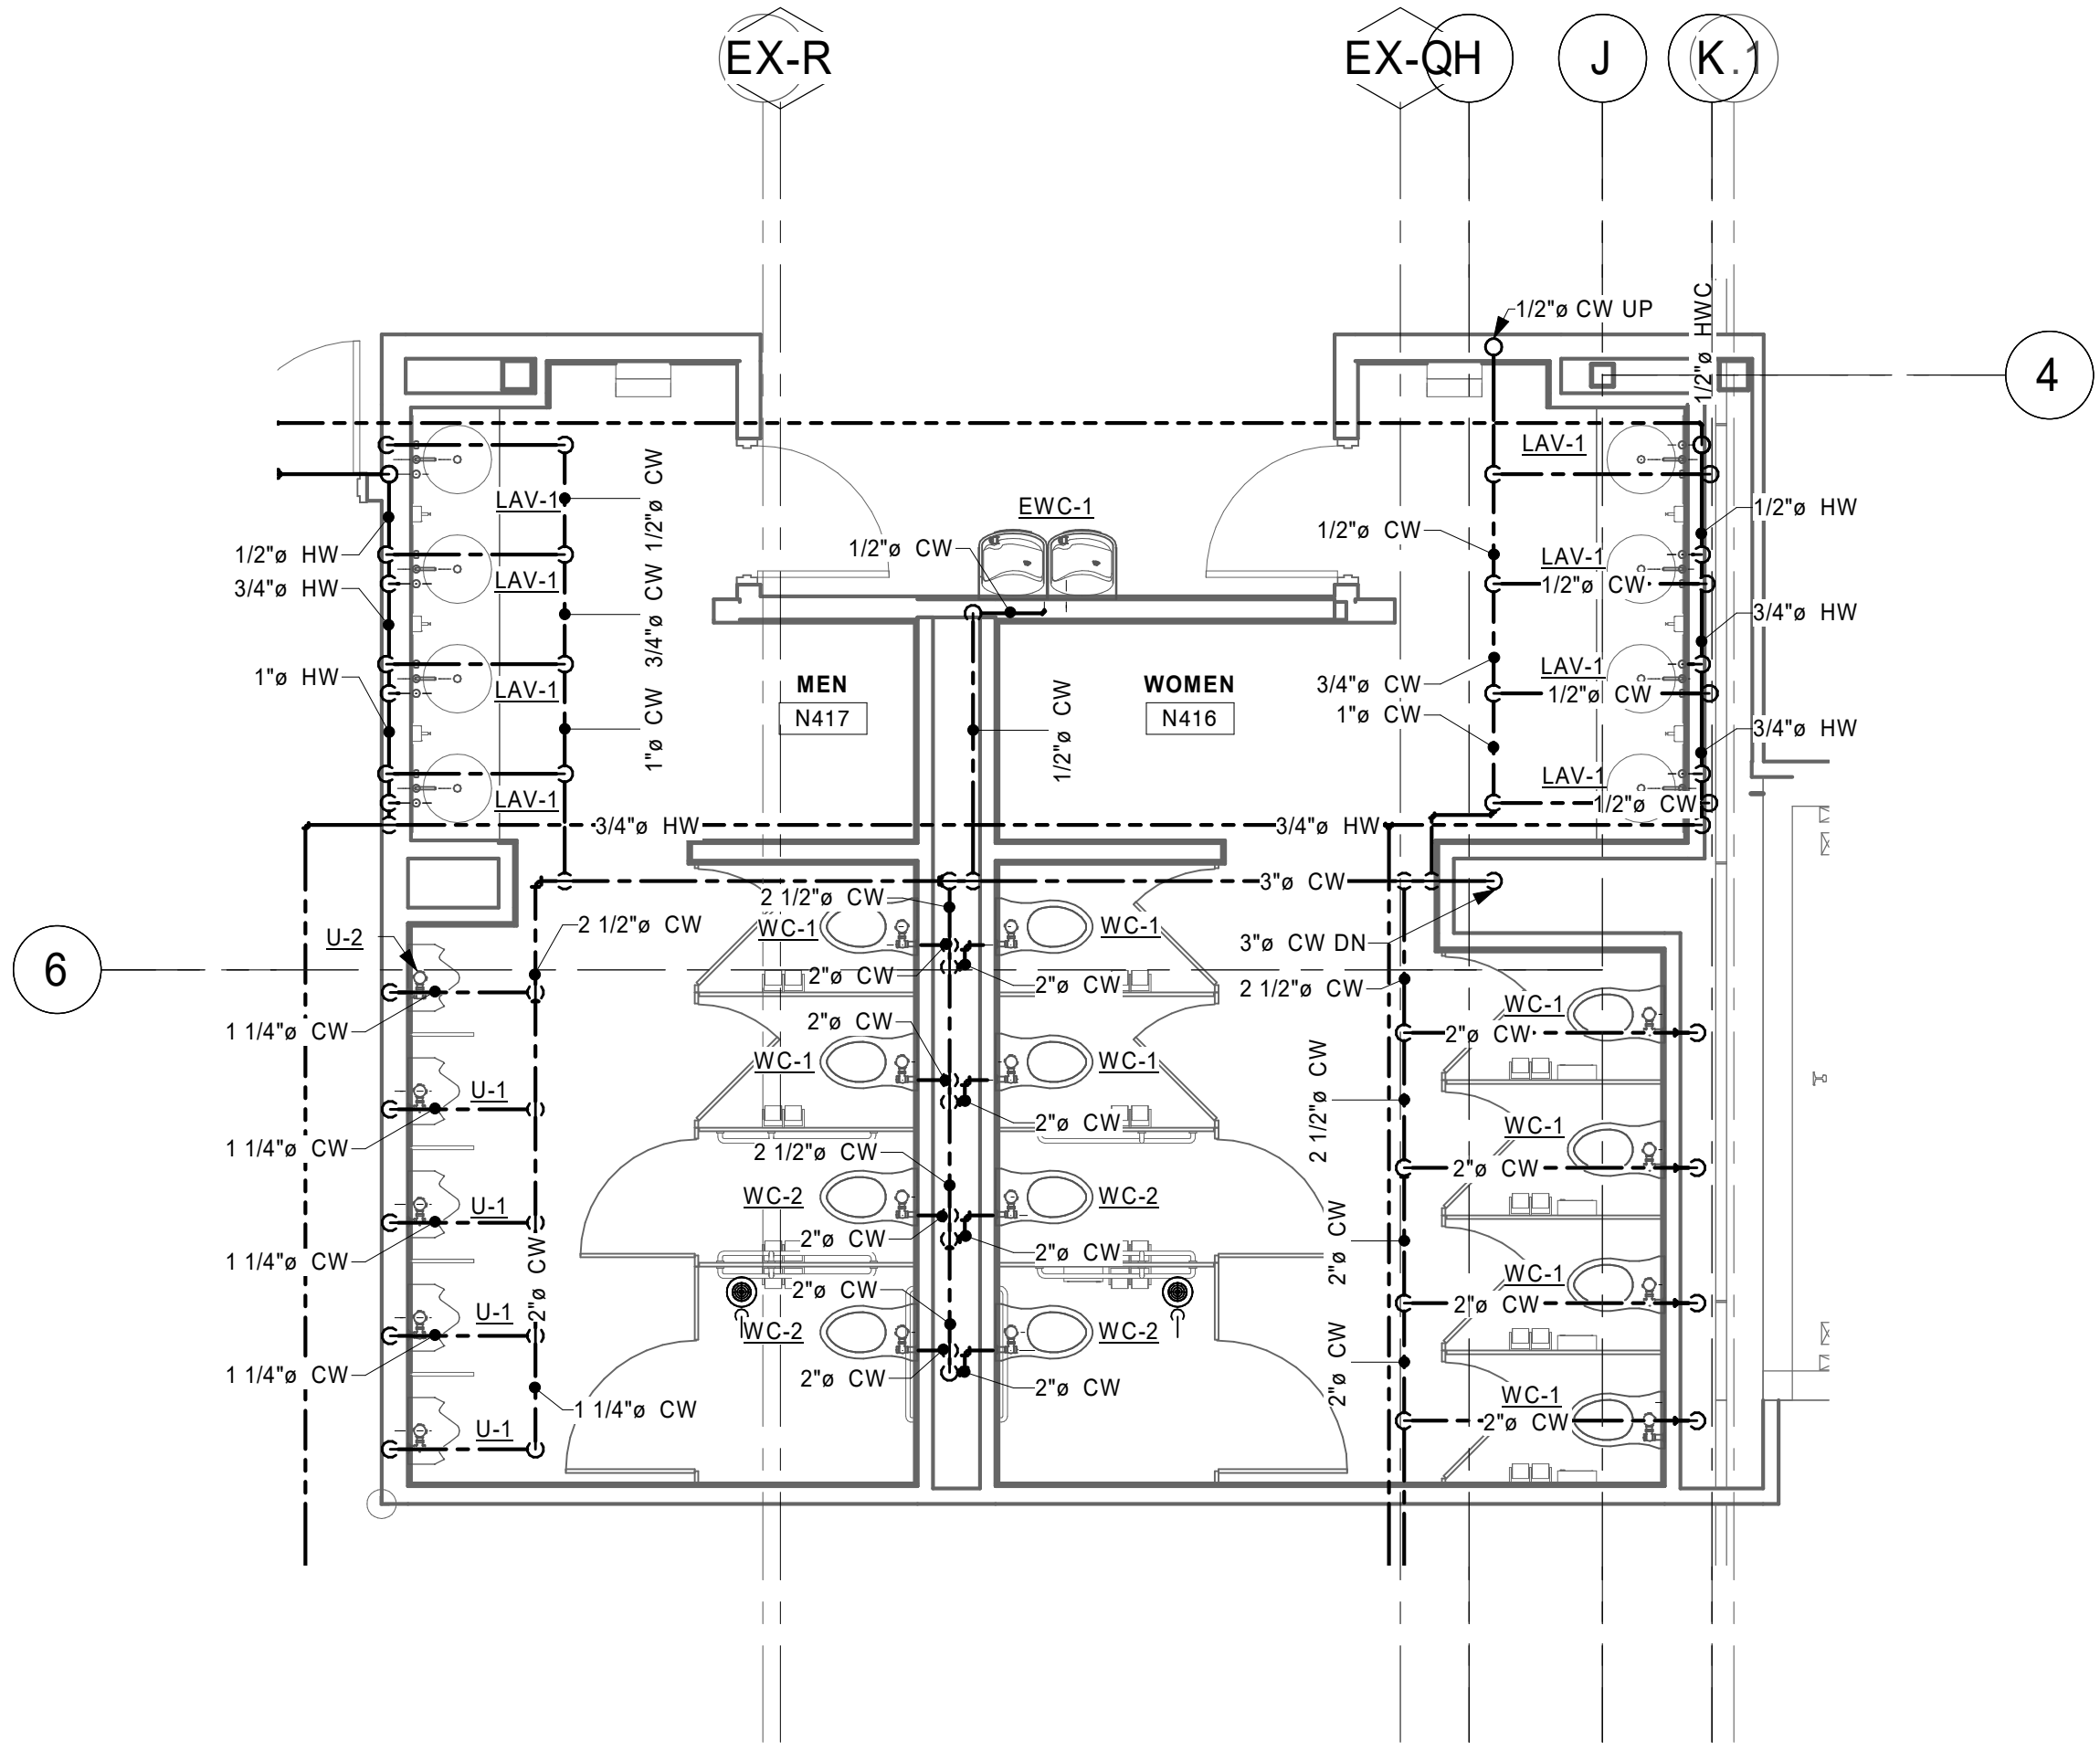

2 NEW BALLROOM LEVEL DW - AREA A RESTROOMS
1/4" = 1'-0"

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PROJECT

LA CROSSE CENTER EXPANSION & RENOVATION

LA CROSSE WISCONSIN

REVISION SCHEDULE		
DATE	DESCRIPTION	BY
2020/02/20	ADDENDUM #02	DJS
2020/03/30	PR #10	JMH
2020/08/18	PR #21	JMH

PROJECT NO.	16-19990
FILE NAME	19990 Arch R18.rvt
DRAWN BY	JMH
DESIGNED BY	RKD
REVIEWED BY	SMS
ORIGINAL ISSUE DATE	02/06/20



CLIENT PROJECT NO.

TITLE

PLUMBING CALLOUTS, SECTIONS, AND ELEVATIONS

SHEET

3P4-12

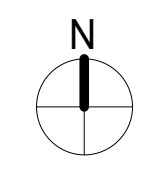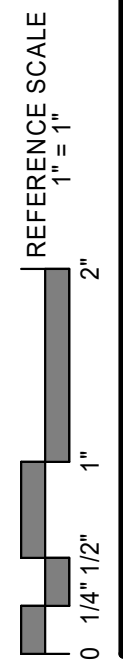


ELECTRICAL KEYNOTE LEGEND	
KEY	KEYNOTE TEXT
80	HOOD FIRE PROTECTION SYSTEM. CONNECT TO NEW FIRE ALARM SYSTEM.

- ### FOODSERVICE SHEET NOTES
- ALL FOODSERVICE EQUIPMENT SHALL BE PROVIDED AND INSTALLED, UNLESS OTHERWISE NOTED, BY THE FOOD SERVICE EQUIPMENT CONTRACTOR. ALL ELECTRICAL ROUGHINS AND FINAL CONNECTIONS SHALL BE PROVIDED BY ELECTRICAL CONTRACTOR.
 - ELECTRICAL CONTRACTOR IS RESPONSIBLE FOR DISCONNECTION AND RECONNECTION ON ALL RELOCATED EXISTING EQUIPMENT. SCHEDULED BY FSEC AFTER OPERATIONAL VERIFICATION.
 - GAS SHUT-OFF VALVE SHALL BE PROVIDED BY TRADE FOR INSTALLATION BY PLUMBING CONTRACTOR. ELECTRICAL CONTRACTOR TO INTER CONNECTION FIRE PROTECTION SYSTEM FROM WALL MOUNTED GAS VALVE RESET STATION TO ELECTRIC GAS VALVE SOLENOID LOCATED ABOVE FINISHED CEILING. FOR FUEL SHUT DOWN TO COOKING EQUIPMENT LOCATED BELOW HOOD, SO THAT UPON ACTIVATION OF THE FIRE SYSTEM, FUEL WILL SHUT OFF.
 - FSEC SHALL PROVIDE ALL RECEPTACLES IN FABRICATED EQUIPMENT AND WILL PRE-WIRE ELECTRICAL COMPONENTS IN COUNTER TO LOAD CENTER PANEL. FINAL CONNECTION BY ELECTRICAL CONTRACTOR, UNLESS OTHERWISE NOTED.
 - ELECTRICAL CONTRACTOR SHALL INTERWIRE FIRE PROTECTION SYSTEM WITH BUILDING ALARM SYSTEM. TO POWER SHUT-OFF DEVICES SUPPLIED BY FIRE PROTECTION SYSTEM INSTALLER, SO THAT ALL ELECTRICAL EQUIPMENT BELOW HOOD WILL BE SHUT OFF UPON ACTIVATION OF THE FIRE FIRE PROTECTION SYSTEM.
 - A CHEMICAL FIRE SYSTEM PROVIDED BY FSEC. SOLENOID/SHUT OFF VALVE SHALL BE INTERWIRED BY ELECTRICAL. PROVIDE 1/2" EMPTY CONDUIT TO WALL MOUNTED OCTAGONAL JUNCTION BOX FOR REMOTE PULL STATION.
 - ELECTRICAL CONTRACTOR SHALL INTERWIRE DISPOSER, CONTROLS AND SOLENOID VALVE PROVIDED BY FSEC PER MANUFACTURERS SPECIFICATIONS.
 - ELECTRICAL CONTRACTOR SHALL INTERWIRE WALK-IN COOLER/FREEZER LIGHTS, SWITCHES AND HEAT TAPE IN FREEZER FOR EVAPORATOR DRAINLINE. FSEC SHALL PROVIDE HEAT TAPE.
 - ELECTRICAL CONTRACTOR SHALL PROVIDE WIRE HOOD FAN AND LIGHT TO WALL SWITCHES.
 - ELECTRICAL CONTRACTOR SHALL PROVIDE COMPUTER GRADE SEPARATE DEDICATED CIRCUIT FOR OWNERS POS TERMINAL.
 - ELECTRICAL CONTRACTOR SHALL PROVIDE EMPTY JUNCTION BOX AND UNDER FLOOR CONDUIT AS NECESSARY BETWEEN POS TERMINAL LOCATION AND ADMINISTRATOR'S OFFICE.
 - VERIFY ALL PLUG CONFIGURATIONS WITH MANUFACTURERS SHOP DRAWINGS.
 - ALL 120 VOLT DUPLEX RECEPTACLES SHALL BE A MINIMUM OF 20 AMP RATED, UNLESS OTHERWISE NOTED. MOUNT ALL DUPLEX RECEPTACLES HORIZONTALLY IN WALL, UNLESS OTHERWISE NOTED.
 - ALL EXPOSED CONDUIT SHALL BE SEAL TIGHT OR EPOXY COATED FOR CLEANING. MG IS NOT ACCEPTED.
 - ALL SINGLE-PHASE RECEPTACLES RATED 150 VOLTS TO GROUND OR LESS, 50 AMPERES OR LESS AND THREE PHASE RECEPTACLES RATED 150 VOLTS TO GROUND OR LESS, 100 AMPERES OR LESS INSTALLED IN KITCHENS/CONCESSIONS SHALL HAVE GROUND-FAULT CIRCUIT-INTERRUPTER PROTECTION FOR PERSONNEL.
 - ELECTRICAL CONTRACTOR SHALL OBTAIN AN UPDATED SET OF PLANS FROM FOOD SERVICE VENDOR. ALL WORK SHALL BE COORDINATED WITH FOOD SERVICE EQUIPMENT SUPPLIER.




KITCHEN EQUIPMENT SCHEDULE - BALLROOM LEVEL

ITEM#	DESCRIPTION	POWER REQUIREMENTS				LOCATION	PNL - CKT	MINIMUM CONDUIT, WIRE # - SIZE, GND	STARTER		DISCONNECT		NOTES
		HP	VOLTS	POLES	AMPS				VA	TYPE	BY	TYPE	
E1.1	WALK-IN FREEZER	120 V	1	20.0 A	1840 VA	KITCHEN N423	K2 - 3	3/4" C, 2- 12s, 12GND	(none)	(none)	NF	EC	SEE FOOD SERVICE SHEET NOTE 8
E1.2	WALK-IN FREEZER	120 V	1	20.0 A	1840 VA	KITCHEN N423	K2 - 4	3/4" C, 2- 12s, 12GND	(none)	(none)	NF	EC	SEE FOOD SERVICE SHEET NOTE 8
E2	ROOF TOP REFRIGERATION UNIT	208 V	3	30.0 A	8640 VA		K2 - 17,19,21	3/4" C, 3- 10s, 10GND	(none)	(none)	NF	EC	
E3	WALK-IN COOLER COIL	120 V	1	2.0 A	240 VA		K2 - 1	3/4" C, 2- 12s, 12GND	(none)	(none)	NF	EC	SEE FOOD SERVICE SHEET NOTE 8
E4	WALK-IN FREEZER COIL	208 V	2	8.9 A	1851 VA	KITCHEN N423	K2 - 10, 12	3/4" C, 2- 12s, 12GND	(none)	(none)	NF	EC	SEE FOOD SERVICE SHEET NOTE 8
E11	ICE MACHINE	120 V	1	1.1 A	180 VA	KITCHEN N423	K1 - 5	3/4" C, 2- 12s, 12GND	(none)	(none)	(none)	(none)	EC TO PROVIDE AND INSTALL CORD
E12	ICE MACHINE CLEANER	120 V	1	0.1 A	180 VA	KITCHEN N423	K1 - 5	3/4" C, 2- 12s, 12GND	(none)	(none)	(none)	(none)	
E13	ICE MACHINE CONDENSER	208 V	3	2.0 A	720 VA		K2 - 11,13,15	3/4" C, 3- 12s, 12GND	(none)	(none)	NF	EC	
E18	HAND SINK FAUCET	120 V	1	0.1 A	180 VA	KITCHEN N423	K1 - 2	3/4" C, 2- 12s, 12GND	(none)	(none)	(none)	(none)	
E24	DISPOSER	208 V	3	6.6 A	2378 VA	KITCHEN N423	K1 - 32,34,36	3/4" C, 3- 12s, 12GND	(none)	(none)	NF	EC	SEE FOOD SERVICE SHEET NOTE 7
E29	COOKING EXHAUST HOOD	120 V	1	0.0 A	0 VA	KITCHEN N423	K1 - 8	0-	(none)	(none)	(none)	(none)	SERVICED THRU HOOD CONTROL PANEL SEE FOOD SERVICE SHEET NOTE 5 & 9
E29A	HOOD DUCT SENSOR	0 V	1	0.0 A	0 VA	KITCHEN N423		0-	(none)	(none)	(none)	(none)	
E31	HOOD CONTROL - TOUCH SCREEN	0 V	1	0.0 A	0 VA	KITCHEN N423		0-	(none)	(none)	(none)	(none)	2-GANG J-BOX & 3/4" CONDUIT ABOVE CEILING
E32	HOOD FIRE SYSTEM	120 V	1	15.0 A	1440 VA	KITCHEN N423	K1 - 24	3/4" C, 2- 12s, 12GND	(none)	(none)	(none)	(none)	
E32A	FIRE SUPPRESSION SYSTEM - DRY CONTACTOR	0 V	1	0.0 A	0 VA	KITCHEN N423		0-	(none)	(none)	(none)	(none)	DRY CONTACTOR TO SHUNT TRIP BREAKER BY EC SEE FOOD SERVICE SHEET NOTE 5
E32B	FIRE SUPPRESSION SYSTEM - GAS VALVE	120 V	1	0.0 A	0 VA	KITCHEN N423		0-	(none)	(none)	(none)	(none)	TO GAS SHUT OFF VALVE SEE FOOD SERVICE SHEET NOTE 6
E32C	FIRE SUPPRESSION SYSTEM - BUILDING ALARM	0 V	1	0.0 A	0 VA	KITCHEN N423		0-	(none)	(none)	(none)	(none)	BUILDING ALARM TO DRY CONTACTOR IN FIRE PANEL, BY EC SEE FOOD SERVICE SHEET NOTE 5
E32D	FIRE SUPPRESSION SYSTEM - REMOTE MANUAL PULL	0 V	1	0.0 A	0 VA	KITCHEN N423		0-	(none)	(none)	(none)	(none)	REMOTE MANUAL PULL STATION, SEE FOOD SERVICE SHEET NOTE 6
E32E	FIRE SUPPRESSION SYSTEM - GAS RESET STATION	0 V	1	0.0 A	0 VA	KITCHEN N423		0-	(none)	(none)	(none)	(none)	GAS RESET STATION PROVIDED BY FSEC
E32F	FIRE SUPPRESSION SYSTEM - FIRE MICROSWITCH	0 V	1	0.0 A	0 VA	KITCHEN N423		0-	(none)	(none)	(none)	(none)	FROM E33 CONTROL PANEL, FOR FIRE SYSTEM MICROSWITCH
E33	HOOD CONTROL BOX	120 V	1	15.0 A	1440 VA	KITCHEN N423	K1 - 8	3/4" C, 2- 12s, 12GND	(none)	(none)	(none)	(none)	
E34	ROOM TEMP SENSOR	0 V	1	0.0 A	0 VA	KITCHEN N423		0-	(none)	(none)	(none)	(none)	2-GANG J-BOX & 3/4" CONDUIT ABOVE CEILING
E41	THREE FRYER BATTERY	120 V	1	6.0 A	720 VA	KITCHEN N423	K1 - 15	3/4" C, 2- 12s, 12GND	(none)	(none)	(none)	(none)	SEE FOOD SERVICE SHEET NOTE 5
E42	FRENCH FRY WARMER	208 V	2	20.6 A	4285 VA	KITCHEN N423	K1 - 16, 18	3/4" C, 2- 10s, 10GND	(none)	(none)	(none)	(none)	SEE FOOD SERVICE SHEET NOTE 5
E43	FREZZER WORKTOP	120 V	1	8.1 A	972 VA	KITCHEN N423	K1 - 19	3/4" C, 2- 12s, 12GND	(none)	(none)	(none)	(none)	SEE FOOD SERVICE SHEET NOTE 5
E44	36" RANGE	120 V	1	4.0 A	480 VA	KITCHEN N423	K1 - 23	3/4" C, 2- 12s, 12GND	(none)	(none)	(none)	(none)	SEE FOOD SERVICE SHEET NOTE 5
E46	DOUBLE STACK COMBI OVEN	208 V	2	3.7 A	770 VA	KITCHEN N423	K1 - 26,28	3/4" C, 2- 12s, 12GND	(none)	(none)	(none)	(none)	SEE FOOD SERVICE SHEET NOTE 5
E46A	DOUBLE STACK COMBI OVEN	208 V	2	3.7 A	770 VA	KITCHEN N423	K1 - 27,29	3/4" C, 2- 12s, 12GND	(none)	(none)	(none)	(none)	SEE FOOD SERVICE SHEET NOTE 5
E49A	DECORATIVE HEAT LAMPS	120 V	1	15.6 A	1875 VA	KITCHEN N423	K1 - 13	3/4" C, 2- 12s, 12GND	(none)	(none)	(none)	(none)	EC TO MOUNT (5) HEAT LAMPS PER TRACK AND CONNECT WITH REMOTE WALL SWITCH. VERIFY LOCATION OF WALL SWITCH WITH FSEC.
E49B	DECORATIVE HEAT LAMPS	120 V	1	15.6 A	1875 VA	KITCHEN N423	K1 - 9	3/4" C, 2- 12s, 12GND	(none)	(none)	(none)	(none)	EC TO MOUNT (5) HEAT LAMPS PER TRACK AND CONNECT WITH REMOTE WALL SWITCH. VERIFY LOCATION OF WALL SWITCH WITH FSEC.
E52A	HOLDING & TRANSPORT CABINET	120 V	1	12.0 A	1400 VA	KITCHEN N423	K1 - 3	3/4" C, 2- 12s, 12GND	(none)	(none)	(none)	(none)	
E52B	HOLDING & TRANSPORT CABINET	120 V	1	12.0 A	1400 VA	KITCHEN N423	K1 - 12	3/4" C, 2- 12s, 12GND	(none)	(none)	(none)	(none)	
E52C	HOLDING & TRANSPORT CABINET	120 V	1	12.0 A	1400 VA	KITCHEN N423	K1 - 1	3/4" C, 2- 12s, 12GND	(none)	(none)	(none)	(none)	
E52D	HOLDING & TRANSPORT CABINET	120 V	1	12.0 A	1400 VA	KITCHEN N423	K1 - 4	3/4" C, 2- 12s, 12GND	(none)	(none)	(none)	(none)	
E54	TWO SECTION ROLL THRU REFRIGERATOR	120 V	1	13.4 A	1608 VA	KITCHEN N423	K1 - 6	3/4" C, 2- 12s, 12GND	(none)	(none)	(none)	(none)	
E55	ONE SECTION ROLL THRU REFRIGERATOR	120 V	1	11.6 A	1392 VA	KITCHEN N423	K1 - 7	3/4" C, 2- 12s, 12GND	(none)	(none)	(none)	(none)	
E62	POT & PAN SCRAP MASTER	208 V	3	12.7 A	4575 VA	KITCHEN N423	K2 - 14, 16, 18	3/4" C, 3- 12s, 12GND	(none)	(none)	NF	EC	
E64	WALK-IN COOLER - REFRIGERATION SYSTEM	120 V	1	14.3 A	1716 VA	LIQUOR STORAGE N425	K2 - 2	3/4" C, 2- 12s, 12GND	(none)	(none)	NF	EC	SEE FOOD SERVICE SHEET NOTE 8
E64A	WALK-IN COOLER - REFRIGERATION SYSTEM	120 V	1	14.3 A	1716 VA	LIQUOR STORAGE N425	K2 - 9	3/4" C, 2- 12s, 12GND	(none)	(none)	NF	EC	SEE FOOD SERVICE SHEET NOTE 8
E67	DISHMACHINE W/BOOSTER HEATER	208 V	3	113.0 A	40710 VA	KITCHEN N423	H-LINE L5 - 12,14,16	1 1/2" C, 3- 10s, 6GND	(none)	(none)	NF	EC	VERIFY UNIT REQUIREMENTS WITH VENDOR PRIOR TO INSTALL
E67A	RACK CONVEYOR DISHWASHER - VENT FAN	0 V	1	0.0 A	0 VA	KITCHEN N423		0-	(none)	(none)	(none)	(none)	CONTROL WIRING BY EC TO VENT FAN
E67B	RACK CONVEYOR DISHWASHER - LIMIT SWITCH	0 V	1	0.0 A	0 VA	KITCHEN N423		0-	(none)	(none)	(none)	(none)	CONTROL WIRING BY EC TO CLEAN DISHTABLE LIMIT SWITCH
E67C	RACK CONVEYOR DISHWASHER - LIMIT SWITCH J-BOX	0 V	1	0.0 A	0 VA	KITCHEN N423		0-	(none)	(none)	(none)	(none)	J-BOX FOR CLEAN DISHTABLE LIMIT SWITCH BY EC TO E67C
E78A	COFFEE MAKER	208 V	2	28.0 A	5825 VA	SERVICE HALL N419	K2 - 6,8	3/4" C, 3- 8s, 10GND	(none)	(none)	NF	EC	
E78B	COFFEE MAKER	208 V	2	28.0 A	5825 VA	SERVICE HALL N419	K2 - 5,7	3/4" C, 3- 8s, 10GND	(none)	(none)	NF	EC	

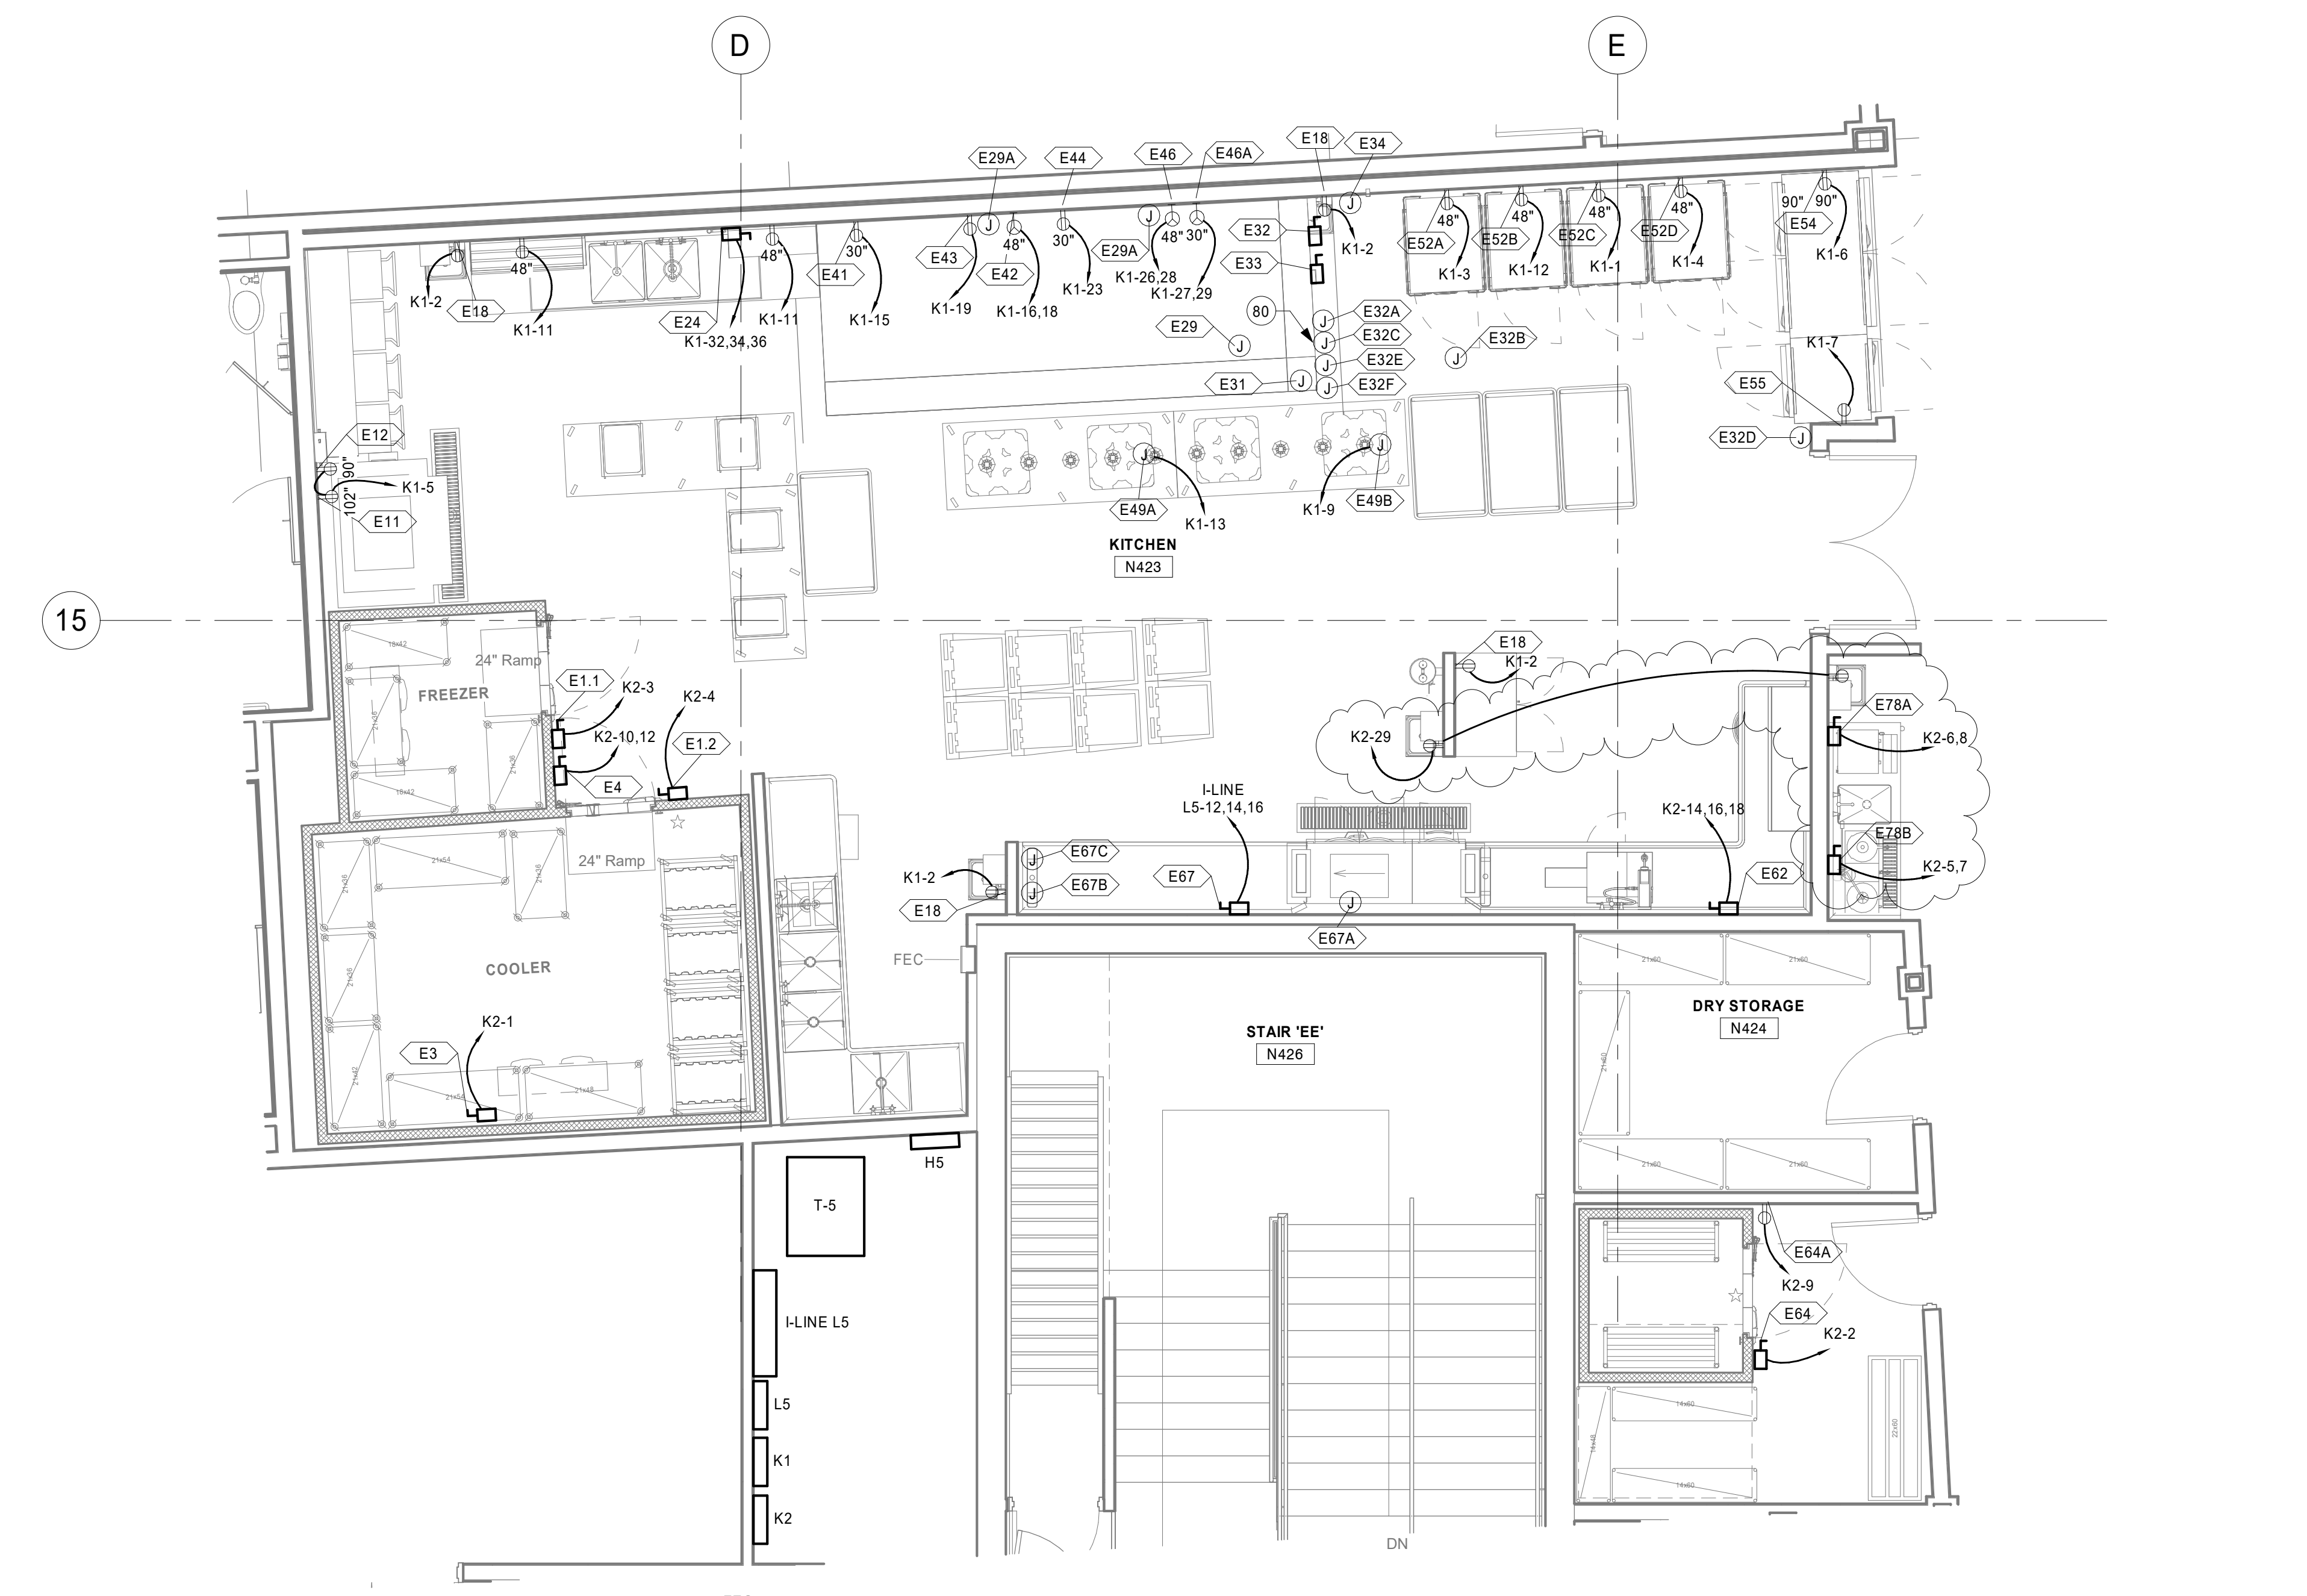

1 BALLROOM BANQUET KITCHEN POWER PLAN
1/4" = 1'-0"

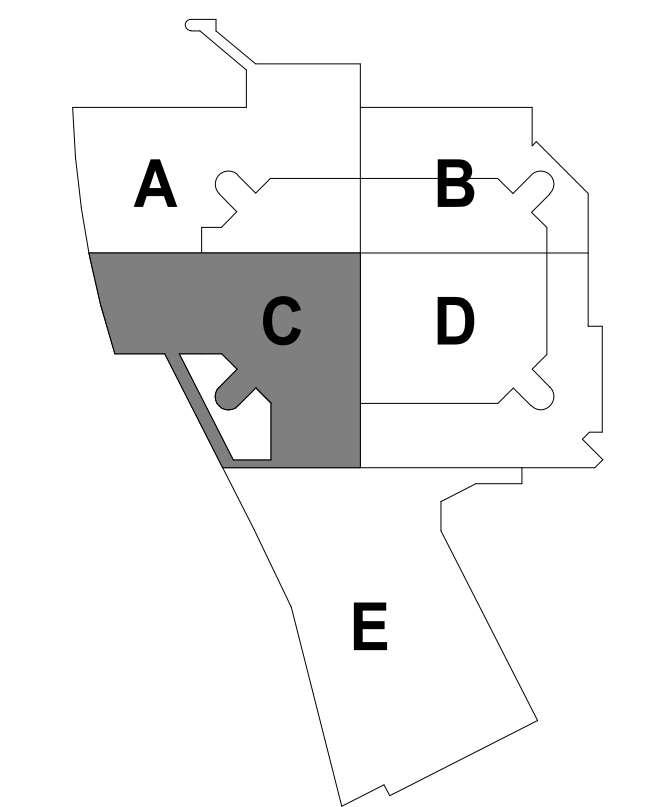

KEYPLAN

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REVISION SCHEDULE		
DATE	DESCRIPTION	BY
08/18/20	PR #21	CWR

PROJECT NO.	16-19990
FILE NAME	19990 Elec R18.rvt
DRAWN BY	CWR
DESIGNED BY	CWR
REVIEWED BY	MDN
ORIGINAL ISSUE DATE	02/06/2020
CLIENT PROJECT NO.	

TITLE

ENLARGED POWER PLANS - AREA C

SHEET
3E3-13

ELECTRICAL KEYNOTE LEGEND

Table with 2 columns: KEY and KEYNOTE TEXT. Contains notes for fire protection systems and concession doors.


FOODSERVICE SHEET NOTES

- 1. ALL FOODSERVICE EQUIPMENT SHALL BE PROVIDED AND INSTALLED...
2. ELECTRICAL CONTRACTOR IS RESPONSIBLE FOR DISCONNECTION AND RECONNECTION...
3. GAS SHUT-OFF VALVE SHALL BE PROVIDED BY TRADE FOR INSTALLATION...
4. FSEC SHALL PROVIDE ALL RECEPTACLES IN FABRICATED EQUIPMENT...
5. ELECTRICAL CONTRACTOR SHALL INTERWIRE FIRE PROTECTION SYSTEM WITH BUILDING ALARM SYSTEM...
6. A CHEMICAL FIRE SYSTEM PROVIDED BY FSEC; SOLENOID/SHUT OFF VALVE SHALL BE INTERWIRED BY ELECTRICAL...
7. ELECTRICAL CONTRACTOR SHALL INTERWIRE DISPOSER, CONTROLS AND SOLENOID VALVE PROVIDED BY FSEC PER MANUFACTURERS SPECIFICATIONS...
8. ELECTRICAL CONTRACTOR SHALL INTERWIRE WALK-IN COOLER/FREEZER LIGHTS, SWITCHES AND HEAT TAPE IN FREEZER FOR EVAPORATOR DRAINLINE...
9. ELECTRICAL CONTRACTOR SHALL PROVIDE WIRE HOOD FAN AND LIGHT TO WALL SWITCHES...
10. ELECTRICAL CONTRACTOR SHALL PROVIDE COMPUTER GRADE SEPARATE DEDICATED CIRCUIT FOR OWNERS POS TERMINAL...
11. ELECTRICAL CONTRACTOR SHALL PROVIDE EMPTY JUNCTION BOX AND UNDER FLOOR CONDUIT AS NECESSARY BETWEEN POS TERMINAL LOCATION AND ADMINISTRATOR'S OFFICE...
12. VERIFY ALL PLUG CONFIGURATIONS WITH MANUFACTURERS SHOP DRAWINGS...
13. ALL 120 VOLT DUPLEX RECEPTACLES SHALL BE A MINIMUM OF 20 AMP RATED...
14. ALL EXPOSED CONDUIT SHALL BE SEAL TIGHT OR EPOXY COATED FOR CLEANING...
15. ALL SINGLE-PHASE RECEPTACLES RATED 150 VOLTS TO GROUND OR LESS...
16. ELECTRICAL CONTRACTOR SHALL OBTAIN AN UPDATED SET OF PLANS FROM FOOD SERVICE VENDOR...




KITCHEN EQUIPMENT SCHEDULE - CONCOURSE LEVEL

Table with columns: ITEM#, DESCRIPTION, POWER REQUIREMENTS (HP, VOLTS, POLES, AMPS, VA), LOCATION, PNL - CKT, MINIMUM COUOLDIT, WIRE # - SIZE, OND, STARTER (TYPE, BY), DISCONNECT (TYPE, BY), NOTES. Lists various kitchen equipment like coolers, ovens, fryers, and their electrical specifications.

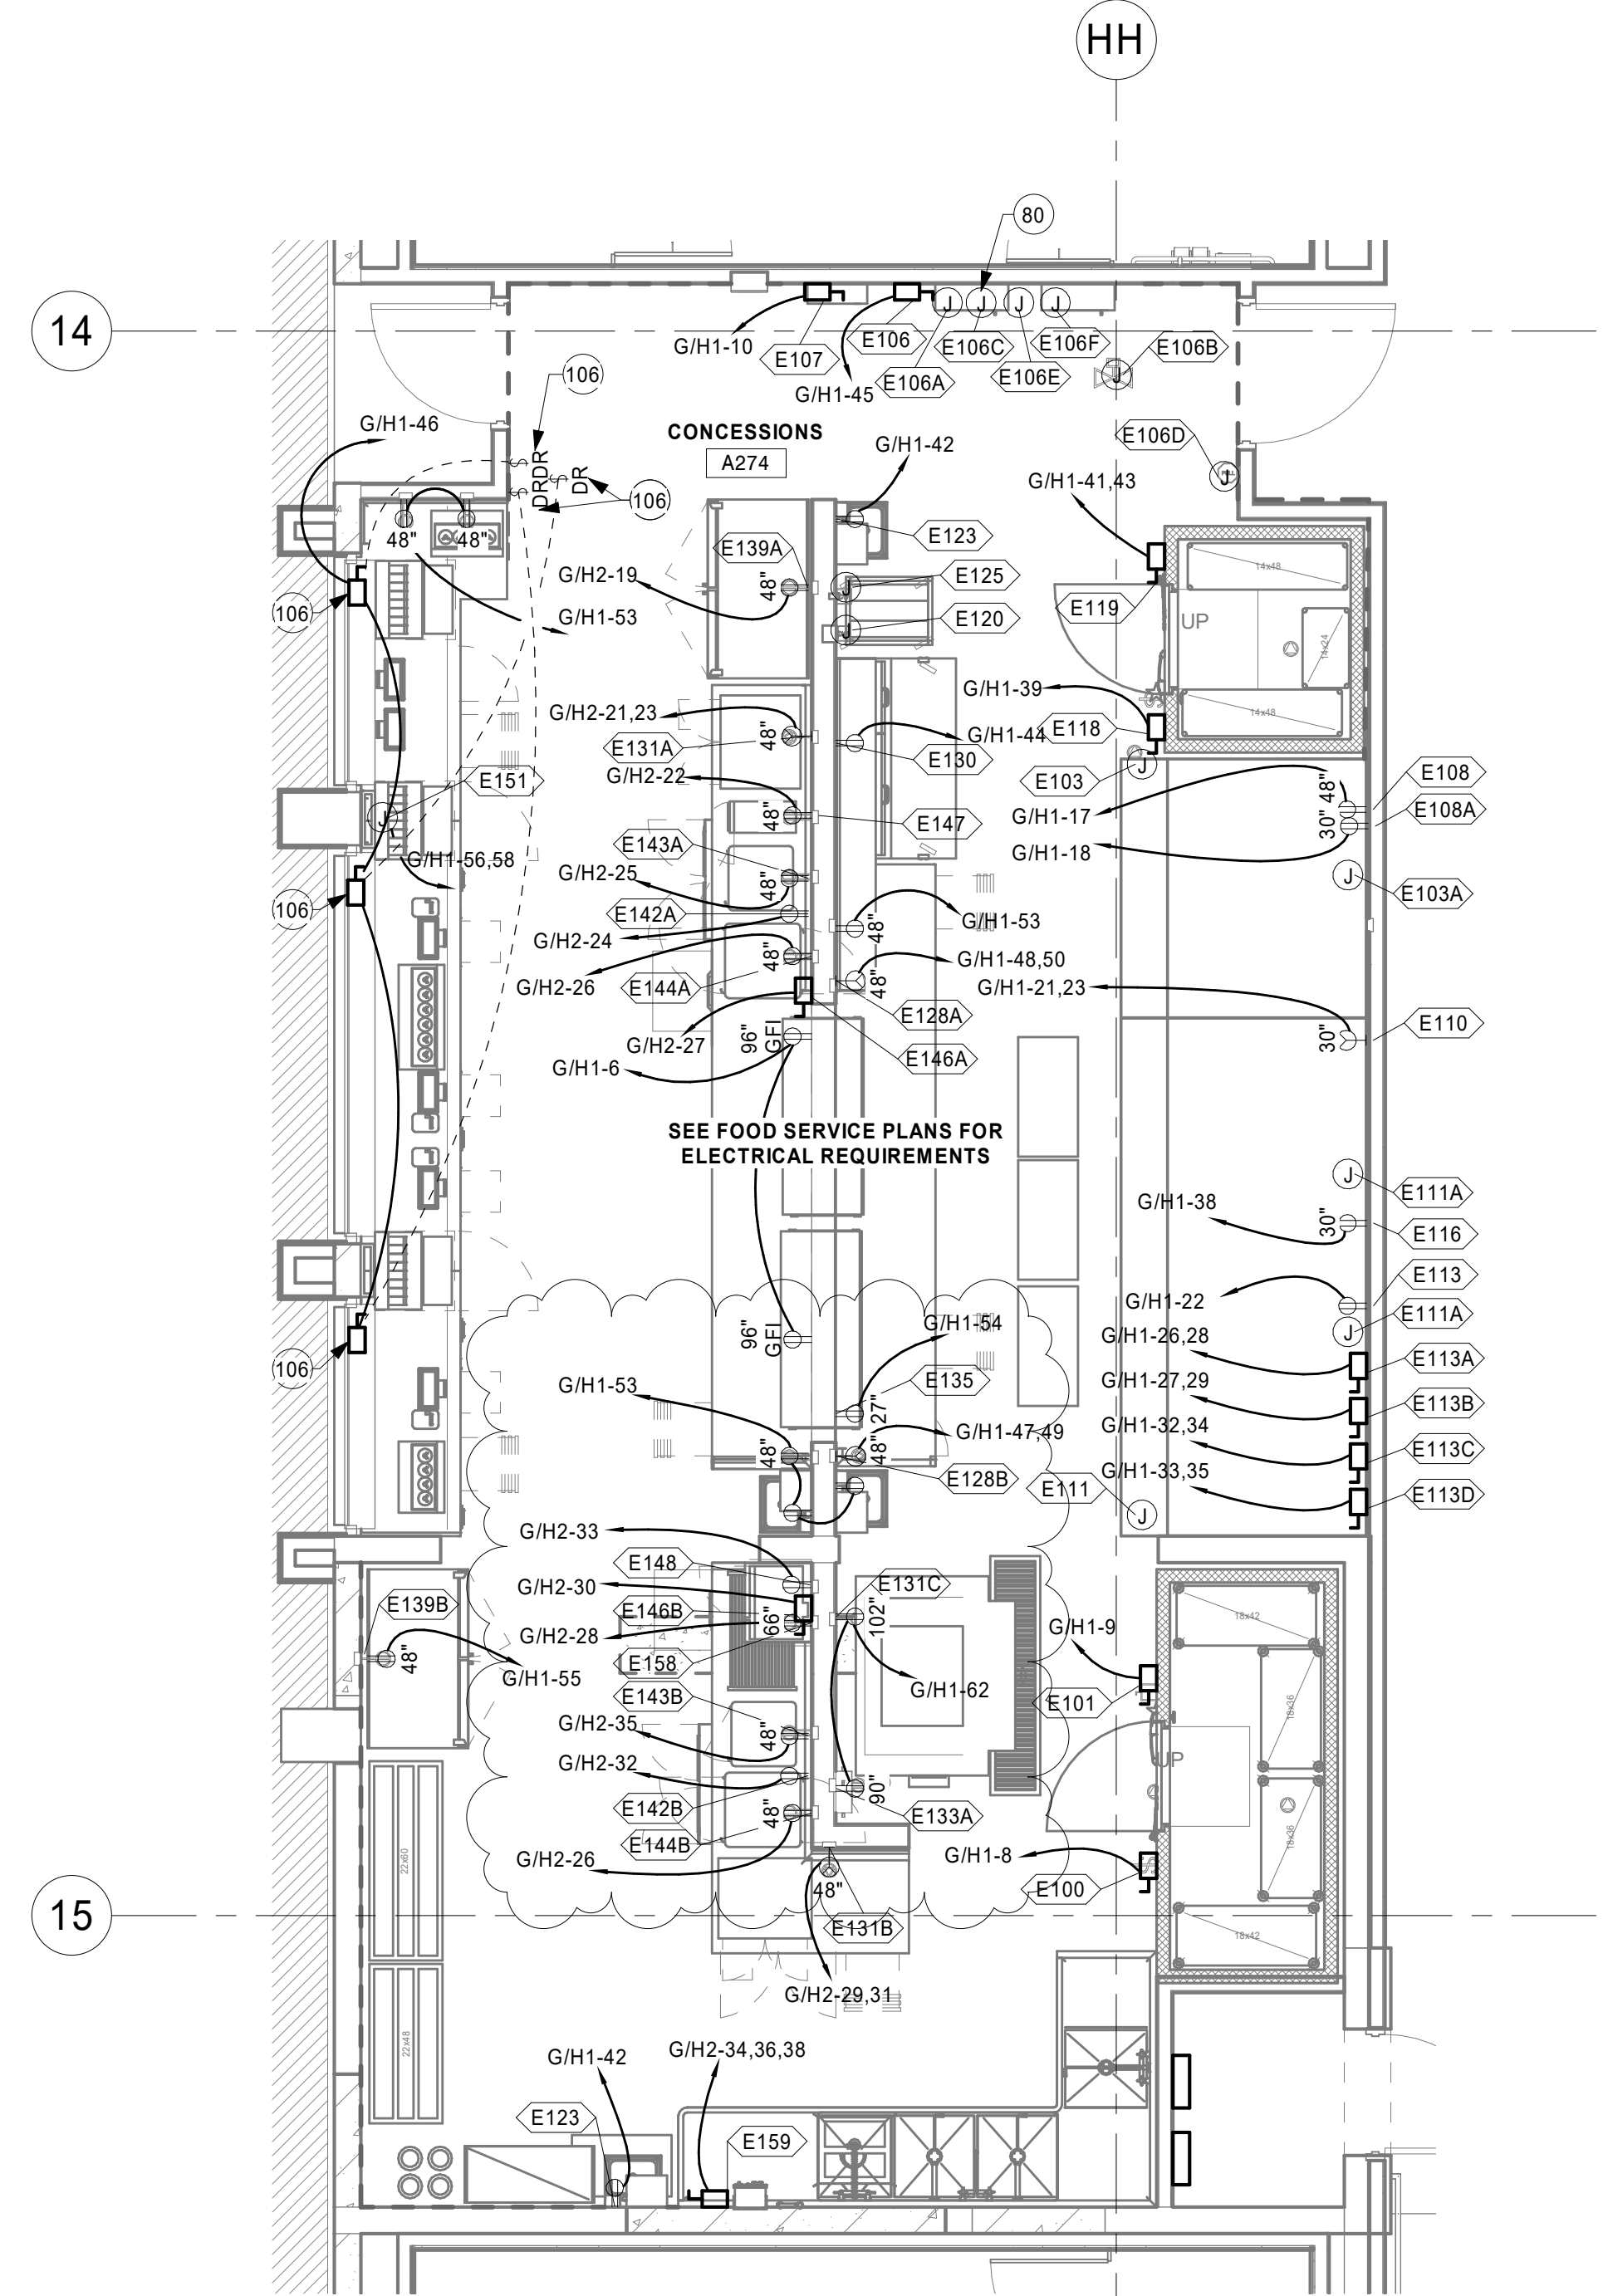

3 CONCOURSE LEVEL AREA D CONCESSIONS 1 POWER PLAN 1/4" = 1'-0"

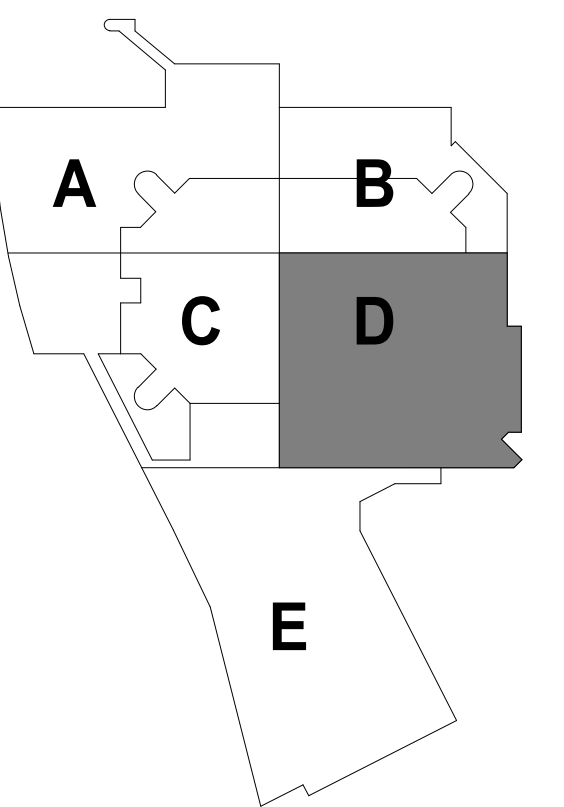

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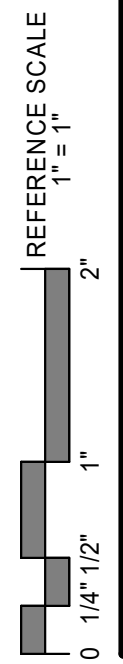
PROJECT LA CROSSE WISCONSIN
LA CROSSE CENTER EXPANSION & RENOVATION


REVISION SCHEDULE table with columns: DATE, DESCRIPTION, BY. Shows revisions 04/30/20 PR #12 and 08/18/20 PR #21.

PROJECT NO. 16-19990
FILE NAME 19990 Elec R18.rvt
DRAWN BY CWR
DESIGNED BY CWR
REVIEWED BY MDN
ORIGINAL ISSUE DATE 02/06/2020


CLIENT PROJECT NO.
TITLE

ENLARGED POWER PLANS - AREA D
SHEET 3E3-14



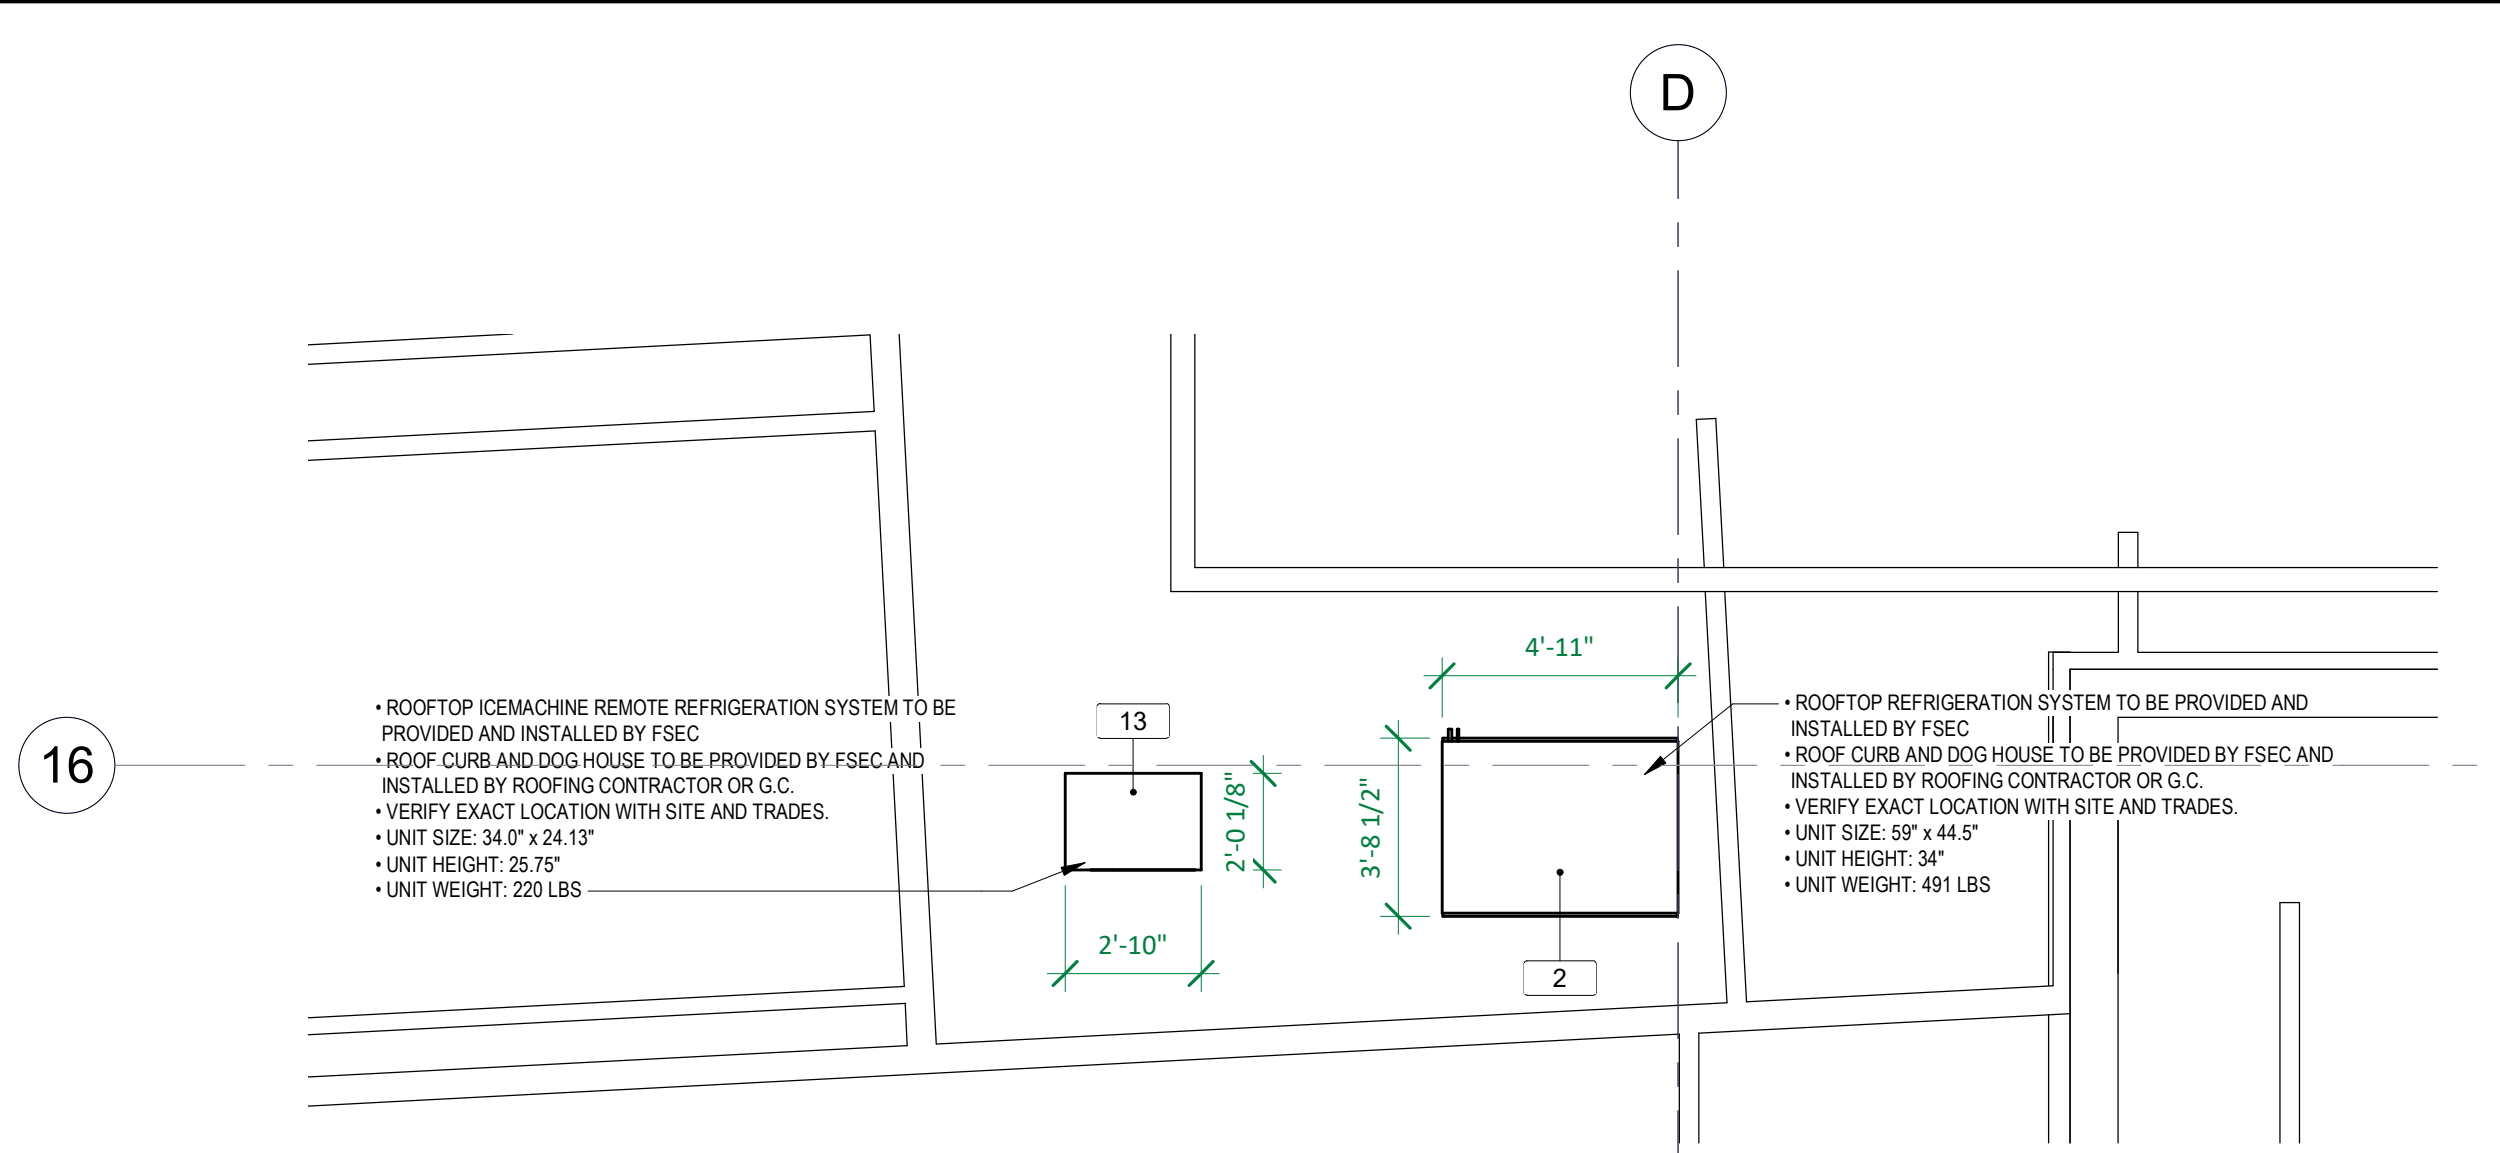

1 FOODSERVICE EQUIPMENT BALLROOM ROOF PLAN
 FS101 1/4" = 1'-0"

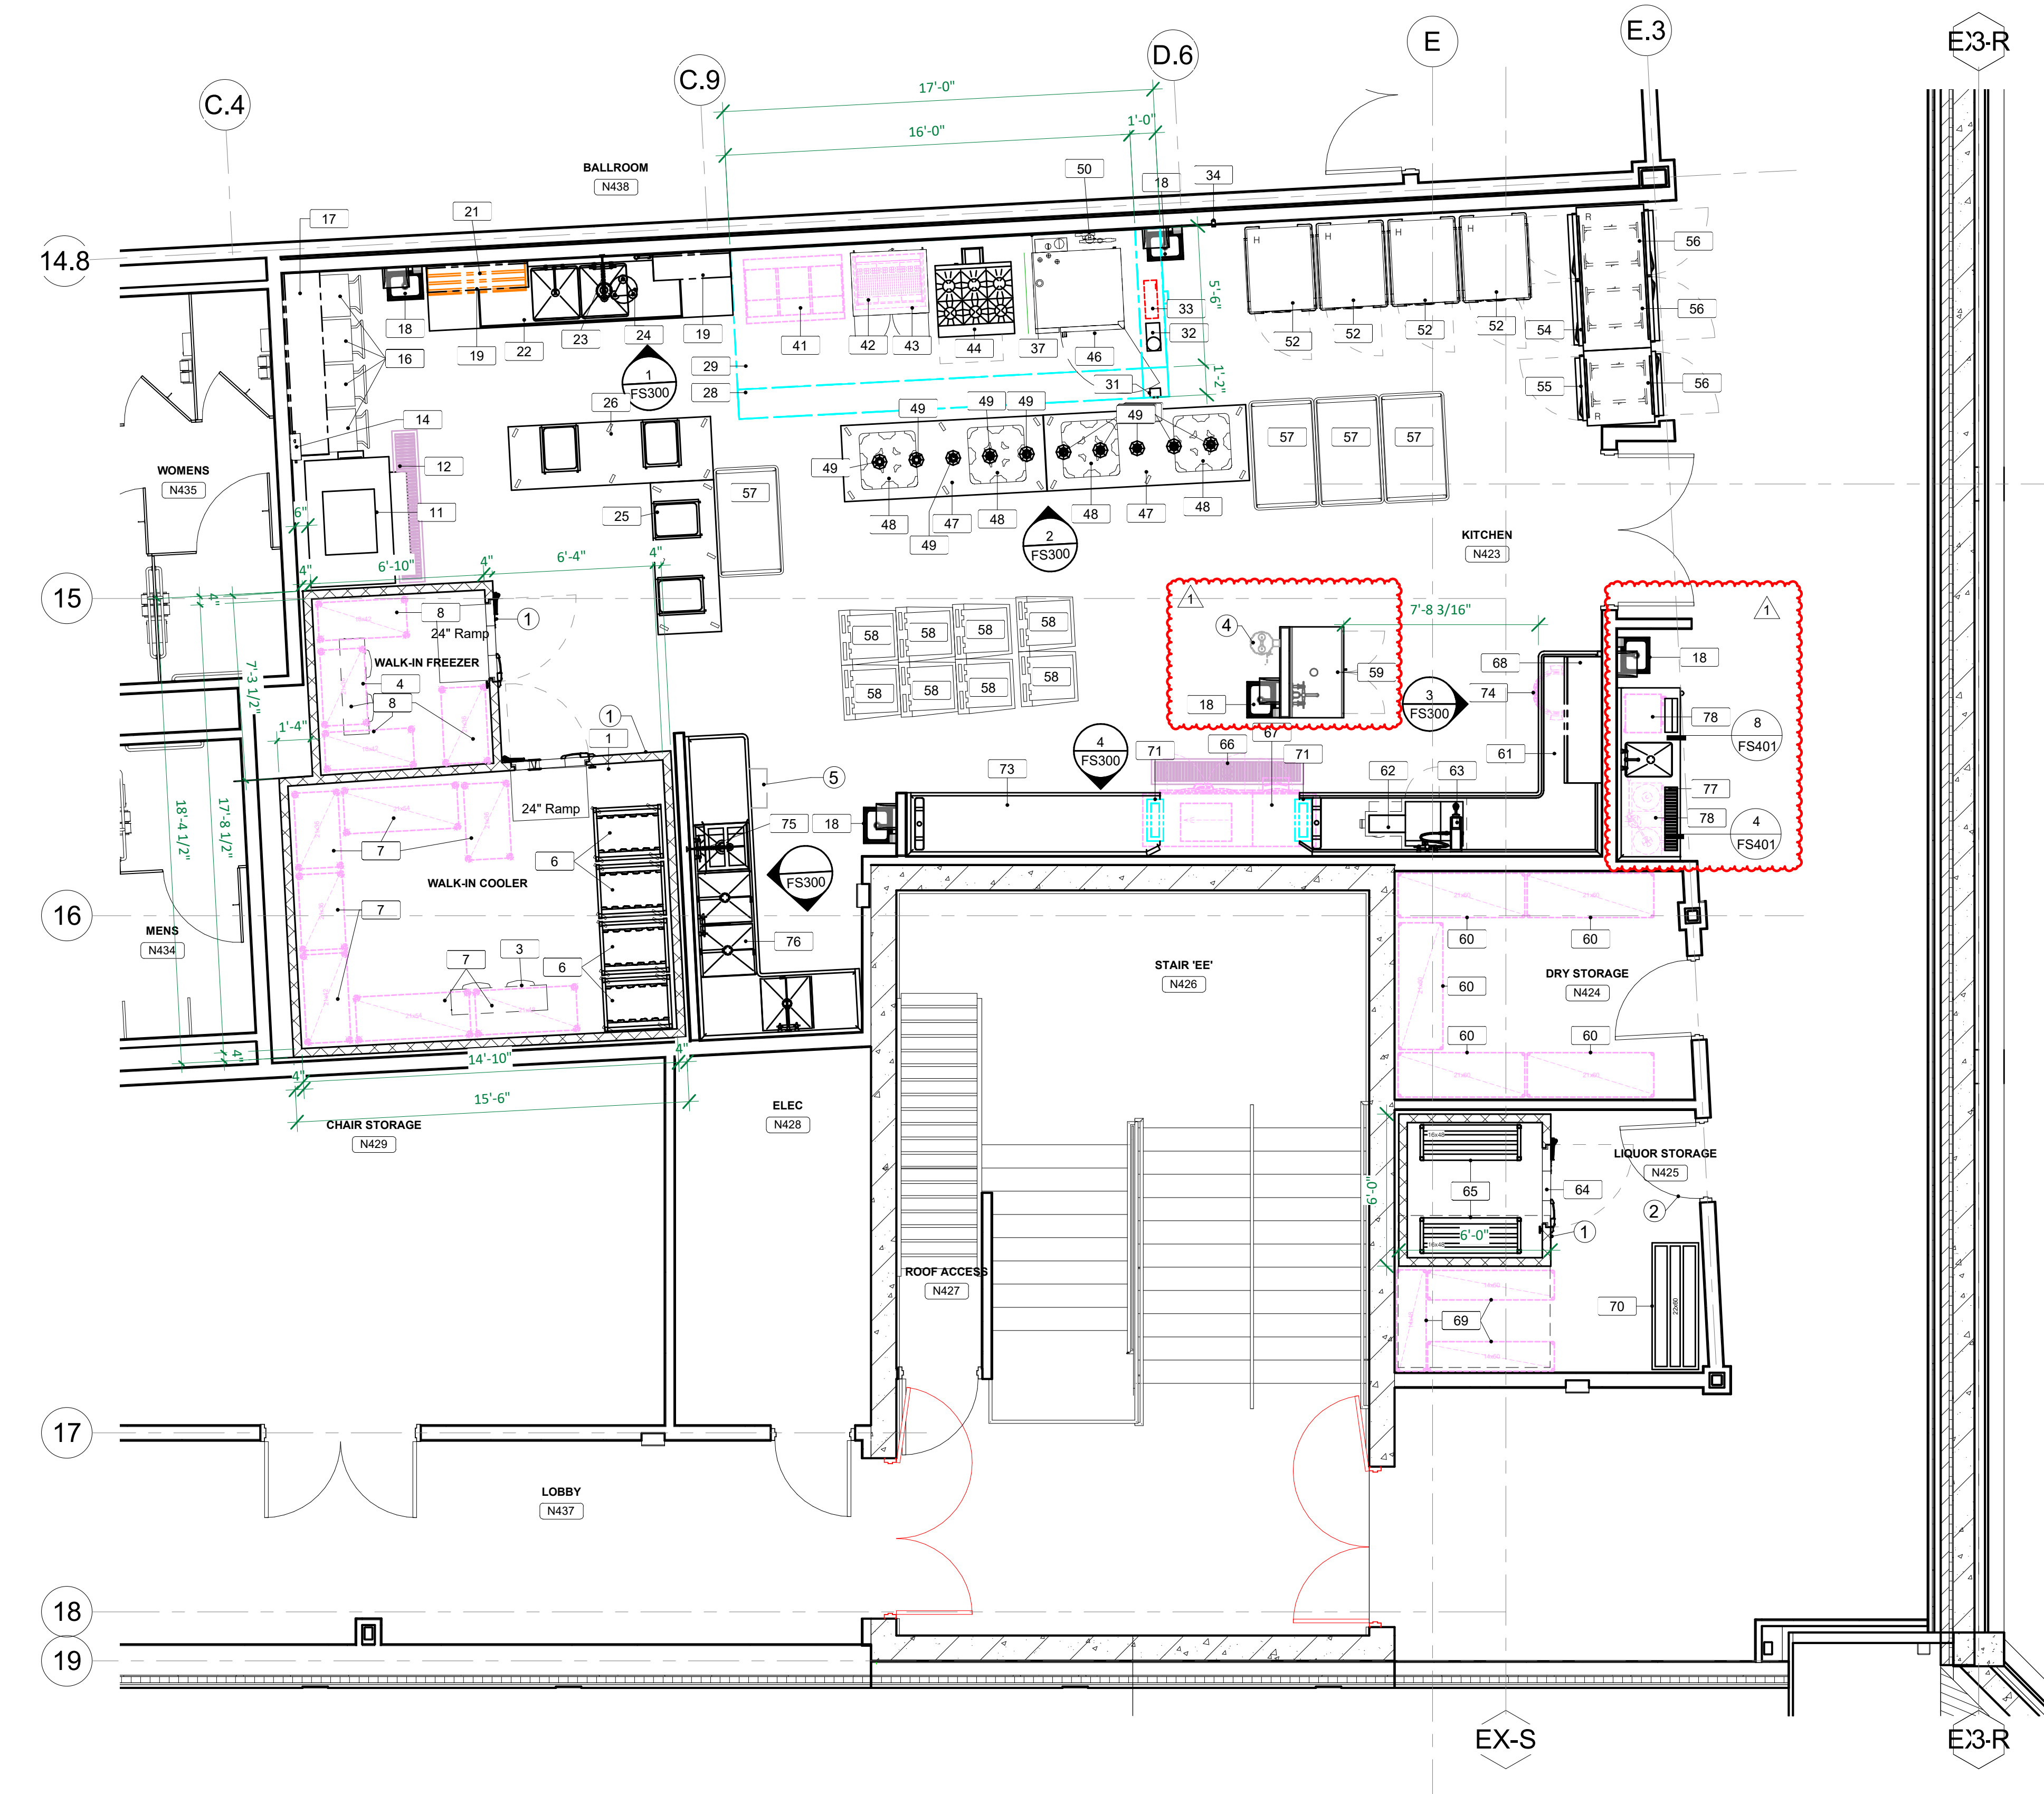

2 FOODSERVICE EQUIPMENT BALLROOM BANQUET KITCHEN PLAN
 FS101 1/4" = 1'-0"

PLAN LEGEND

- EQUIPMENT PROVIDED BY OWNER
- EQUIPMENT PROVIDED BY VENDOR
- EXISTING EQUIPMENT - RELOCATE


PLAN KEY INDEX

- ① PROVIDE 1/8" DIAMOND TREAD 42" HIGH
- ② 42" DOOR REQUIRED* (BY BUILDING CONTRACTOR)
- ③ JANITOR SINK W/ FAUCET * (BY MECHANICAL)
- ④ EYE WASH STATION* (BY MECHANICAL)
- ⑤ GREASE INTERCEPTOR* (BY MECHANICAL)
- ⑥ FIELD JOINT - SEE SPECIFICATION FOR TYPE

*SEE ARCHITECT AND OR ENGINEER PLANS FOR EXACT LOCATIONS

BALLROOM EQUIPMENT SCHEDULE

ITEM NO	QTY	DESCRIPTION	REMARKS
1	1	Walk-in Cooler / Freezer Box	
2	1	Roof Top Refrigeration Unit	
3	1	Cooler Coil	
4	1	Freezer Coil	
5	1	** Spare Number **	
6	4	Bun / Sheet Pan Rack	
7	7	Cooler Mobile Shelving	NIC; By Owner
8	4	Freezer Mobile Shelving	NIC; By Owner
9	1	** Spare Number **	
10	1	** Spare Number **	
11	1	Ice Machine w/ Bin and Transport Cart	
12	1	12' x 72" Floor Trough Grey Fiberglass Grating	
13	1	Ice Machine Remote Condenser	
14	1	Ice Machine Water Filtration System	
15	1	** Spare Number **	
16	4	Transport Utility Cart	
17	2	Wall Shelf	Stacked
18	5	Hand Sink w/ Faucet	Towel & Soap Dispenser by Owner, Installed by GC
19	2	Wall Shelf	
20	1	** Spare Number **	
21	1	Wall Mounted Pot Rack	
22	1	Vegetable Prep Table w/ Sinks	
23	1	Type 4 Prep Area Pre-Rinse	
24	1	Disposer w/ Controls & Offset Chute	
25	1	Mobile Work Table	
26	1	Mobile Work Table	
27	1	** Spare Number **	
28	1	Cooking Hood Perforated Supply Plenum	14' x 17'-0"
29	1	Cooking Exhaust Hood	66' x 16'-0"
30	1	** Spare Number **	
31	1	Hood Control Touch Screen (CASHMI)	
32	1	Fire Protection System	
33	1	Hood Control Box - Heat Sensor Elec. Package	
34	1	Room Temperature Sensor	
35	1	** Spare Number **	
36	1	** Spare Number **	
37	1	Flat Stainless Steel Wall Panel	
38	1	** Spare Number **	
39	1	** Spare Number **	
40	1	** Spare Number **	
41	1	Three Fryer Battery	NIC; By Owner
42	1	French Fry Warmer	NIC; By Owner
43	1	Undercounter Freezer	
44	1	36" Range - 6 Burners - Convection Oven	
45	1	** Spare Number **	
46	1	Double Stacked Combi Oven	Provide with Heat Shield
47	2	Mobile Work Table	
48	4	Poker Chip Dish Dolly	
49	10	Decorative Heat Lamp	
50	1	Combi Oven Water Filtration System	
51	1	** Spare Number **	
52	4	Holding & Transport Cabinet	
53	1	** Spare Number **	
54	1	Two Section Roll Thru Refrigerator	
55	1	One Section Roll Thru Refrigerator	
56	3	Refrigerator Roll-in Rack	
57	4	Queen Mary Utility Cart	
58	8	Dishrack Dolly	
59	1	Mop Cabinet w/ Faucet	
60	5	Dry Storage Shelving	NIC; By Owner
61	1	Soiled Dishtable	
62	1	Pot & Pan Scrap Master	
63	1	Type 8 Enclosed Hose Reel	
64	1	Walk-in Cooler Box & Refrigeration System	
65	2	Keg Storage Rack	
66	1	12' x 72" Floor Trough Grey Fiberglass Grating	
67	1	Dishmachine w/ Booster Heater	NIC; By Owner
68	1	Slant Rack Shelf	
69	3	Dry Storage Shelving	NIC; By Owner
70	1	Dry Storage Dunnage Rack	
71	2	Dishwasher Vent Duct Riser	
72	1	** Spare Number **	
73	1	Clean Dishtable	
74	1	Trash Container	NIC; By Owner
75	1	Warewash Spray Rinse	
76	1	Four Compartment Sink	
77	1	Beverage Counter w/ Sink & Drip Drain	
78	2	Coffee Maker w/ water Filter	NIC; By Owner

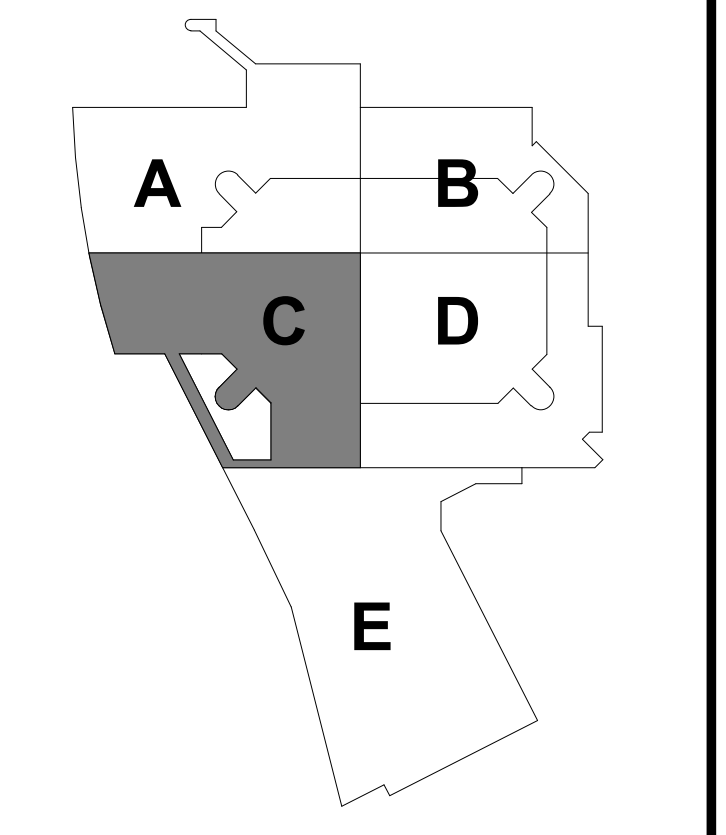

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PROJECT

LA CROSSE CENTER EXPANSION & RENOVATION

LA CROSSE WISCONSIN

REVISION SCHEDULE

DATE	DESCRIPTION	BY
08/14/2020	PR20	

PROJECT NO. 16-19990

FILE NAME 19990 Arch R18.rvt

DRAWN BY SK

DESIGNED BY DH

REVIEWED BY DH

ORIGINAL ISSUE DATE 02/06/20

CLIENT PROJECT NO.


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FOODSERVICE BALLROOM BANQUET KITCHEN PLAN & SCHEDULE


SHEET

FS101

REFERENCE SCALE
 1" = 1'-0"
 0 1/4" 1/2" 1" 2"

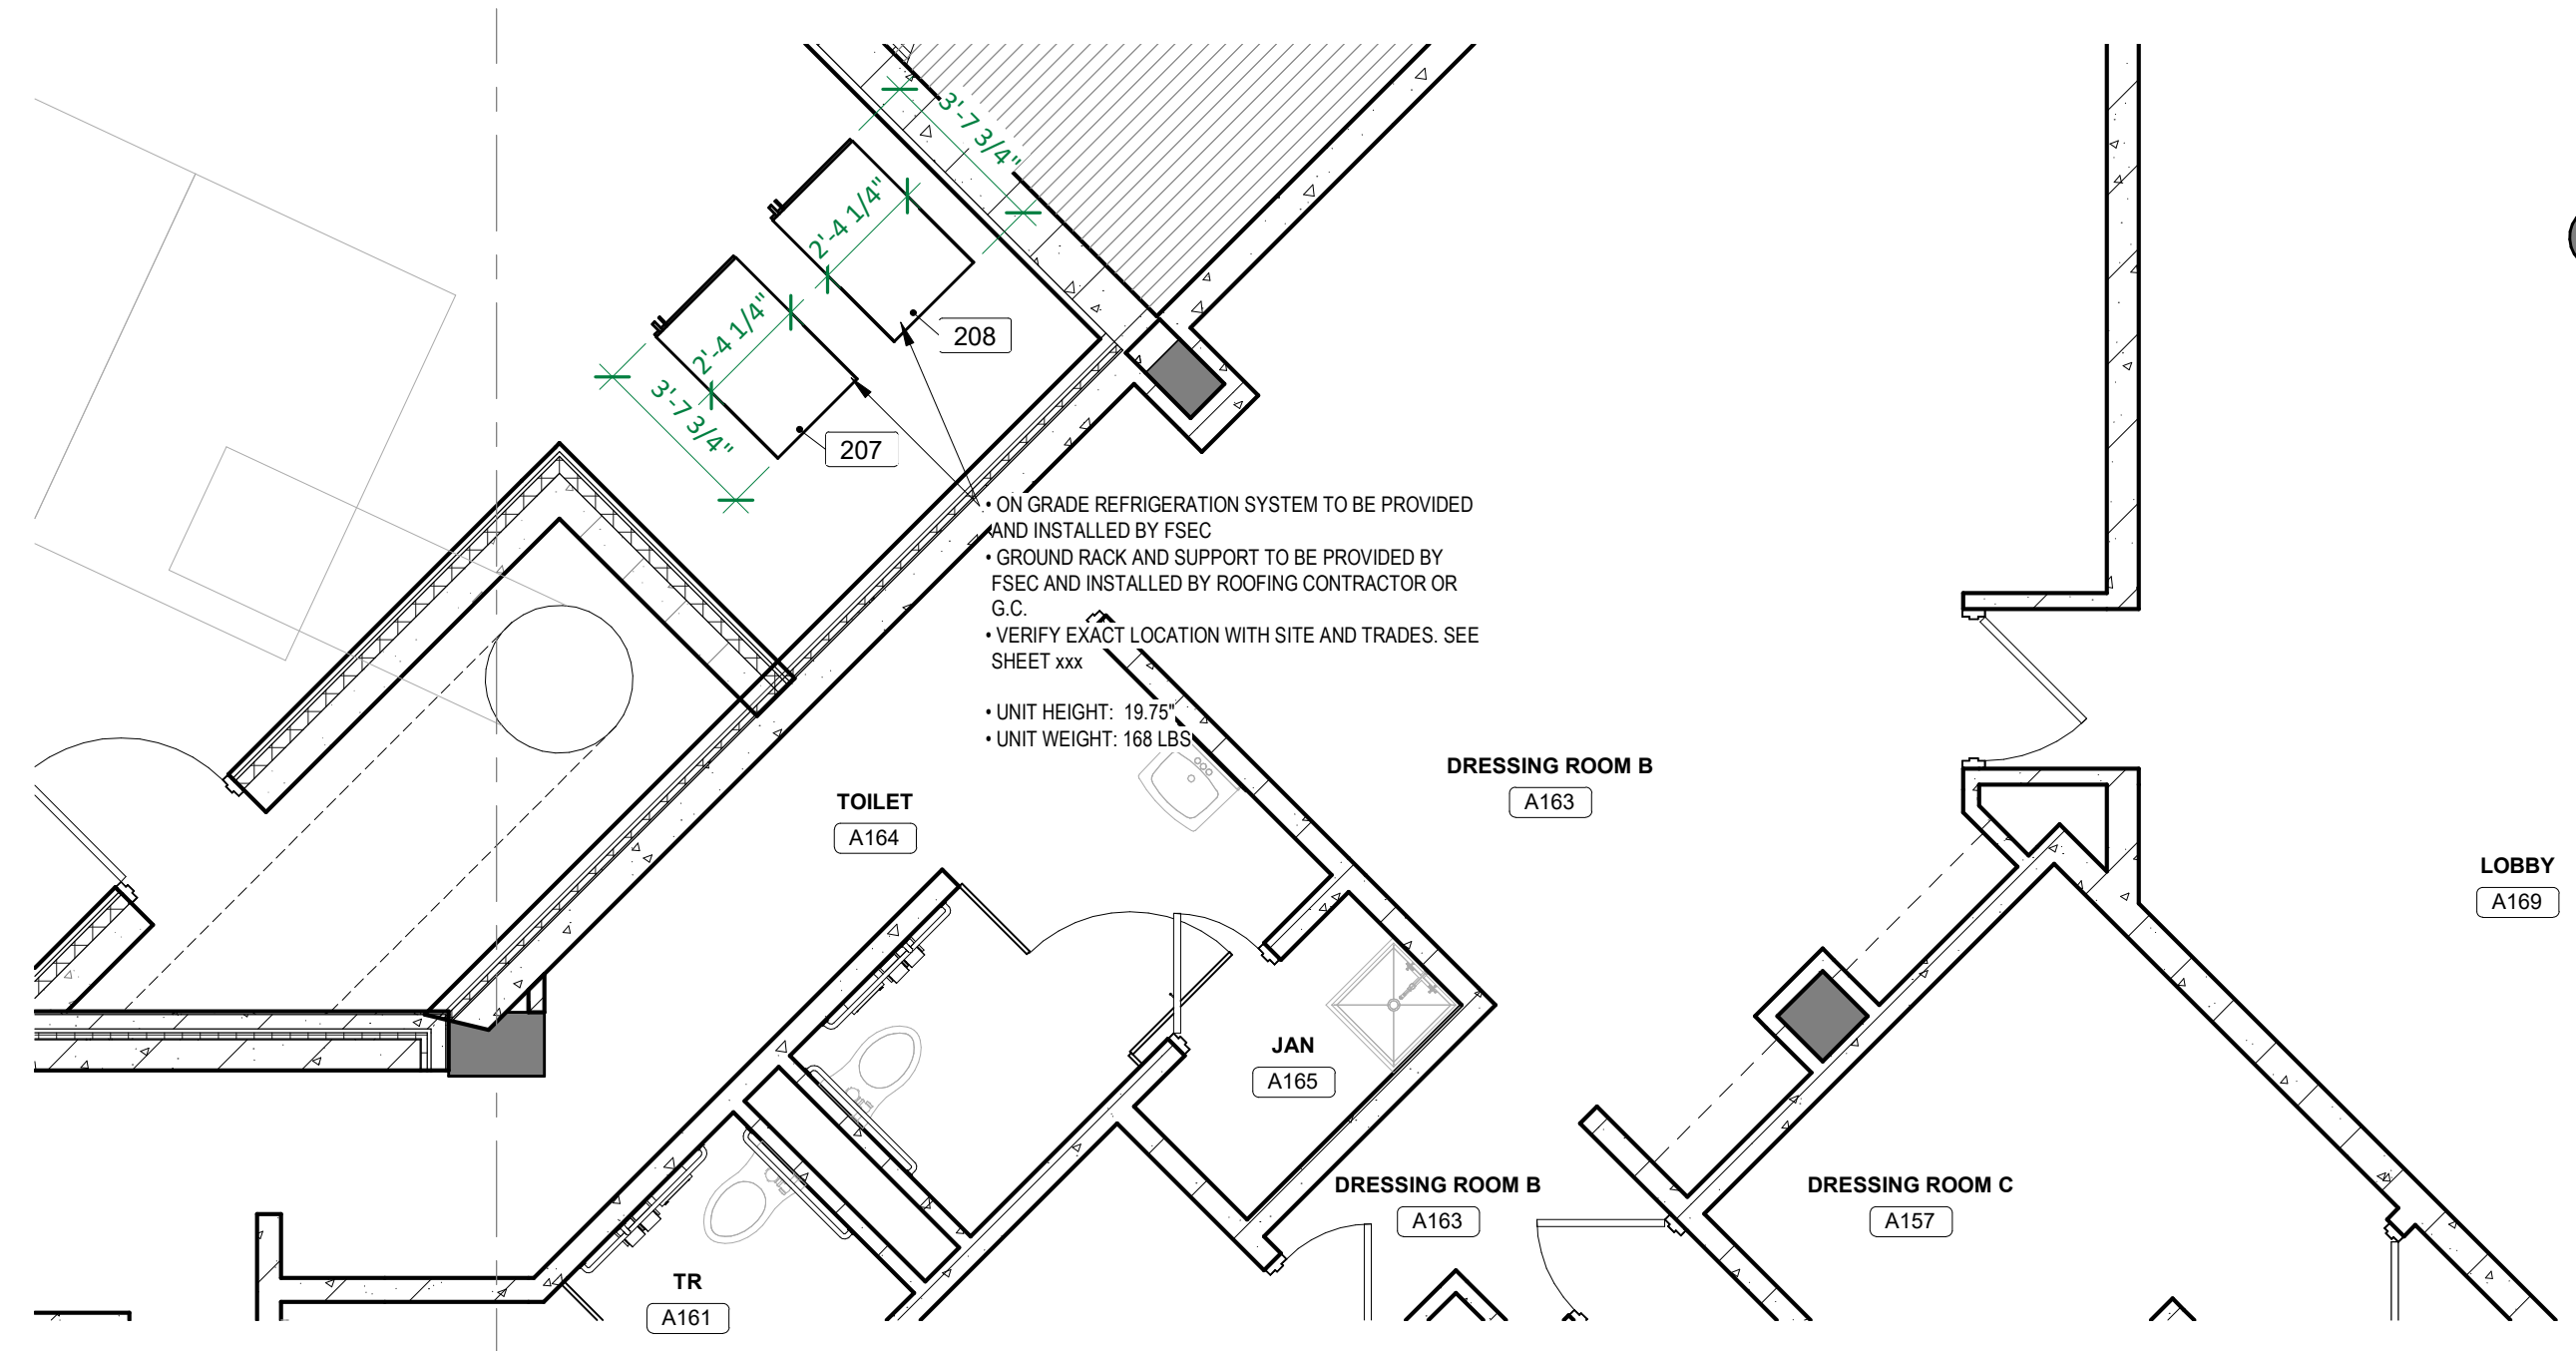

1 FOODSERVICE EQUIPMENT ARENA WALK-IN PLAN
FS102 1/4" = 1'-0"

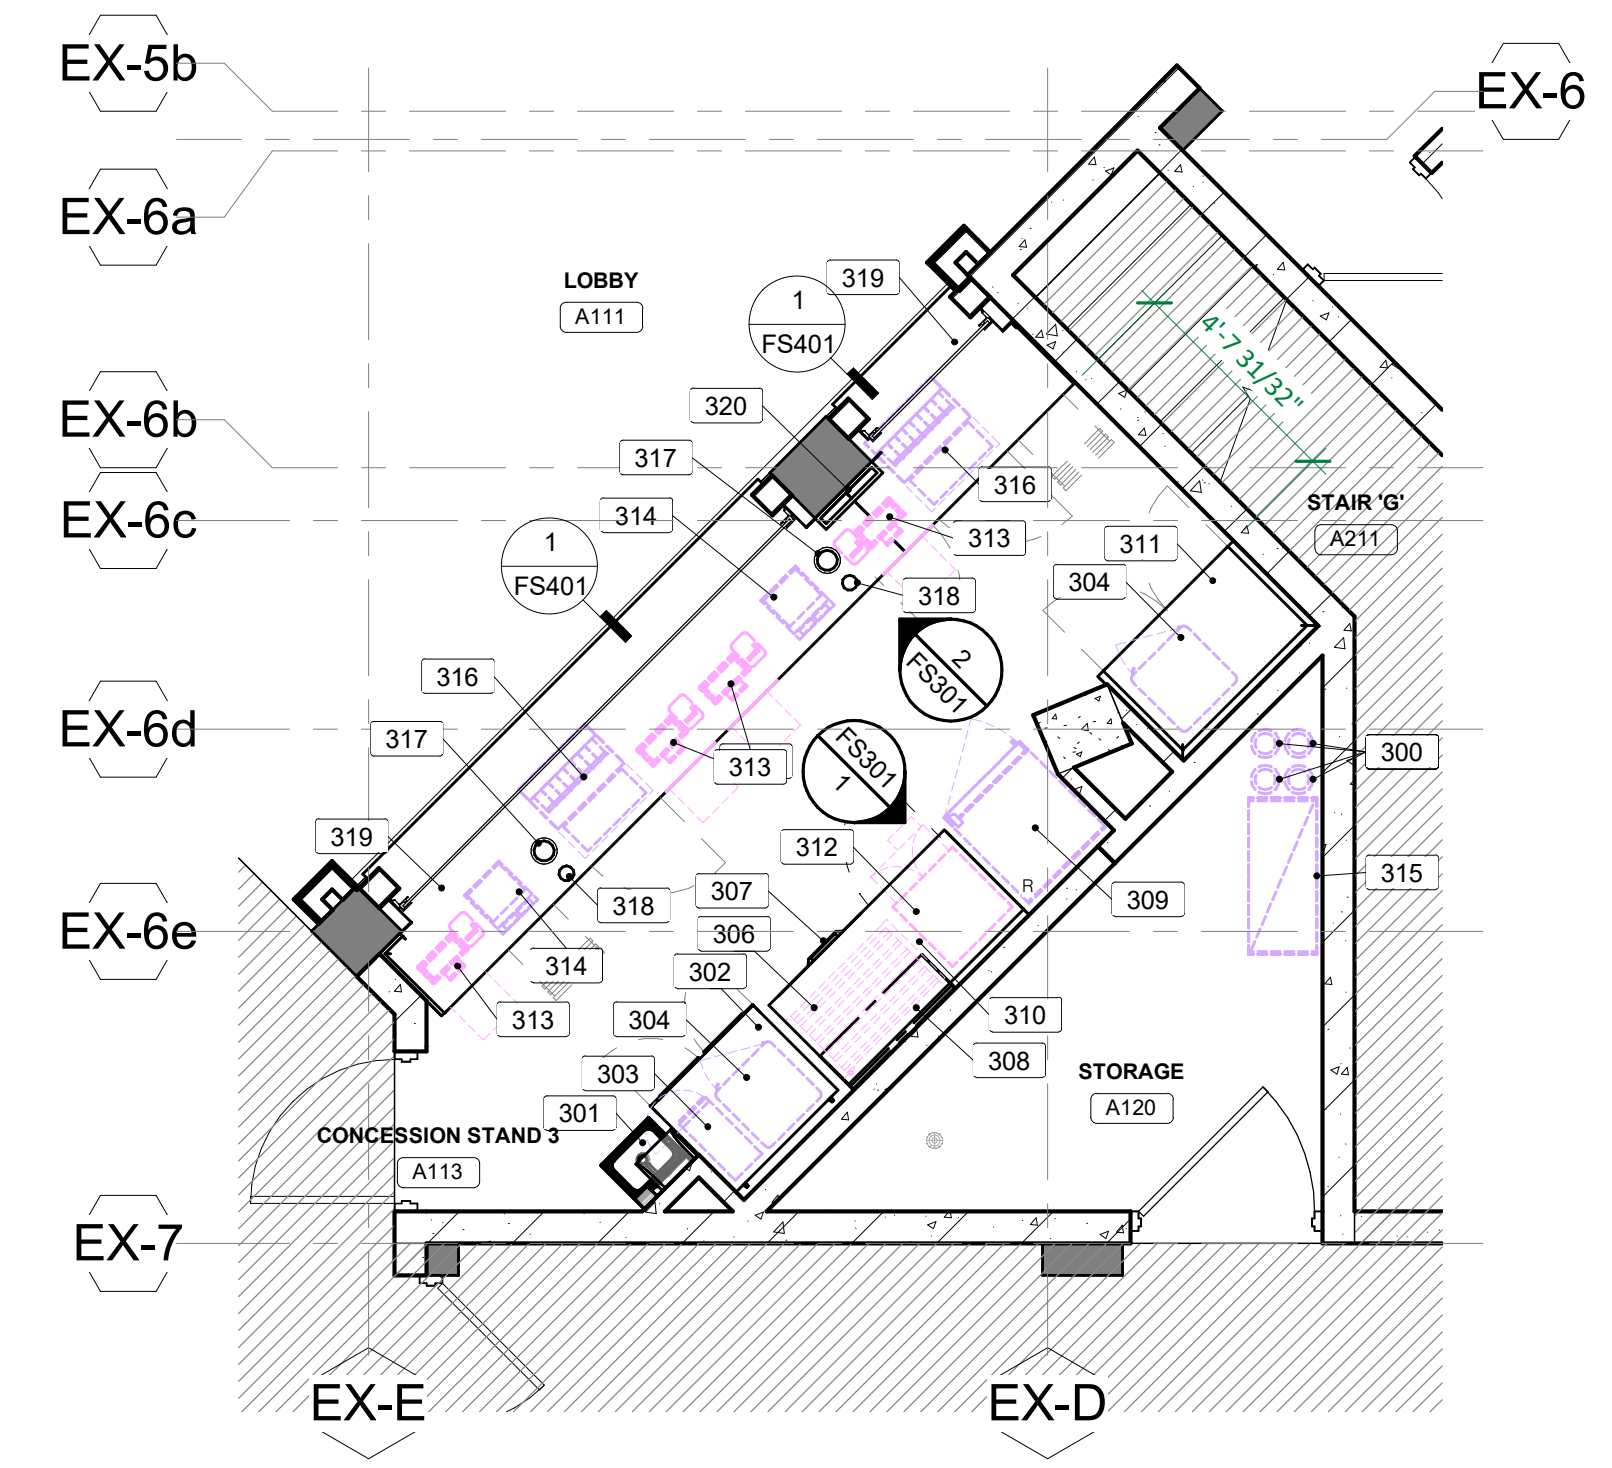

2 FOODSERVICE EQUIPMENT CONCESSION STAND #3 PLAN
FS102 1/4" = 1'-0"

ITEM NO	QTY	DESCRIPTION	REMARKS
300	4	CO2 Cylinder Tank	NIC; By Vendor
301	1	Hand Sink w/ Faucet	Towl & Soap Dispenser by Owner, Installed by GC
302	1	Undercounter Freezer	NIC; By Vendor
303	1	Single Hot Food Dispenser	NIC; By Vendor
304	2	Pretzel Heated Display Case	NIC; By Vendor
305	1	** Spare Number **	
306	1	Hot Dog Grill	NIC; By Owner
307	1	Built-in Drawer Warmer	
308	1	Wall Shelf	
309	1	One Section Merchandiser Refrigerator	NIC; By Vendor
310	1	Work Counter	
311	1	Work Counter	
312	1	Popcorn Machine	NIC; By Owner
313	4	Tablet Cash Register System	NIC; By Owner
314	2	Bottoms Up Beer System	NIC; By Vendor
315	1	Soda Rack	NIC; By Vendor
316	2	Soda Dispenser w/ Drop in Ice Bin	NIC; By Vendor
317	2	Cup Dispenser	
318	2	Cup Dispenser	
319	1	Front Serving Counter	
320	1	Stainless Steel Utility Chase	W/ Load Panel Center


PLAN LEGEND

- EQUIPMENT PROVIDED BY OWNER
- EQUIPMENT PROVIDED BY VENDOR
- EXISTING EQUIPMENT - RELOCATE

PLAN KEY INDEX

- PROVIDE 1/8" DIAMOND TREAD 42" HIGH
- 42" DOOR REQUIRED* (BY BUILDING CONTRACTOR)
- JANITOR SINK W/ FAUCET* (BY MECHANICAL)
- EYE WASH STATION* (BY MECHANICAL)
- GREASE INTERCEPTOR* (BY MECHANICAL)
- FIELD JOINT - SEE SPECIFICATION FOR TYPE

*SEE ARCHITECT AND/OR ENGINEER PLANS FOR EXACT LOCATIONS

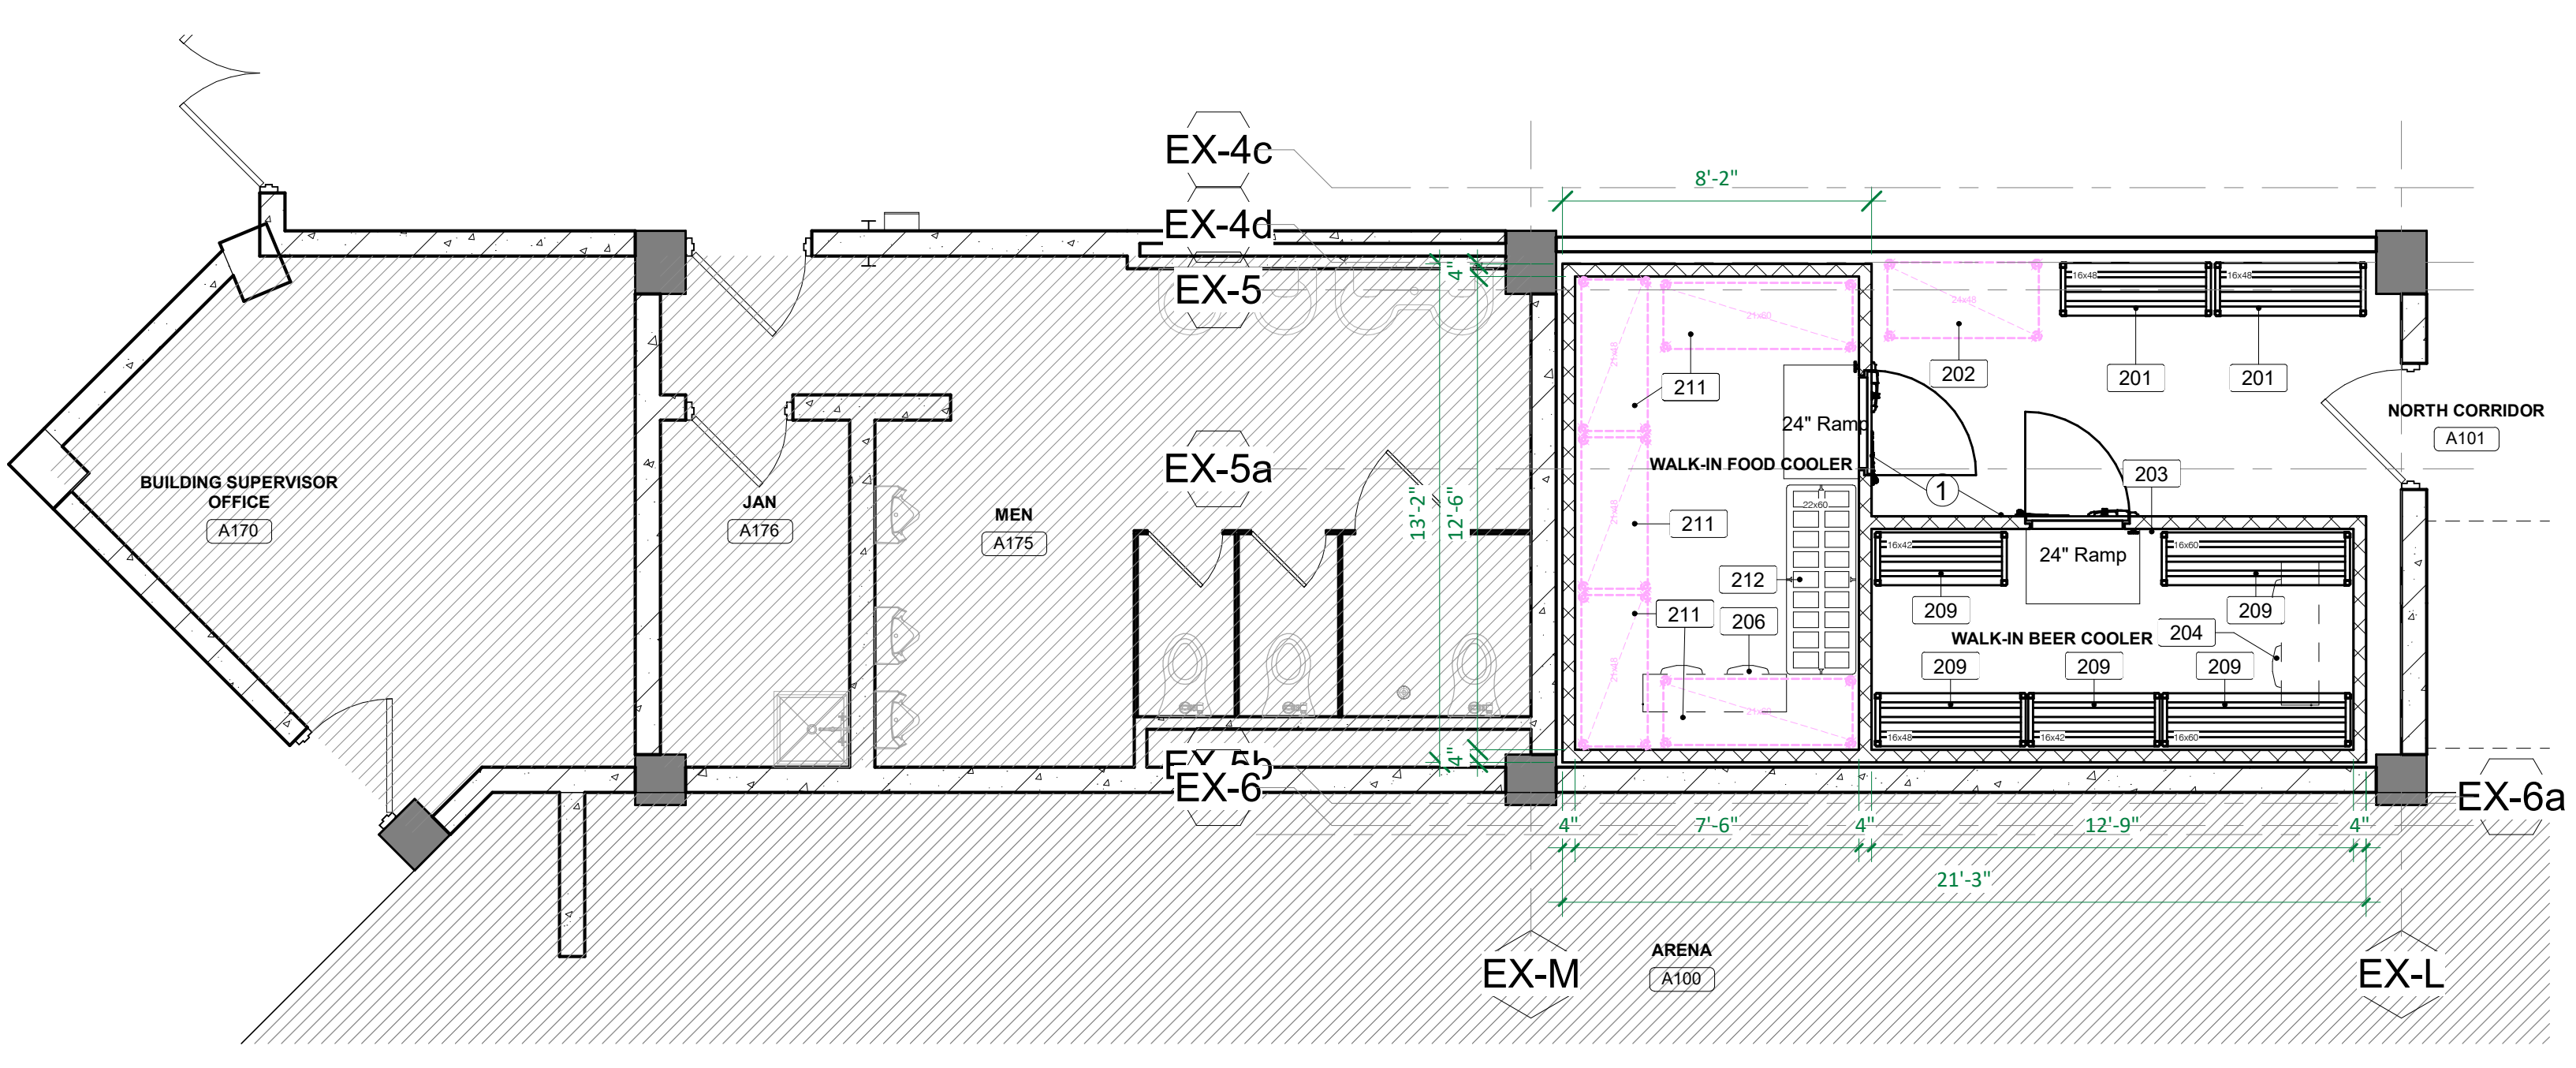


ARENA WALK-INS EQUIPMENT SCHEDULE


ITEM NO	QTY	DESCRIPTION	REMARKS
201	2	Keg Storage Rack	
202	1	Dry Storage Mobile Shelving	NIC; By Owner
203	1	Walk-in Cooler / Cooler Box	
204	1	Beer Cooler Coil	
205	1	** Spare Number **	
206	1	Cooler Coil	
207	1	Ground Refrigeration Unit	
208	1	Ground Refrigeration Unit	
209	5	Keg Storage Rack	
210	1	** Spare Number **	
211	5	Cooler Mobile Shelving	NIC; By Owner
212	1	Dunnage Rack	

CONCOURSE EQUIPMENT SCHEDULE


ITEM NO	QTY	DESCRIPTION	REMARKS
100	1	Walk-in Cooler Box	
101	1	Cooler Center Mount Coil	
102	4	Cooler Mobile Shelving	NIC; By Owner
103	1	Cooking Exhaust Hood	60" x 7'-0"
104	1	Cooking Hood Perforated Supply Plenum	14" x 7'-0"
105	1	Roof Top Refrigeration Unit	
106	1	Fire Protection System	
107	1	Hood Control Box - Heat Sensor Elec. Package	
108	1	Double Conveyor Oven	NIC; By Owner
109	1	** Spare Number **	
110	1	French Fry Warmer	NIC; By Owner
111	1	Cooking Exhaust Hood	60" x 13'-0"
112	1	Cooking Hood Perforated Supply Plenum	14" x 13'-0"
113	1	60" Griddle w/ Griddle Clam Shell	
114	1	French Fry Table	
115	1	Mobile Griddle Stand	
116	1	Three Fryer Battery	NIC; By Owner
117	1	Flat Stainless Steel Wall Panel	
118	1	Walk-in Freezer Box	
119	1	Freezer Center Mount Coil	
120	1	Hood Control Touch Screen (CASHMI)	
121	3	Freezer Shelving	NIC; By Owner
122	2	Kitchen Dunnage Rack	
123	4	Hand Sink w/ Faucet	Towl & Soap Dispenser by Owner, Installed by GC
124	1	Bread Rack	NIC; By Vendor
125	1	Room Temperature Sensor	
126	1	Back Prep Counter	
127	2	Wall Shelf	Stacked
128	2	Merchandising Display Warmers	
129	1	** Spare Number **	
130	1	Pizza Prep Refrigerator	
131	2	Popcorn Machine	NIC; By Owner
132	1	** Spare Number **	
133	1	Ice Machine w/ Bin and Transport Cart	
134	1	Ice Machine Water Filtration System	
135	1	Microwave Oven	
136	1	15" x 72" Floor Trough	
137	1	Soda Rack	NIC; By Vendor
138	4	CO2 Cylinder Tank	NIC; By Vendor
139	2	Refrigerator Merchandiser	NIC; By Vendor
140	3	Mobile Work Table	
141	1	Front Prep Counter	
142	2	Undercounter Freezer	
143	2	Pizza Heated Display Case	NIC; By Vendor
144	2	Pretzel Heated Display Case	NIC; By Vendor
145	1	Front Prep Counter	
146	2	Built-in Drawer Warmer	
147	1	Single Hot Food Dispenser	NIC; By Vendor
148	1	Hot Dog Grill	NIC; By Owner
149	1	** Spare Number **	
150	2	Stainless Steel Utility Chase	
151	1	Front Serving Counter	W/ Load Panel Center
152	1	** Spare Number **	
153	1	** Spare Number **	
154	6	Tablet Cash Register System	NIC; By Owner
155	1	Four Compartment Sink	
156	3	Soda Dispenser w/ Drop in Ice Bin	NIC; By Vendor
157	1	Microwave Shelf	
158	1	Microwave Oven	
159	1	Disposer w/ Controls & Offset Chute	
160	1	Warewash Spray Rinse	
161	1	Bottoms Up Beer Dispenser - 6 Tap	NIC; By Vendor
162	2	Bottoms Up Beer Dispenser - 4 Tap	NIC; By Vendor
164	1	Ice Machine Remote Condenser	Included w/ item 133
165	5	Disposable Cup Dispenser	
166	5	Disposable Cup Dispenser	

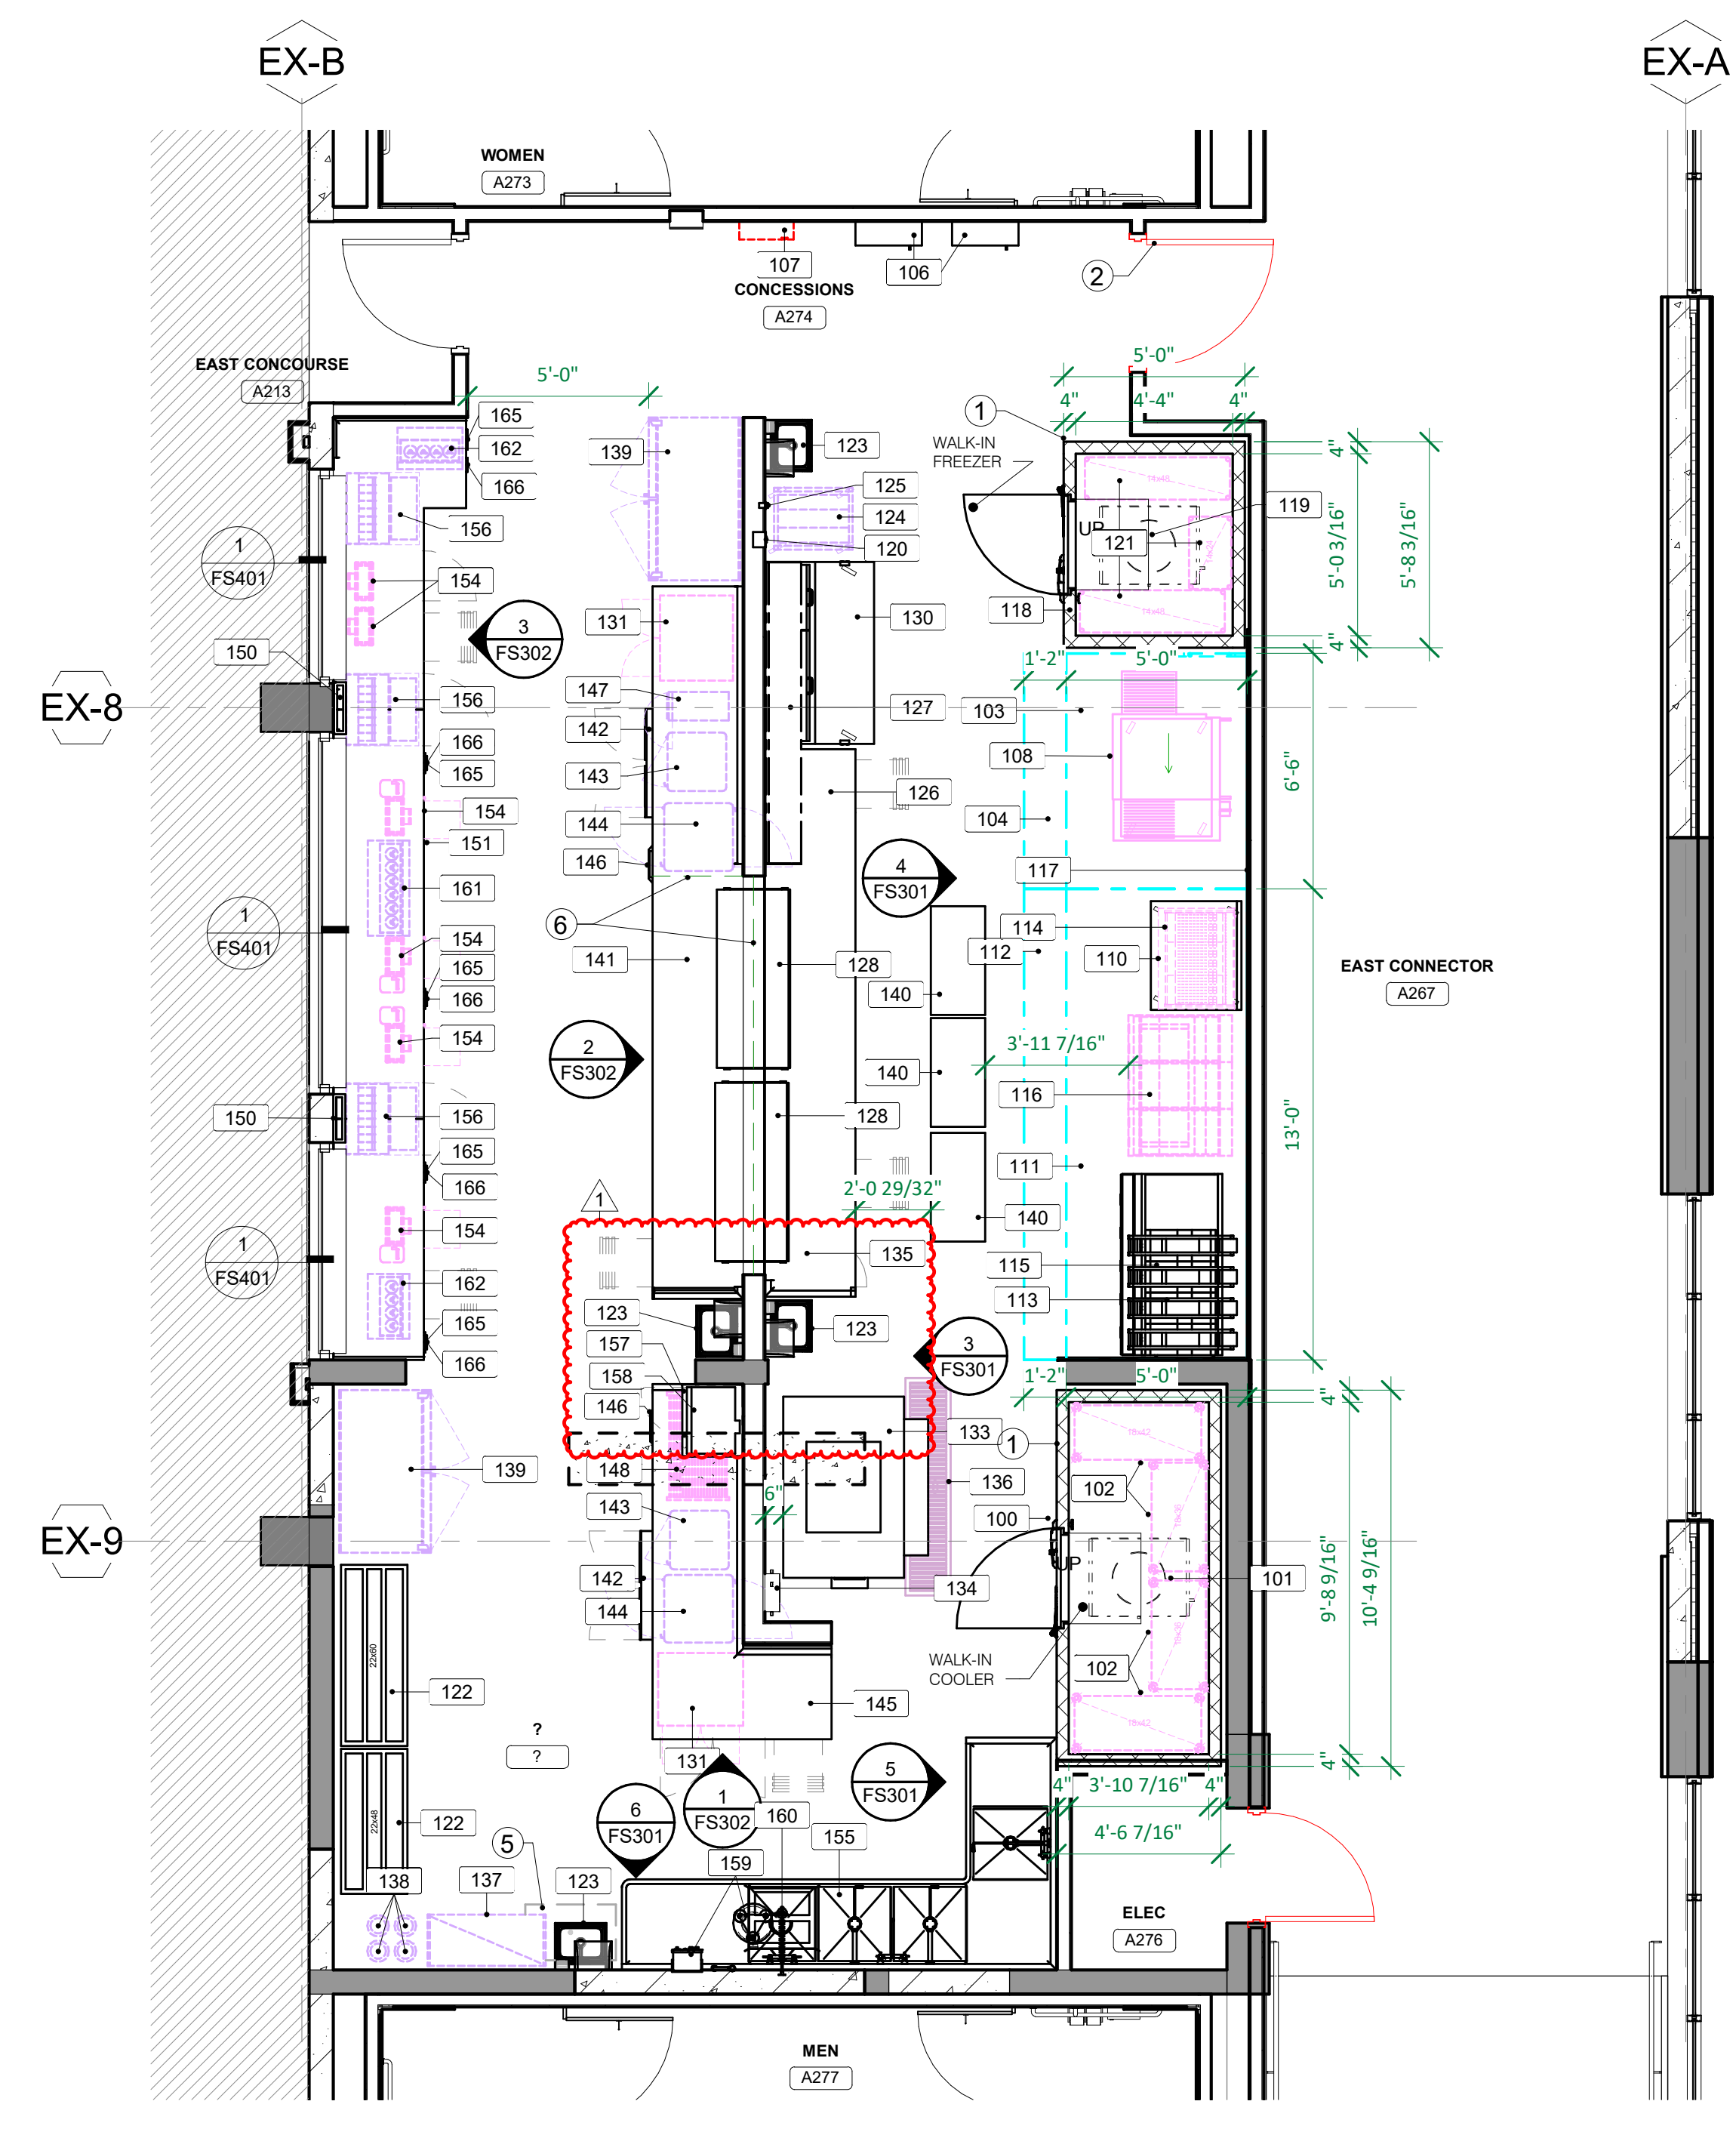

3 FOODSERVICE EQUIPMENT CONCOURSE CONCESSION PLAN - EAST
FS102 1/4" = 1'-0"

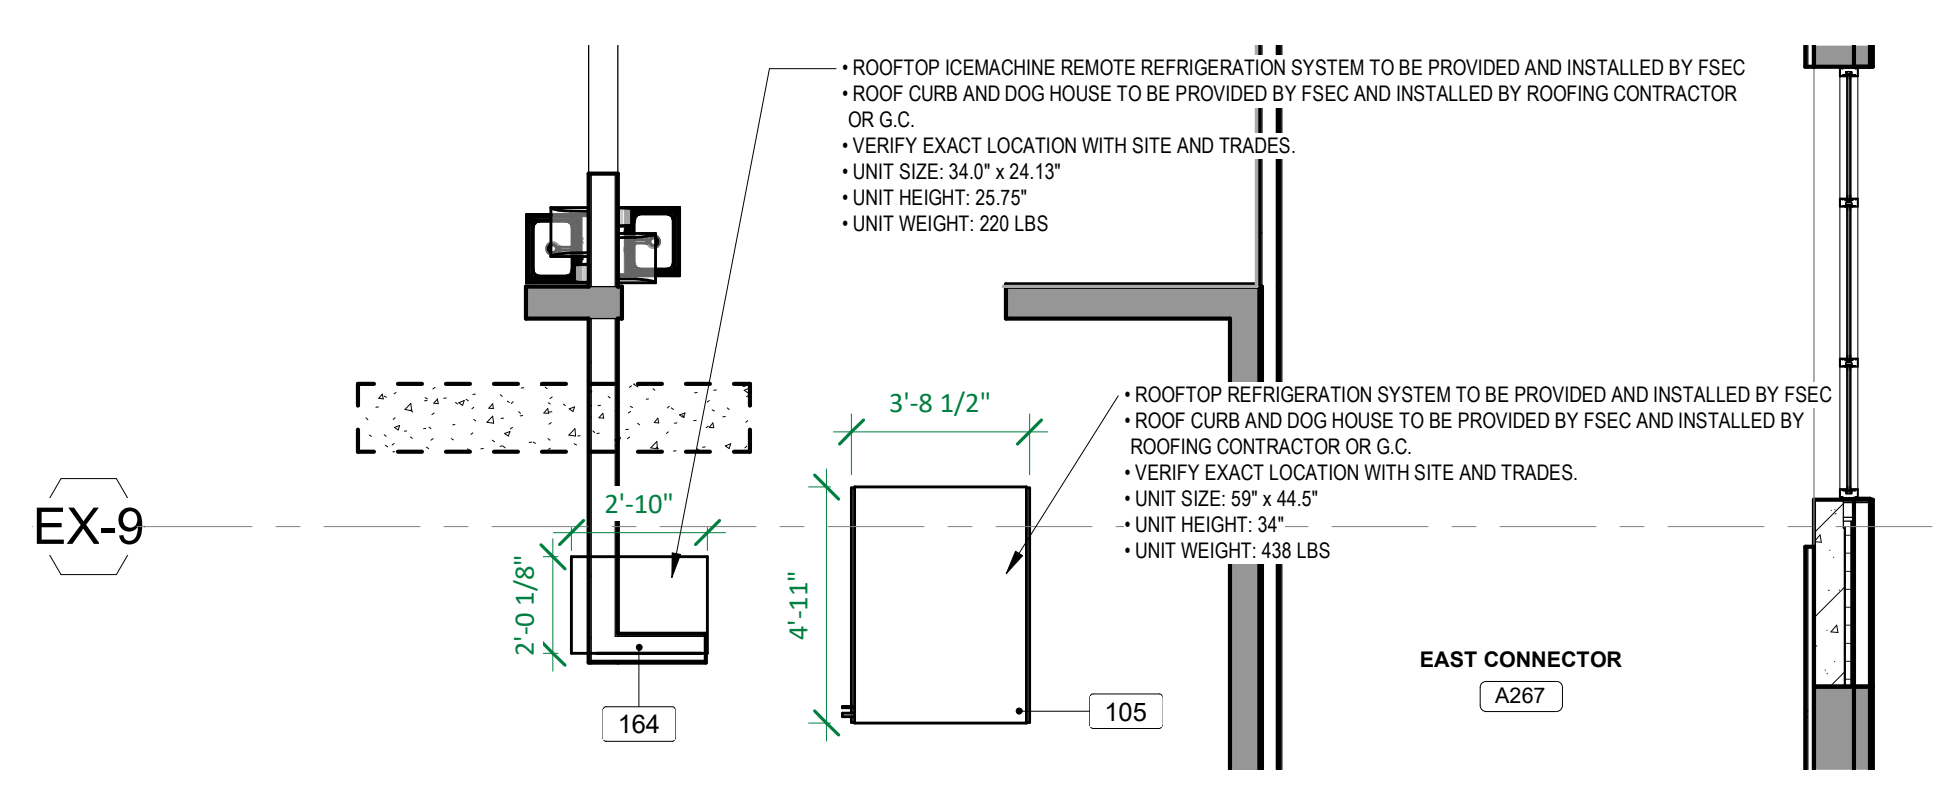

4 FOODSERVICE EQUIPMENT CONCOURSE CONCESSION ROOF EQ PLAN
FS102 1/4" = 1'-0"

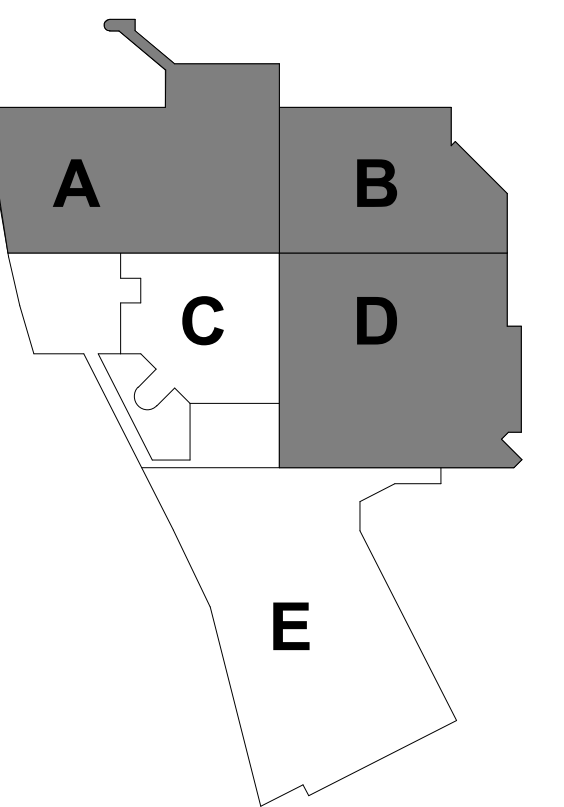

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PROJECT

LA CROSSE CENTER EXPANSION & RENOVATION

LA CROSSE WISCONSIN

REVISION SCHEDULE		
DATE	DESCRIPTION	BY
08/14/2020	PR20	








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FILE NAME 19990 Arch R18.rvt
DRAWN BY SK
DESIGNED BY DH
REVIEWED BY DH
ORIGINAL ISSUE DATE 02/06/20
CLIENT PROJECT NO.

TITLE

FOODSERVICE CONCOURSE CONCESSION ARENA CONCESSIONS & WALKINS PLAN & SCHEDULE

SHEET

FS102

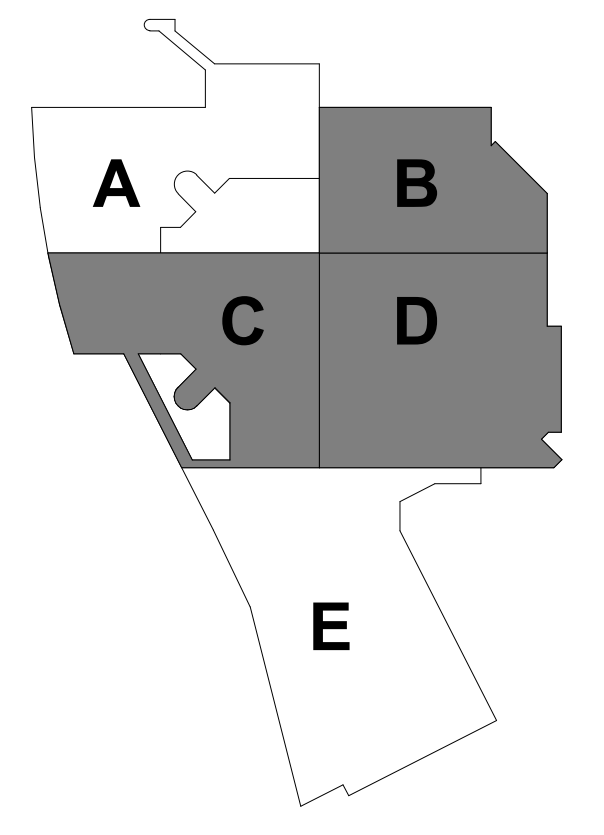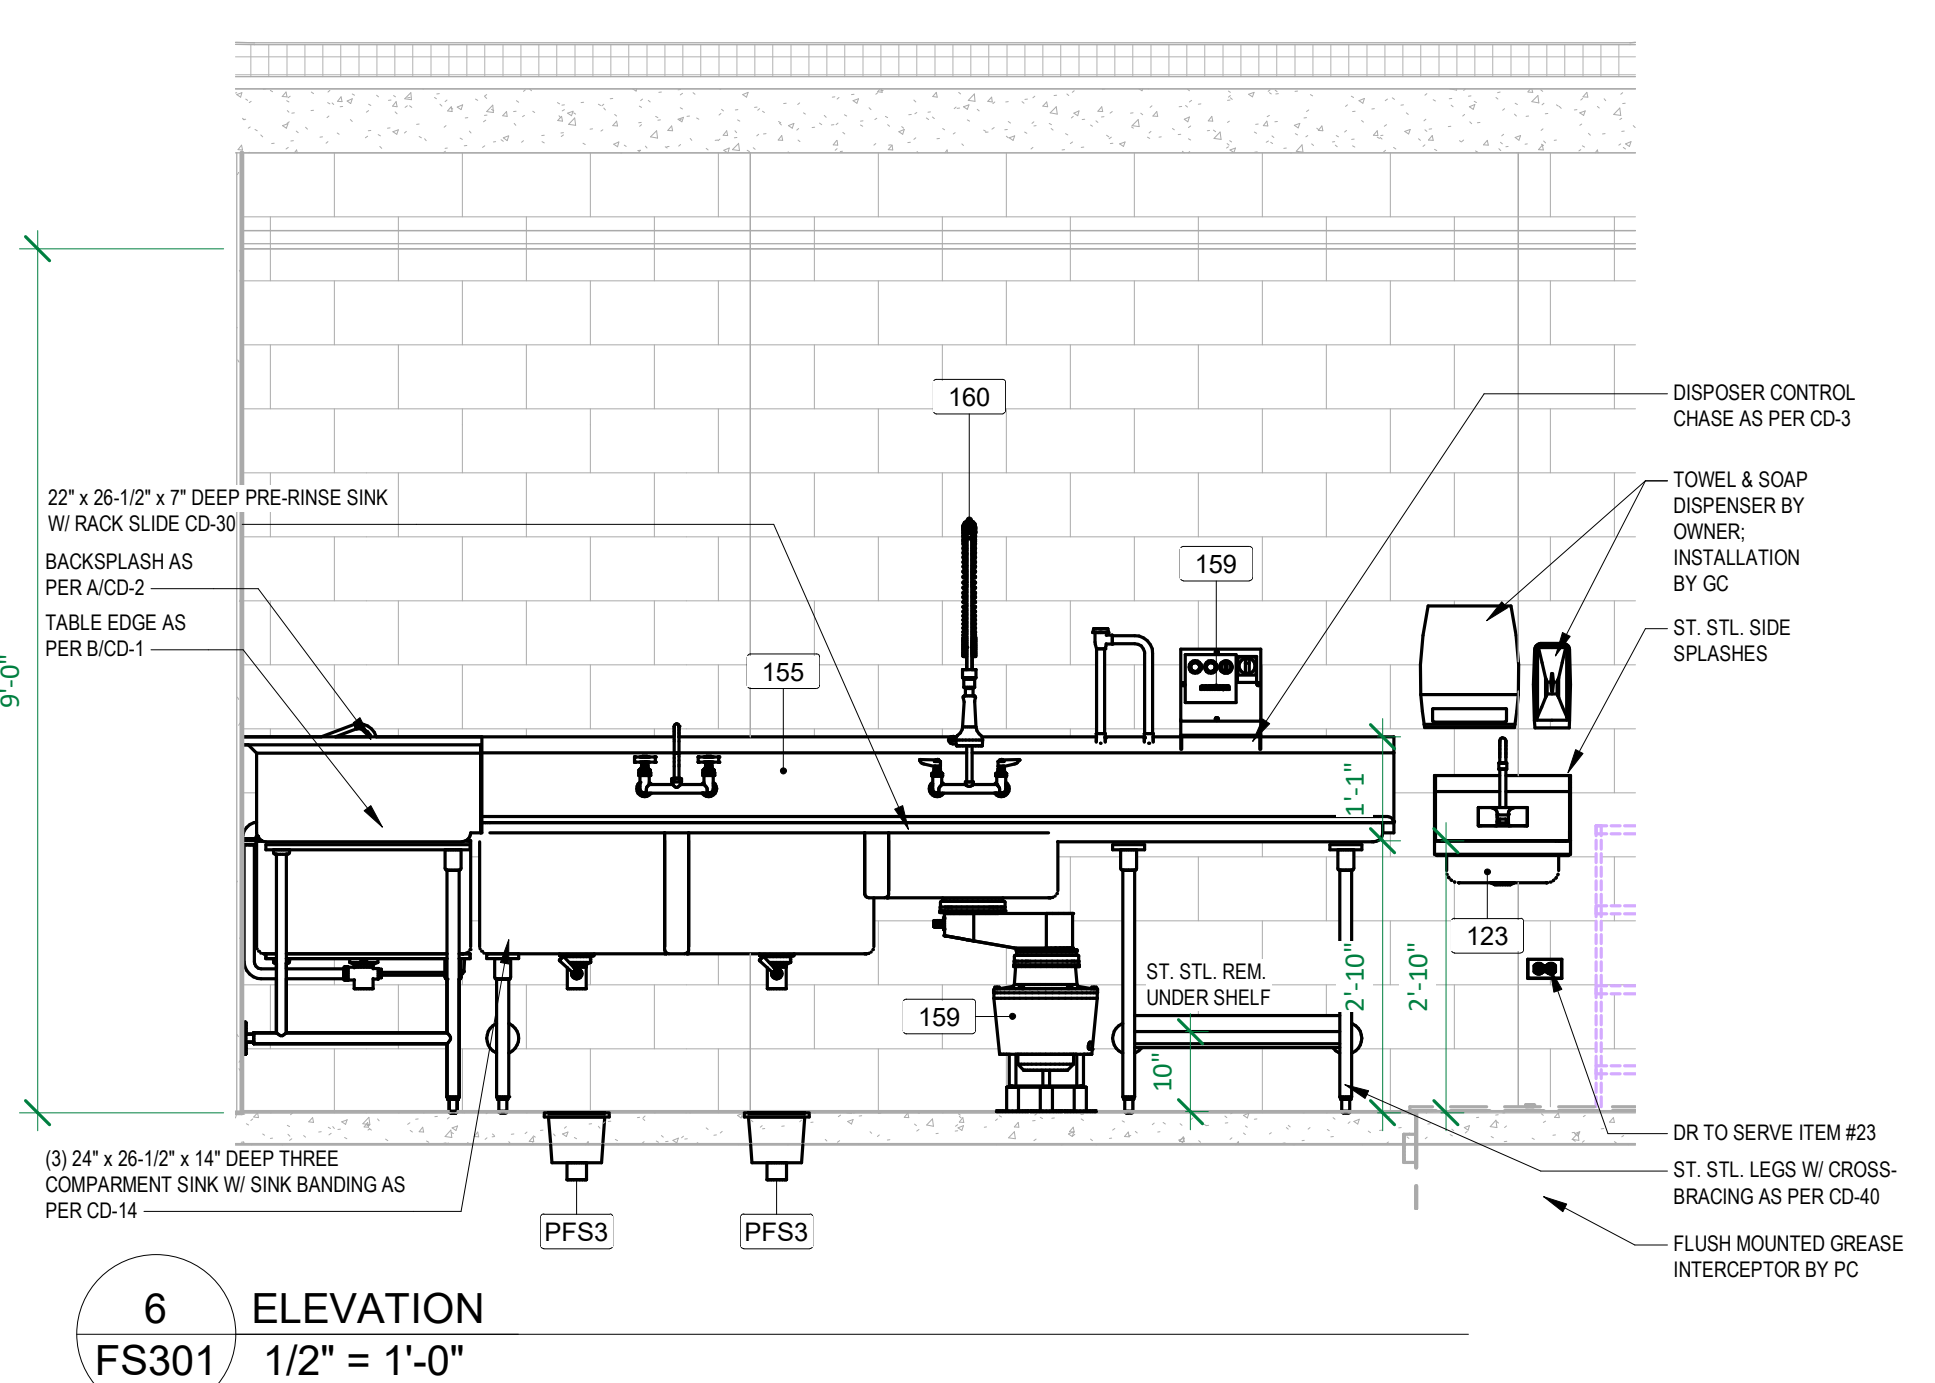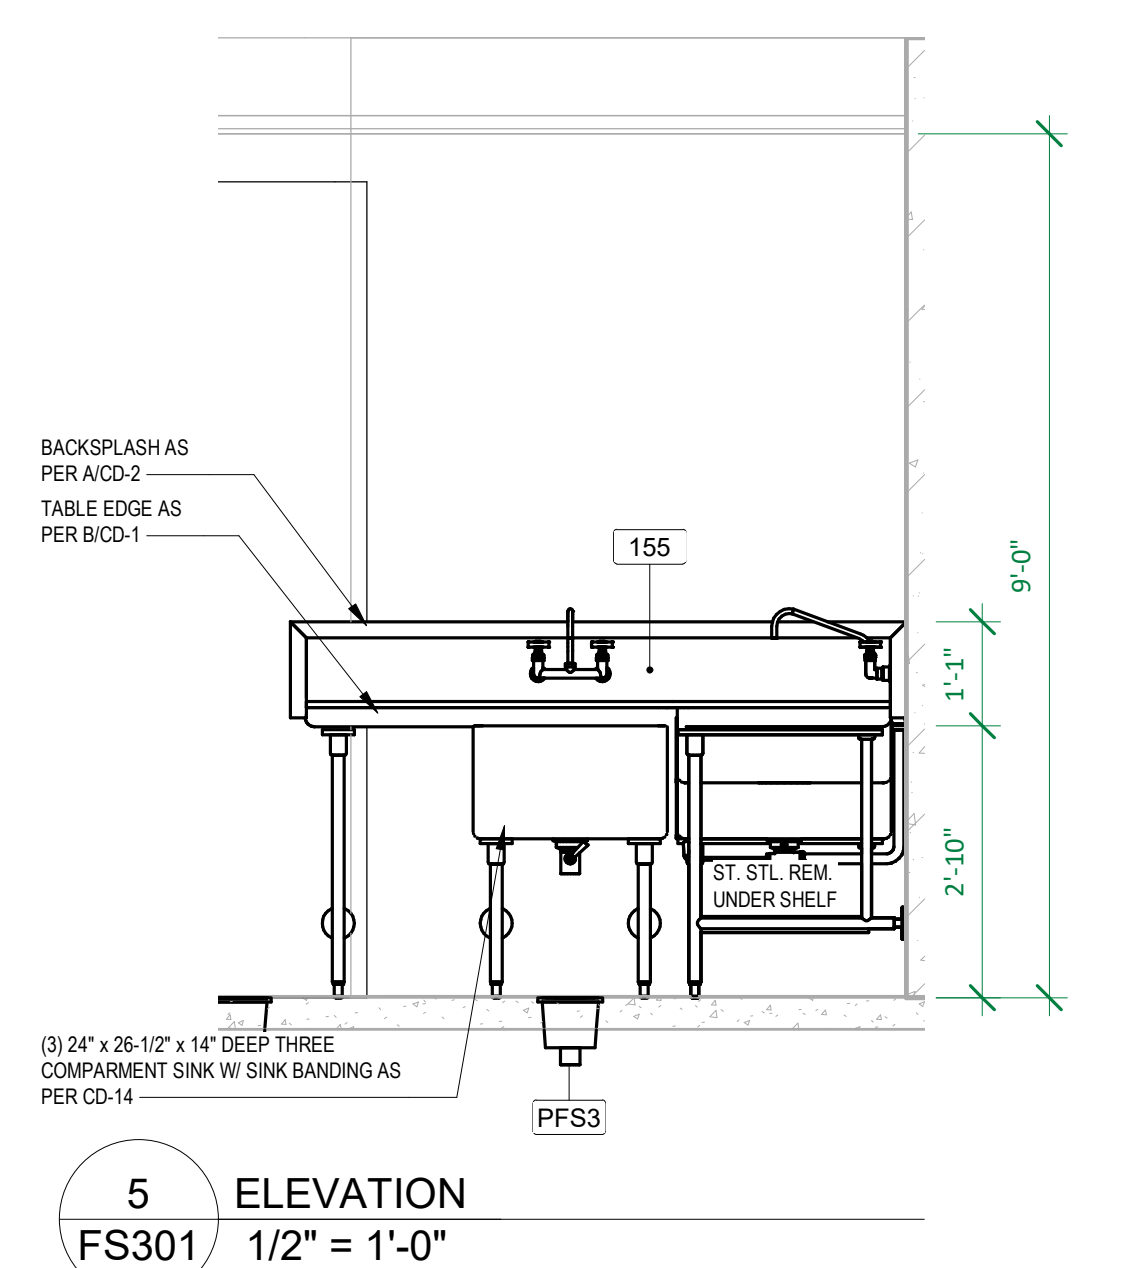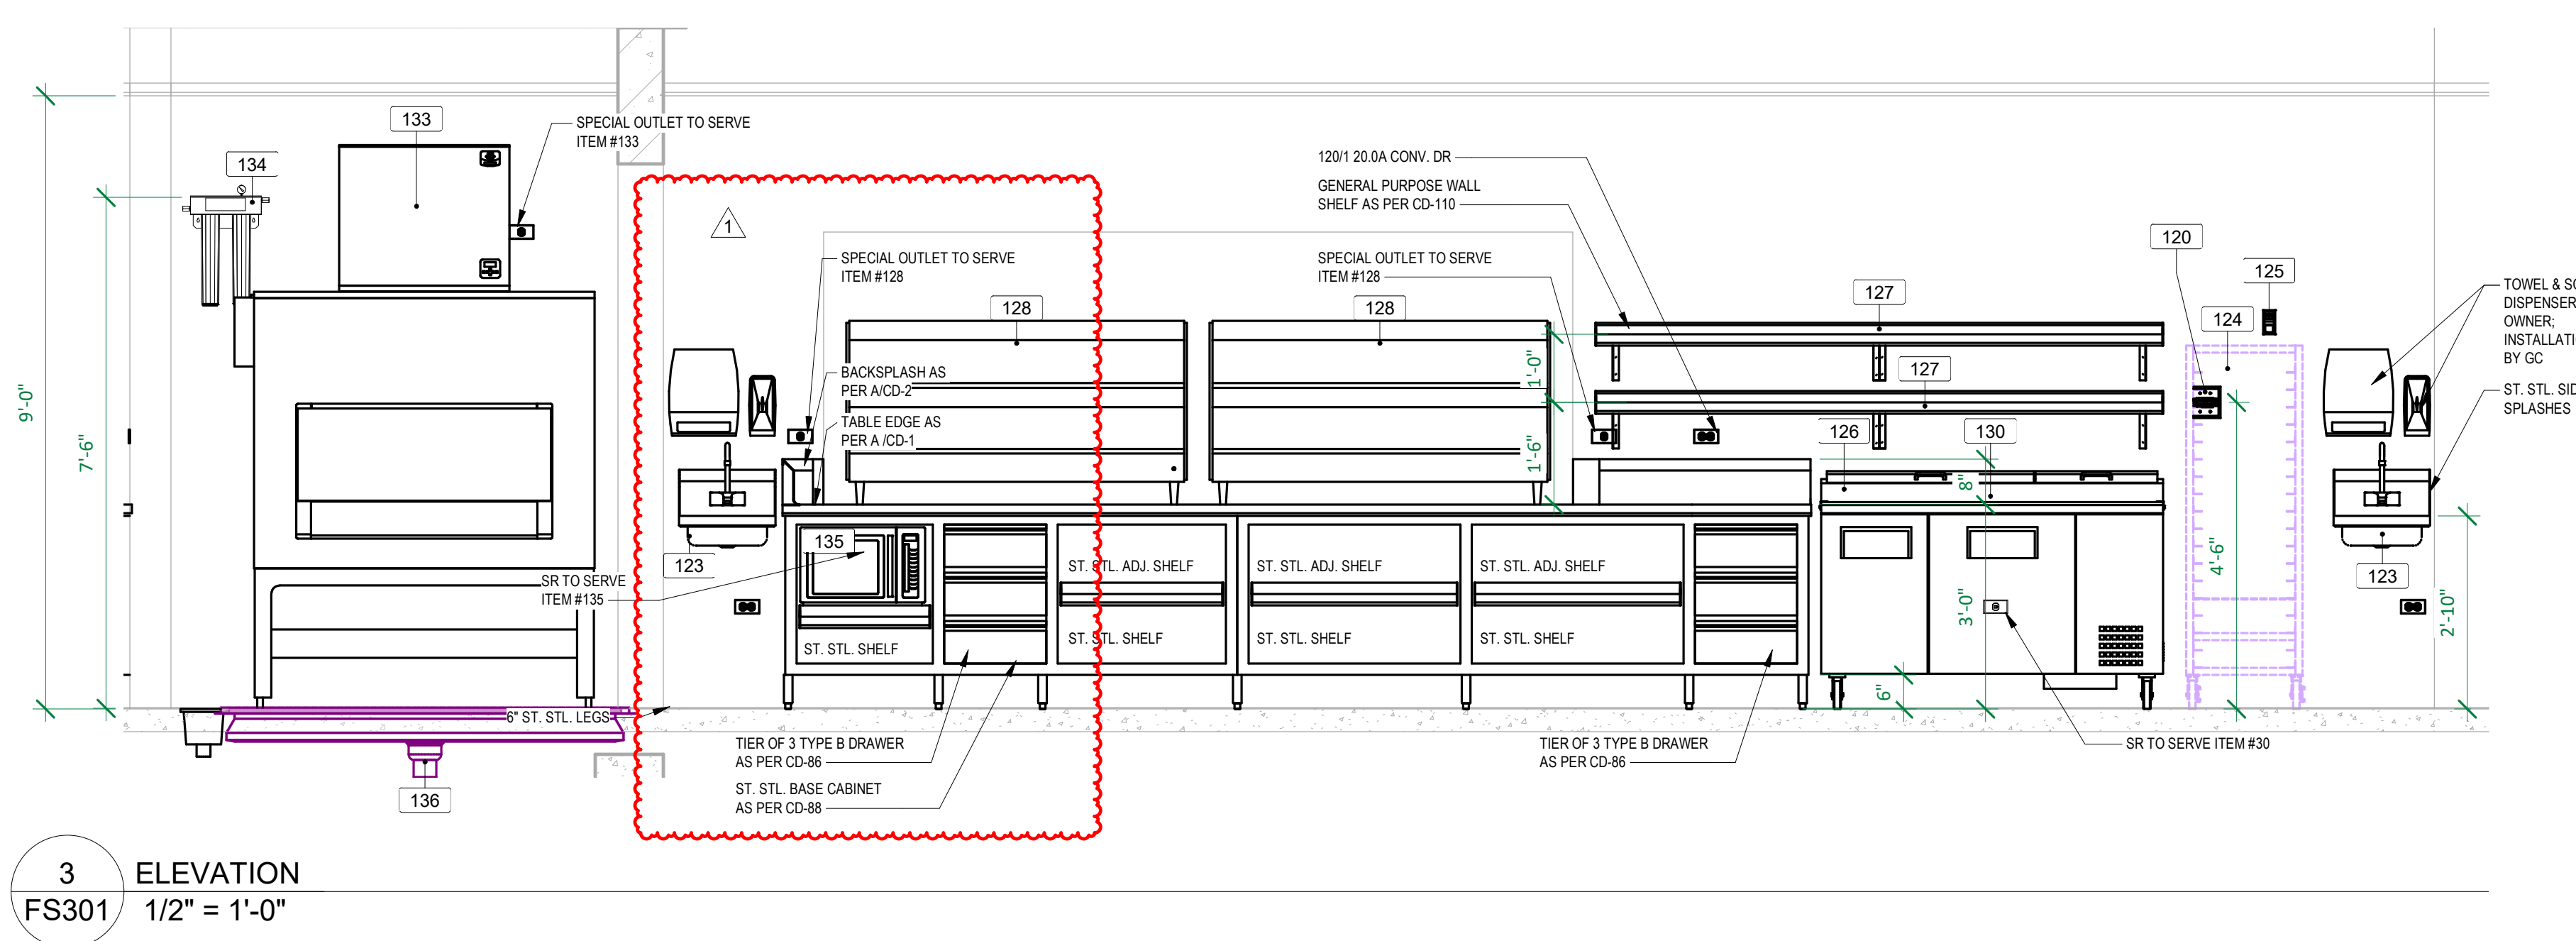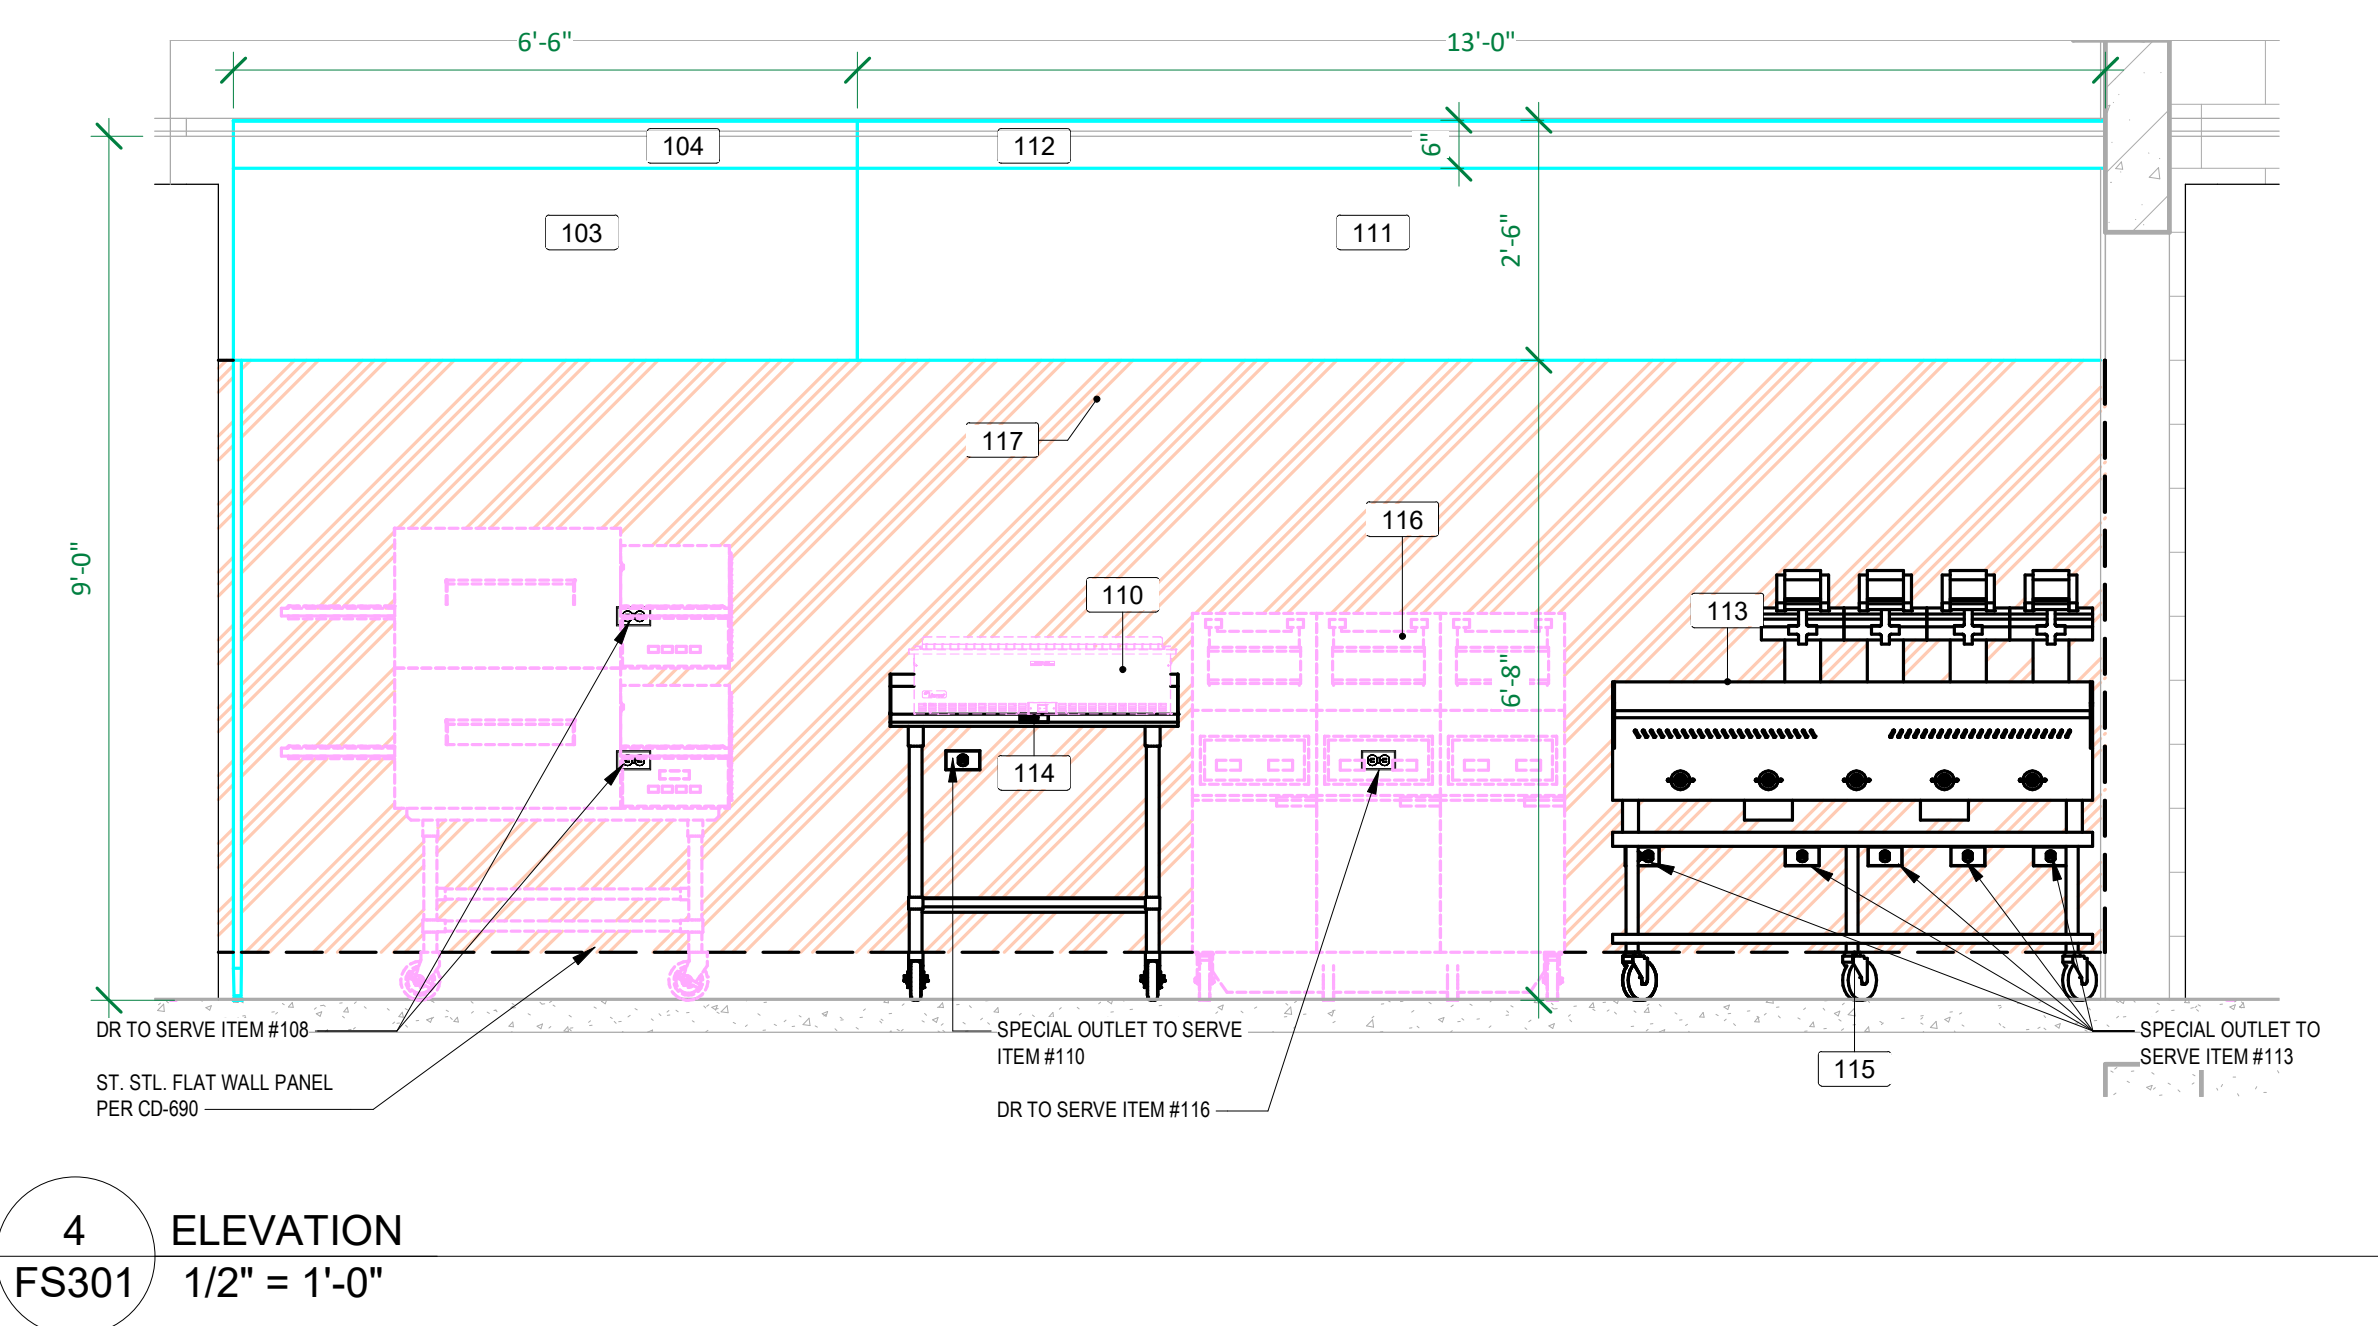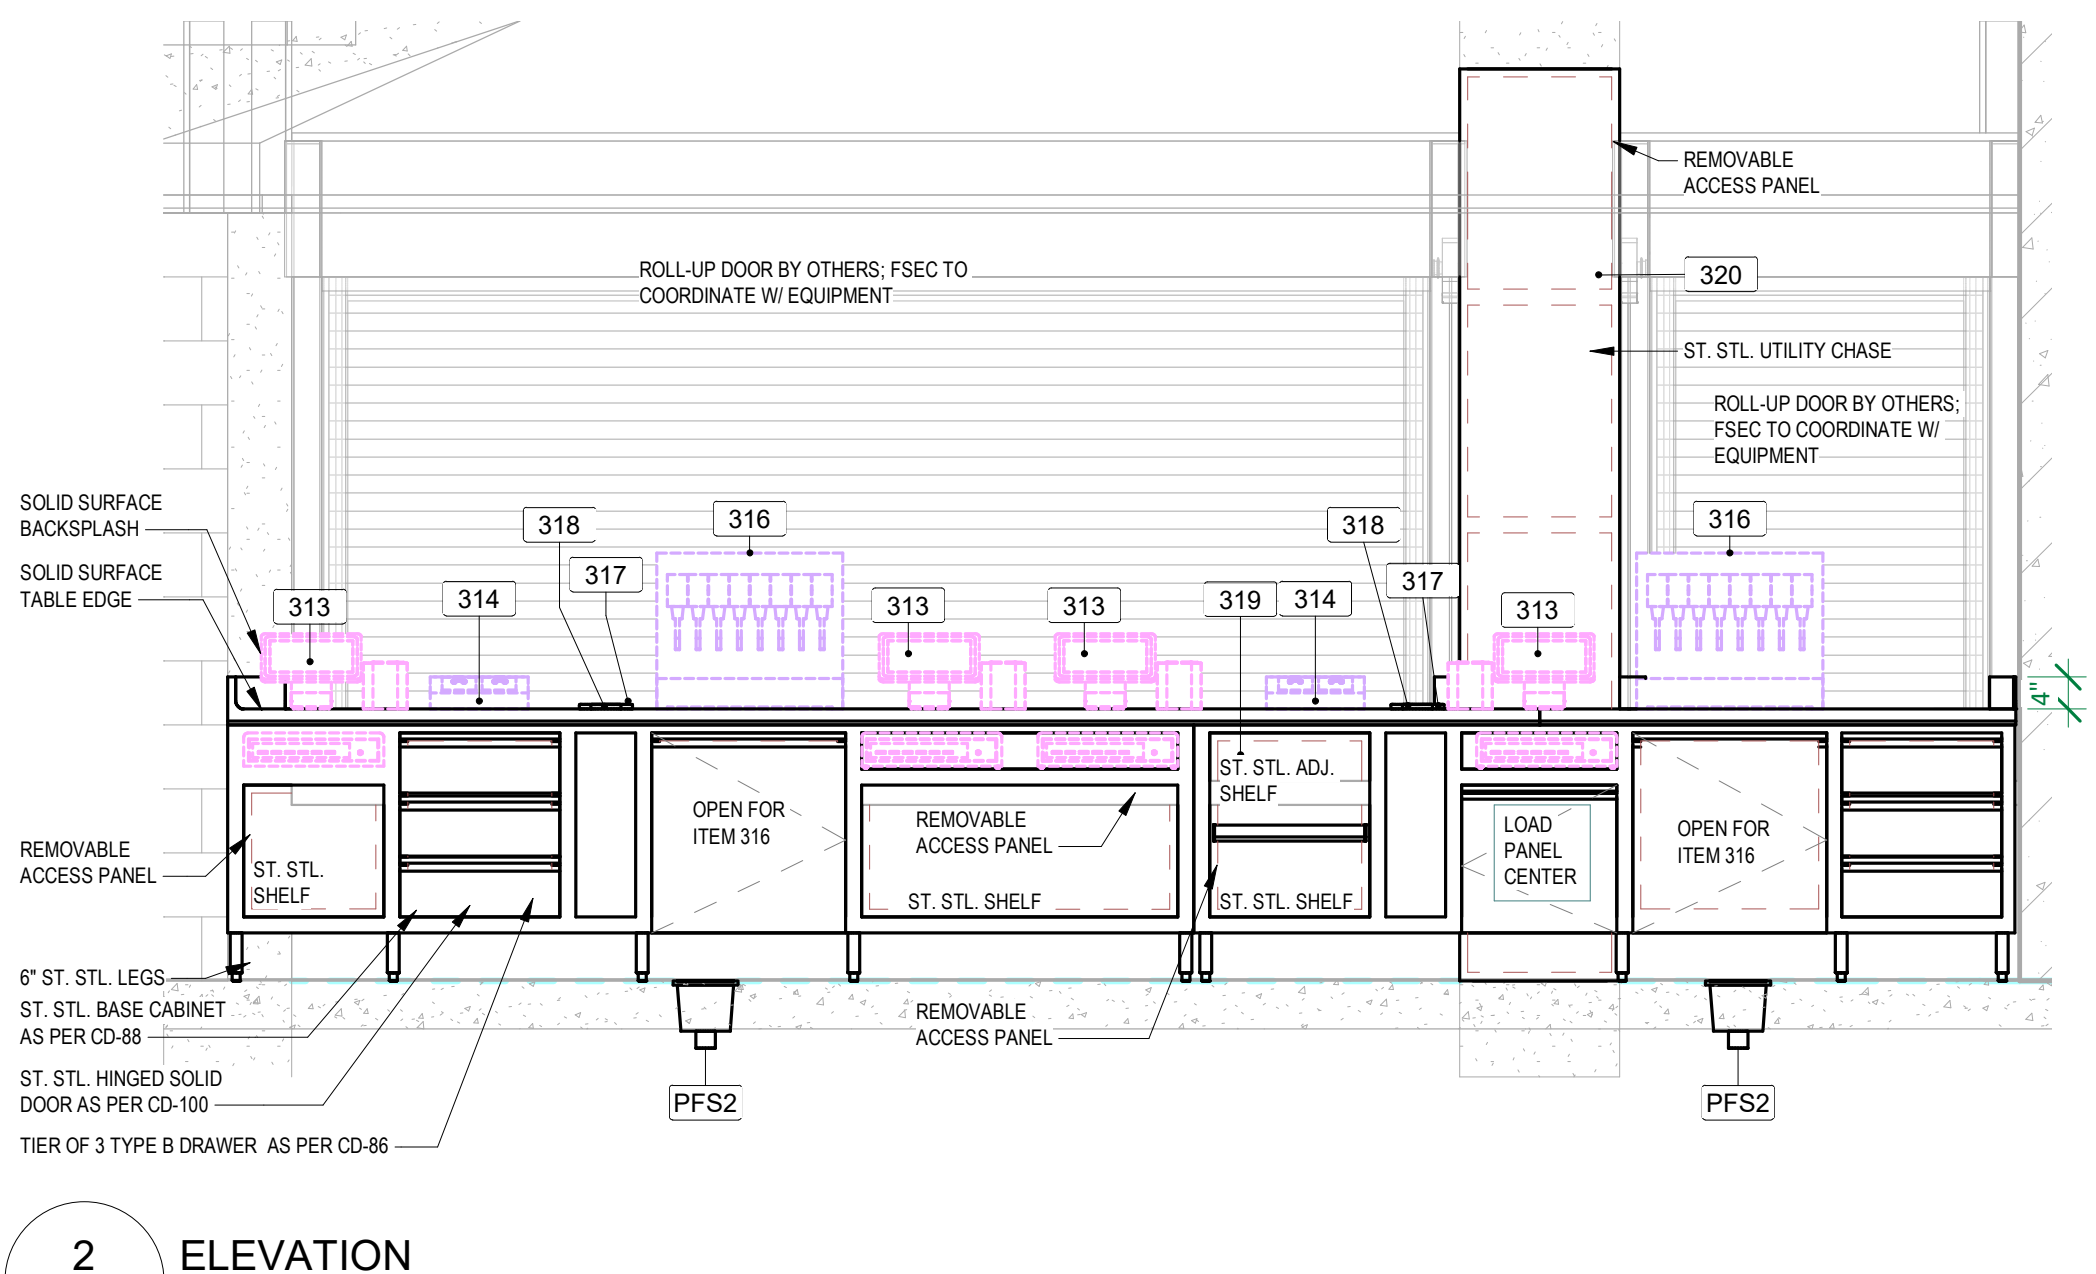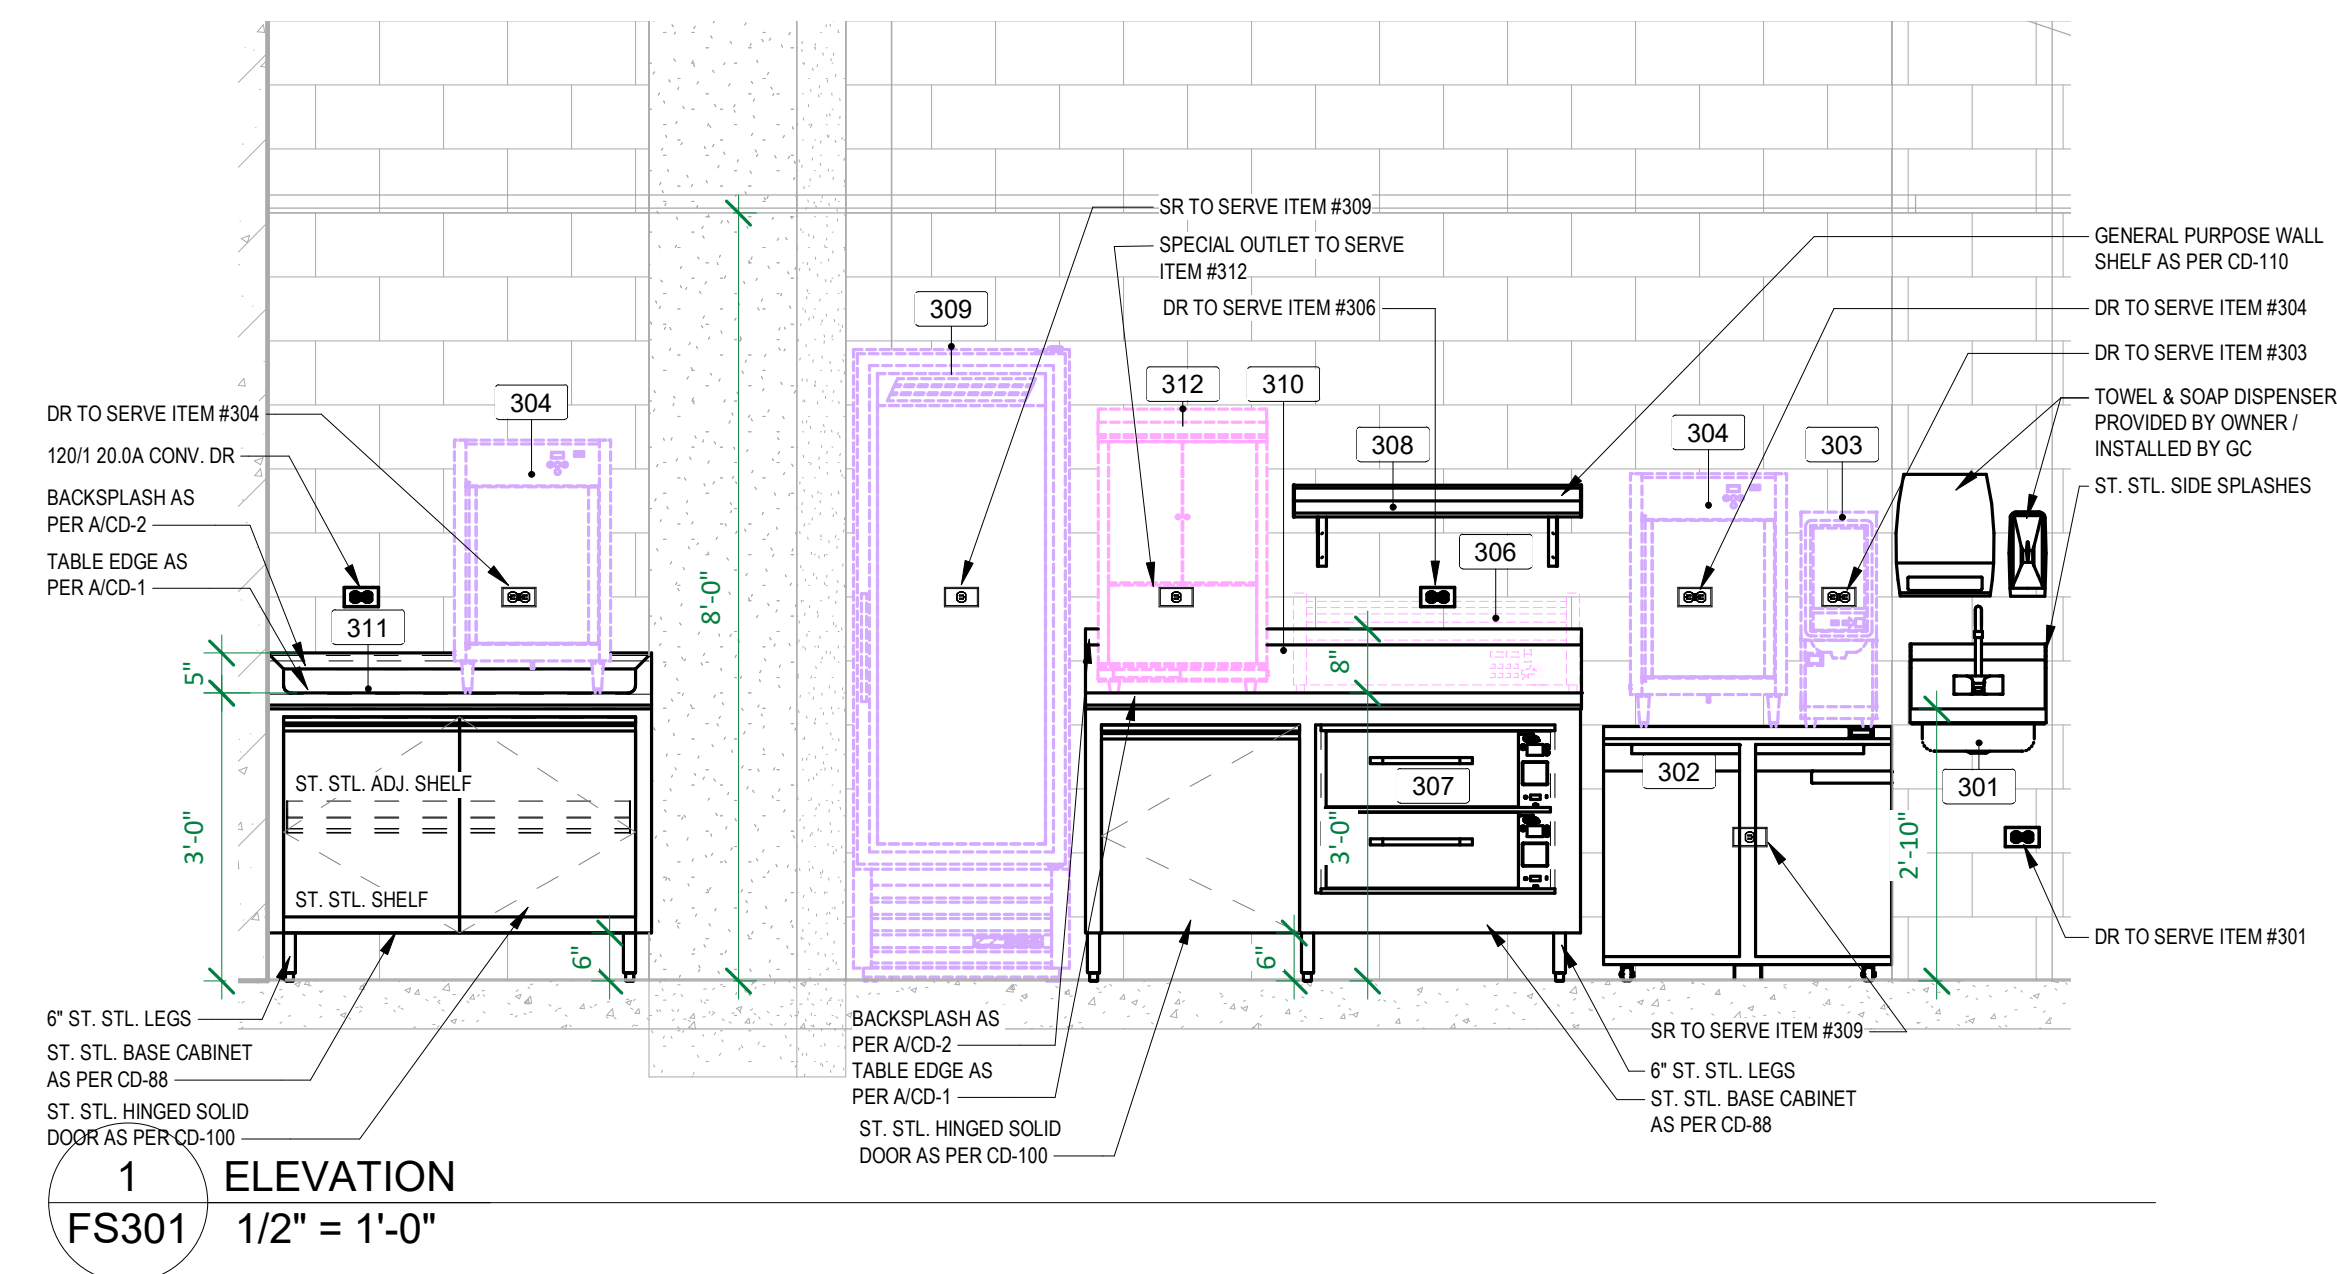

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PROJECT

LA CROSSE CENTER EXPANSION & RENOVATION

LA CROSSE WISCONSIN

REVISION SCHEDULE		
DATE	DESCRIPTION	BY
08/14/2020	PR20	



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REVIEWED BY	DH
ORIGINAL ISSUE DATE	02/06/20
CLIENT PROJECT NO.	


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FOODSERVICE ELEVATIONS


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FS301




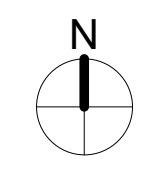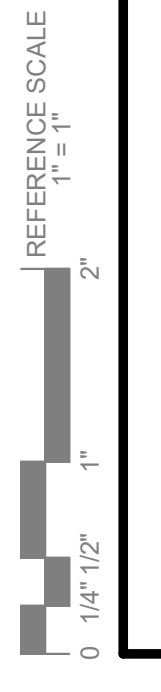


1 ELEVATION
FS302 1/2" = 1'-0"

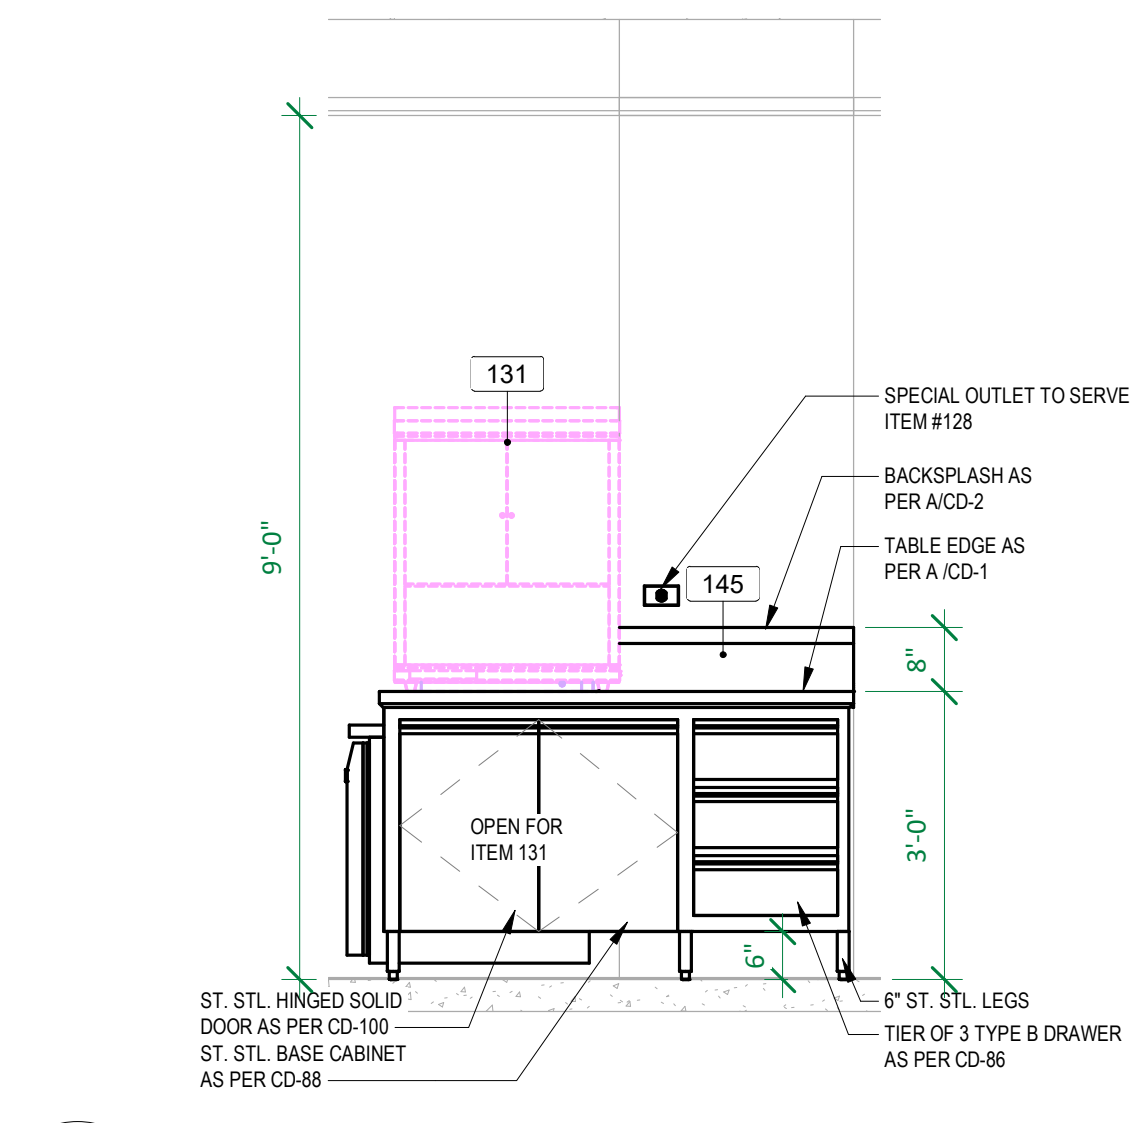

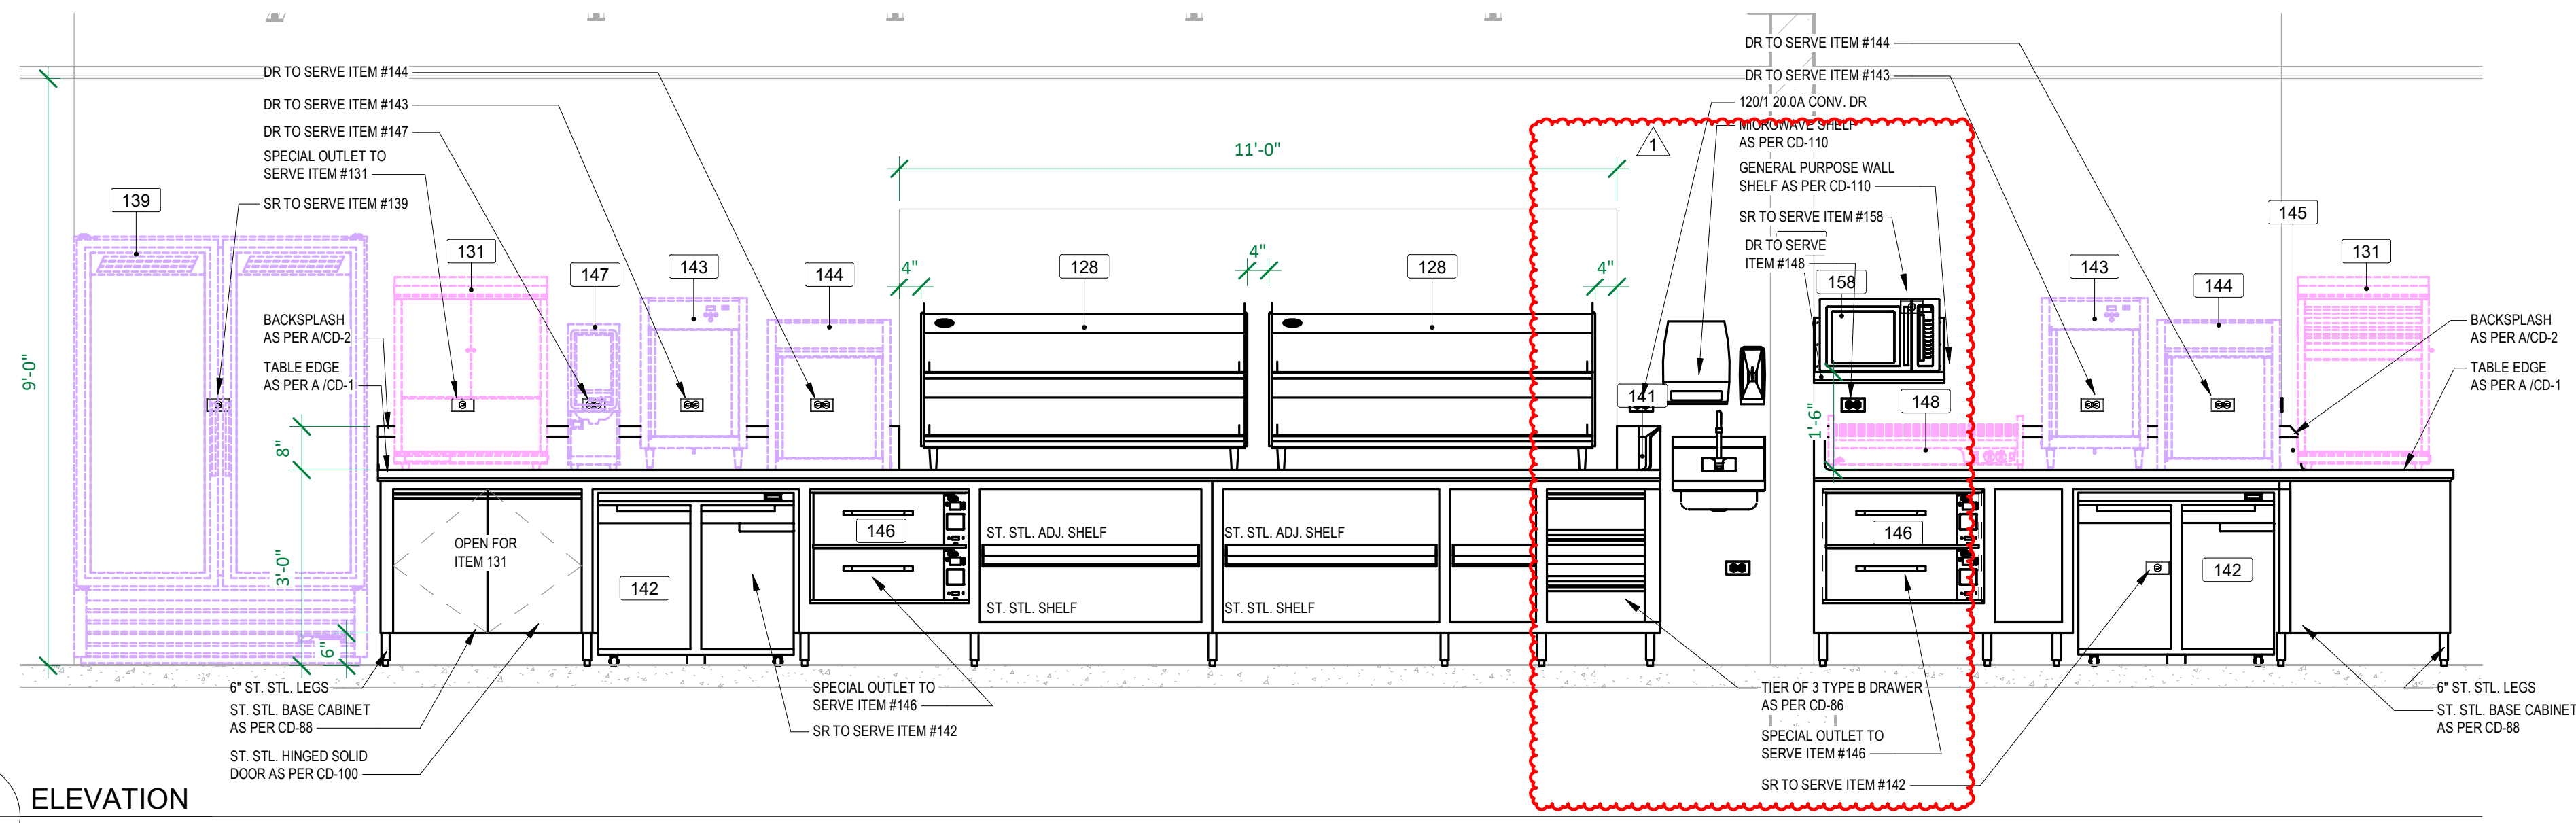2 ELEVATION
FS302 1/2" = 1'-0"

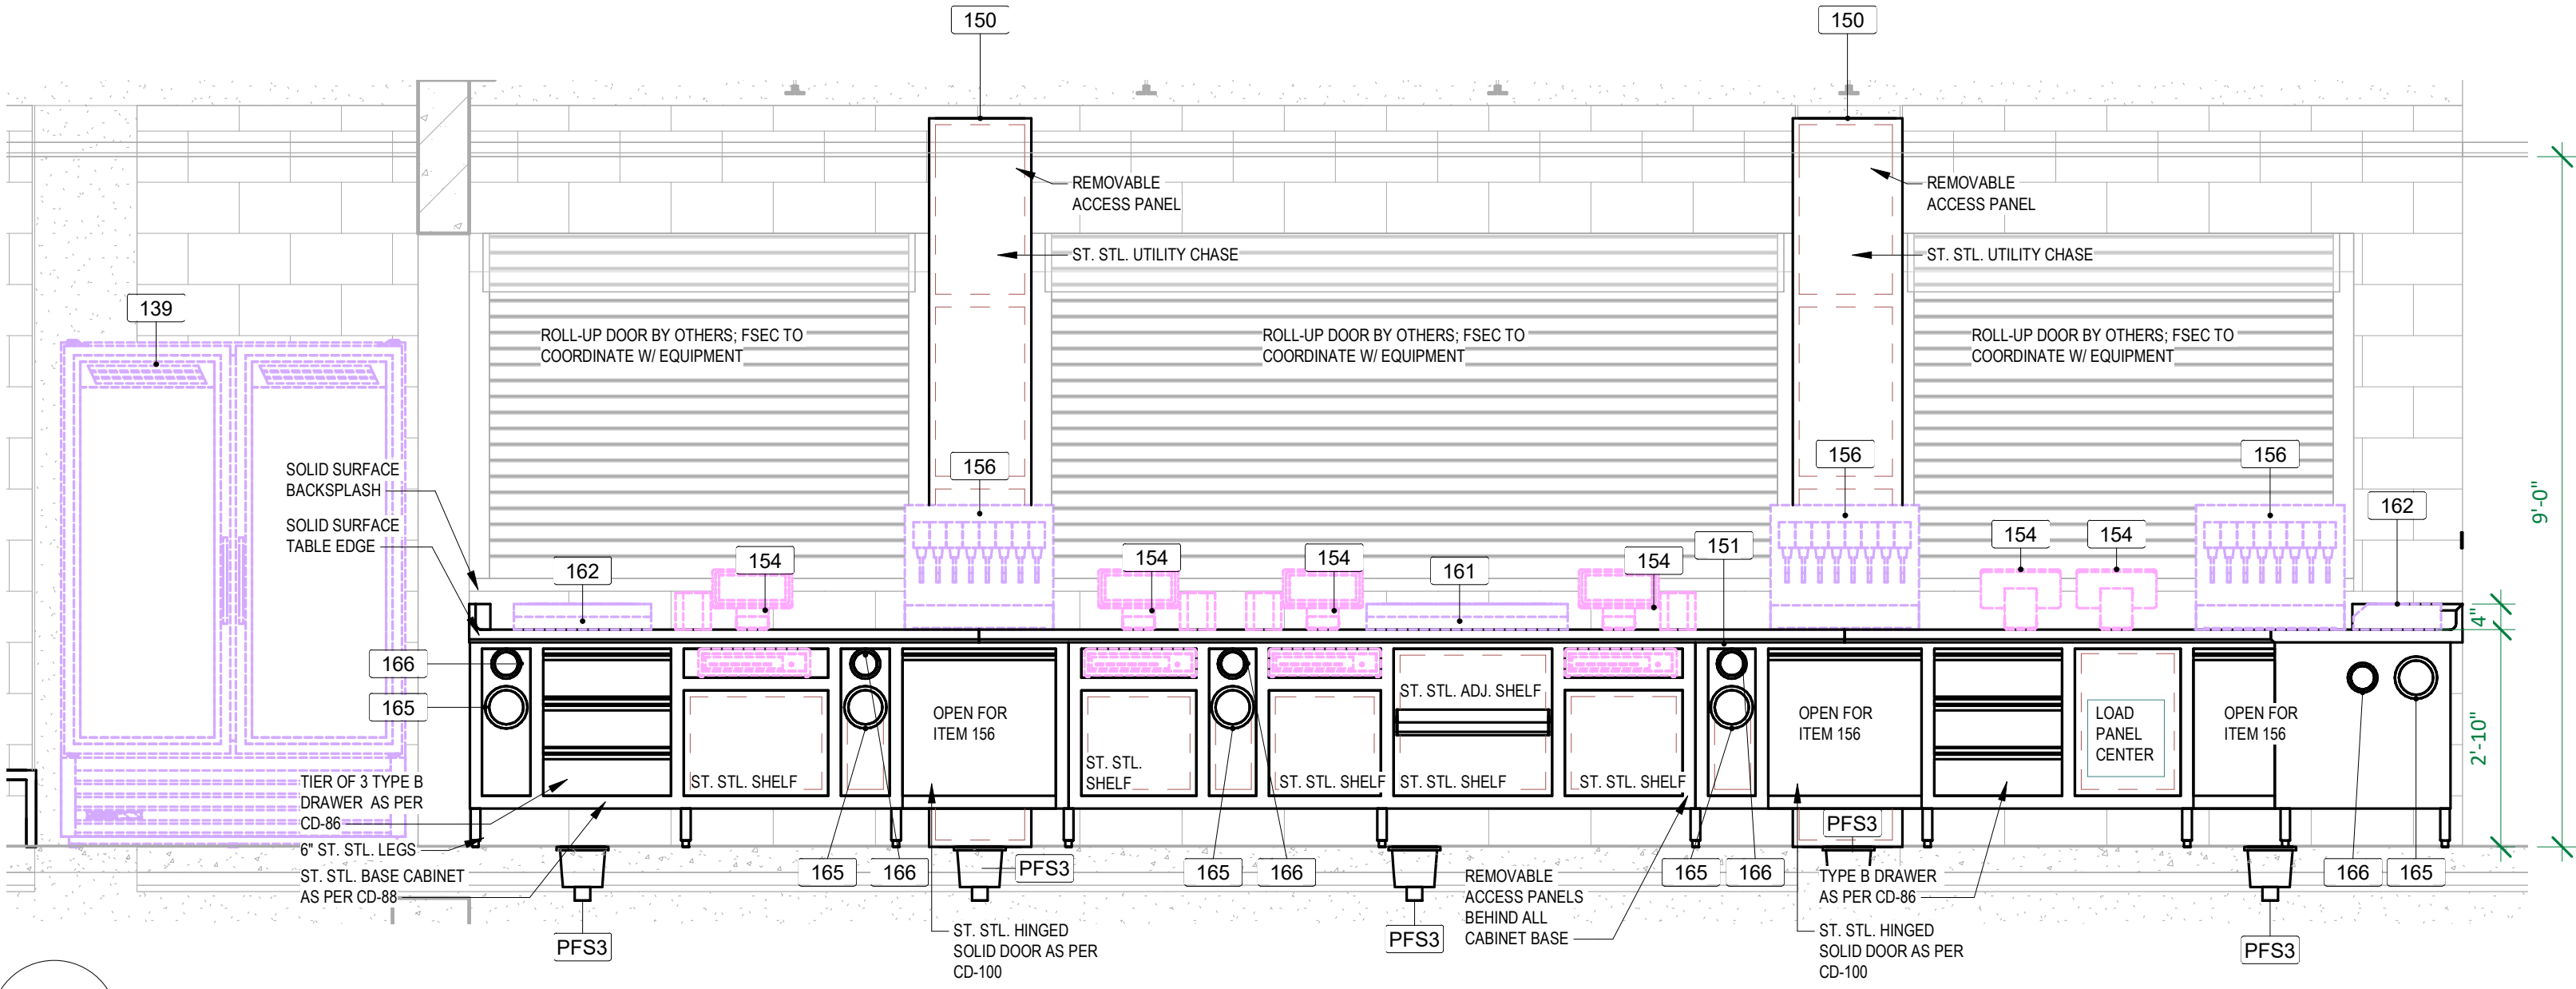

3 ELEVATION
FS302 1/2" = 1'-0"

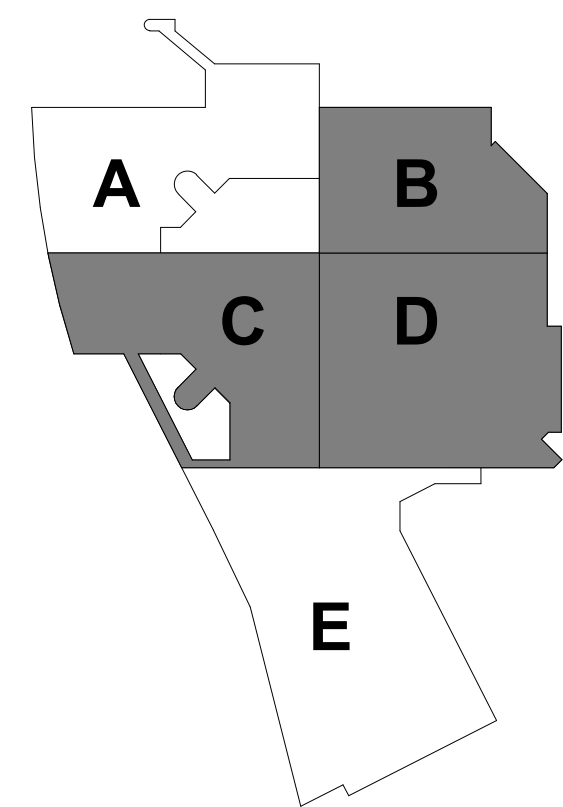

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PROJECT

LA CROSSE CENTER EXPANSION & RENOVATION

LA CROSSE WISCONSIN

REVISION SCHEDULE		
DATE	DESCRIPTION	BY
08/14/2020	PR20	



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FILE NAME	19990 Arch R18.rvt
DRAWN BY	SK
DESIGNED BY	DH
REVIEWED BY	DH
ORIGINAL ISSUE DATE	02/06/20
CLIENT PROJECT NO.	


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FOODSERVICE ELEVATIONS


SHEET

FS302




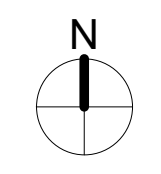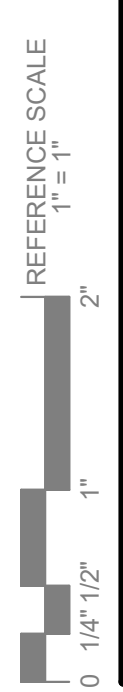

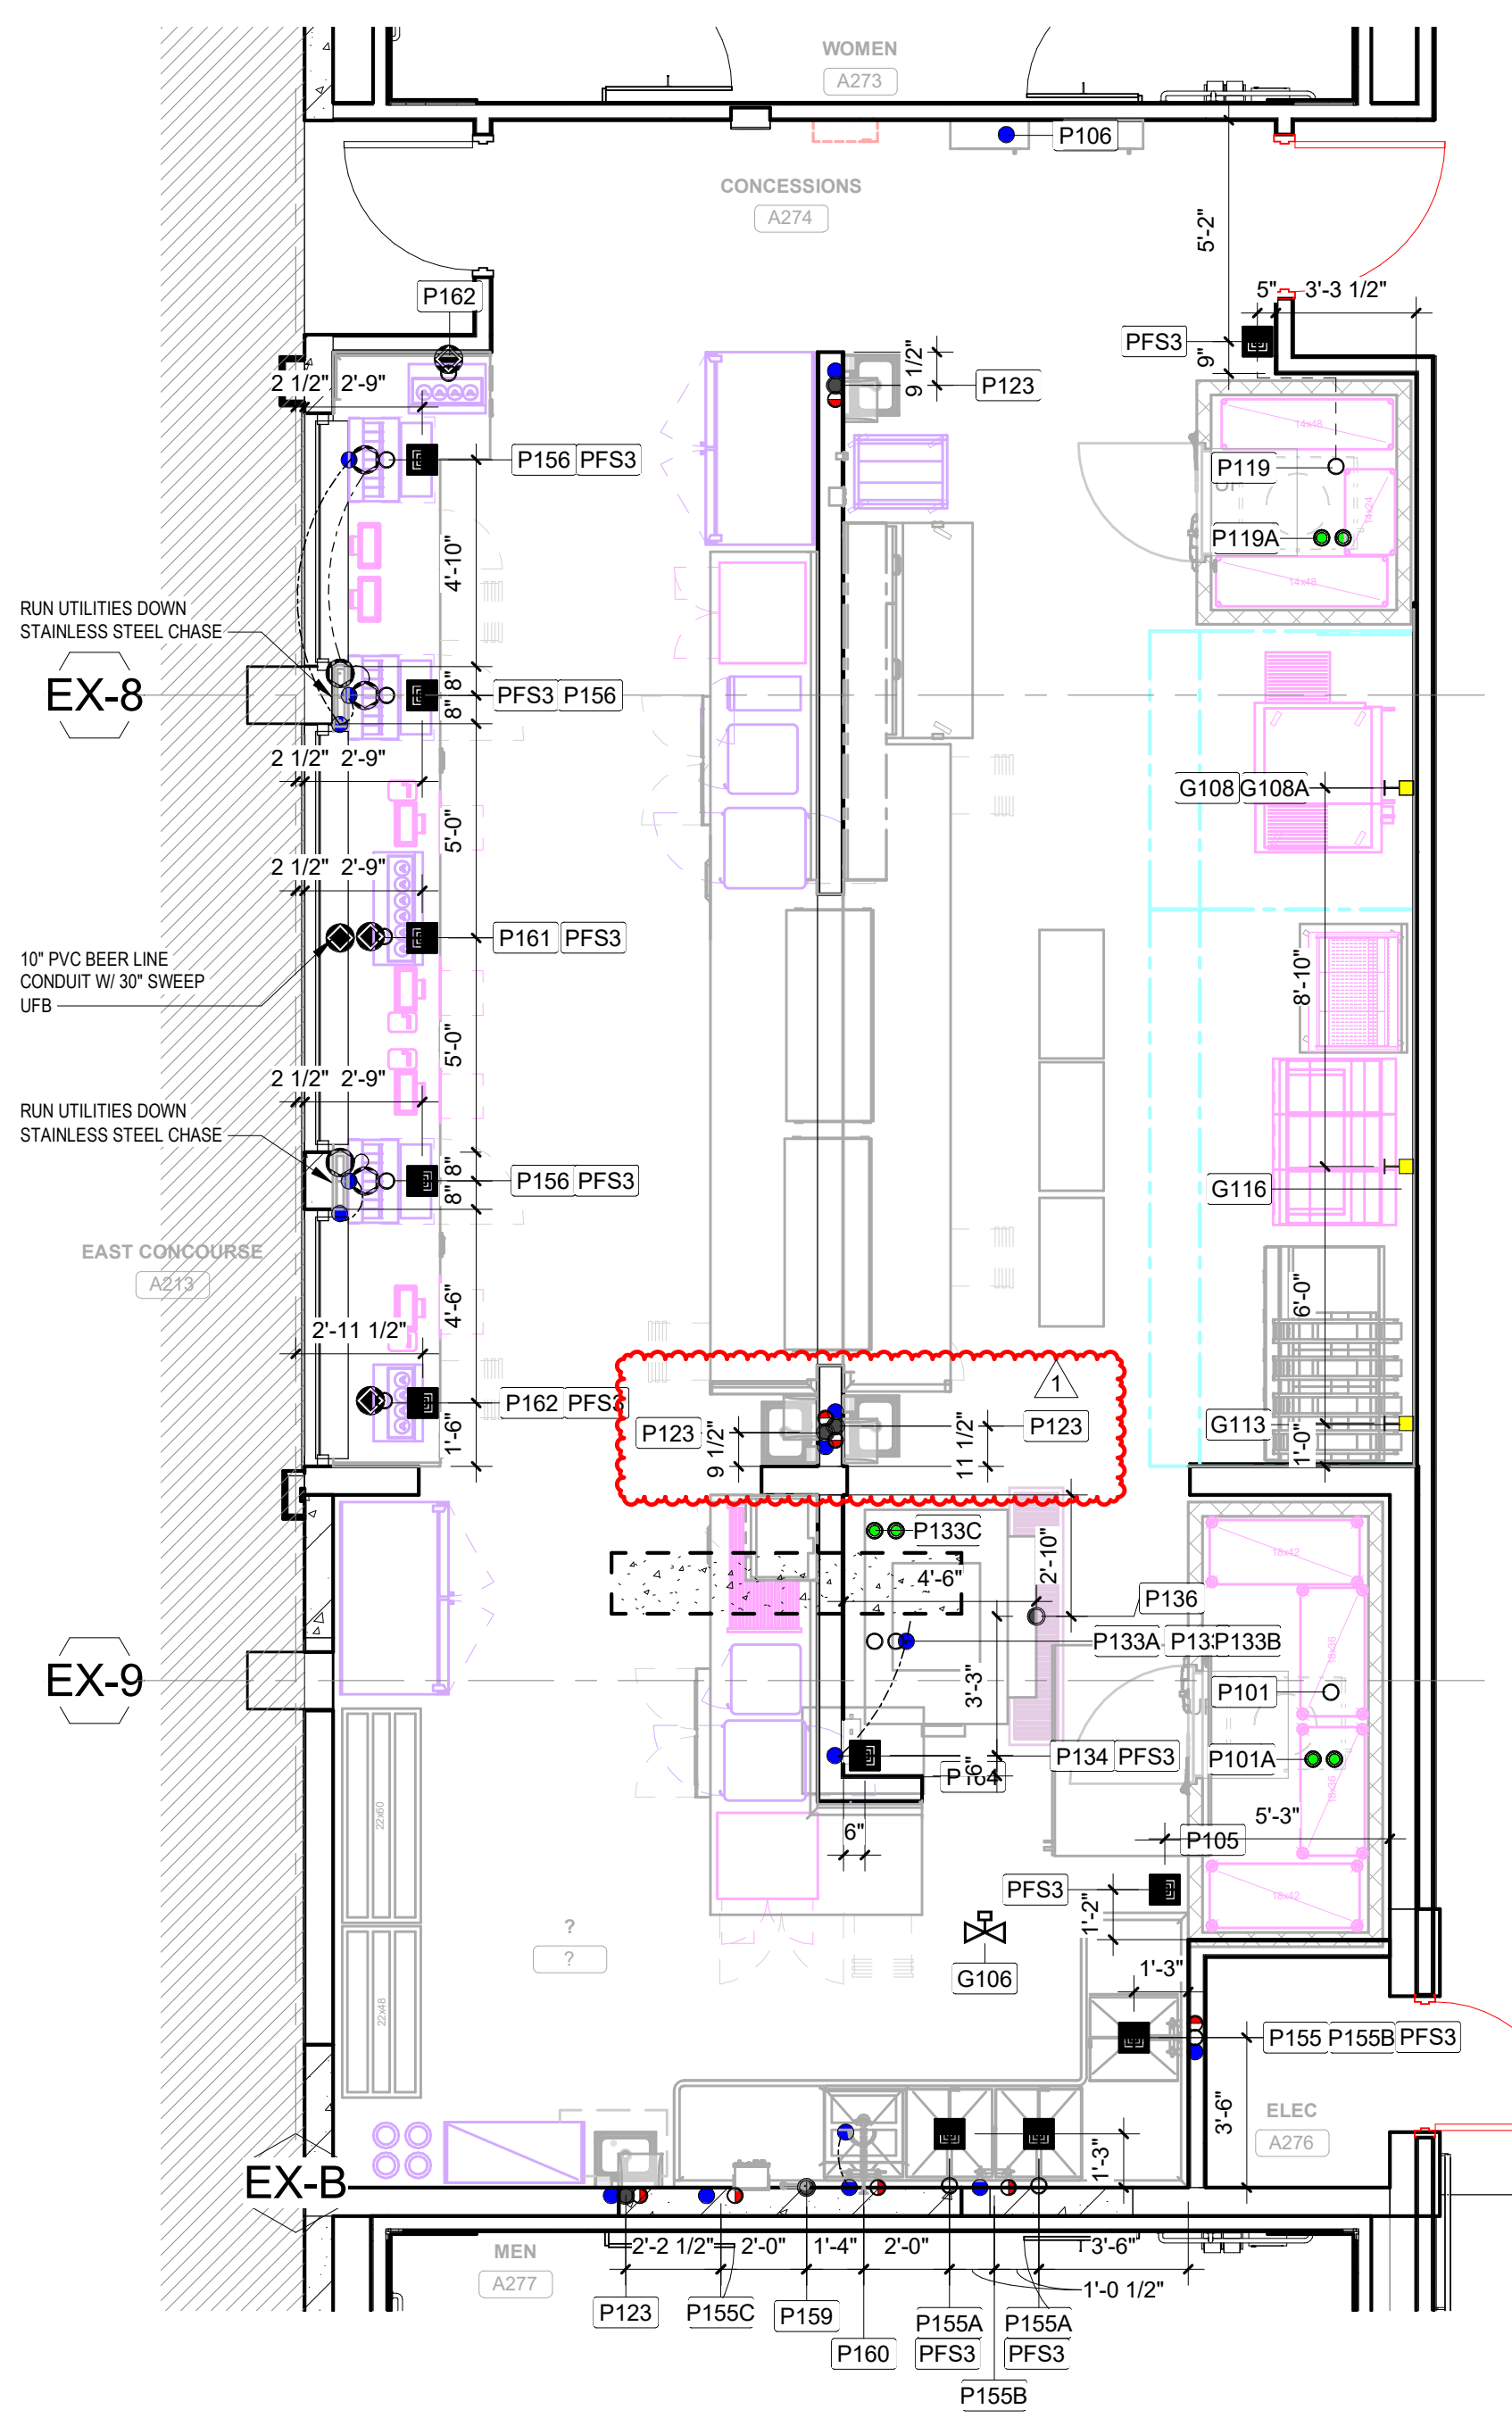
2 FOODSERVICE EQUIPMENT CONCOURSE CONCESSIONS PLB ROUGH-IN PLAN
FS500 1/4" = 1'-0"

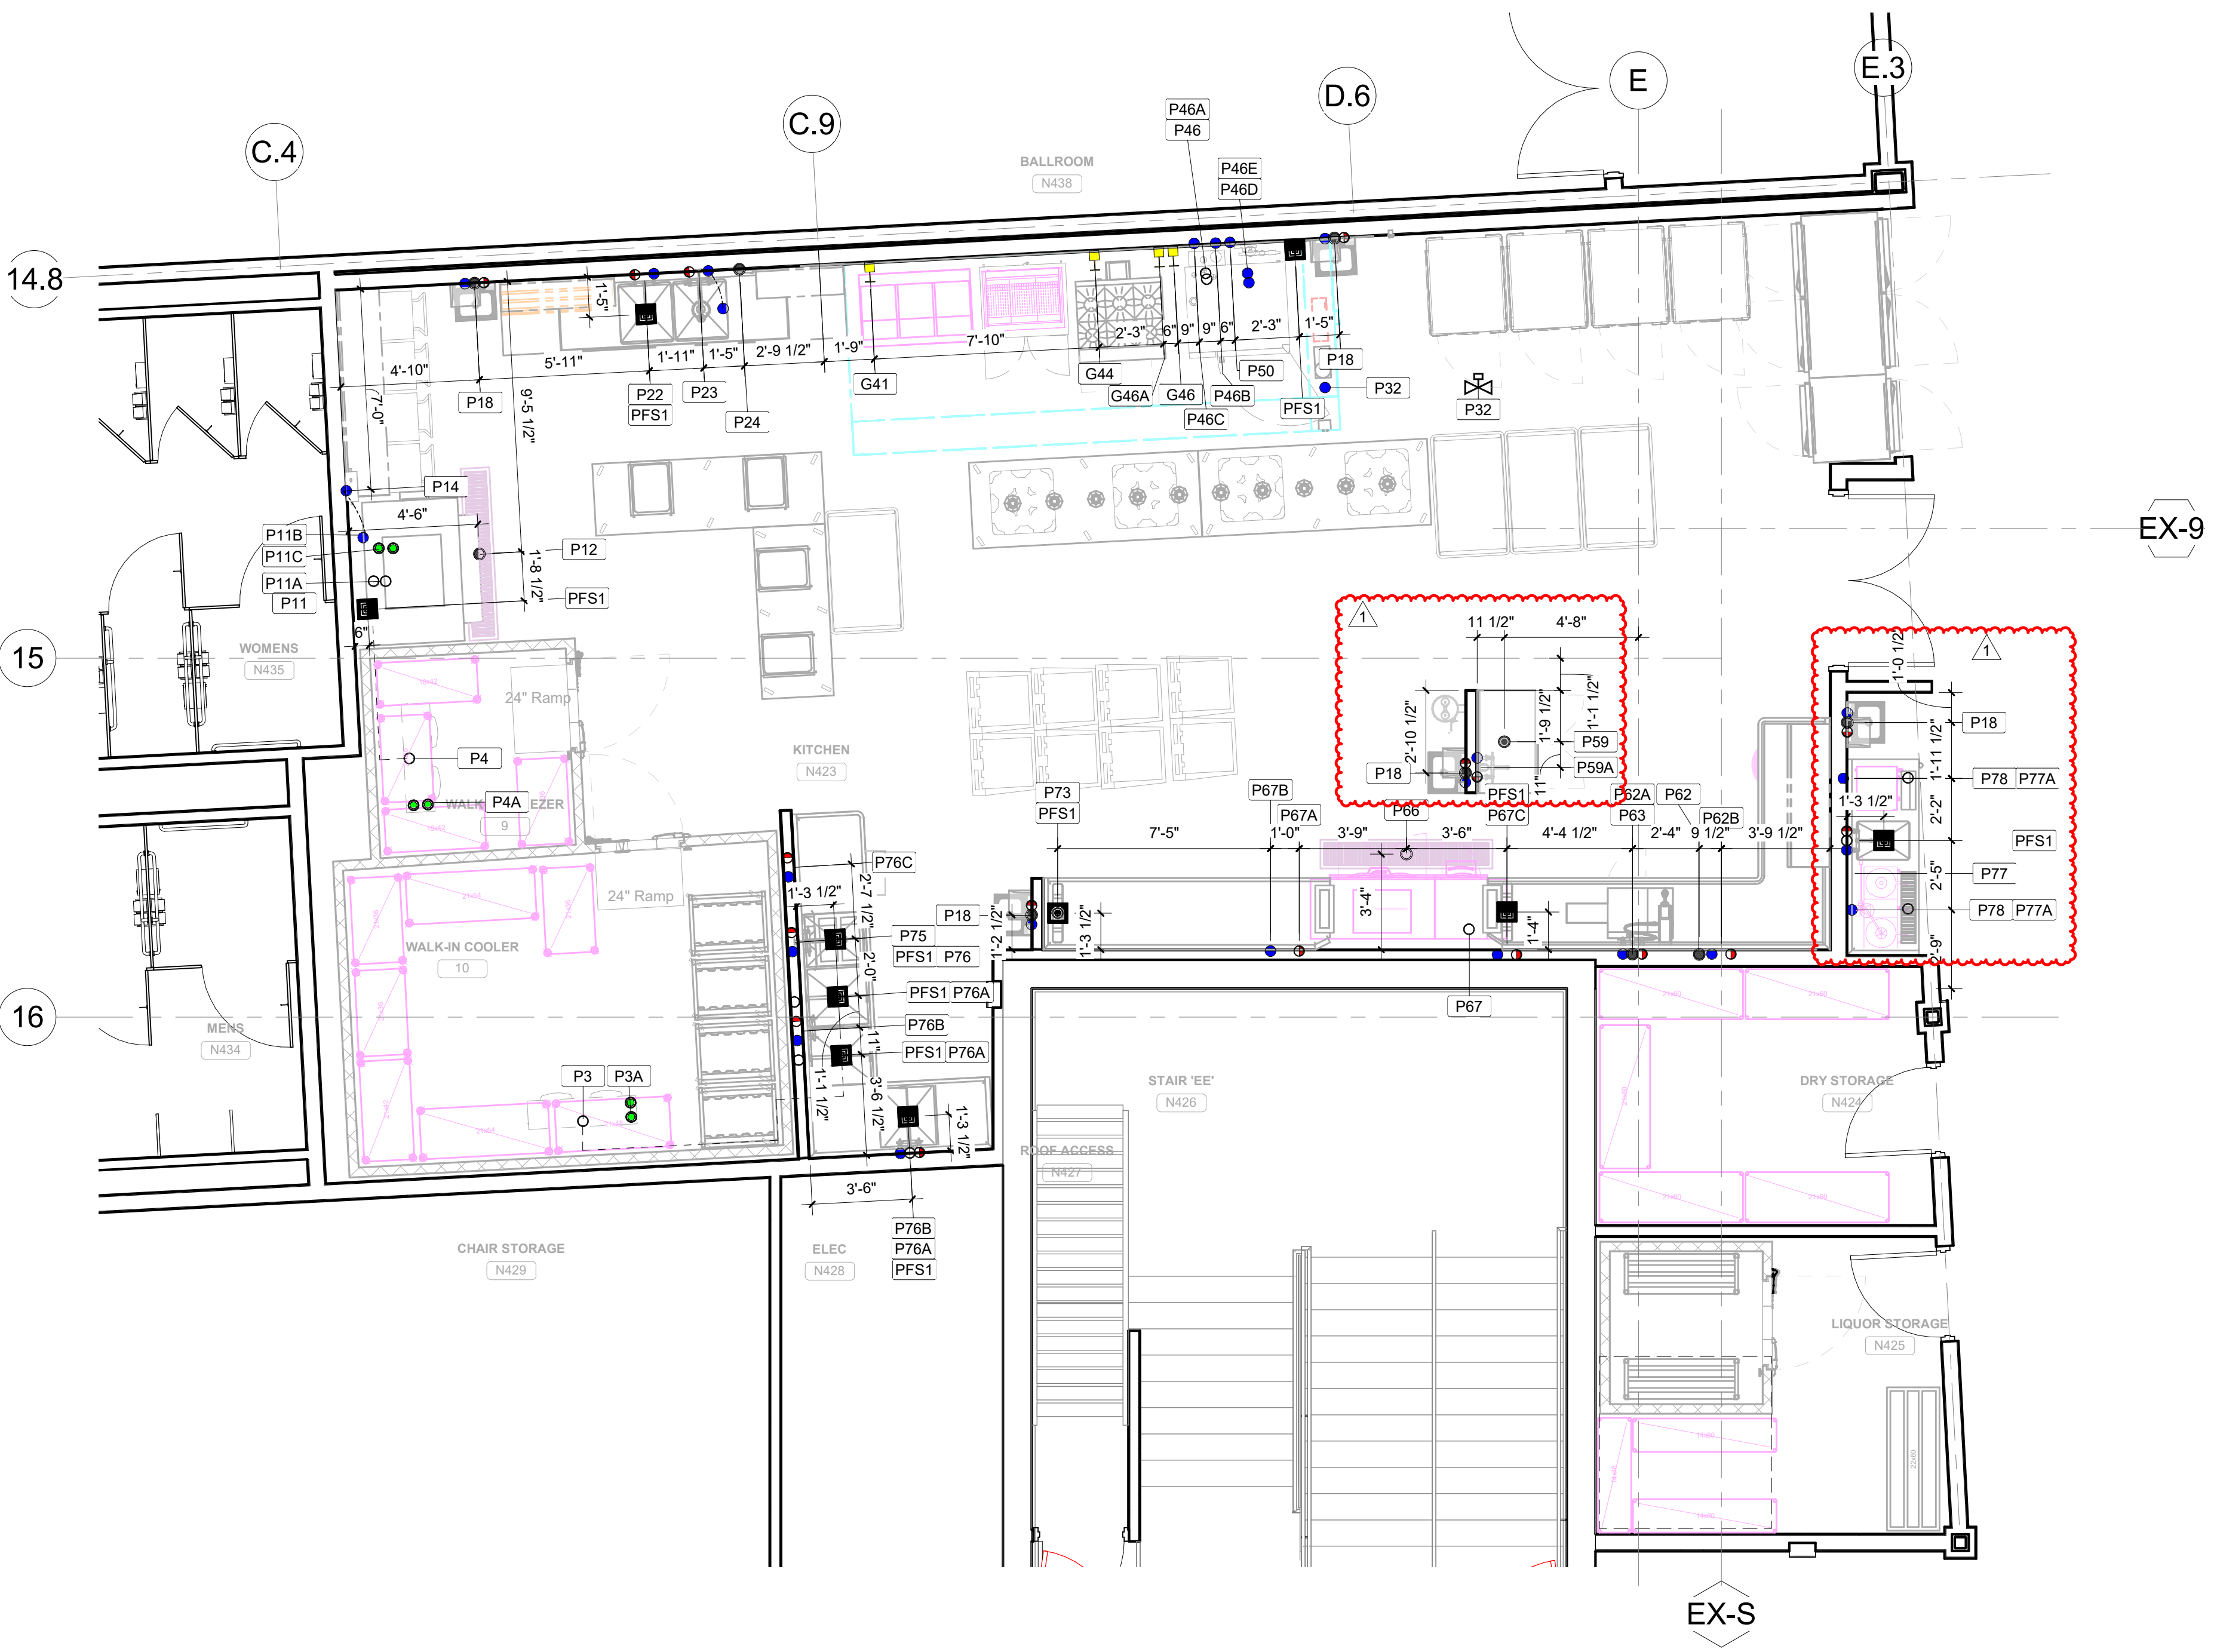


1 FOODSERVICE EQUIPMENT BALLROOM BANQUET KITCHEN PLB ROUGH-IN PLAN
FS500 1/4" = 1'-0"

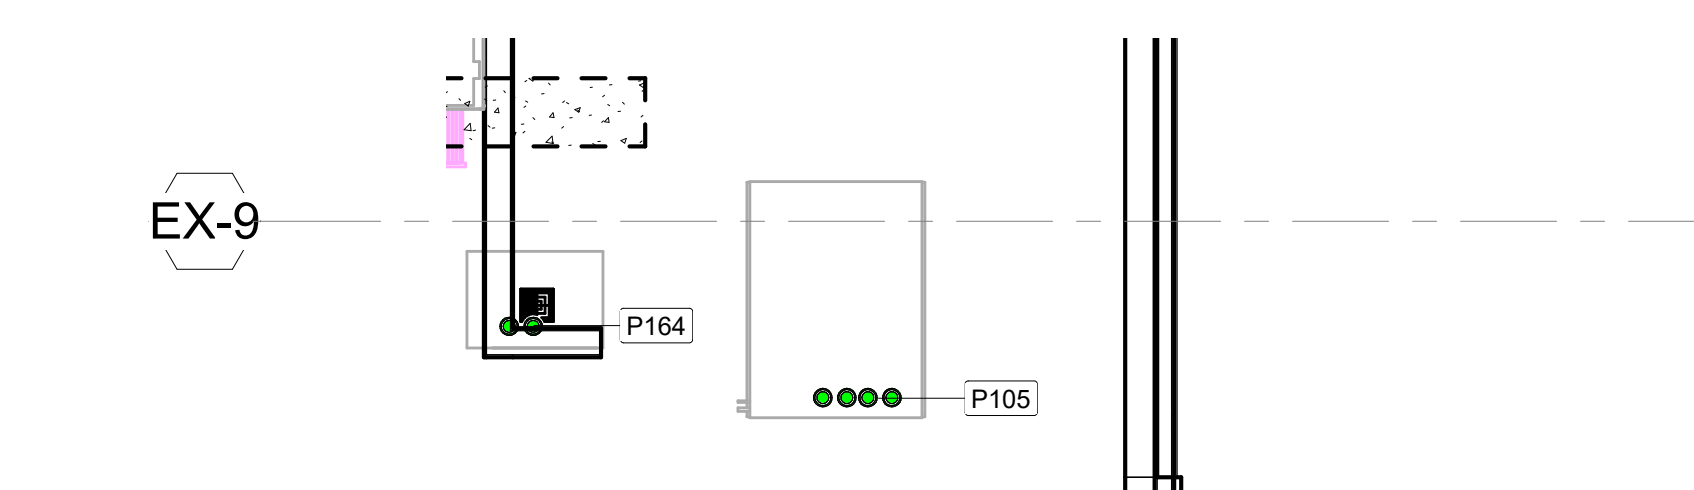

4 FOODSERVICE EQUIPMENT CONCOURSE CONCESSIONS ROOF PLB ROUGH-IN
FS500 1/4" = 1'-0"

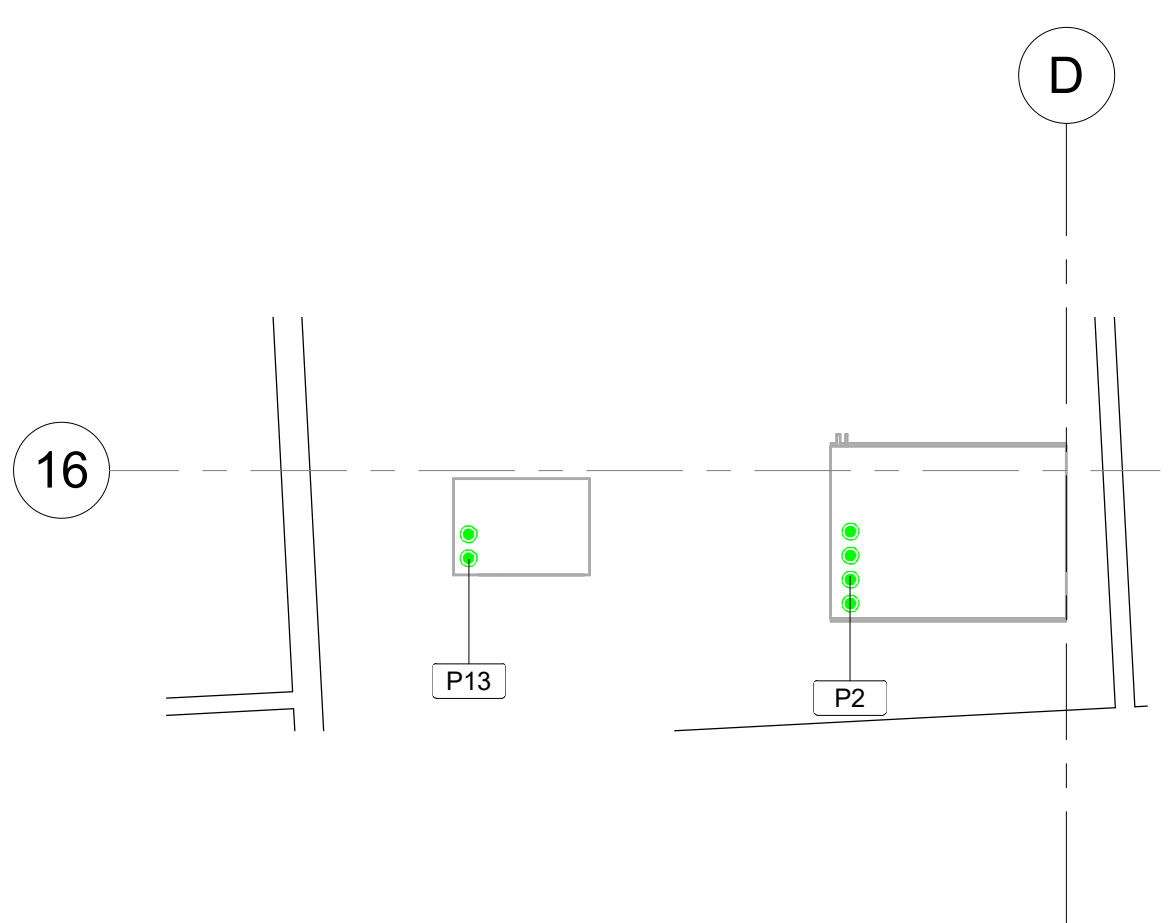

3 FOODSERVICE EQUIPMENT BALLROOM BANQUET KITCHEN PLB ROUGH-IN PLAN
FS500 1/4" = 1'-0"

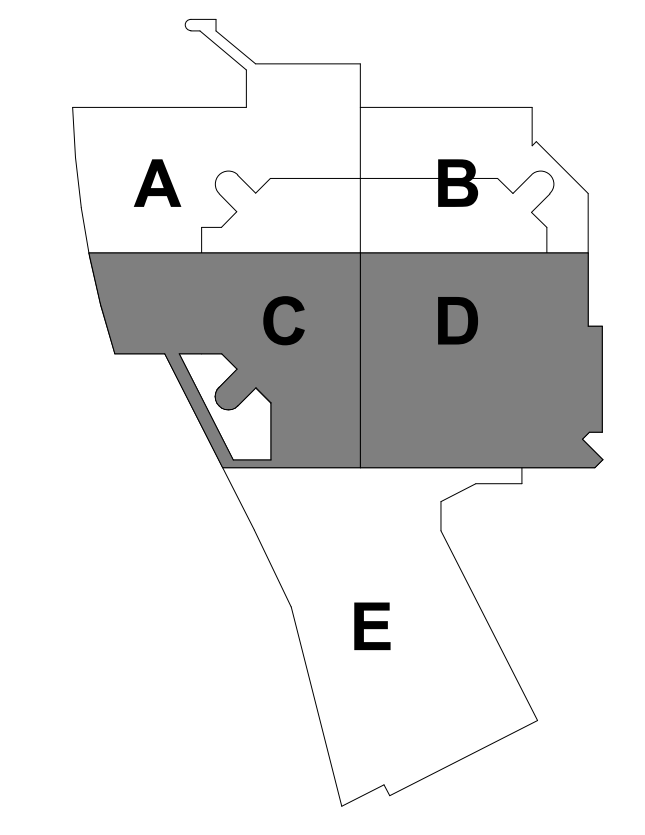

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PROJECT

LA CROSSE CENTER EXPANSION & RENOVATION

LA CROSSE WISCONSIN

REVISION SCHEDULE		
DATE	DESCRIPTION	BY
08/14/2020	PR20	

PROJECT NO.	16-19990
FILE NAME	19990 Arch R18.rvt
DRAWN BY	SK
DESIGNED BY	DH
REVIEWED BY	DH
ORIGINAL ISSUE DATE	02/06/20
CLIENT PROJECT NO.	

TITLE

FOODSERVICE BALLROOM LEVEL & CONCOURSE LEVEL PLUMBING ROUGH-IN PLAN

FS500

- PLUMBING LEGEND**
- INDIRECT WASTE
 - DIRECT WASTE
 - ⊕ FLOOR DRAIN
 - ⊕ FLOOR DRAIN W/ 4" FUNNEL
 - ⊕ FLOOR SINK W/HALF GRATE
 - ⊕ FLOOR SINK W/FULL GRATE
 - ⊕ FLOOR SINK W/NO GRATE
 - ⊕ HUB DRAIN
 - GAS
 - GAS W/ QUICK DISCONNECT
 - REFRIGERATION LINES
 - HOT WATER
 - COLD WATER
 - HOT WATER HOSE BIB
 - COLD WATER HOSE BIB
 - SODA CONDUIT LINE
 - BEER CONDUIT LINE
 - ⊕ MECHANICAL GAS SHUT-OFF VALVE FOR FIRE SYSTEM
 - ⊕ ELECTRIC SOLENOID GAS SHUT-OFF VALVE FOR FIRE SYSTEM
 - STEAM SUPPLY
 - STEAM RETURN
 - A.F.F. ABOVE FINISHED FLOOR
 - B.F.F. BELOW FINISHED FLOOR
 - D.F.A. DOWN FROM ABOVE
 - U.F.B. UP FROM BELOW
 - BEER & SODA LINES
 - REFRIGERATION LINES
 - WATER LINES
 - DRAIN LINES

REFERENCE SCALE
1" = 1'-0"
0 1/4" 1/2" 1" 2"




BALLROOM PLUMBING ROUGH-IN SCHEDULE table with columns: ITEM NO, QTY, DESCRIPTION, DIRECT WASTE, INDIRECT WASTE, COLD WATER, TREATED WATER, HOT WATER, REFRIGERATION, PLUMBING INFORMATION.

CONCOURSE PLUMBING ROUGH-IN SCHEDULE table with columns: ITEM NO, QTY, DESCRIPTION, DIRECT WASTE, INDIRECT WASTE, COLD WATER, TREATED WATER, HOT WATER, REFRIGERATION, PLUMBING INFORMATION.

BALLROOM GAS ROUGH-IN SCHEDULE table with columns: ITEM NO, QTY, DESCRIPTION, SERVICE, GAS REMARKS.

CONCOURSE GAS ROUGH-IN SCHEDULE table with columns: ITEM NO, QTY, DESCRIPTION, SERVICE, GAS REMARKS.

FLOOR SINK PLUMBING ROUGH-IN SCHEDULE table with columns: ITEM NO, QTY, DESCRIPTION, DIRECT WASTE, PLUMBING INFORMATION.

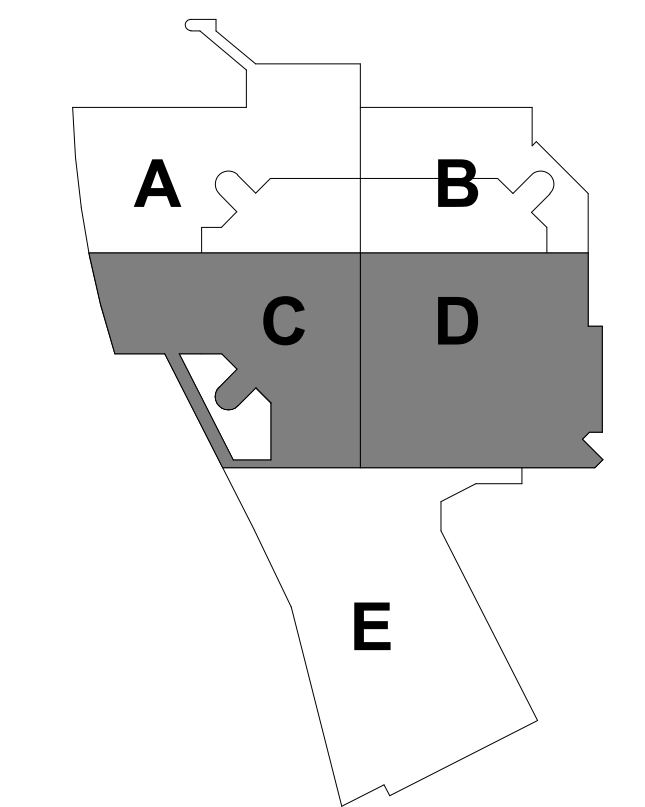

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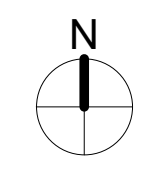
PROJECT
LA CROSSE WISCONSIN
REVISION SCHEDULE
DATE DESCRIPTION BY

PROJECT NO. 16-19990
FILE NAME 19990 Arch R18.rvt
DRAWN BY SK
DESIGNED BY DH
REVIEWED BY DH
ORIGINAL ISSUE DATE 02/06/20

TITLE
FOODSERVICE BALLROOM LEVEL & CONCOURSE LEVEL PLUMBING SCHEDULE & NOTES


SHEET
FS501

REFERENCE SCALE 1"=1'




CONVENIENCE ELECTRICAL ROUGH-IN SCHEDULE										
ITEM NO	QTY	DESCRIPTION	SERVICE				ROUGH-IN		ELECTRICAL INFORMATION	
			VOLTS	PHASE	AMP	CONN. TYPE	OUTLET TYPE	HEIGHT	ABRV	REMARKS & NOTES
ECO1	2	Convenience Outlet - Ballroom Level	120 V	1	20.0 A	Direct	DR	4'-0"	AFF	Convenience Outlet by EC
ECO2	3	Convenience Outlet - Concourse Level	120 V	1	20.0 A	Direct	DR	4'-0"	AFF	Convenience Outlet by EC
ECO3	1	Convenience Outlet - Arena Level	120 V	1	20.0 A	Direct	DR	4'-0"	AFF	Convenience Outlet by EC

BALLROOM ELECTRICAL ROUGH-IN SCHEDULE													
ITEM NO	QTY	DESCRIPTION	VOLTS	PHASE	AMP	SERVICE		OUTLET TYPE	NEMA	ROUGH-IN		ELECTRICAL INFORMATION	
						CONN. TYPE	CD			HEIGHT	ABRV	REMARKS & NOTES	
E1	1	Walk-in Cooler / Freezer Box	120 V	1	20.0 A	Direct				8'-6"	DFA	CD-717-FS800	Note 7
E2	1	Roof Top Refrigeration Unit	208 V	3	30.0 A	Direct				0"		CD-716-FS800	
E3	1	Cooler Coil	120 V	1	2.0 A	Direct				9'-6"	DFA	CD-711 & CD-717 - FS800	Note 7
E4	1	Freezer Coil	208 V	1	8.9 A	Direct				8'-6"	DFA	CD-711 & CD-717-FS801	Note 7
E11	1	Ice Machine w/ Bin and Transport Cart	120 V	1	1.1 A	Cord & Plug		Special Connection		8'-6"	AFF		Cord & Plug by EC
E11A	1	Ice Machine w/ Bin and Transport Cart - Cleaning System	120 V	1	0.5 A	Direct		DR		0"	AFF		Elec drawn directly from ice machine
E13	1	Ice Machine Remote Condenser	208 V	3	2.0 A	Direct				0"			
E18	5	Hand Sink w/ Faucet	120 V	1	20.0 A	Cord & Plug		DR	5-15P	1'-6"	AFF	CD-570-FS800	
E24	1	Disposer w/ Controls & Offset Chute	208 V	3	6.6 A	Direct				1'-2"	AFF	CD-706-FS800	Note 5
E29	1	Cooking Exhaust Hood	120 V	1	15.0 A	Direct				9'-6"	DFA	CD-601-FS800	Serviced Thru E31 Hood Control Panel / Note 3 & 8
E29A	2	Cooking Exhaust Hood - Duct Sensor	0 V	0	0.0 A	Low Voltage				0"	DFA		
E31	1	Hood Control Touch Screen (CASHMI)	0 V	0	0.0 A	Control Wiring				9'-6"	DFA		
E32A	1	Fire Suppression System - Dry Contactor	0 V	0	0.0 A					0"		CD-700-FS800	Dry contactor to shunt trip breaker by EC / Note 3
E32B	1	Fire Suppression System - Gas Valve	120 V	0	0.0 A	Direct				0"		CD-700-FS800	To gas shut off valve / Note 4A
E32C	1	Fire Suppression System - Building Alarm	0 V	0	0.0 A					0"		CD-700-FS800	Building Alarm to dry contactor in fire panel, by EC / Note 2
E32D	1	Fire Suppression System - Remote Manual Pull	0 V	0	0.0 A					0"		CD-700-FS800	Remote Manual Pull Station / Note 4A
E32E	1	Fire Suppression System - Gas Reset Station	0 V	0	0.0 A					0"		CD-700-FS800	Gas reset station provided by FSEC, as per documents
E32F	1	Fire Suppression System - Fire Microswitch	0 V	0	0.0 A					0"		CD-700-FS800	From Exx control panel, for Fire system microswitch
E33	1	Hood Control Box - Heat Sensor Elec. Package	120 V	1	15.0 A	Direct				8'-10"	DFA	CD-700-FS800	
E34	1	Room Temperature Sensor	0 V	0	0.0 A	Control Wiring				4'-6"	AFF		2-Gang J-box & 3/4" Conduit above ceiling
E41	1	Three Fryer Battery	120 V	1	2.0 A	Cord & Plug		DR	5-15P	2'-6"	AFF		Note 3, 4 & 6
E42	1	French Fry Warmer	208 V	1	20.6 A	Cord & Plug		Special Outlet		2'-6"	AFF		Note 3, 4 & 6
E43	1	Undercounter Freezer	120 V	1	8.1 A	Cord & Plug		SR	5-15P	1'-6"	AFF		Note 3 & 4
E44	1	36" Range - 6 Burners - Convection Oven	120 V	1	4.0 A	Cord & Plug		DR	5-15P	2'-6"	AFF		Note 3 & 4
E46	1	Double Stacked Combi Oven	208 V	1	15.0 A	Cord & Plug		Special Outlet		4'-0"	AFF		Note 3 & 4
E46A	1	Double Stacked Combi Oven - Bottom	208 V	1	15.0 A	Cord & Plug		Special Outlet		2'-6"	AFF		Note 3 & 4
E49	10	Decorative Heat Lamp	120 V	1	15.6 A	Direct				9'-0"	DFA		Remote Switch / Track type lights on track system
E52	4	Holding & Transport Cabinet	120 V	1	12.0 A	Cord & Plug		SR	5-15P	4'-0"	AFF		
E54	1	Two Section Roll Thru Refrigerator	120 V	1	13.4 A	Cord & Plug		SR	5-20P	7'-6"	AFF		
E55	1	One Section Roll Thru Refrigerator	120 V	1	11.6 A	Cord & Plug		SR	5-15P	7'-6"	AFF		
E62	1	Pot & Pan Scrap Master	208 V	3	12.6 A	Direct				1'-2"	AFF		
E64	1	Walk-in Cooler Box & Refrigeration System	120 V	1	20.0 A	Direct				8'-6"	DFA	CD-717	Note 7
E64A	1	Walk-in Cooler Box - Refrigeration	120 V	1	14.3 A	Cord & Plug		DR	5-20P	9'-6"	AFF		
E67	1	Dishmachine w/ Booster Heater	208 V	3	88.0 A	Direct				1'-2"	AFF		One point connection for booster heat & machine / Note 6
E67A	1	Dishmachine w/ Booster Heater - Vent Fan	0 V	0	0.0 A	Control Wiring				6'-6"	AFF		Control Wiring by EC to Vent Fan / Note 6
E67B	1	Dishmachine w/ Booster Heater - Limit Switch	0 V	0	0.0 A	Control Wiring				6'-6"	AFF		Control Wiring by EC to clean dishtable limit switch / Note 6
E67C	1	Dishmachine w/ Booster Heater- Limit Switch Jbox	0 V	0	0.0 A	J-Box				2'-6"	AFF		J-box for clean dishtable limit switch by EC to E67B / Note 6
E78	2	Coffee Maker w/ water Filter	120,208 V	1	28.6 A	Cord & Plug		Special Outlet		4'-0"	AFF		requires 3 wires plus ground rated 240v single phase / Note 6

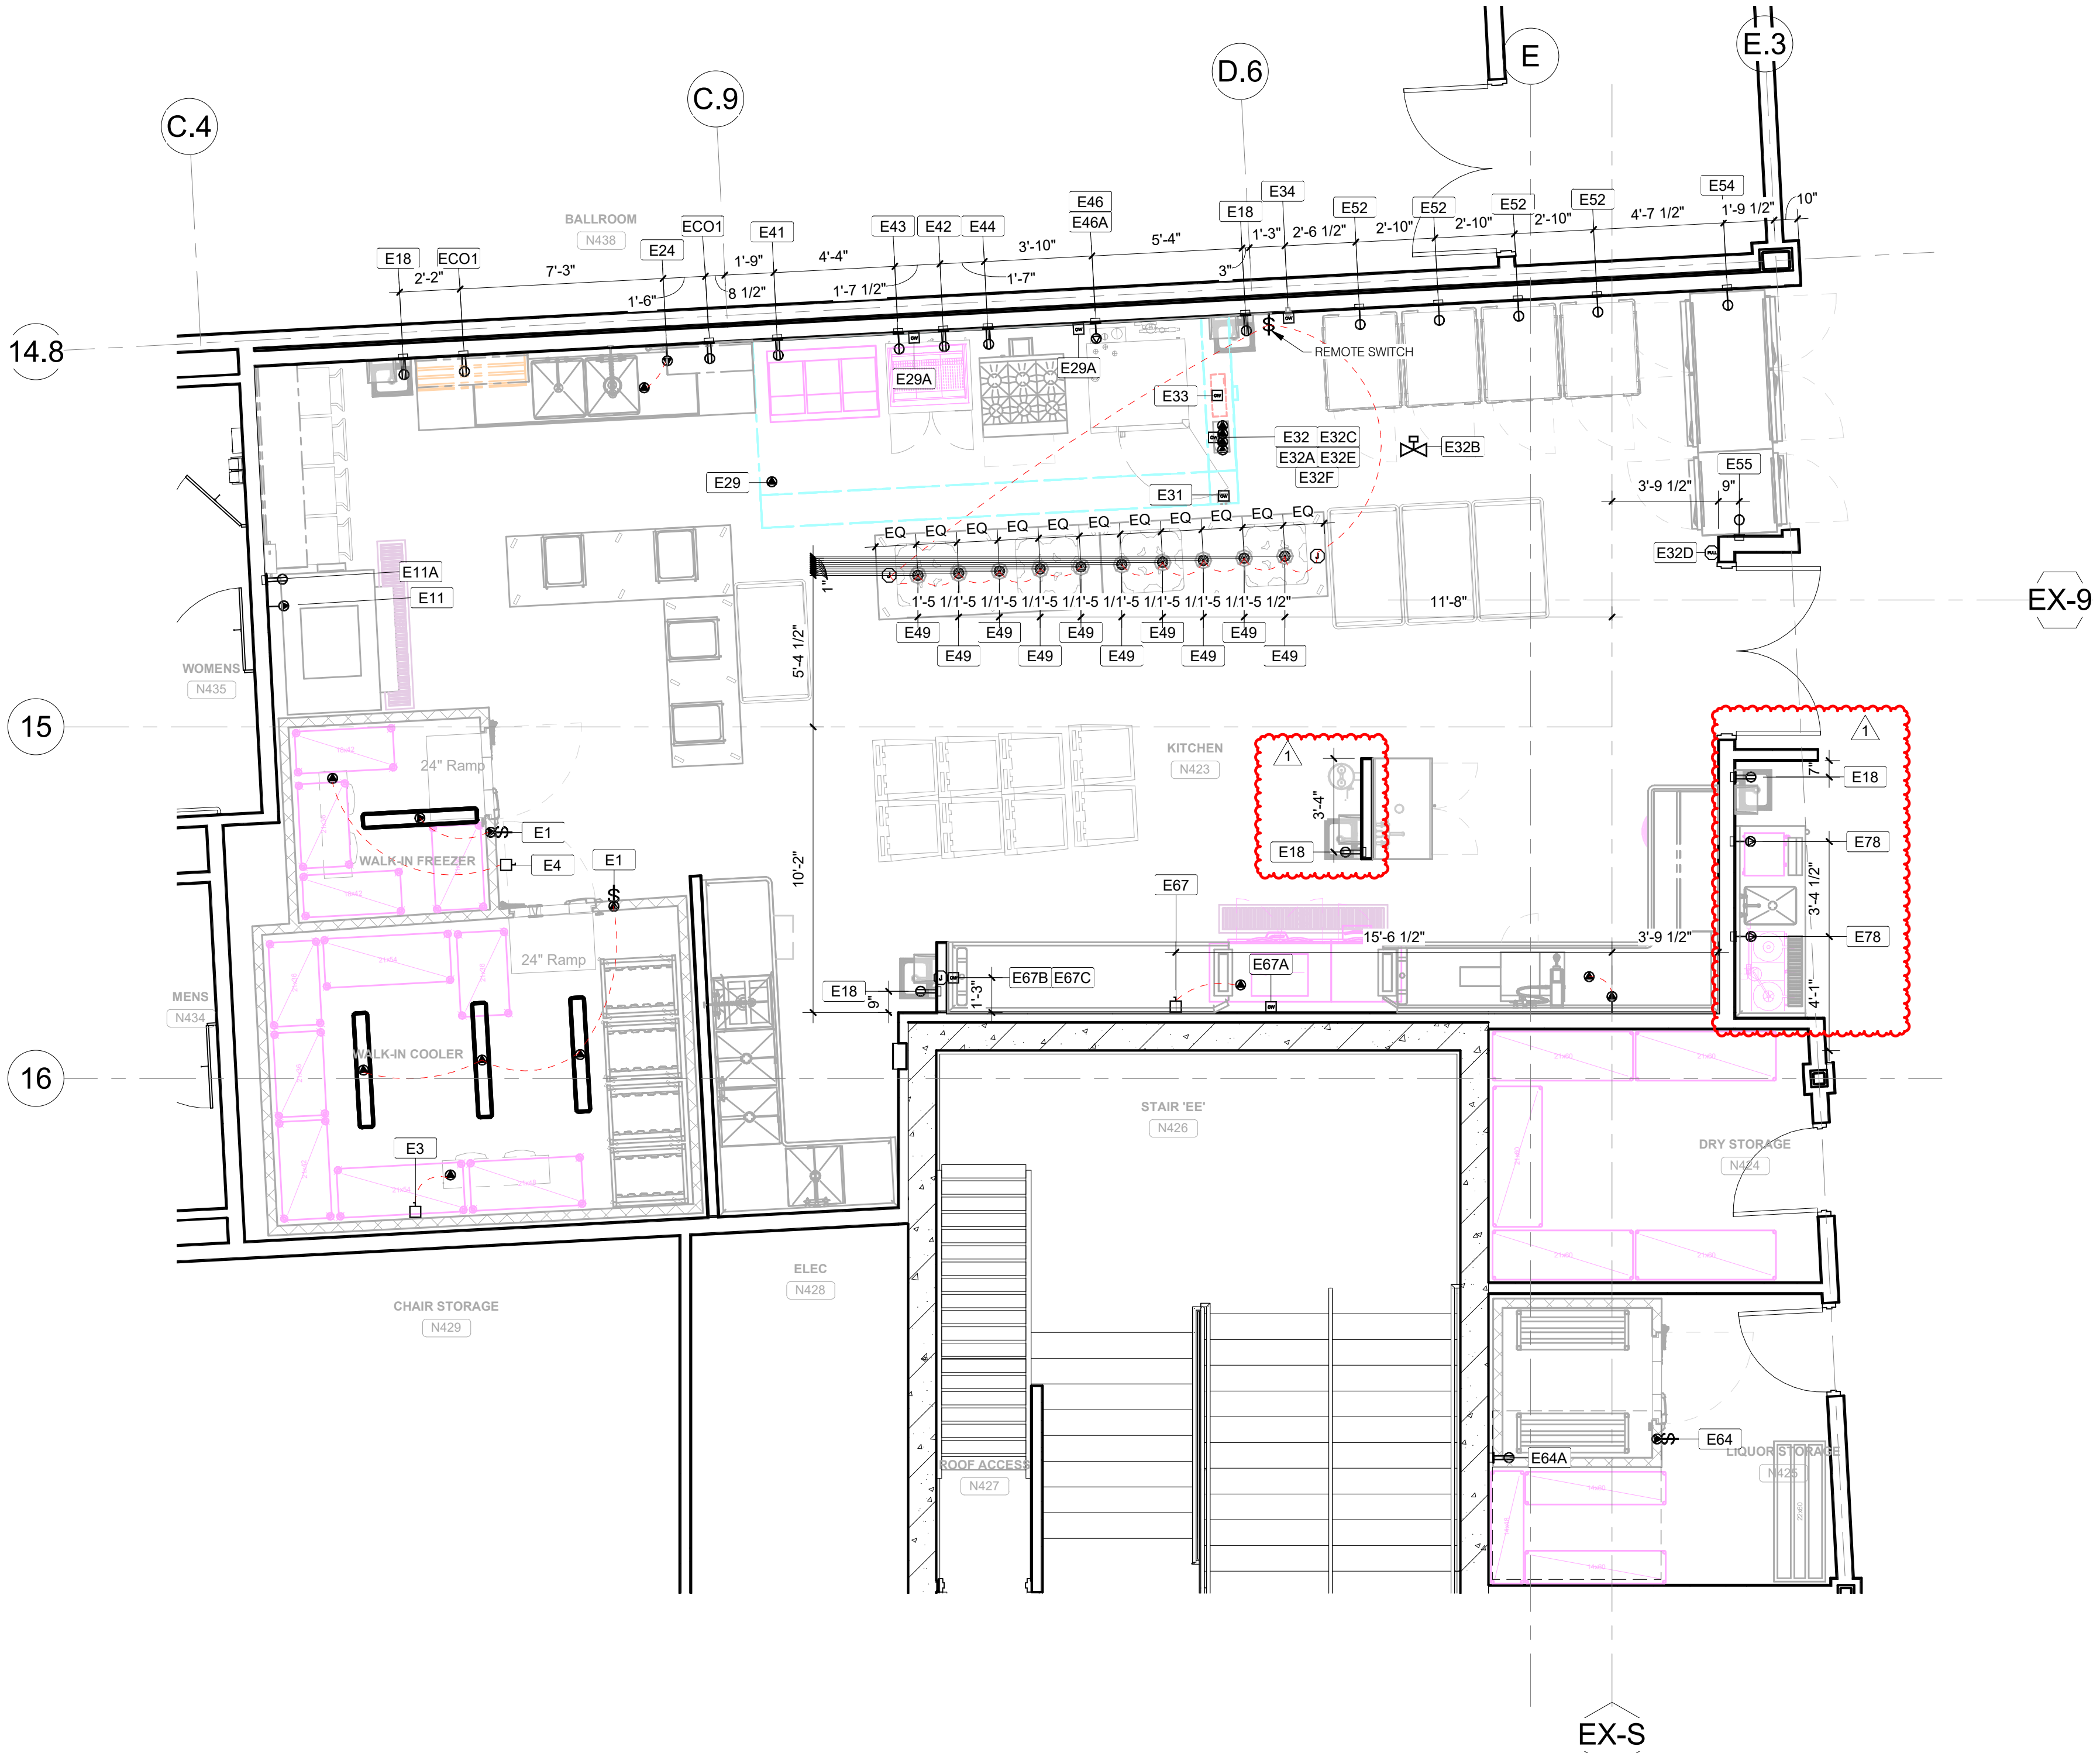

ELECTRICAL LEGEND:

- SINGLE RECEPTACLE OUTLET
- ⊖ DUPLEX RECEPTACLE OUTLET
- ⊕ SPECIAL PURPOSE RECEPTACLE OUTLET
- ⊖ FLOOR-SINGLE RECEPTACLE OUTLET
- ⊖ FLOOR-DUPLEX RECEPTACLE OUTLET
- ⊖ FLOOR-SPECIAL PURPOSE OUTLET
- ▲ DIRECT CONNECTION
- ▲ FLOOR/CEILING DIRECT CONNECTION
- ⊕ MECHANICAL GAS SHUT-OFF VALVE FOR FIRE SYSTEM
- ⊕ ELECTRIC SOLENOID GAS SHUT-OFF VALVE FOR FIRE SYSTEM
- ⊖ EMPTY OCTAGONAL DATA J-BOX
- ⊖ EMPTY OCTAGONAL J-BOX
- ⊖ EMPTY OCTAGONAL FOR POS DATA J-BOX
- ⊖ REMOTE PULL STATION FOR FIRE SYSTEM
- ⊖ WALK-IN TIME CLOCK
- ⊖ REFRIGERATION REMOTE CONTROLLER
- ⊖ 24 VOLT CONTROL WIRING
- ⊖ EXTERNALLY OPERATED DISCONNECT SWITCH
- CEILING-VAPOR PROOF SURFACE INCANDESCENT LIGHT
- DROP CORD
- CEILING-JUNCTION BOX
- WALL-JUNCTION BOX
- ⊖ SURFACE OR PENDANT CONTINUOUS ROW LED LIGHT FIXTURE
- ⊖ SURFACE OR PENDANT CONTINUOUS ROW FLUORESCENT LIGHT FIXTURE
- ⊖ SWITCH
- ⊖ PRIVATE TELEPHONE SYSTEM DEVICES
- ⊖ TELEPHONE INTERCONNECTIONS
- A.F.F. ABOVE FINISHED FLOOR
- B.F.F. BELOW FINISHED FLOOR
- D.F.A. DOWN FROM ABOVE
- U.F.B. UP FROM BELOW
- ELECTRICAL POWER
- LOW VOLTAGE
- DATA LINES

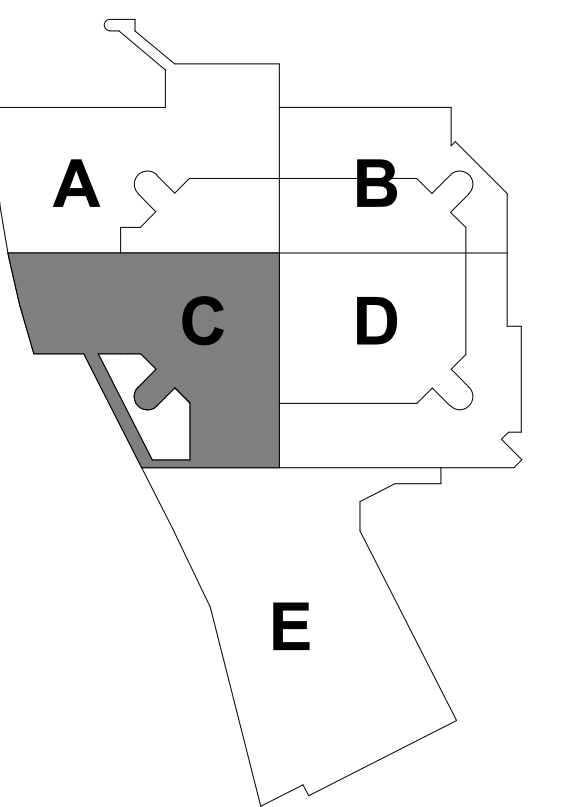

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PROJECT

LA CROSSE CENTER EXPANSION & RENOVATION

LA CROSSE WISCONSIN

REVISION SCHEDULE		
DATE	DESCRIPTION	BY
08/14/2020	PR20	


PROJECT NO.	16-19990
FILE NAME	19990 Arch R18.rvt
DRAWN BY	SK
DESIGNED BY	DH
REVIEWED BY	DH
ORIGINAL ISSUE DATE	02/06/20
CLIENT PROJECT NO.	

FOODSERVICE BALLROOM LEVEL ELECTRICAL ROUGH-IN PLAN

TITLE


FS700

SHEET


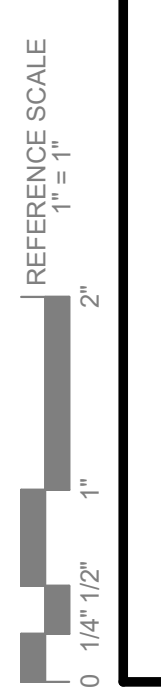


2 FOODSERVICE EQUIPMENT BALLROOM KITCHEN ELEC ROUGH-IN PLAN
FS700 1/4" = 1'-0"



1 FOODSERVICE EQUIPMENT BALLROOM BANQUET KITCHEN ELEC ROUGH-IN PLAN
FS700 1/4" = 1'-0"

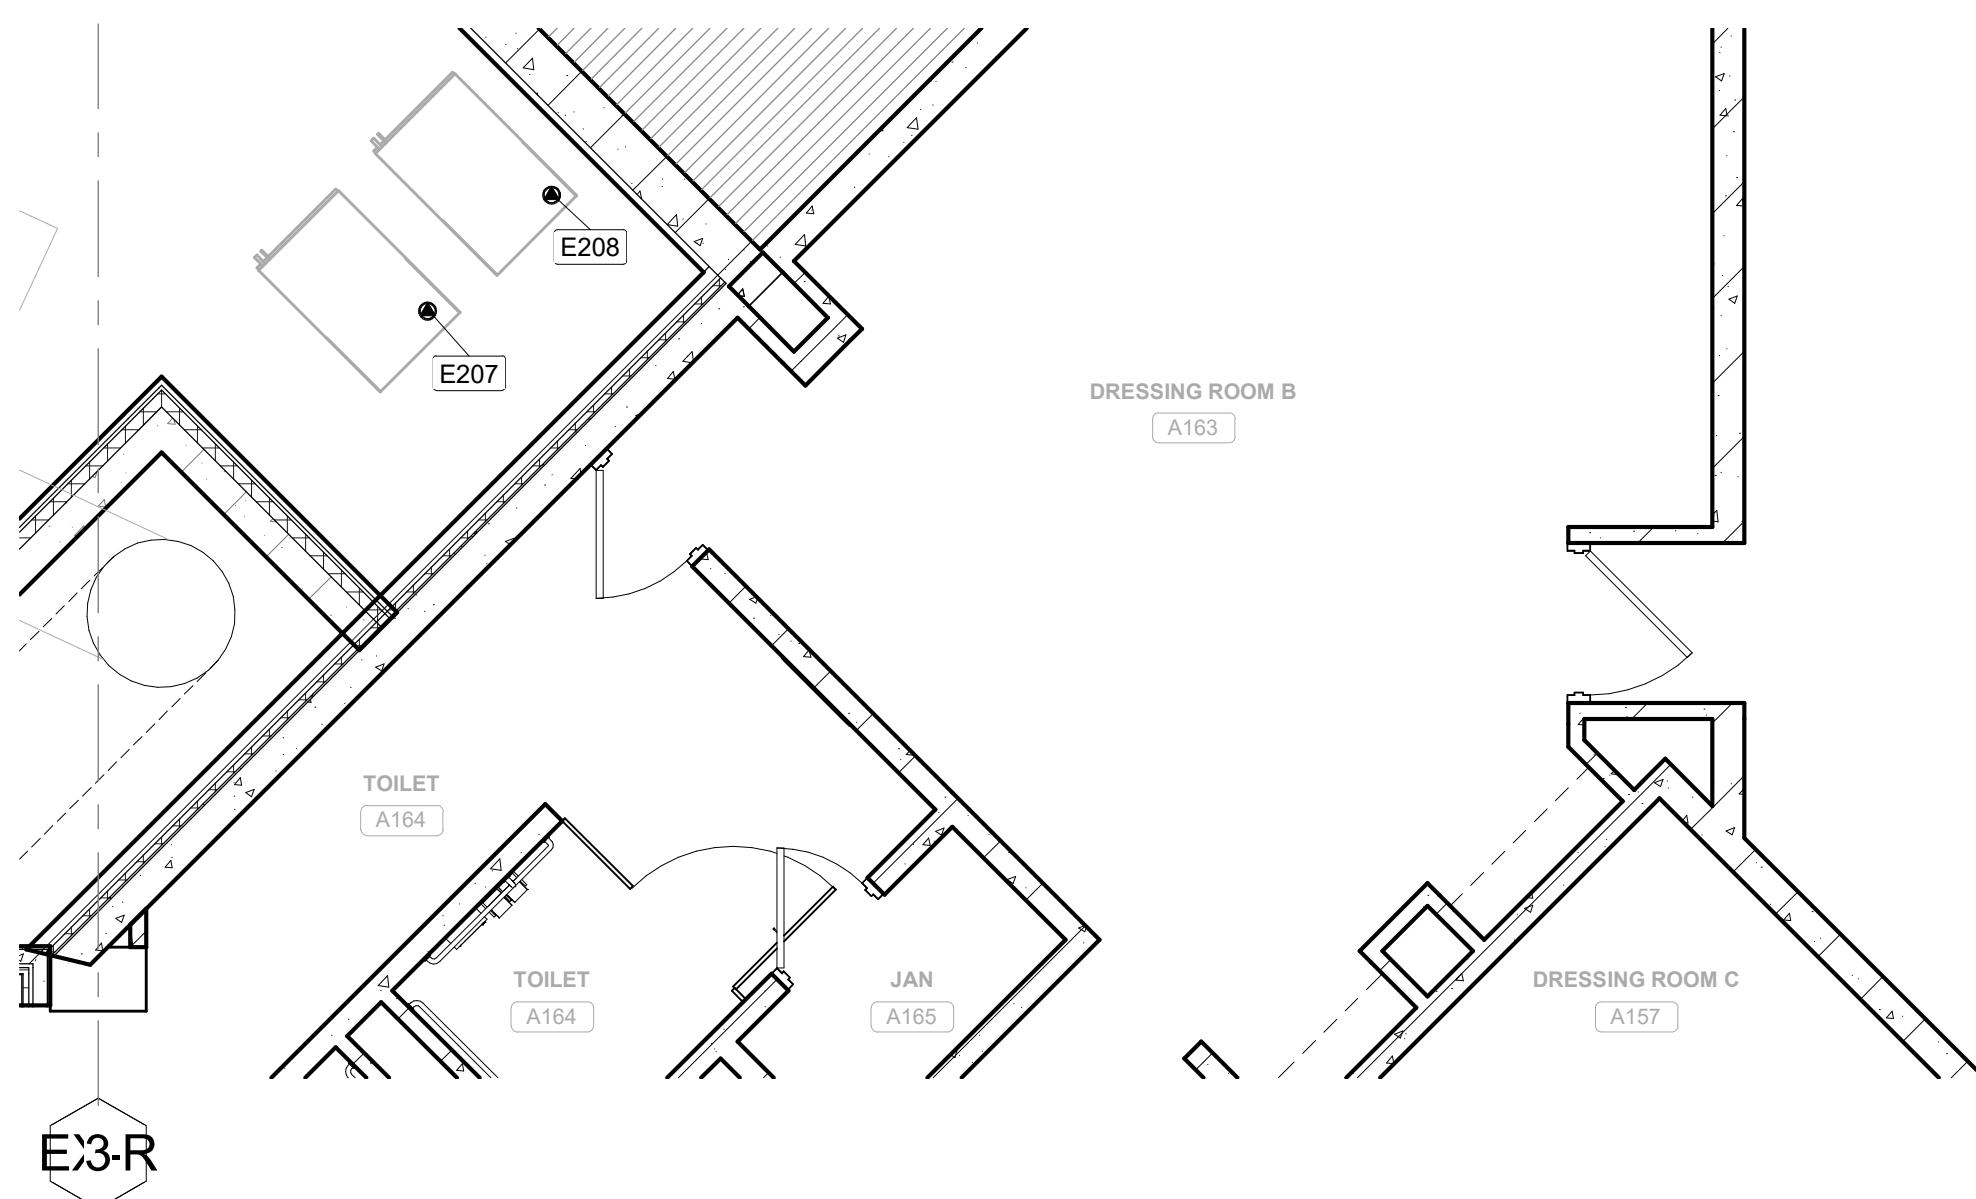

1 FOODSERVICE EQUIPMENT ARENA WALK INS ELEC ROUGH-IN PLAN
FS701 1/4" = 1'-0"

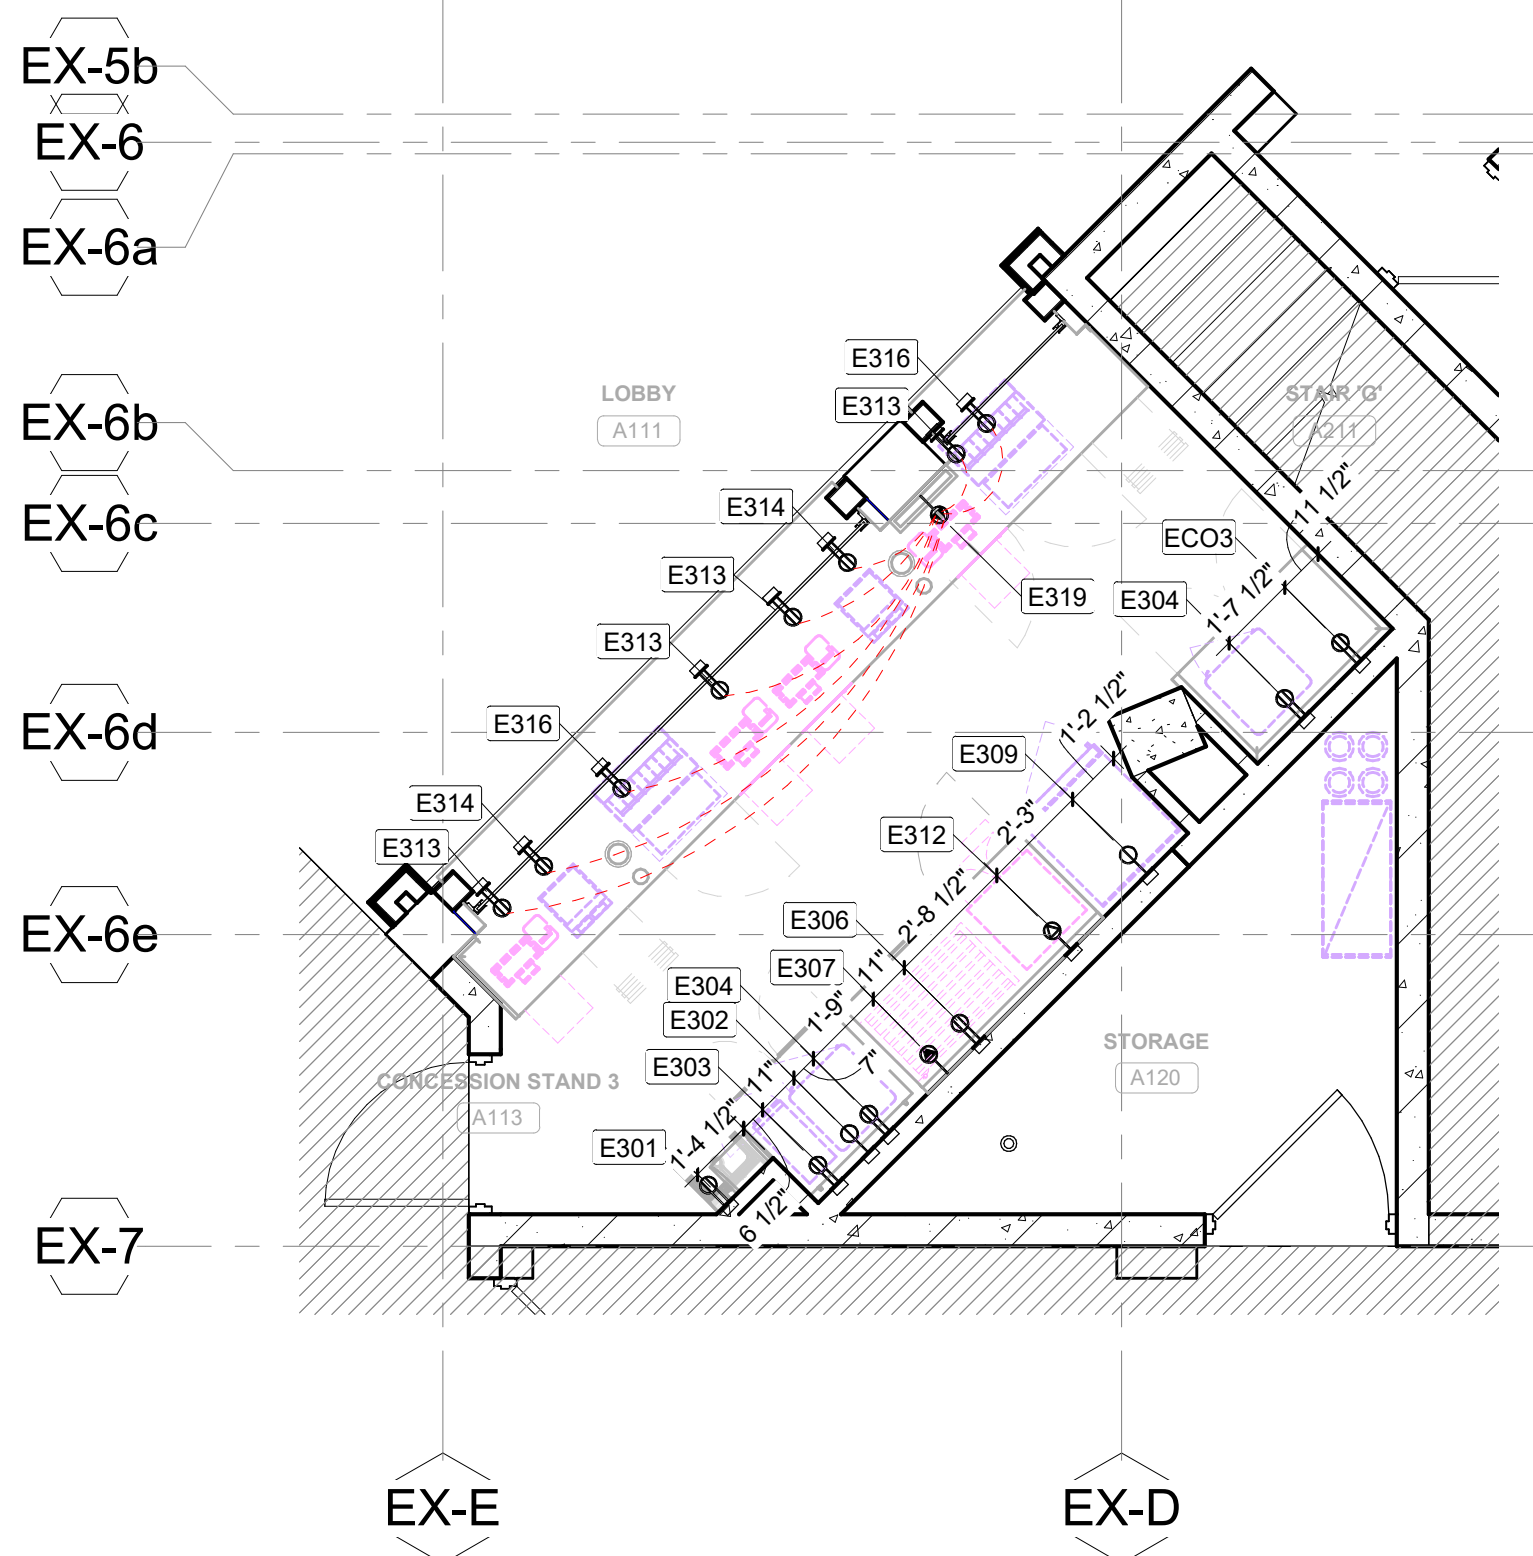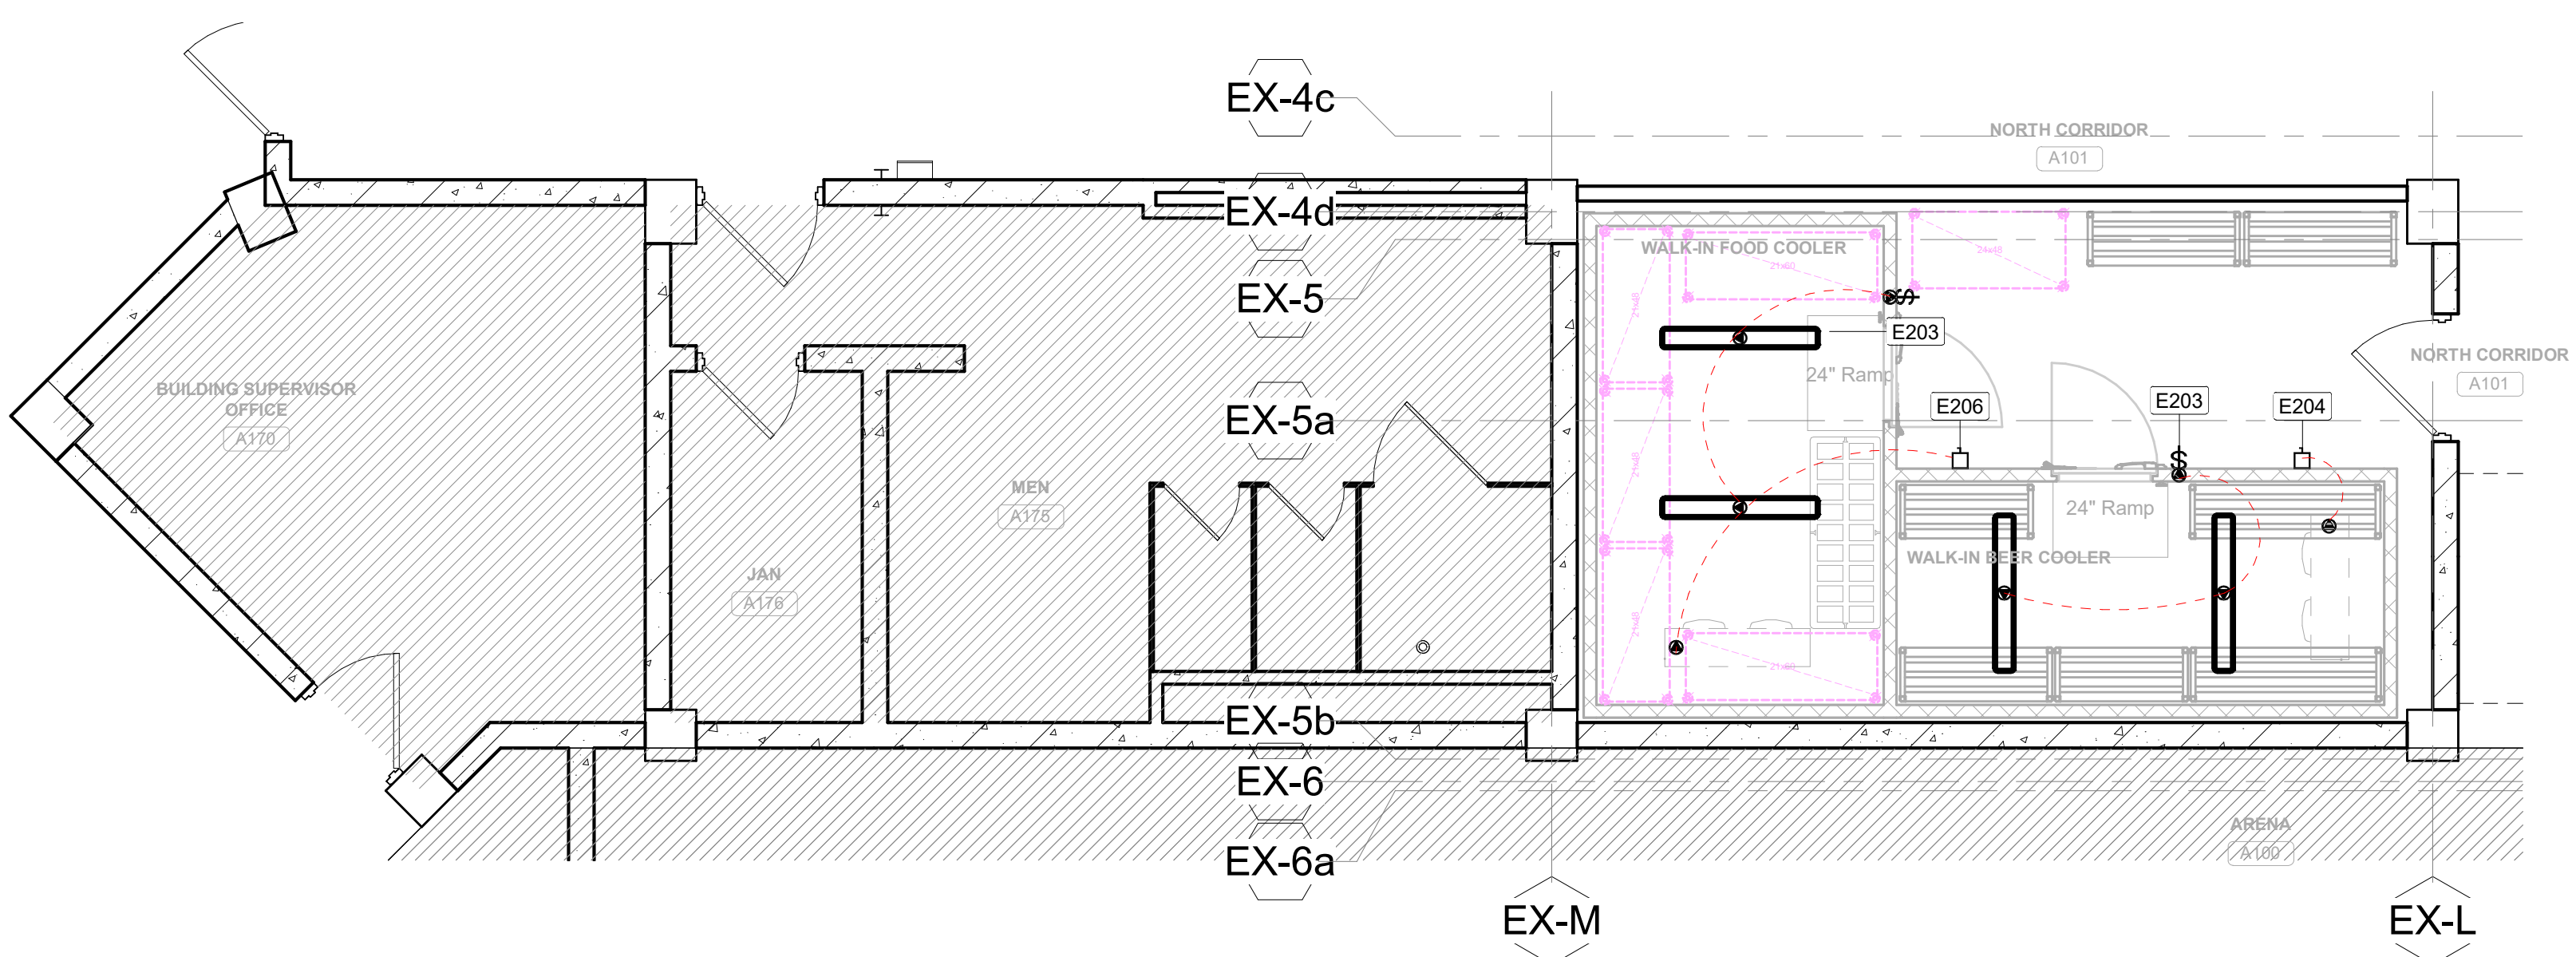

2 FOODSERVICE EQUIPMENT ARENA CONCESSIONS #3 ELEC ROUGH-IN PLAN
FS701 1/4" = 1'-0"

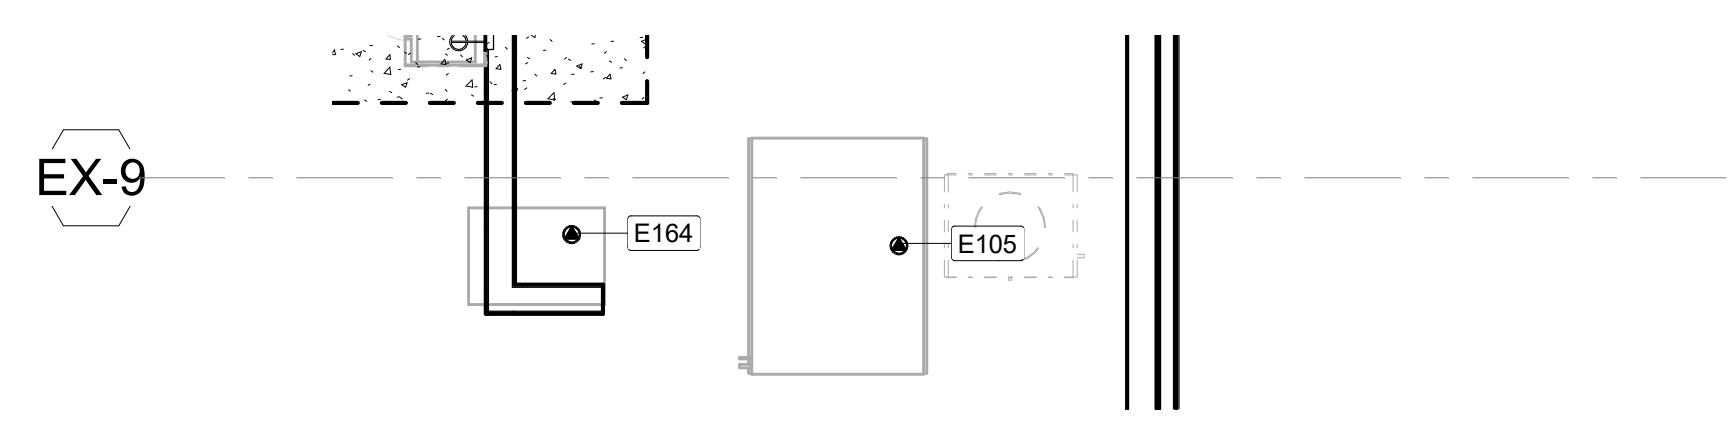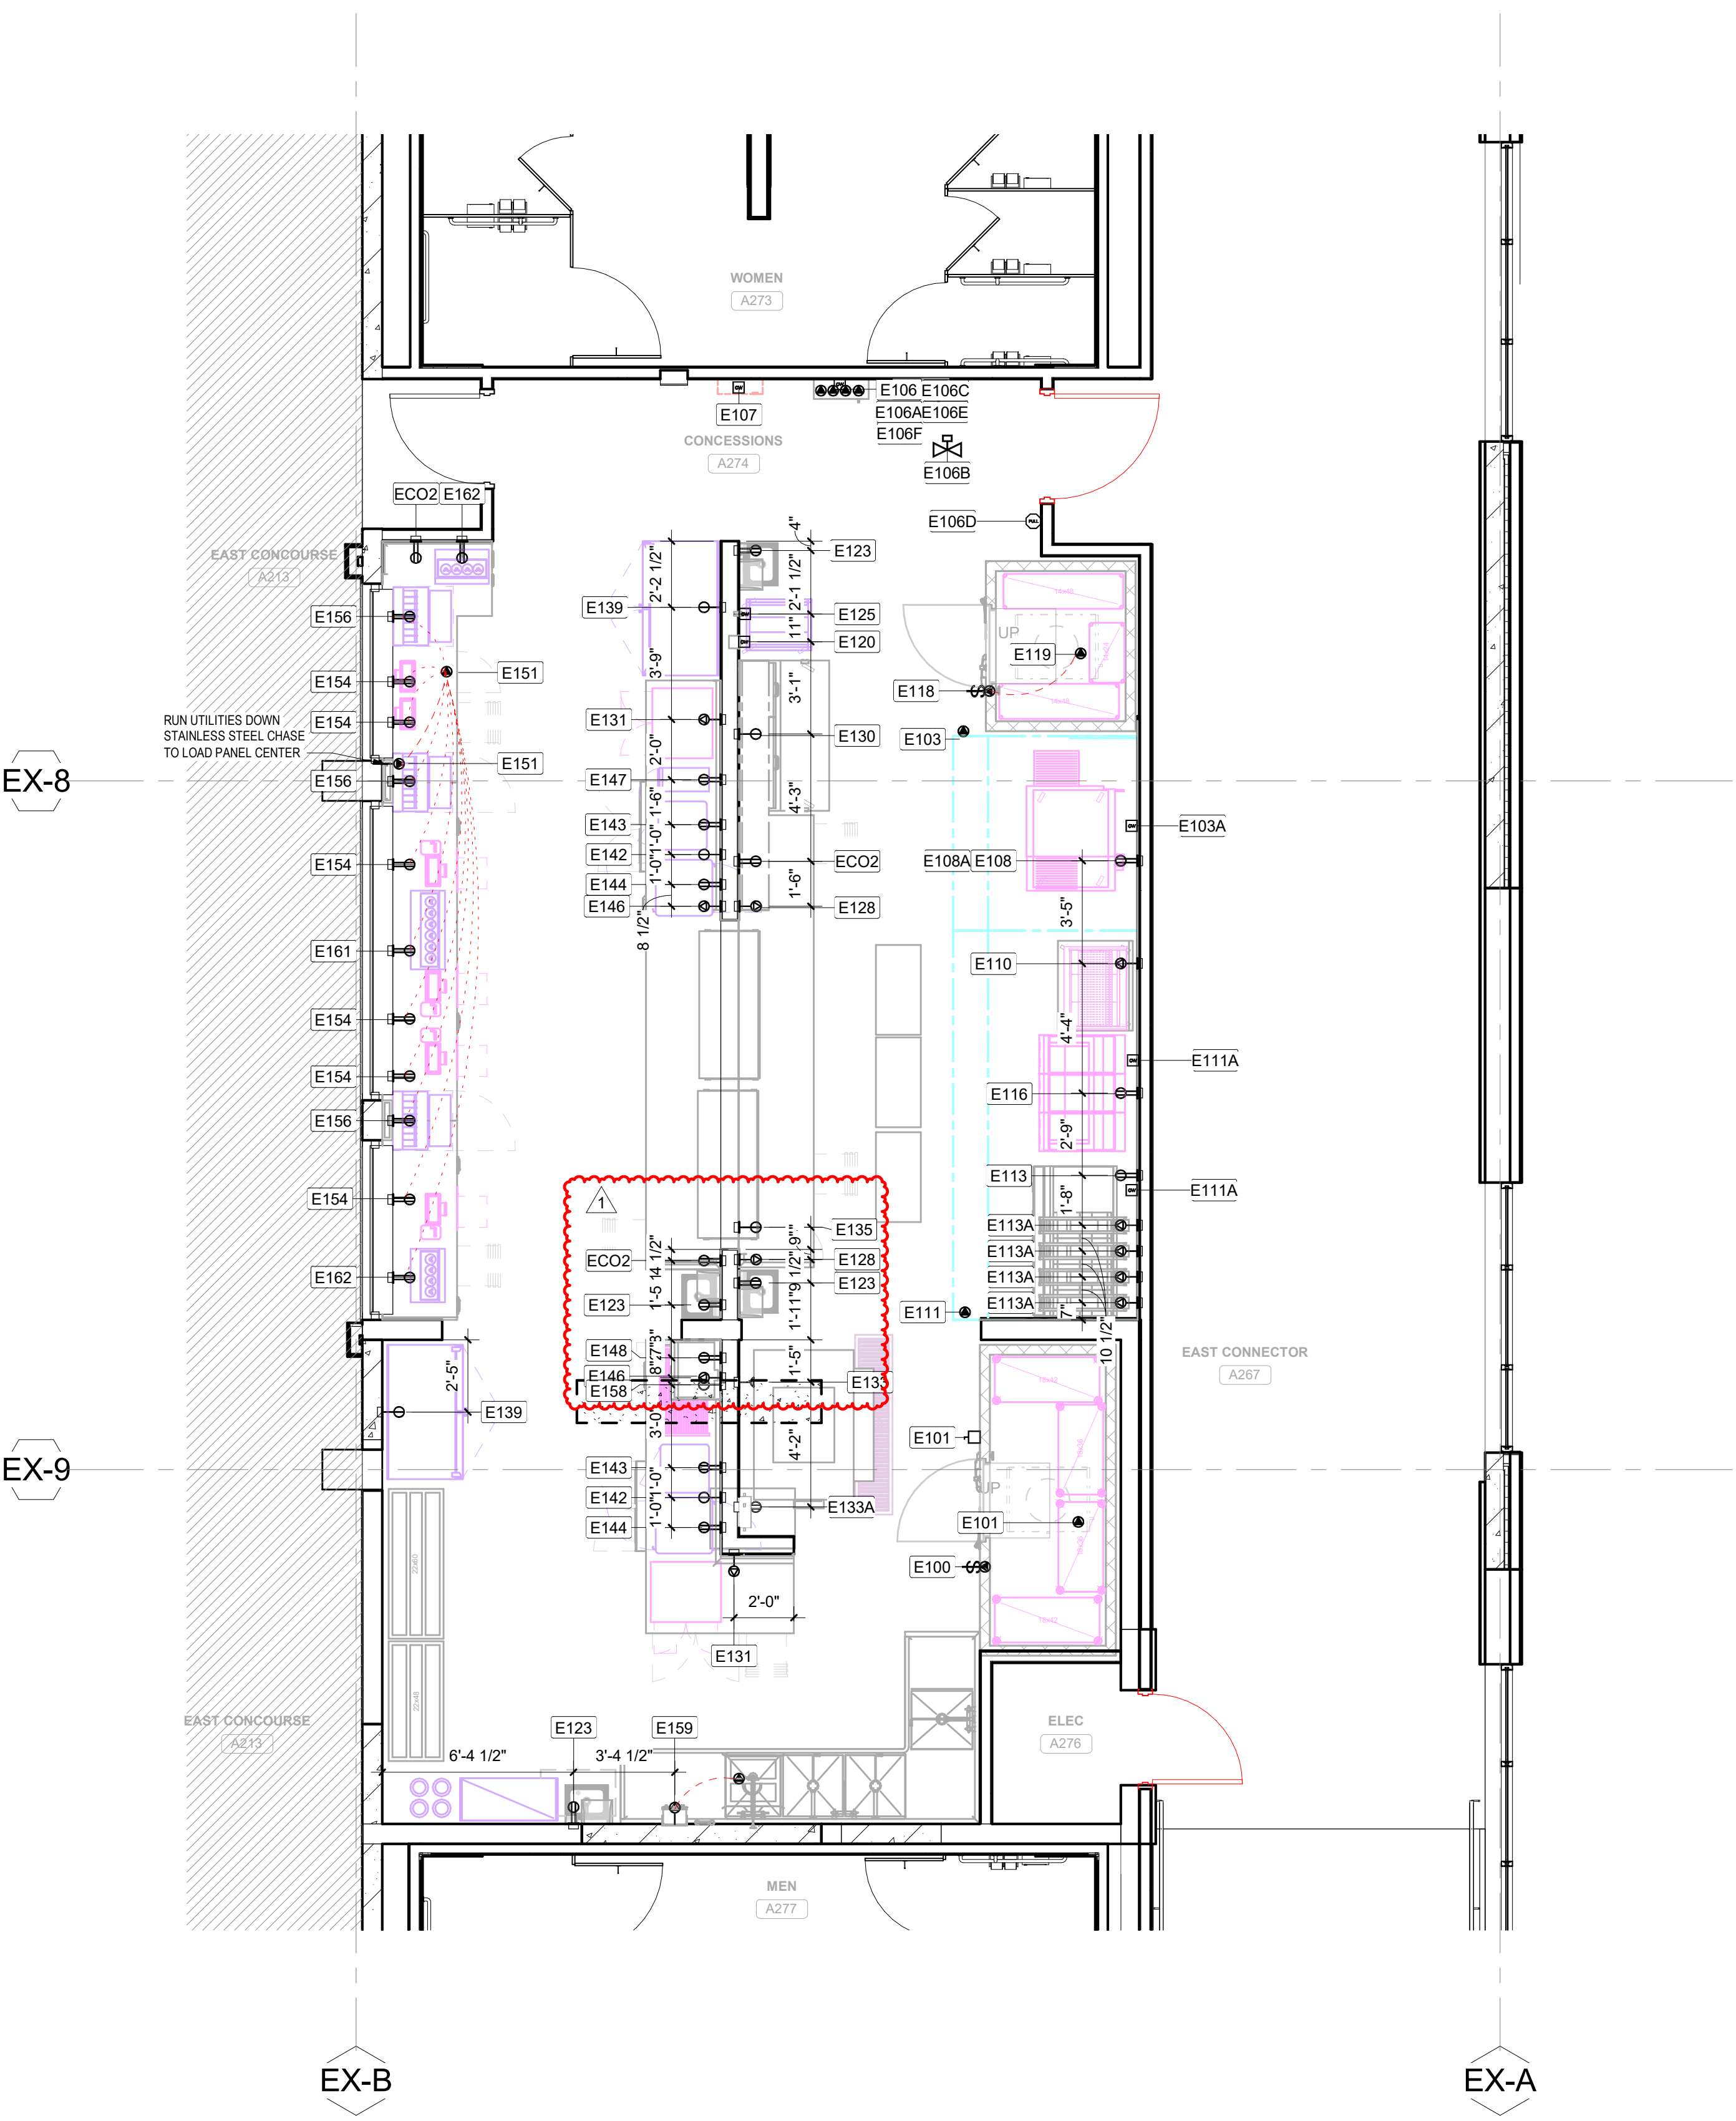


4 FOODSERVICE EQUIPMENT CONCOURSE CONCESSIONS ROOF ELC ROUGH-IN
FS701 1/4" = 1'-0"

3 FOODSERVICE EQUIPMENT CONCOURSE CONCESSIONS ELEC ROUGH-IN PLAN
FS701 1/4" = 1'-0"

ELECTRICAL LEGEND:

- SINGLE RECEPTACLE OUTLET
- DUPLEX RECEPTACLE OUTLET
- SPECIAL PURPOSE RECEPTACLE OUTLET
- FLOOR-SINGLE RECEPTACLE OUTLET
- FLOOR-DUPLEX RECEPTACLE OUTLET
- FLOOR-SPECIAL PURPOSE OUTLET
- DIRECT CONNECTION
- FLOOR/CEILING DIRECT CONNECTION
- MECHANICAL GAS SHUT-OFF VALVE FOR FIRE SYSTEM
- ELECTRIC SOLENOID GAS SHUT-OFF VALVE FOR FIRE SYSTEM
- EMPTY OCTAGONAL DATA J-BOX
- EMPTY OCTAGONAL J-BOX
- EMPTY OCTAGONAL FOR POS DATA J-BOX
- REMOTE PULL STATION FOR FIRE SYSTEM
- WALK-IN TIME CLOCK
- REFRIGERATION REMOTE CONTROLLER
- 24 VOLT CONTROL WIRING
- EXTERNALLY OPERATED DISCONNECT SWITCH
- CEILING-VAPOR PROOF SURFACE INCANDESCENT LIGHT
- DROP CORD
- CEILING-JUNCTION BOX
- WALL-JUNCTION BOX
- SURFACE OR PENDANT CONTINUOUS ROW LED LIGHT FIXTURE
- SURFACE OR PENDANT CONTINUOUS ROW FLUORESCENT LIGHT FIXTURE
- SWITCH
- PRIVATE TELEPHONE SYSTEM DEVICES
- TELEPHONE INTERCONNECTIONS
- A.F.F. ABOVE FINISHED FLOOR
- B.F.F. BELOW FINISHED FLOOR
- D.F.A. DOWN FROM ABOVE
- U.F.B. UP FROM BELOW
- ELECTRICAL POWER
- LOW VOLTAGE
- DATA LINES

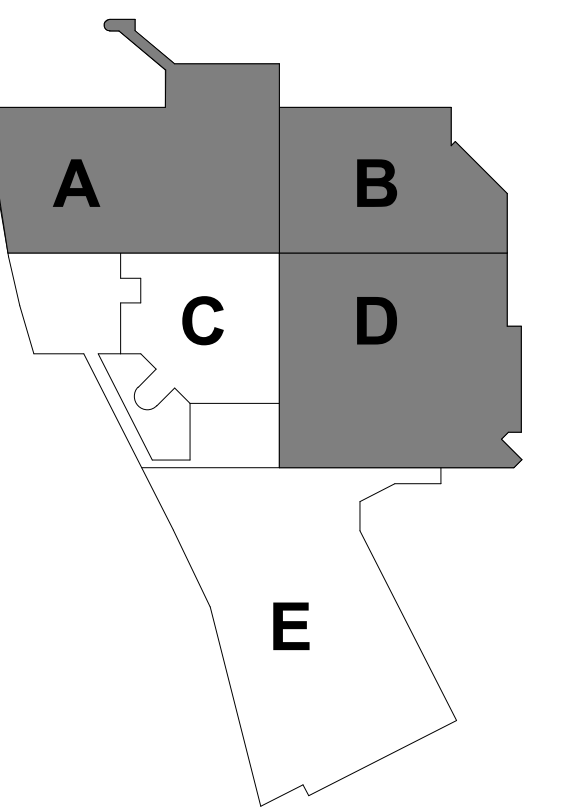

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PROJECT

LA CROSSE CENTER EXPANSION & RENOVATION


LA CROSSE WISCONSIN


REVISION SCHEDULE		
DATE	DESCRIPTION	BY
08/14/2020	PR20	

PROJECT NO.	16-19990
FILE NAME	19990 Arch R18.rvt
DRAWN BY	SK
DESIGNED BY	DH
REVIEWED BY	DH
ORIGINAL ISSUE DATE	02/06/20
CLIENT PROJECT NO.	

FOODSERVICE CONCOURSE LEVEL & ARENA LEVEL ELECTRICAL ROUGH-IN PLAN

SHEET
FS701

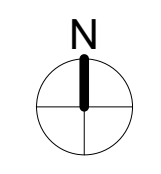

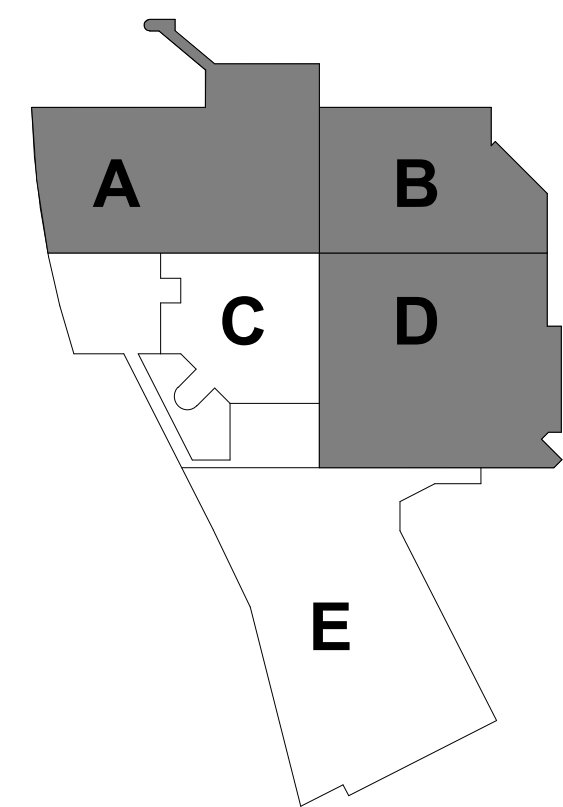

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PROJECT

LA CROSSE CENTER EXPANSION & RENOVATION

LA CROSSE WISCONSIN

REVISION SCHEDULE table with columns: DATE, DESCRIPTION, BY

PROJECT INFORMATION table with fields: PROJECT NO., FILE NAME, DRAWN BY, DESIGNED BY, REVIEWED BY, ORIGINAL ISSUE DATE

CLIENT PROJECT NO.

TITLE

FOODSERVICE ARENA & CONCOURSE ELECTRICAL SCHEDULE

SHEET FS702

CONCOURSE ELECTRICAL ROUGH-IN SCHEDULE

Main table for Concourse Electrical Rough-In Schedule with columns: ITEM NO, QTY, DESCRIPTION, SERVICE (VOLTS, PHASE, AMP, CONN. TYPE), ROUGH-IN (HEIGHT, ABRV), ELECTRICAL INFORMATION (CD, REMARKS & NOTES)

GENERAL ELECTRICAL NOTES:

- A. ALL 120 VOLT DUPLEX RECEPTACLES SHALL BE A MINIMUM OF 20.0 AMP CIRCUIT... B. ELECTRICAL CONTRACTOR SHALL PROVIDE ALL NECESSARY ELECTRICAL DISCONNECT SWITCHES FOR EQUIPMENT... C. FSEC SHALL BE RESPONSIBLE FOR SETTING EQUIPMENT IN PLACE READY FOR FINAL CONNECTION AND INTERCONNECTIONS...

ELECTRICAL SCHEDULE NOTES:

- 1) FSEC SHALL PROVIDE ALL RECEPTACLES IN FABRICATED EQUIPMENT AND WILL PRE-WIRE ELECTRICAL COMPONENTS IN COUNTER FOR FINAL CONNECTION BY ELECTRICAL CONTRACTOR... 2) ELECTRICAL CONTRACTOR SHALL INTERWIRE FIRE PROTECTION SYSTEM WITH BUILDING ALARM SYSTEM...

ARENA WALK-IN ELECTRICAL ROUGH-IN SCHEDULE

Table for Arena Walk-In Electrical Rough-In Schedule with columns: ITEM NO, QTY, DESCRIPTION, SERVICE, ROUGH-IN, ELECTRICAL INFORMATION

ARENA CONCESSIONS #3 ELECTRICAL ROUGH-IN SCHEDULE

Table for Arena Concessions #3 Electrical Rough-In Schedule with columns: ITEM NO, QTY, DESCRIPTION, SERVICE, ROUGH-IN, ELECTRICAL INFORMATION

CONVENIENCE ELECTRICAL ROUGH-IN SCHEDULE

Table for Convenience Electrical Rough-In Schedule with columns: ITEM NO, QTY, DESCRIPTION, SERVICE, ROUGH-IN, ELECTRICAL INFORMATION

