



	OWNER FURNISHED	SHEET	OWNER FURNISHED	CONTRACTOR FURNISHED
MATERIALS	OWNER INSTALLED	NUMBER	CONTRACTOR INSTALLED	CONTRACTOR INSTALLED
PERMITS	Х			
EDU & TAP FEES	X			
UTILITY COMPANY FEES	Х			
WINTER CONDITIONS				ALLOWANCE
CONSTRUCTION STAKING				χ
CONSTRUCTION TESTING AND 3RD PARTY INSPECTIONS			OWNER PAID/GC SCHEDULED	
SITE SECURITY ENCLOSURE FENCE			IF NECESSARY	χ
PLASTIC BOLLARD COVERS	Х			
R.O. FIBERGLASS TANKS			Х	
PAVEMENT MARKINGS	Х			
COLORED DRY-BLOCK OR STRUCTURAL BRICK				Х
CONVEYOR PIT GRATING	Х			
STAINLESS STEEL BUCKET WELL				Χ
STAINLESS STEEL ROOF LADDER			Х	
STAINLESS STEEL DOORS/FRAMES AND HARDWARE				Χ
COMPOSITE RO AND RECLAIM PIT COVERS				Х
VACUUMS/STANCHEONS	Х			
LANDSCAPING & IRRIGATION				Χ
ALL STRUCTURAL STAINLESS STEEL			Х	
CASHIER-SALES CANOPY KIOSK -FOOTINGS/FOUNDATIONS & CONCRETE FLOOR BY GC				Χ
OVERHEAD DOORS	Х			
FLOOR SEALER AND EPOXY FLOORING	Х			
FIRE EXTINGUISHERS/CABINET	Х			
ALL BUILDING SIGNAGE/MONUMENT SIGN	Х			
ELECTRIC SELF-CONTAINED WATER COOLER	Х			
COMPRESSED AIR PIPING			Х	
PUMP CONTROL BOX			X	
HOT WATER FLOOR HEATING			TUBING, MANIFOLDS, BOILER, AND GROUND BOX	CONCRETE, INSULATION, A INSTALLATION OF FLOOR HE RUNS, MANIFOLD; SUPPLY/RETURN LINES, AN GROUND BOX
IRRIGATION VACUUM BREAKER	X			SILCOND BOX
SINK AND FAUCET				X
TRENCH DRAIN				X
WATTS "900" SERIES BACKFLOW PREVENTORS VALVE & FITTINGS			X	Λ
75 SERIES BROWN ESTAT REFERENCE TREFE WITH THOSE			Λ	

RESPONSIBILITY MATRIX - CARWASH BUILDING				
MATERIALS	OWNER FURNISHED OWNER INSTALLED	SHEET NUMBER	OWNER FURNISHED CONTRACTOR INSTALLED	CONTRACTOR FURNISHED CONTRACTOR INSTALLED
THERMOSTATIC MIXING VALVES			Х	
3" WATER METER			Χ	
BOOSTER PUMP & PRESSURE REGULATING VALVE			χ	
SOLENOID VALVE WITH BALL VALVE & UNION			χ	
4" COMBUSTION AIR INTAKE AND 6" FLUE PIPE VENTS FOR HOT WATER SYSTEM				Х
MAU-1 & MAU-2 MAKE-UP AIR UNITS			Х	
AIR DOORS SLOT DISCHARGE PLENUMS			Х	
EF 2A & EF 2B TUNNEL EXHAUST FANS			Х	
12" X 12" X 84" AIR NOZZEL & AIR DIVERTERS			Х	
LIGHT FIXTURES			Х	
ELECTRICAL SWITCH GEAR			Х	
MOTOR CONTROL CENTER (MCC) CONTROL PANEL			Х	
LOW VOLTAGE WIRING	Х			
TELEPHONE, DATA, SECURITY WIRING & SYSTEMS	Х			
SITE LIGHTING CONCRETE BASES & WIRING				Х
SITE LIGHTING POLES AND FIXTURES			Х	
SALES CANOPY LIGHT FIXTURES	Х			
HUBBLES PIN AND SLEEVE CONNECTOR			Х	
DOUBLE H.O.A. SWITCH BOX			Х	
EDWARDS CAT. NO. 340-4NL			Х	
EDWARDS CAT. NO. 876-N5 WEATHERPROOF HORN			Х	
LOUD SPEAKERS	Х			
CAMERAS	Х			
VIDEO CONTROL CABINET	Х			
COMPUTER PANEL	X			
ALARM/ACCESS CONTROL PANEL	X			
COMPUTER RACK	X			
SERVER CABINET	Х			
REMOTE OFFICE LOW VOLTAGE COLLECTOR BOX			χ	
EXIT END LOW VOLTAGE COLLECTOR BOX			Х	
MECHANICAL ROOM TRENCH DRAIN				Х
A.V. CABINET	Х			
PIPE BOLLARDS				Х
FLAG POLE AND GROUND SLEEVE			Х	
UNISTRUT SUPPORT HANGERS			Х	

PROJECT TEAM		SHEET INDEX
	Sheet	
OWNER	Number	Sheet Name
Crew Carwash	GENERAL	
11700 Exit 5 Parkway	G000	TITLE SHEET
Fishers, IN 46037		
Contact: Andy Goebes	CIVIL	
317.572.9250	C000	COVER SHEET
andy.goebes@crewcarwash.com	C100	CIVIL
	C300	DEMOLITION AND EROSION CONTROL PHASE 1
	C301	EROSION AND SEDIMENT CONTROL PHASE 2 P
ARCHITECT	C302	EROSION AND SEDIMENT CONTROL DETAILS
	C400	SITE PLAN
DJR Architecture, Inc. 333 Washington Avenue N	C401	SITE DETAILS
Union Plaza, Suite 210	C500	GRADING AND DRAINAGE PLAN
Minneapolis, MN 55401	C600	UTILITY PLAN
, ,	C601	PUBLIC UTILITY PROFILE
Contact: Chris Whitehouse	C602 C603	UTILITY DETAILS
612.676.2736	V100	UTILITY DETAILS ALTA-NSPS LAND TITLE SURVEY
612.676.2727 (fax)	V 100	ALTA-NSPS LAND TITLE SURVEY
cwhitehouse@djr-inc.com	LANDCCADE	ARCHITECTURE
CONTRACTOR	L100	LANDSCAPE PLAN
Contractor Name	L100	LANDSCAPE DETAILS
Address	L101	LANDSCAFE DETAILS
Suite	ARCHITECTU	IDE
City, MN 55000	A001	ABBREVIATIONS AND GENERAL NOTES
	A001	SPECIFICATIONS SPECIFICATIONS
Contact: Contractor, P.E.	A002	SPECIFICATIONS
612.000.0000 Contractor@contractor.com	A004	SPECIFICATIONS
Contractor@contractor.com	A100	LIFE SAFETY PLAN & CODE REVIEW
	A101	FIRST FLOOR PLAN
STRUCTURAL ENGINEER	A150	ROOF PLAN
	A200	EXTERIOR ELEVATIONS
Kimley- Horn 767 Eustis Street	A201	EXTERIOR ELEVATIONS
Suite 100	A350	WALL SECTIONS
St. Paul, MN 55114	A351	WALL SECTIONS
,	A352	WALL SECTIONS
Contact: Ricky Kirchner, P.E.	A353	WALL SECTIONS
651.252.4954	A450	INTERIOR ELEVATIONS
ricky.kirchner@kimley-horn.com	A451	INTERIOR ELEVATIONS
	A500	DETAILS
MECHANICAL AND PLUMBING ENGINEER	A600	DOOR & WINDOW TYPES & SCHEDULES
DAE, Inc.	A610	FINISH PLAN & SCHEDULE
2707 Rand Road		
Indianapolis, IN 46241	STRUCTURA	L
·	S100	STRUCTURAL
Contact: Dave Haun, P.E.		
317.464.9090	PLUMBING	
dhaun@daengineering.com	P100	PLUMBING
	MECHANICA	L __
ELECTRICAL ENGINEER	M100	MECHANICAL
KBSO Consulting	M200	MECHANICAL
275 Veterans Way	M300	MECHANICAL
Suite 300		
Carmel, IN 46032	ELECTRICAL	
0	E100	ELECTRICAL
Contact: Paul Records, P.E.	E200	ELECTRICAL
317.753.5722 precords@kbsoconsulting.com		
precords@nbsoconsutting.com		

Kimley- Horn 767 N. Eustis Street

Contact: Jared Jones, P.E.

jared.jones@kimley-horn.com

Suite 100 St. Paul, MN 55114

612.389.1819







NOT FOR CONSTRUCTION

Issue:	Da
Checked by:	
Drawn by:	
Date:	10-28-20
Project #:	24-071

PROJECT TEAM

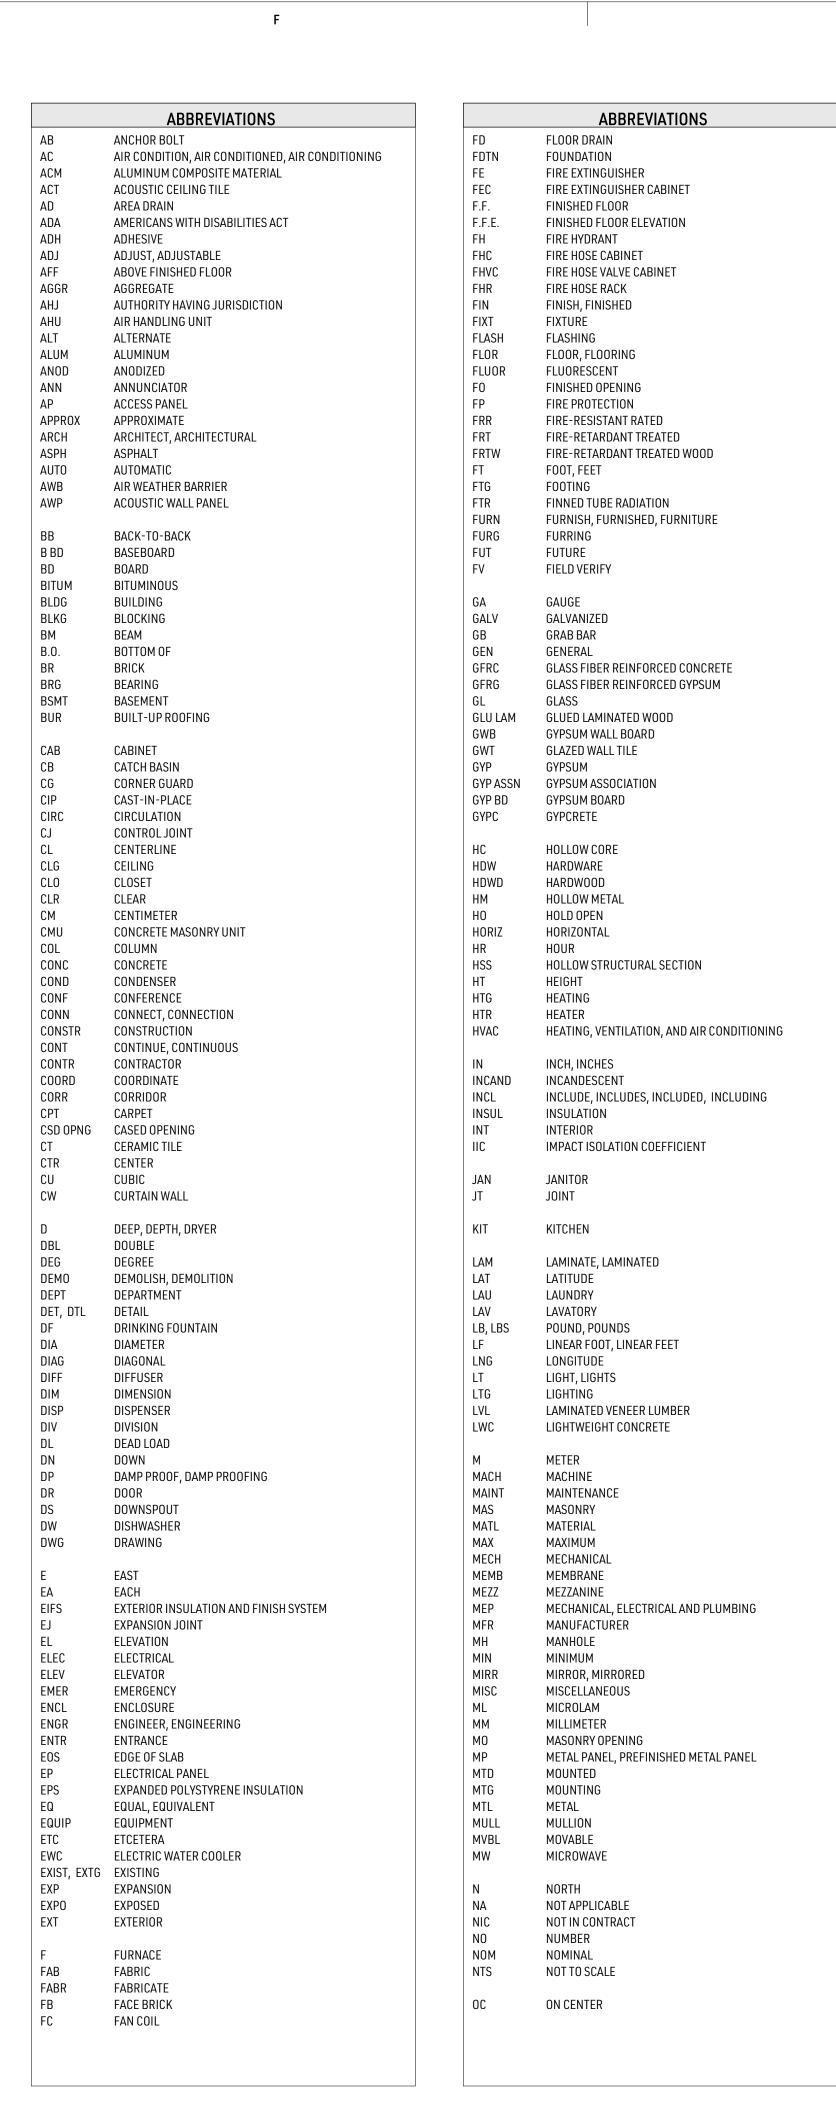

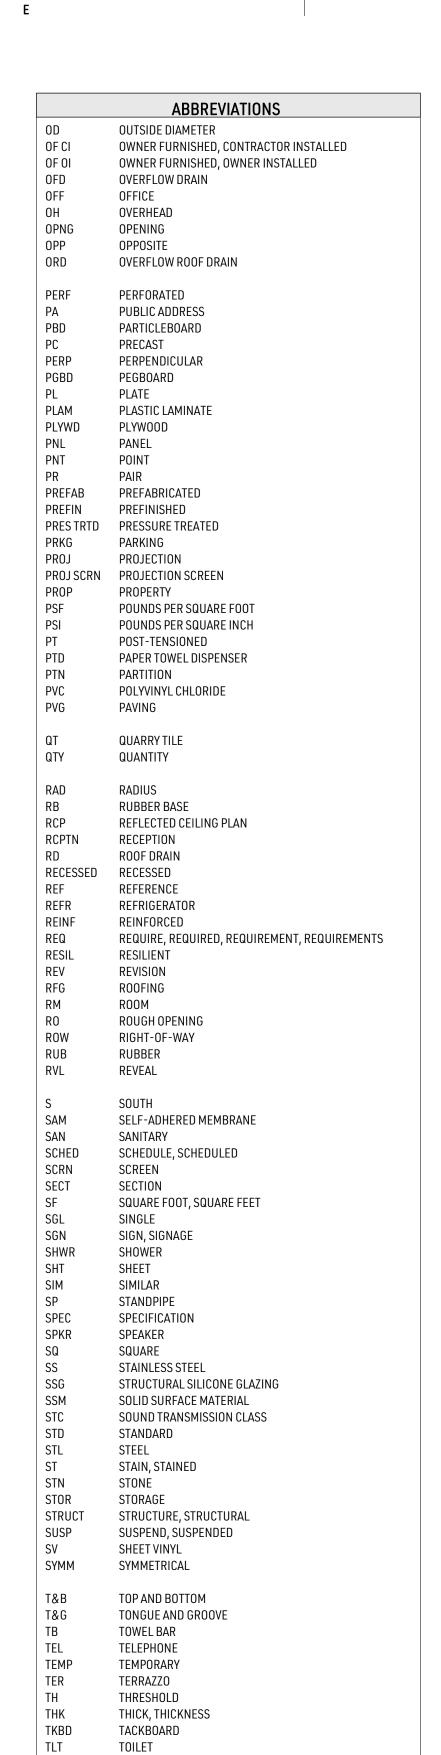

	ABBREVIATIONS
UL	UNDERWRITERS LABORATORIES
UNEXC	UNEXCAVATED
UNFIN	UNFINISHED
UNO	UNLESS NOTED OTHERWISE
UR	URINAL
US	UTILITY SINK
UTIL	UTILITY
VB	VINYL BASE
VCT	VINYL COMPOSITION TILE
VENT	VENTILATION
VERT	VERTICAL
VEST	VESTIBULE
VIF	VERIFY IN FIELD
VOL	VOLUME
VNR	VENEER
VPR BAR	VAPOR BARRIER
VR	VAPOR RETARDER
W	WEST, WASHER
W/	WITH
W/D	WASHER AND DRYER
W/0	WITHOUT
WD	WOOD
WH	WATER HEATER
WDW	WINDOW
WP	WATERPROOF, WATERPROOFING
WSCT	WAINSCOT
WT	WEIGHT
Χ	ВУ
XPS	EXTRUDED POLYSTYRENE INSULATION
YD	YARD

ARCHITECTURAL GENERAL NOTES

. ALL INTERIOR DIMENSIONS ARE TO FACE OF FINISHED WALL OR

PROVIDE ALL WOOD BLOCKING AS REQUIRED FOR THE ATTACHMENT

OF MISCELLANEOUS EQUIPMENT INCLUDING BUT NOT LIMITED TO,

EQUIPMENT INDICATED, GRAB BARS, HANDRAILS, AND CASEWORK. 16

TOILET ACCESSORIES, DOOR HARDWARE, ELECTRICAL DEVICES,

TRANSITION OF DIFFERENT FLOORING MATERIALS AT DOORWAYS

ALL NEW DOOR FRAMES ARE TO BE 4" FROM ADJACENT FINISHED

WALL SURFACE AT DOOR HINGE U.N.O. DIMENSION FOR OPENINGS

WITH DOORS ARE TO FACE OF DOOR JAMB, DIMENSION FOR OPENINGS

RECOMMENDED BY WALLBOARD MANUFACTURER AND COORDINATE

GA. GALVANIZED SHEET METAL CAN BE USED AS BLOCKING.

PROVIDE CONTROL JOINTS IN GYPSUM WALLBOARD AS

LOCATION WITH ARCHITECT. (APPROX. 30' O.C.)

CENTERLINE OF COLUMN, UNLESS OTHERWISE NOTED.

GENERAL NOTES TO PERTAIN TO ALL DRAWINGS.

SHALL OCCUR AT CENTERLINE OF DOORS.

WITHOUT DOORS ARE TO FACE OF WALL.


SURFACES AS SPECIFIED.

AND RELOCATE ITEMS.

FREE.


A210 1	INTERIOR ELEVATION REFERENCE
SIM A000	DETAIL REFERENCE
SIM () () ()	DETAIL REFERENCE WITH BOUNDARY
	VERTICAL ELEVATION REFERENCE
Room name	ROOM NAME AND NUMBER

A210

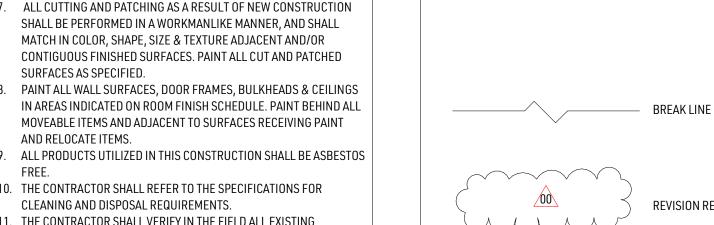

- 10. THE CONTRACTOR SHALL REFER TO THE SPECIFICATIONS FOR CLEANING AND DISPOSAL REQUIREMENTS. . THE CONTRACTOR SHALL VERIFY IN THE FIELD ALL EXISTING APPLICABLE CONDITIONS AND DIMENSIONS SHOWN ON THE DRAWINGS AND AS PERTINENT TO THE INTENT OF THESE DRAWINGS. ANY DISCREPANCY DISCOVERED SHALL BE BROUGHT TO THE ATTENTION OF THE DESIGNER PRIOR TO THE COMMENCEMENT OF ANY WORK AFFECTED BY, OR RELATED TO, SUCH DISCREPANCY. THE CONTRACTOR SHALL BE RESPONSIBLE FOR ALL COSTS ASSOCIATED WITH, OR CAUSED BY FAILURE TO COMPLY WITH THE REQUIREMENT. THE CONTRACTOR SHALL BECOME COMPLETELY FAMILIAR WITH ALL ASPECTS OF THE WORK, EVEN THOSE AREAS DESIGNATED TO BE PROVIDED BY OTHERS. THE FAMILIARIZATION INCLUDES FULL AND COMPLETE UNDERSTANDING OF THE WORK DESCRIBED ON ALL SHEETS OF THE DRAWINGS AND ALL SECTIONS OF THE SPECIFICATIONS. FAILURE BY THE CONTRACTOR TO BECOME COMPLETELY FAMILIAR AND COGNIZANT OF ALL ASPECTS OF THE WORK SHALL NOT RELIEVE THE CONTRACTOR OF THE RESPONSIBILITY TO PROVIDE MATERIALS, ASSEMBLIES, OR SERVICE INDICATED IN THE
- CONTRACT DOCUMENT. B. NOTHING SET FORTH IN THESE DRAWINGS SHALL RELEASE THE CONTRACTOR FROM RESPONSIBILITY TO PROVIDE APPROPRIATE QUANTITIES, FIELD MEASUREMENTS, DIMENSIONAL STABILITY, INSTALLATION, ANCHORAGE, AND COORDINATION WITH OTHER TRADES, OR WAIVE THE CONTRACTORS RESPONSIBILITY TO IDENTIFY AND RESOLVE DEVIATIONS FROM THE REQUIREMENTS OF THE CONTRACT DOCUMENTS, OR WAIVE THE CONTRACTOR'S RESPONSIBILITY TO ALERT THE PROJECT MANAGER/DESIGNER TO DISCREPANCIES CONTAINED THEREIN. 4. THE CONTRACTOR SHALL REVIEW IN ADVANCE ALL PORTIONS OF THE
- WORK TO VERIFY THAT THE WORK WILL NOT PROHIBIT COMPLETION OF THE PROJECT AS INTENDED IN THESE CONTRACT DOCUMENTS, ANY QUESTIONS SHALL BE PROMPTLY REFERRED TO THE DESIGNER FOR RESOLUTION. 5. THE CONTRACTOR SHALL BE RESPONSIBLE FOR THE PROTECTION OF ALL SURFACES AND FINISHES AT INTERIOR AND EXTERIOR OF
- BUILDING. DAMAGED SURFACES AND FINISHES RESULTING FROM THE PERFORMANCE OF THE WORK SHALL BE REPAIRED AT NO COST TO THE OWNER BY THE CONTRACTOR TO MATCH EXISTING ADJACENT. 16. THE CONTRACTOR(S) SHALL BE RESPONSIBLE FOR COORDINATION WITH ALL TRADES. THE CONTRACTOR SHALL REFER TO ALL ASPECTS OF THE DRAWINGS AND SPECIFICATIONS INCLUDING BUT NOT LIMITED TO ARCHITECTURAL DRAWINGS, STRUCTURAL DRAWINGS, MECHANICAL, ELECTRICAL AND PLUMBING DRAWINGS AS WELL AS RELATED SPECIFICATIONS FOR COORDINATION ISSUES. COORDINATE ALL DIAGRAMMATIC DRAWINGS WITH ALL TRADES TO ENSURE FIT AND COMPATIBILITY. 7. ALL FASTENERS WITHIN MECHANICAL ROOM, CARWASH TUNNEL, AND EXPOSED FASTNERS MUST BE STAINLESS STEEL.

SYMBOLS FIRESTOPPING GENERAL NOTES	
PLAN NORTH NORTH NORTH NORTH NORTH NORTH NORTH NORTH ARROW 1. EACH FIRESTOPPING SYSTEM IS TO BE INSTALLED PER APPLICABLE U.L. SYSTEMS AND ITS INSTALLATION REQUIREMENTS IN THE LATE EDITION OF UNDERWRITERS LABORATORIES INC. "FIRE RESISTANC DIRECTORY - VOLUME II". 2. FIRESTOPPING IS REQUIRED AT: A. ALL PENETRATIONS OF FIRE RESISTIVE FLOOR AND ROOF CONSTRUCTION, AND FIRE/SMOKERESISTANCE WALLS AND PARTITIONS RESULTING FROM WORK OF ALL TRADES. B. ALL VOIDS AND JOINTS AT TOP AND BOTTOM OF ALL FIRE/SMO RESISTIVE WALLS AND PARTITIONS, AND DETAILS CONTAINED	ST CE

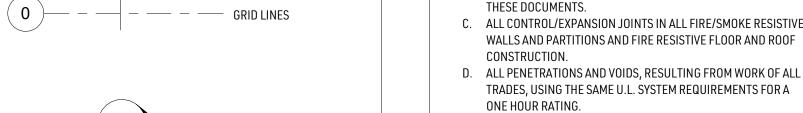

ELEVATION REFERENCE

SECTION REFERENCE

REVISION REFERENCE

DOOR TYPE REFERENCE

WINDOW TYPE REFERENCE

PARTITION TYPE REFERENCE

KEYNOTE REFERENCE

— EXIT WIDTH REQUIRED /

(60) LIFE SAFETY: OPENING

RATING

PROVIDED

OCCUPANT LOAD

DIRECTION OF EGRESS

- E. ALL PENETRATIONS, AND VOIDS, RESULTING FROM WORK OF ALL TRADES, AND ALL JOINTS AT TOP AND BOTTOM OF ALL NON-

		RATED CORRIDOR PARTITIONS, WHERE PARTITIONS EXTEND
		FROM FLOOR TO UNDERSIDE OF FLOOR OR ROOF DECK, AND
		COMPLYING TO DETAILS CONTAINED IN THESE DOCUMENTS,
		USING THE SAME U.L. SYSTEM REQUIREMENTS FOR A ONE HOUR
		RATING.
	F.	ALL CONTROL/EXPANSION JOINTS OCCURRING IN NON-RATED
		WALL, PARTITION, FLOOR OR ROOF CONSTRUCTION USING THE
		SAME U.L. SYSTEM REQUIREMENTS FOR A ONE HOUR RATING.
8.		NEW CONSTRUCTION WHERE THE CONDITION DOES NOT MEET
		REQUIREMENTS OF A U.L. SYSTEM, THEN OBTAIN AN
	ENG	SINEERING JUDGEMENT AS OUTLINED BELOW.
	A.	WHERE OPENINGS AROUND PENETRATING ITEM(S) IN EXISTING
		WALLS, PARTITIONS, FLOORS AND ROOFS DO NOT MEET U.L.
		${\tt SYSTEM} \ {\tt REQUIREMENTS}, {\tt THEN} \ {\tt THE} \ {\tt OPENING} \ {\tt SHALL} \ {\tt BE} \ {\tt INFILLED}$
		BY THE GENERAL CONTRACTOR, WITH MATCHING WALL,
		PARTITION, FLOOR OR ROOF CONSTRUCTION MATERIALS TO
		COMPLY WITH THE ANNULAR OPENING SIZE REQUIREMENT OF
		THE U.L. SYSTEM. WHERE THE OPENING CANNOT BE CLOSED DUE
		TO QUANTITY AND TYPE OF PENETRATING ITEM(S), THEN THE
		FIRESTOPPING CONTRACTOR SHALL OBTAIN AN ENGINEERING
		JUDGEMENT RECOMMENDATION OF THE U/L/ SYSTEM TO BE
		USED FROM THE ENGINEERING DEPARTMENT OF THE
		MANUFACTURER OF THE FIRESTOPPING MATERIALS. THIS
		JUDGEMENT SHALL BE VERIFIED BY UNDERWRITERS
		LABORATORIES, THE ENGINEERING JUDGEMENT AND THE U.L.
		VERIFICATION SHALL BE SUBMITTED AS WRITTEN AND/OR
		GRAPHIC DOCUMENTATION.
		WALL TYPE GENERAL NOTES
	WHI	ERE GYPSUM BOARD ABUTS MASONRY CONSTRUCTION,


2. PROVIDE CONTINUOUS "J"-MOLD AND SEALANT AT JOINT.

6. ALL WALLS TO BE TYPE "A" UNLESS NOTED OTHEWISE..

3. PROVIDE CONTROL JOINTS IN MASONRY WALLS AS PER INDUSTRY

4. PRACTICE AND/OR AS INDICATED. COORDINATE WITH ARCHITECT.

5. PROVIDE ADDITIONAL BRACING AS REQUIRED FOR CONDITION.

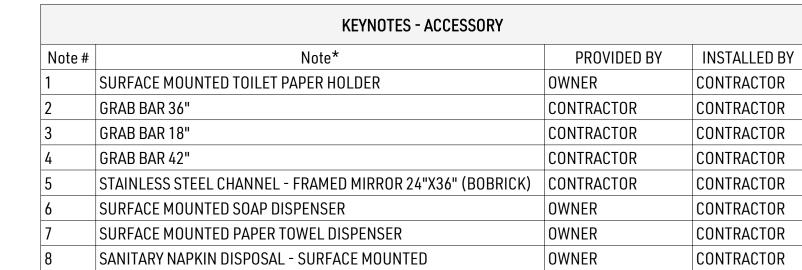

* REFER TO ANTHROPOMORPHIC LEGEND FOR MOUNTING HEIGHTS






NOT FOR CONSTRUCTION

Project #:	24-071.00
Date:	10-28-2024
Drawn by:	CW
Checked by:	SB
Issue:	Date:

15" MIN ACCESSIBLE -INSULATE HOT WATER AND DRAIN PIPES EXPOSED UNDER SINK - STRUCTURAL BRICK PER ACCESSIBLE CODE UNITS - SMOOTH REQUIREMENTS. UTILITY - COLOR: MONTEREY – 4" THICK LIMESTONE VENEER PANEL W/SMOOTH FINISH: TYPICAL SIZE 18" TALL X 36" LONG PROJECTION FROM WALL 8" MIN-13 1/2" MIN NOTE: OWNER/ARCHITECT RESERVES RIGHT TO 17" MIN **URINALS & SCREENS** APPROVE BRICK/MORTAR COLORS PRIOR TO CONSTRUCTION BASED ON APPROVED MOCKUP PANEL ACCESSIBLE LAVATORY CLEARANCES

BLKG DIAGRAM AT PUBLIC SPACE - URINALS

3/8" = 1'-0"

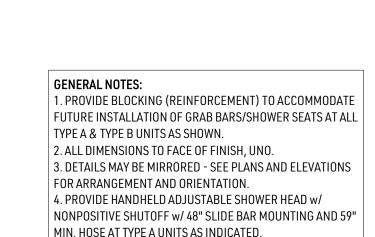


MOCKUP PANEL DETAIL

1/2" = 1'-0"

MIN. HOSE AT TYPE A UNITS AS INDICATED. 5. PROVIDE FIXED SHOWER HEAD AT TYPE B UNITS CENTERED ON ENCLOSURE 80" AFF. 6. TRANSFER TYPE SHOWERS AT TYPE A UNITS SHALL BE 36"x36" AT MIDPOINT OF SIDES. 7. RECTANGULAR SHOWERS SHALL HAVE BLOCKING (REINFORCEMENT) FOR GRAB BARS PER TRANSFER TYPE SHOWERS.



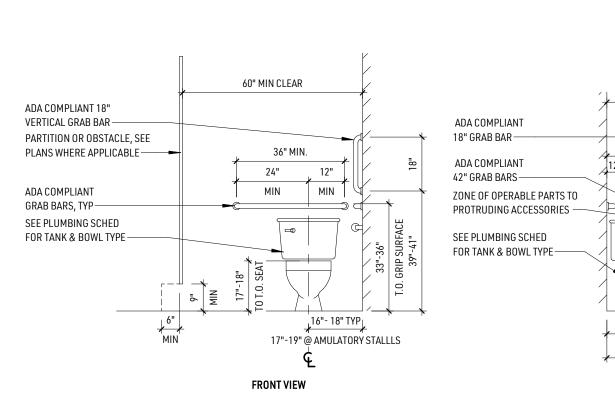

BLKG DIAGRAM AT PUBLIC SPACE - ACCESSIBLE LAVATORY

FACE OF FINISH —

39" - 41"

24" MIN

42" MAX

SIDE VIEW

54" MIN____


42" MIN

WALL OR PARTITION

3/8" = 1'-0"

GENERAL NOTES - BLOCKING ⁷ 3/8" = 1'-0"



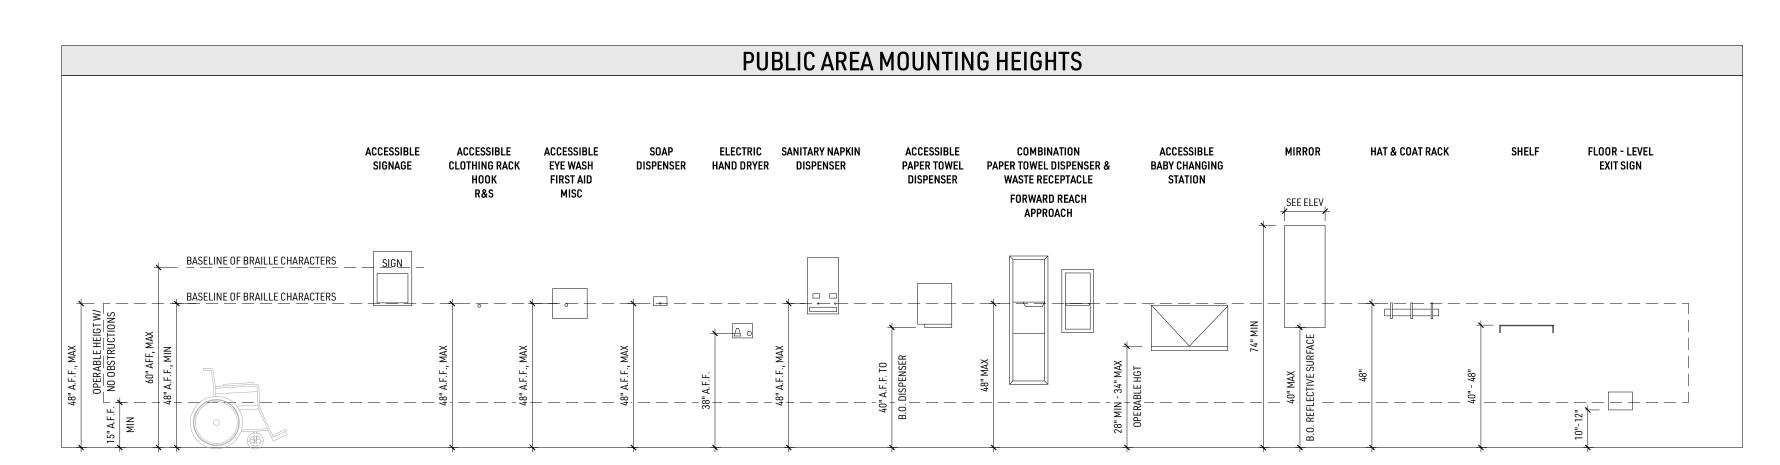

TMPD

T.O. FTG

TOP0

T.O.S.

TRTD

UCL

UGND

TEMPERED

TOP OF FOOTING

TOP OF SLAB

TRFATED

TYPICAL

TUBE STEEL

TELEVISION

UNDERCOUNTER

UNDERGROUND


UNIT HEATER

TOPOGRAPHY, TOPOGRAPHIC

TOILET PAPER (DISPENSER)

UNDER CABINET LIGHTING

TOP OF

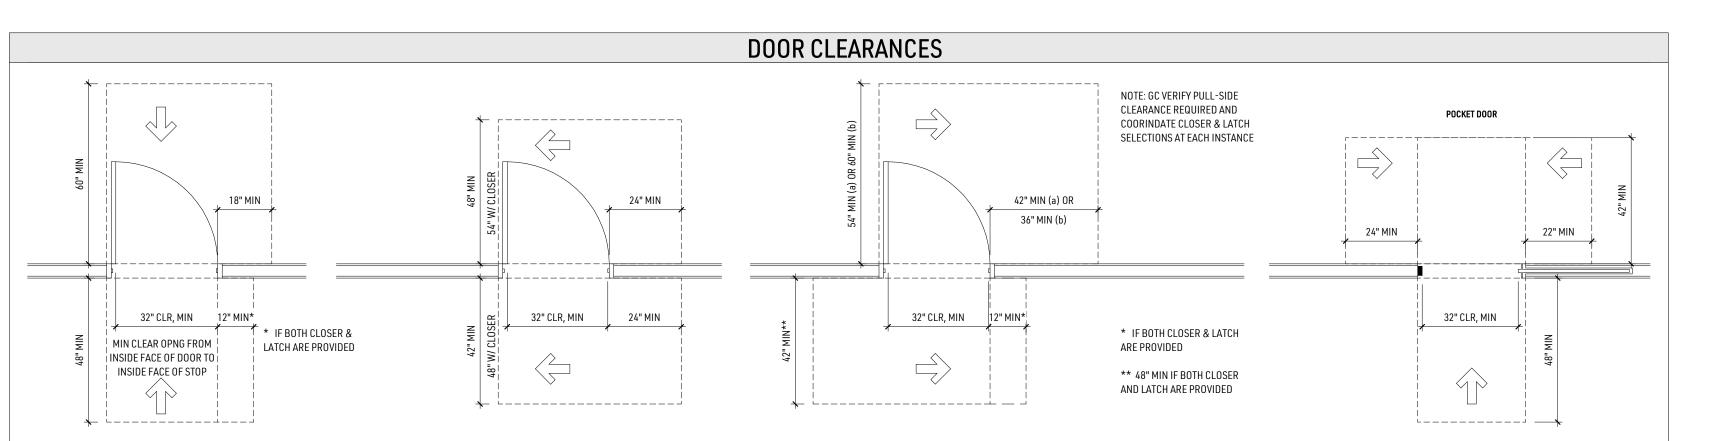

S

4

Table 504.3: Allowable Building Height in Feet Above Grade Plane B IIB NS

Table 504.4: Allowable Number of Stories Above Grade Plane Group Type Sprinkler Allowed Actual Stories Stories B IIB NS

LIFE SAFETY LEGEND

0" / 0" Exit Width Reg'd / Provided

Direction of Egress

0 — Occupant Load

A1 <u>LEVEL 1</u> 3/16" = 1'-0"

Opening Rating (minutes)

Emergency Exit Lighting & Signage

Surface Mounted Fire Extinguisher

1-Hour Fire Barrier

Section 506: Building Area 506.2: Allowable Area Determination Table 506.2: Allowable Area Factor in Square Feet Per Floor Group Type Sprinkler Allowed Area NS 23,000 IIB Actual Areas: Group

6,052

CODE REVIEW 509: Incidental Uses: Incidental uses listed in Table 509 shall be

separated from the remainder of the building or equipped with an Section 702: Multiple Use Fire Assemblies automatic sprinkler system, or both. 702.1: Fire assemblies that serve multiple purposes in a building shall 509.1: Separation: The incidental uses shall be separated from comply with all of the requirements that are applicable for each of the the remainder of the building by a FIRE BARRIER or a individual fire assemblies. HORIZONTAL ASSEMBLY

Section 705: Exterior Walls

each individual story.

through 705.8.6

Table 705.8

15 to less than 20

20 to less than 25

25 to less than 30

Section 705.8.

Section 707: Fire Barriers

building type of construction.

shall comply with this section.

Section 716: Opening Protectives

thereto.

Markings

Type of Assembly

30 or greater

705.8: Openings in exterior walls shall comply with Sections 705.8.1

705.8.1: Allowable Area of Openings. The maximum area of

in any story of a building shall not exceed the percentages

unprotected and protected openings permitted in an exterior wall

specified in Table 705.8 based on the fire separation distance of

UP, S

UP, S

UP, S

UP, S

705.11: Parapets shall be provided on exterior walls of buildings.

1. The wall is not required to be fire-resistance rated in

accordance with Table 602 because of fire separation

6. Where the wall is permitted to have not less than 25 percent

of the exterior wall areas containing unprotected openings based

on fire separation distance as determined in accordance with

707.1: General. Fire Barriers installed as required elsewhere in this

707.2: Materials. Fire barriers shall be of materials permitted by the

707.3: Fire-Resistance Rating. The fire resistance rating of fire barriers

foundation or floor/ ceiling assembly below to the underside of the floor

Req'd Wall Fire Door/

Assembly Fire Glazing Transom

or roof sheathing, slab or deck above and shall be securely attached

code or the International Fire Code shall comply with this section.

707.5: Continuity. Fire Barriers shall extend from the top of the

Table 716.1(2) Opening Fire Protection assemblies, Ratings and

Fire Barrier: Other 1 hour 45 min.

Table 509: Incidental Uses Separation Room or Area Rooms with boilers where the largest piece of equipment is

over 15 psi and 10 horsepower **CHAPTER 6: TYPES OF CONSTRUCTION** Section 602: Construction Classification Table 601: Fire-Resistance Rating Requirements for Building

Elements (Hours) Primary Structural Frame Bearing Walls Exterior Bearing Walls Interior Nonbearing Walls Exterior See Table 602 Nonbearing Walls Interior Floor Construction Roof Construction

Table 602: Fire-Resistance Rating Requirements for Exterior Walls Based on Fire Separation Distance: Fire Separation Distance Type of Const. Occupancy Rating 10′ ≤ X < 30′ 0 Hour 0 Hour

Section 603: Combustible Material in Types I and II Construction 603.1: Allowable Materials: Combustible materials shall be permitted in buildings of Type I and II construction in the following applications and in accordance with Section 603.1.1 through 603.1.3. 603.1.2: Thermal and acoustical insulation, other than foam plastics, having a flame spread index of not more than 25. Exception 1: Insulated panels placed between two layers of noncombustible materials without an intervening airspace shall be allowed to have a flame spread index of not more than 100. 603.1.13: Combustible exterior wall coverings, balconies, and similar projections and bay or oriel windows in accordance with Chapter 14 and Section 705.2.3.1. 603.1.14: Blocking such as for handrails, millwork, cabinets and

window and door frames.

CODE REVIEW CODE REVIEW (CONTINUED)

CHAPTER 7: FIRE AND SMOKE PROTECTION FEATURES CHAPTER 9: FIRE PROTECTION AND LIFE SAFETY SYSTEMS Section 903: Automatic Sprinkler Systems 903.3: Installation Requirements: Not required per Section 903 B occupancy

> Section 906: Portable Fire Extinguishers Table 906.3: Size and Distribution. Maximum floor area for extinguisher 11,250 sf. Maximum travel distance to extinguisher 75

Section 912: Fire Department Connections 912.2: Location. Fire department connections shall be located on the street side of buildings, fully visible and recognizable from the street or as approved by fire code official.

Chapter 10: MEANS OF EGRESS Fire Separation Dist Degree of Opng Protection Allowable Area Section 1003: General Means of Egress 1003.2: Ceiling Height. The means of egress shall have a ceiling No Limit height not less than 7 feet 6 inches above finished floor, except as No Limit permitted by this section. No Limit 1003.3: Protruding Objects.

> 1003.3.1: Headroom. Protruding objects are permitted to extend below the minimum ceiling height where a minimum headroom of 80 inches is provided over circulation paths. Not more than 50% of the ceiling area shall be reduced in height by protruding

1003.3.3: Horizontal Projections. Objects with leading edges more than 27" and not more than 80" AFF shall not project horizontally more than 4" into circulation path.

Section 1004: Occupant Load Table 1004.5 Maximum Floor Area per Occupant, see plans for occupant load tabulations Assembly Tables and Chairs 15 NSF **Business Areas** 150 GSF 300 GSF Storage, Trash, Mech, Elec

Total Occupant Load

1004.9: Posting of Occupant Load. Every room or space that is an assembly occupancy shall have the occupant load of the room posted in a conspicuous place, near the main exit from the room.

Section 1005: Means of Egress Sizing 1005.3: Required capacity based on occupant load. Stairways: 0.3" per occupant. Other Components: 0.2" per occupant 1005.7: Encroachment. Doors, when fully opened, shall not reduce the required width by more than 7". Doors in any position shall not reduce the required width by more than one-half.

CODE REVIEW (CONTINUED)

Section 1006: Number of Exits and Exit Access Doorways. Table 1006.2.1 Spaces with One Exit or Exit Access Doorway (non-sprinkled buildings) Occupancy Max Occupant Load Max Common Path of Egress B 49

Section 1007: Exit and Exit Access Doorway Configuration 1007.1.1: Two exits. Where two exits are required, they shall be placed a distance apart equal to one-half the maximum diagonal of the building or area.

Section 1009: Accessible Means of Egress 1009.1 Accessible Means of Egress Required. Accessible means of egress shall comply with this section. Accessible spaces shall be provided with not less than one accessible means of egress. Where more than one means of egress are required by Section 1006.2 or 1006.3 from any accessible space, each accessible portion of the space shall be served by not less than two accessible means of egress.

Section 1017: Exit Access Travel Distance Table 1017.2: Exit Access Travel Distance (non-sprinkled building) Occupancy Maximum Distance

200' **CHAPTER 29: PLUMBING REQUIREMENTS** 37 Total B Occupants (19 Men /19 Women) <u>Fixture</u> Ratio Req'd Prov'd Water Closets: Men 1 per 25 1 Water Closets: Women 1 per 25 1 Lavatories: Men 1 per 40 Lavatories: Women 1 per 40 Drinking Fountains 1 per 100 1 Service Sink

Total Water Closets Total Lavatories

2902.1 Minimum Number of Fixtures The required number of toilet fixtures may be based on the actual occupancy load rather than the load determined by square footage per IBC Table 1004.1.1. The actual occupancy load shall be based on justification found acceptable to the department.


> 2. Where drinking fountains are required, other reasonable alternatives are acceptable, as approved by the department.


333 Washington Ave N, Suite 210 Minneapolis, Minnesota 55401 612.676.2700 www.djr-inc.com



NOT FOR

Project #:	24-071.00
Date:	10-28-2024
Drawn by:	CW
Checked by:	SB
Issue:	Date:

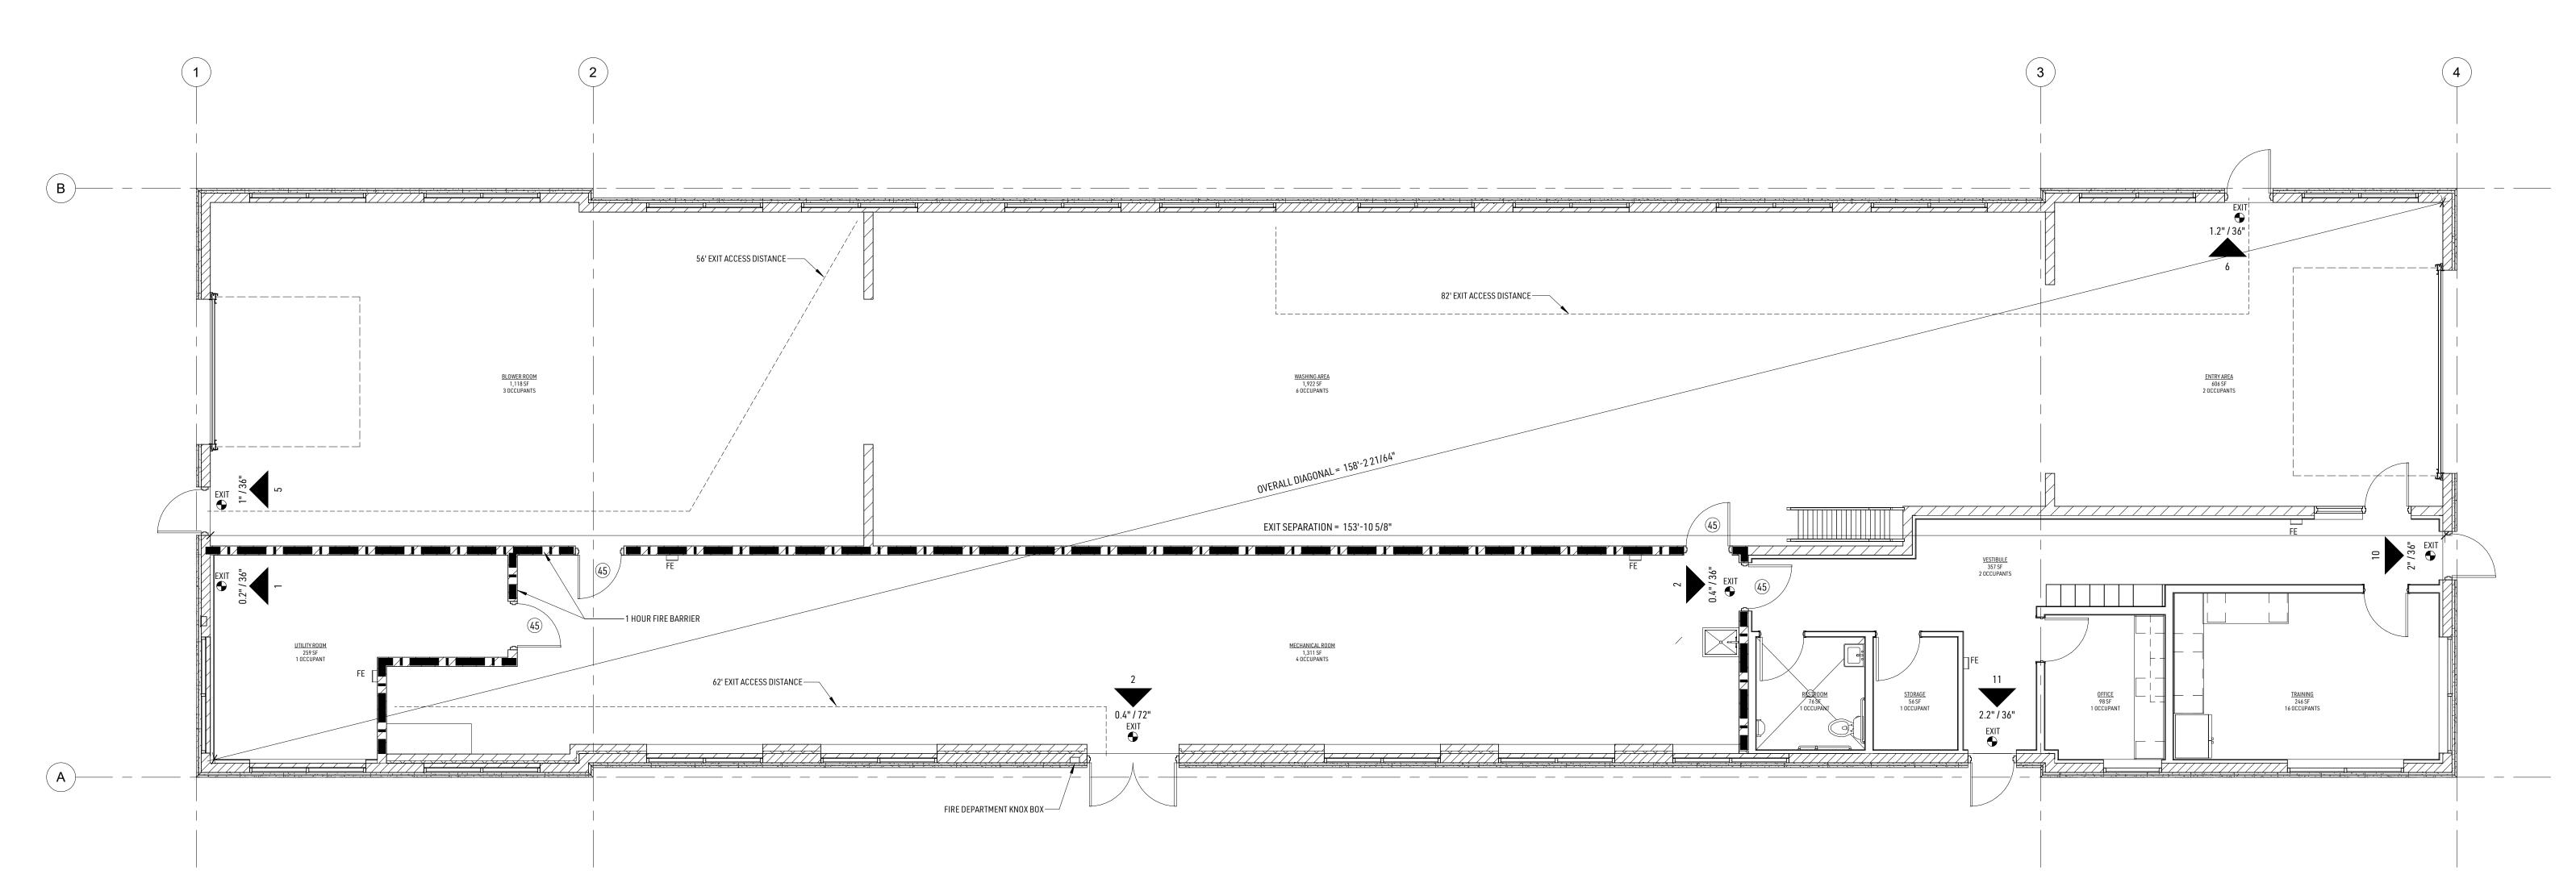

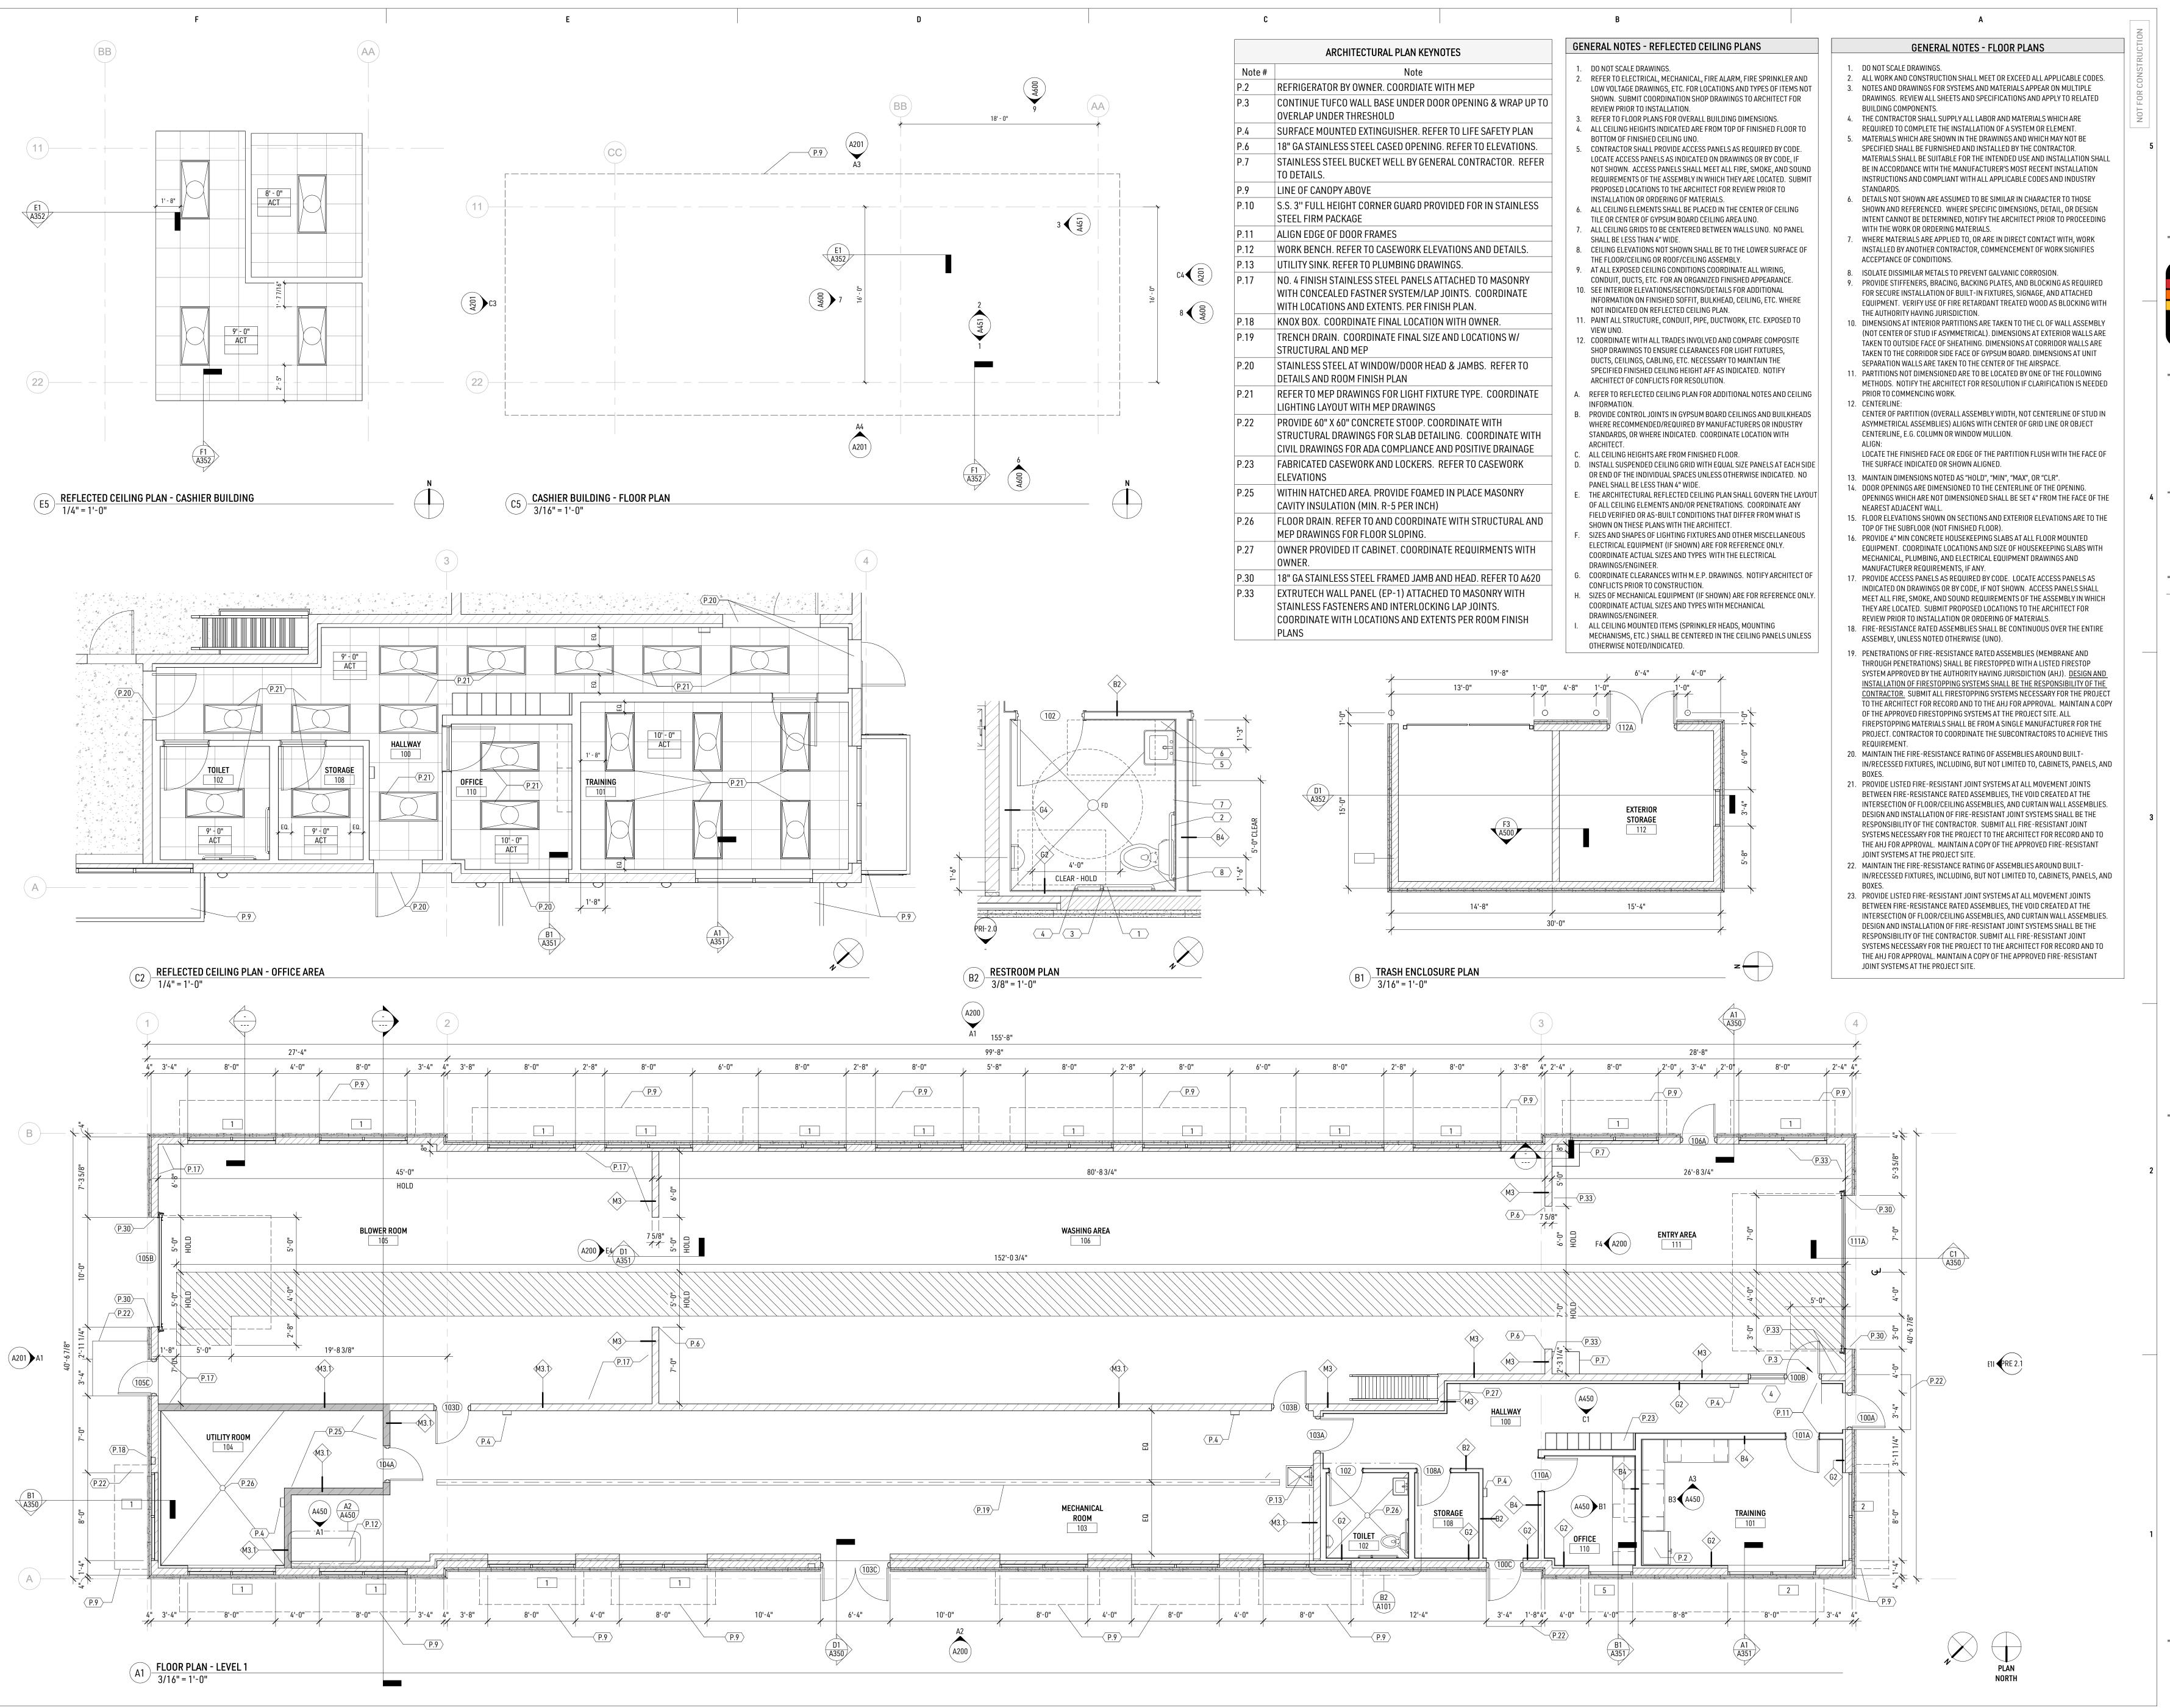

DJR

333 Washington Ave N, Suite 210 Minneapolis, Minnesota 55401 612.676.2700 www.djr-inc.com





NOT FOR CONSTRUCTION

Project #: 24-071.00
Date: 10-28-2024
Drawn by: CW
Checked by: SB

CREW CARWA
3333 STATE ROAD 16 - LA CROSSE, WI

A101

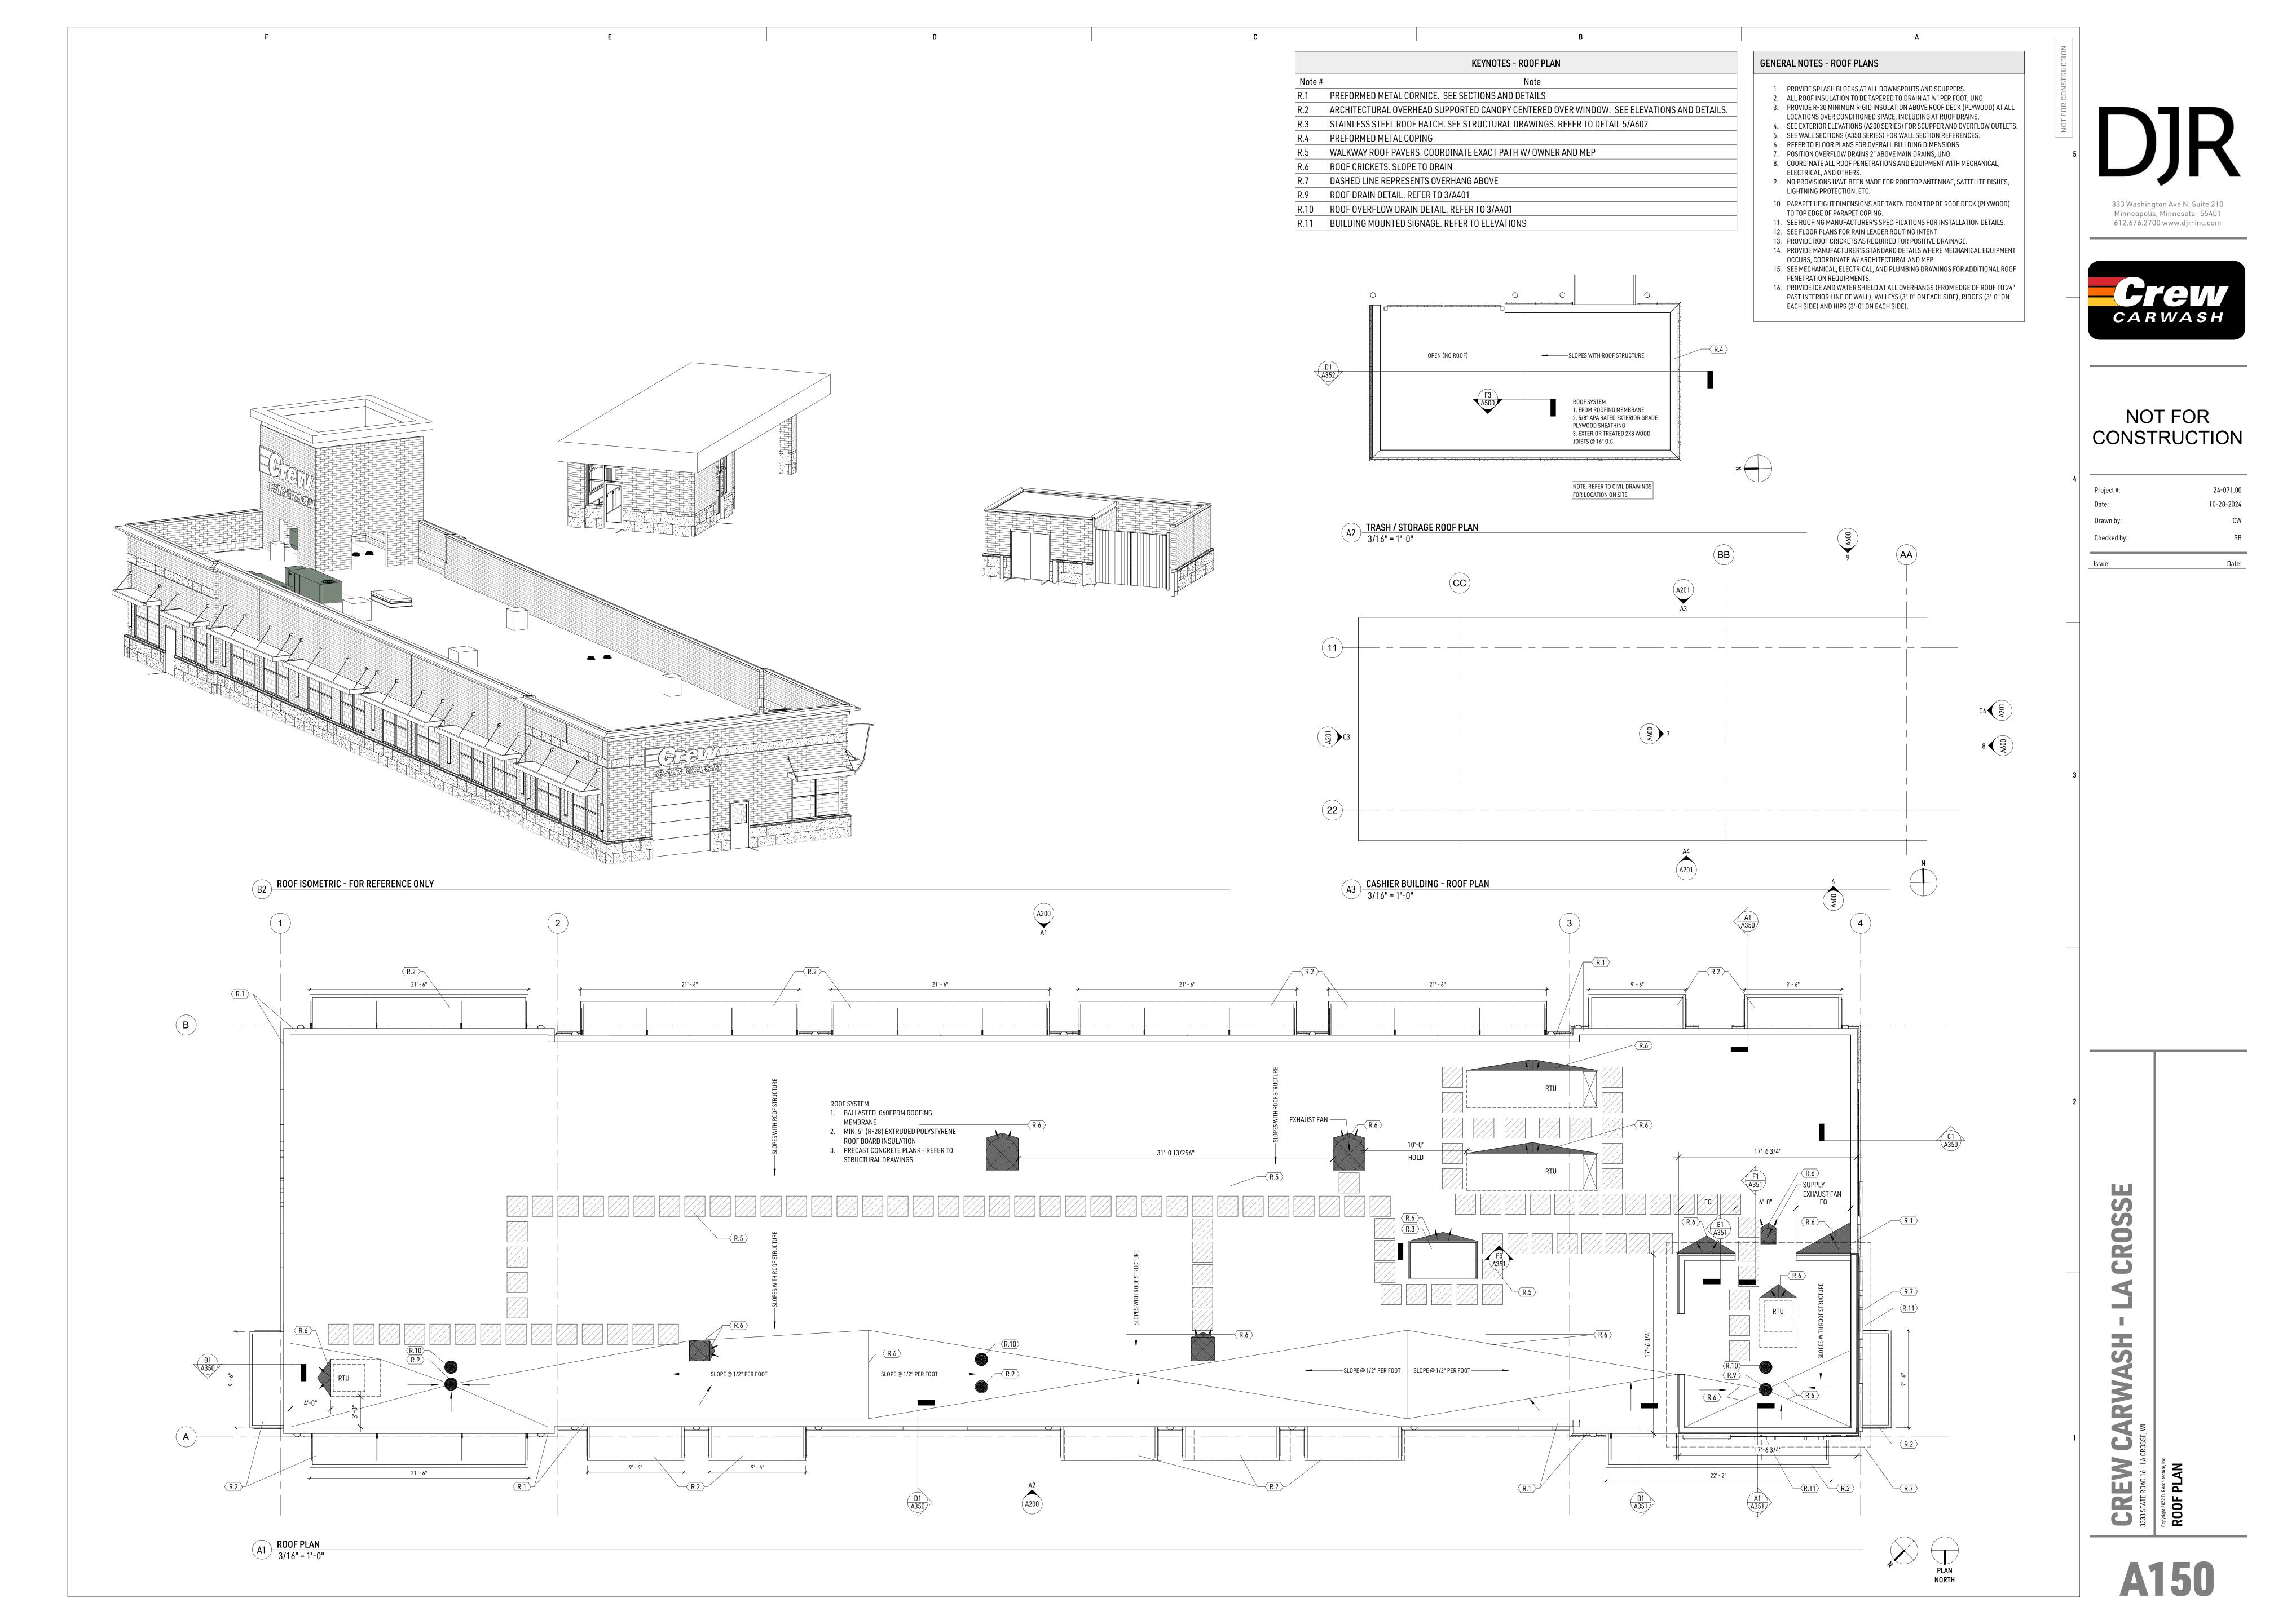

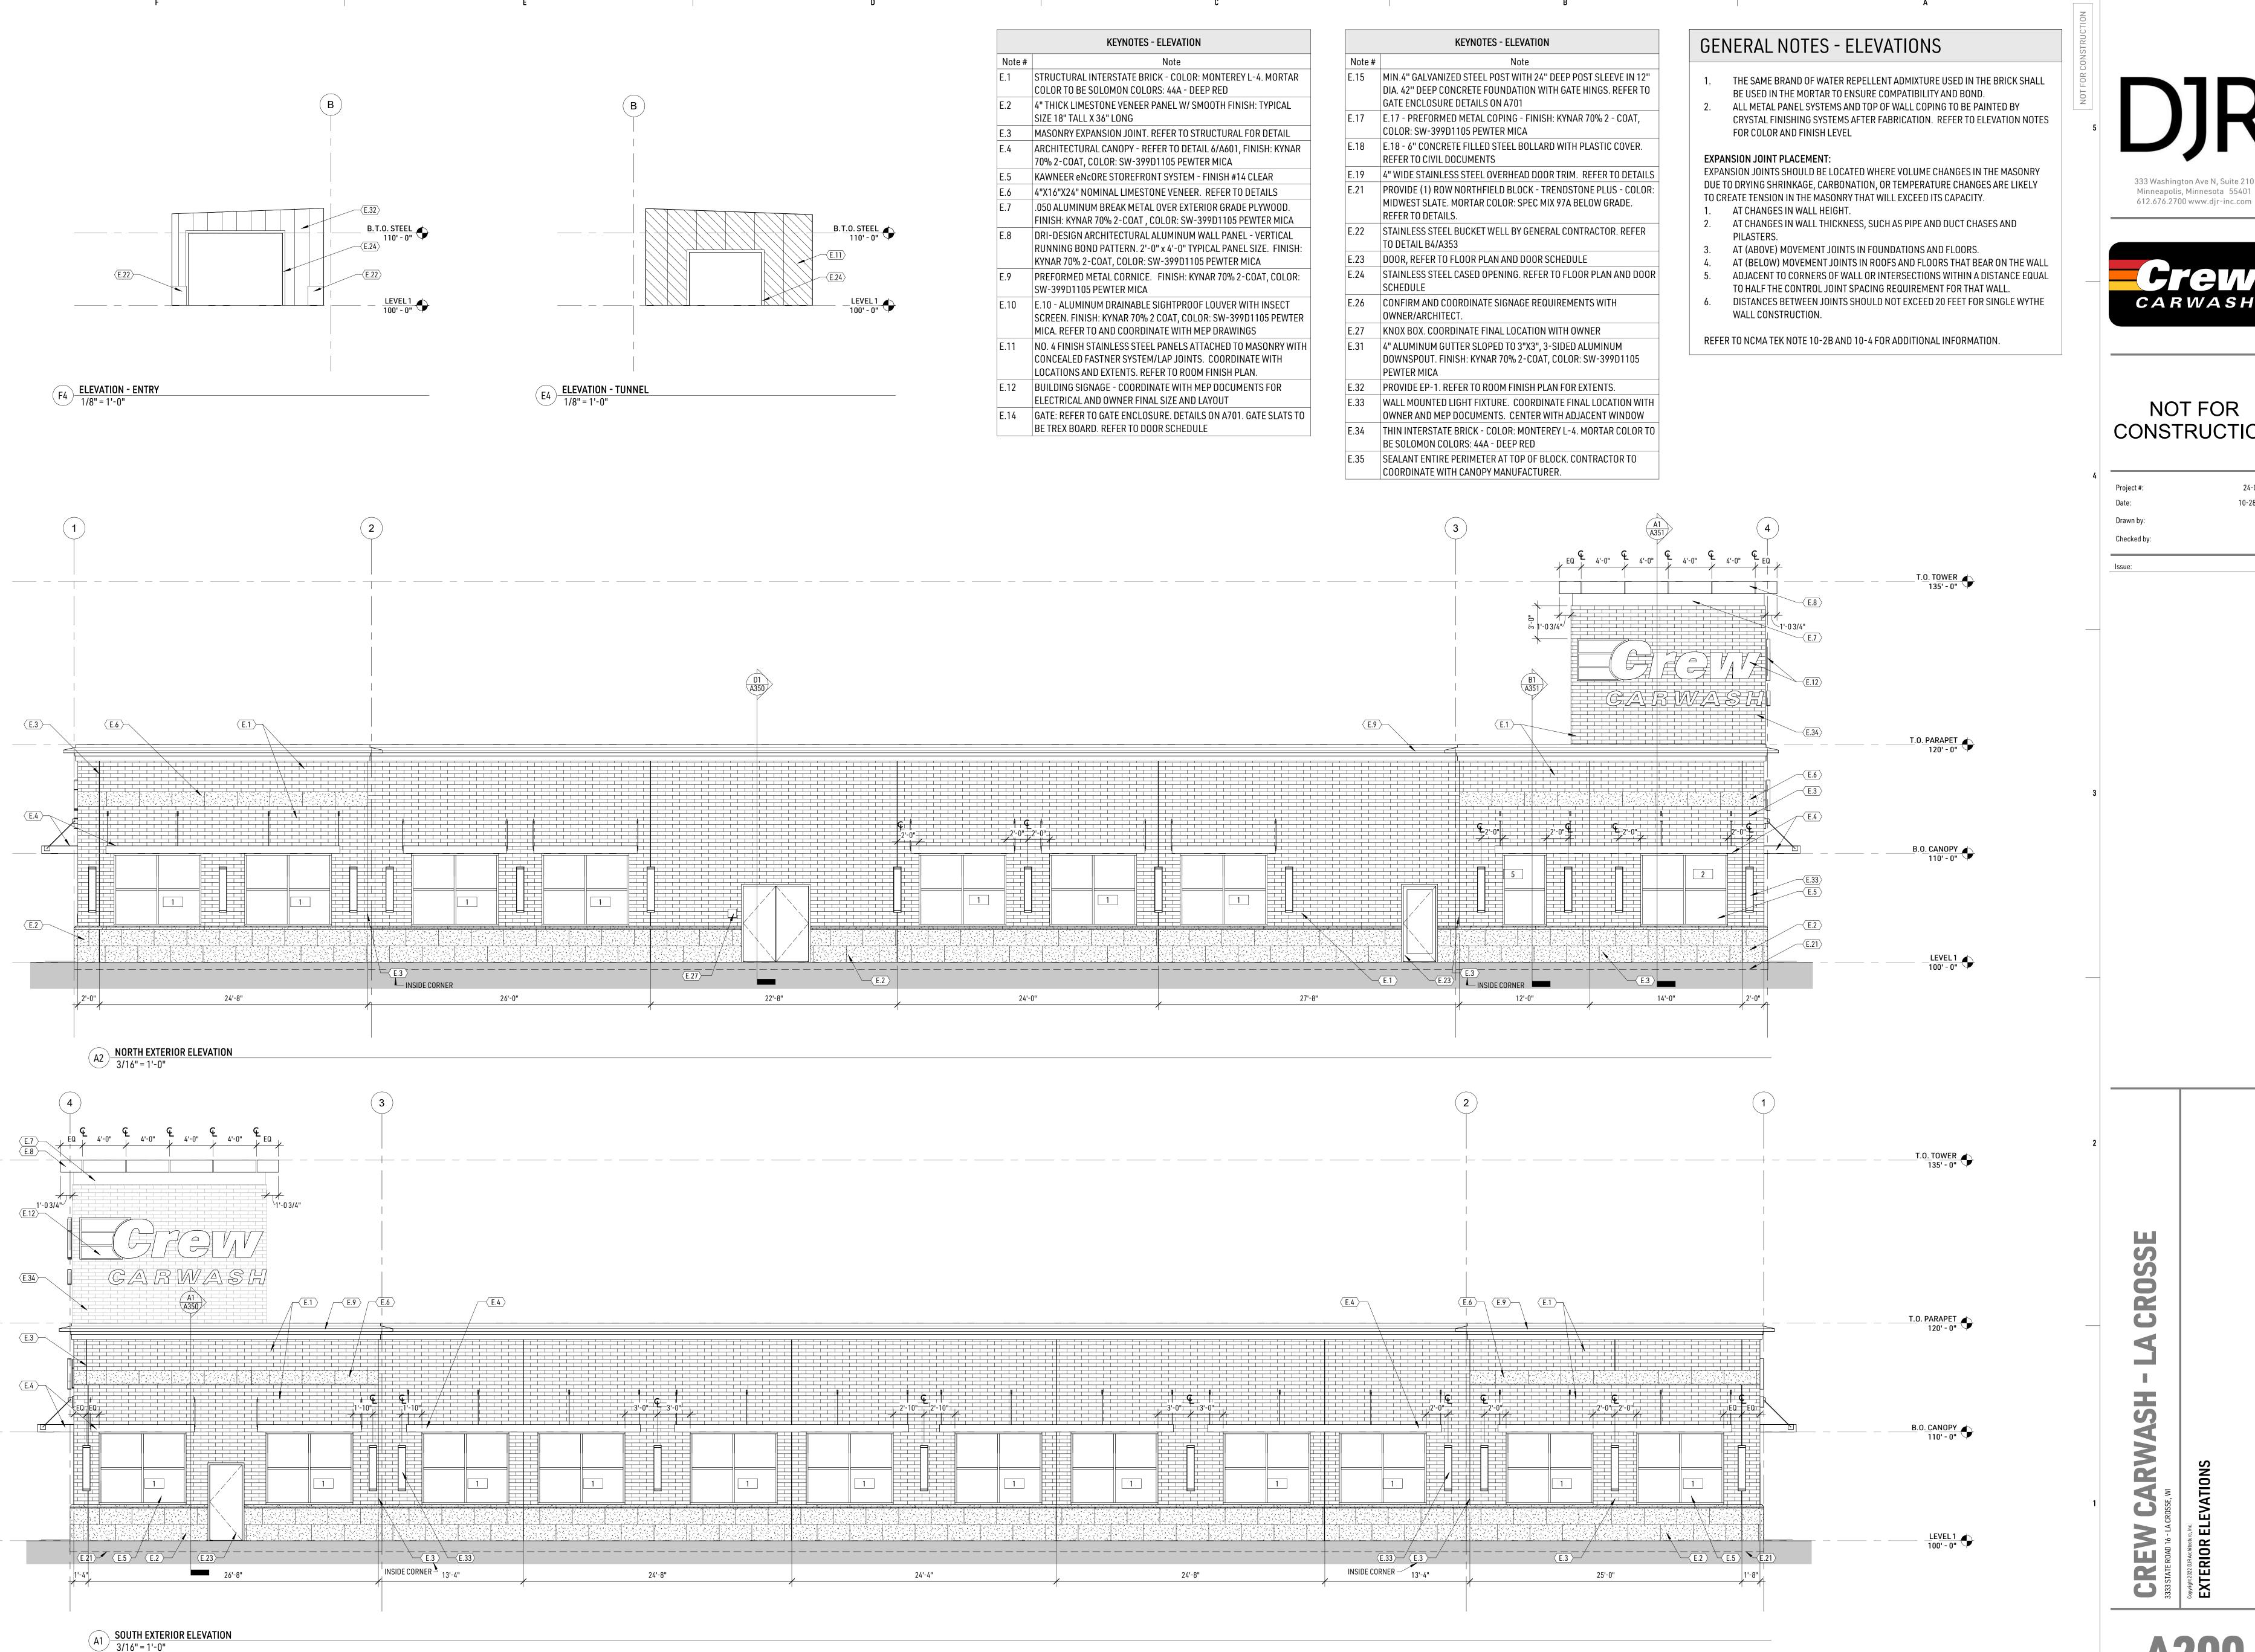


333 Washington Ave N, Suite 210 Minneapolis, Minnesota 55401



NOT FOR CONSTRUCTION

24-071.00 10-28-2024 Checked by: Date:

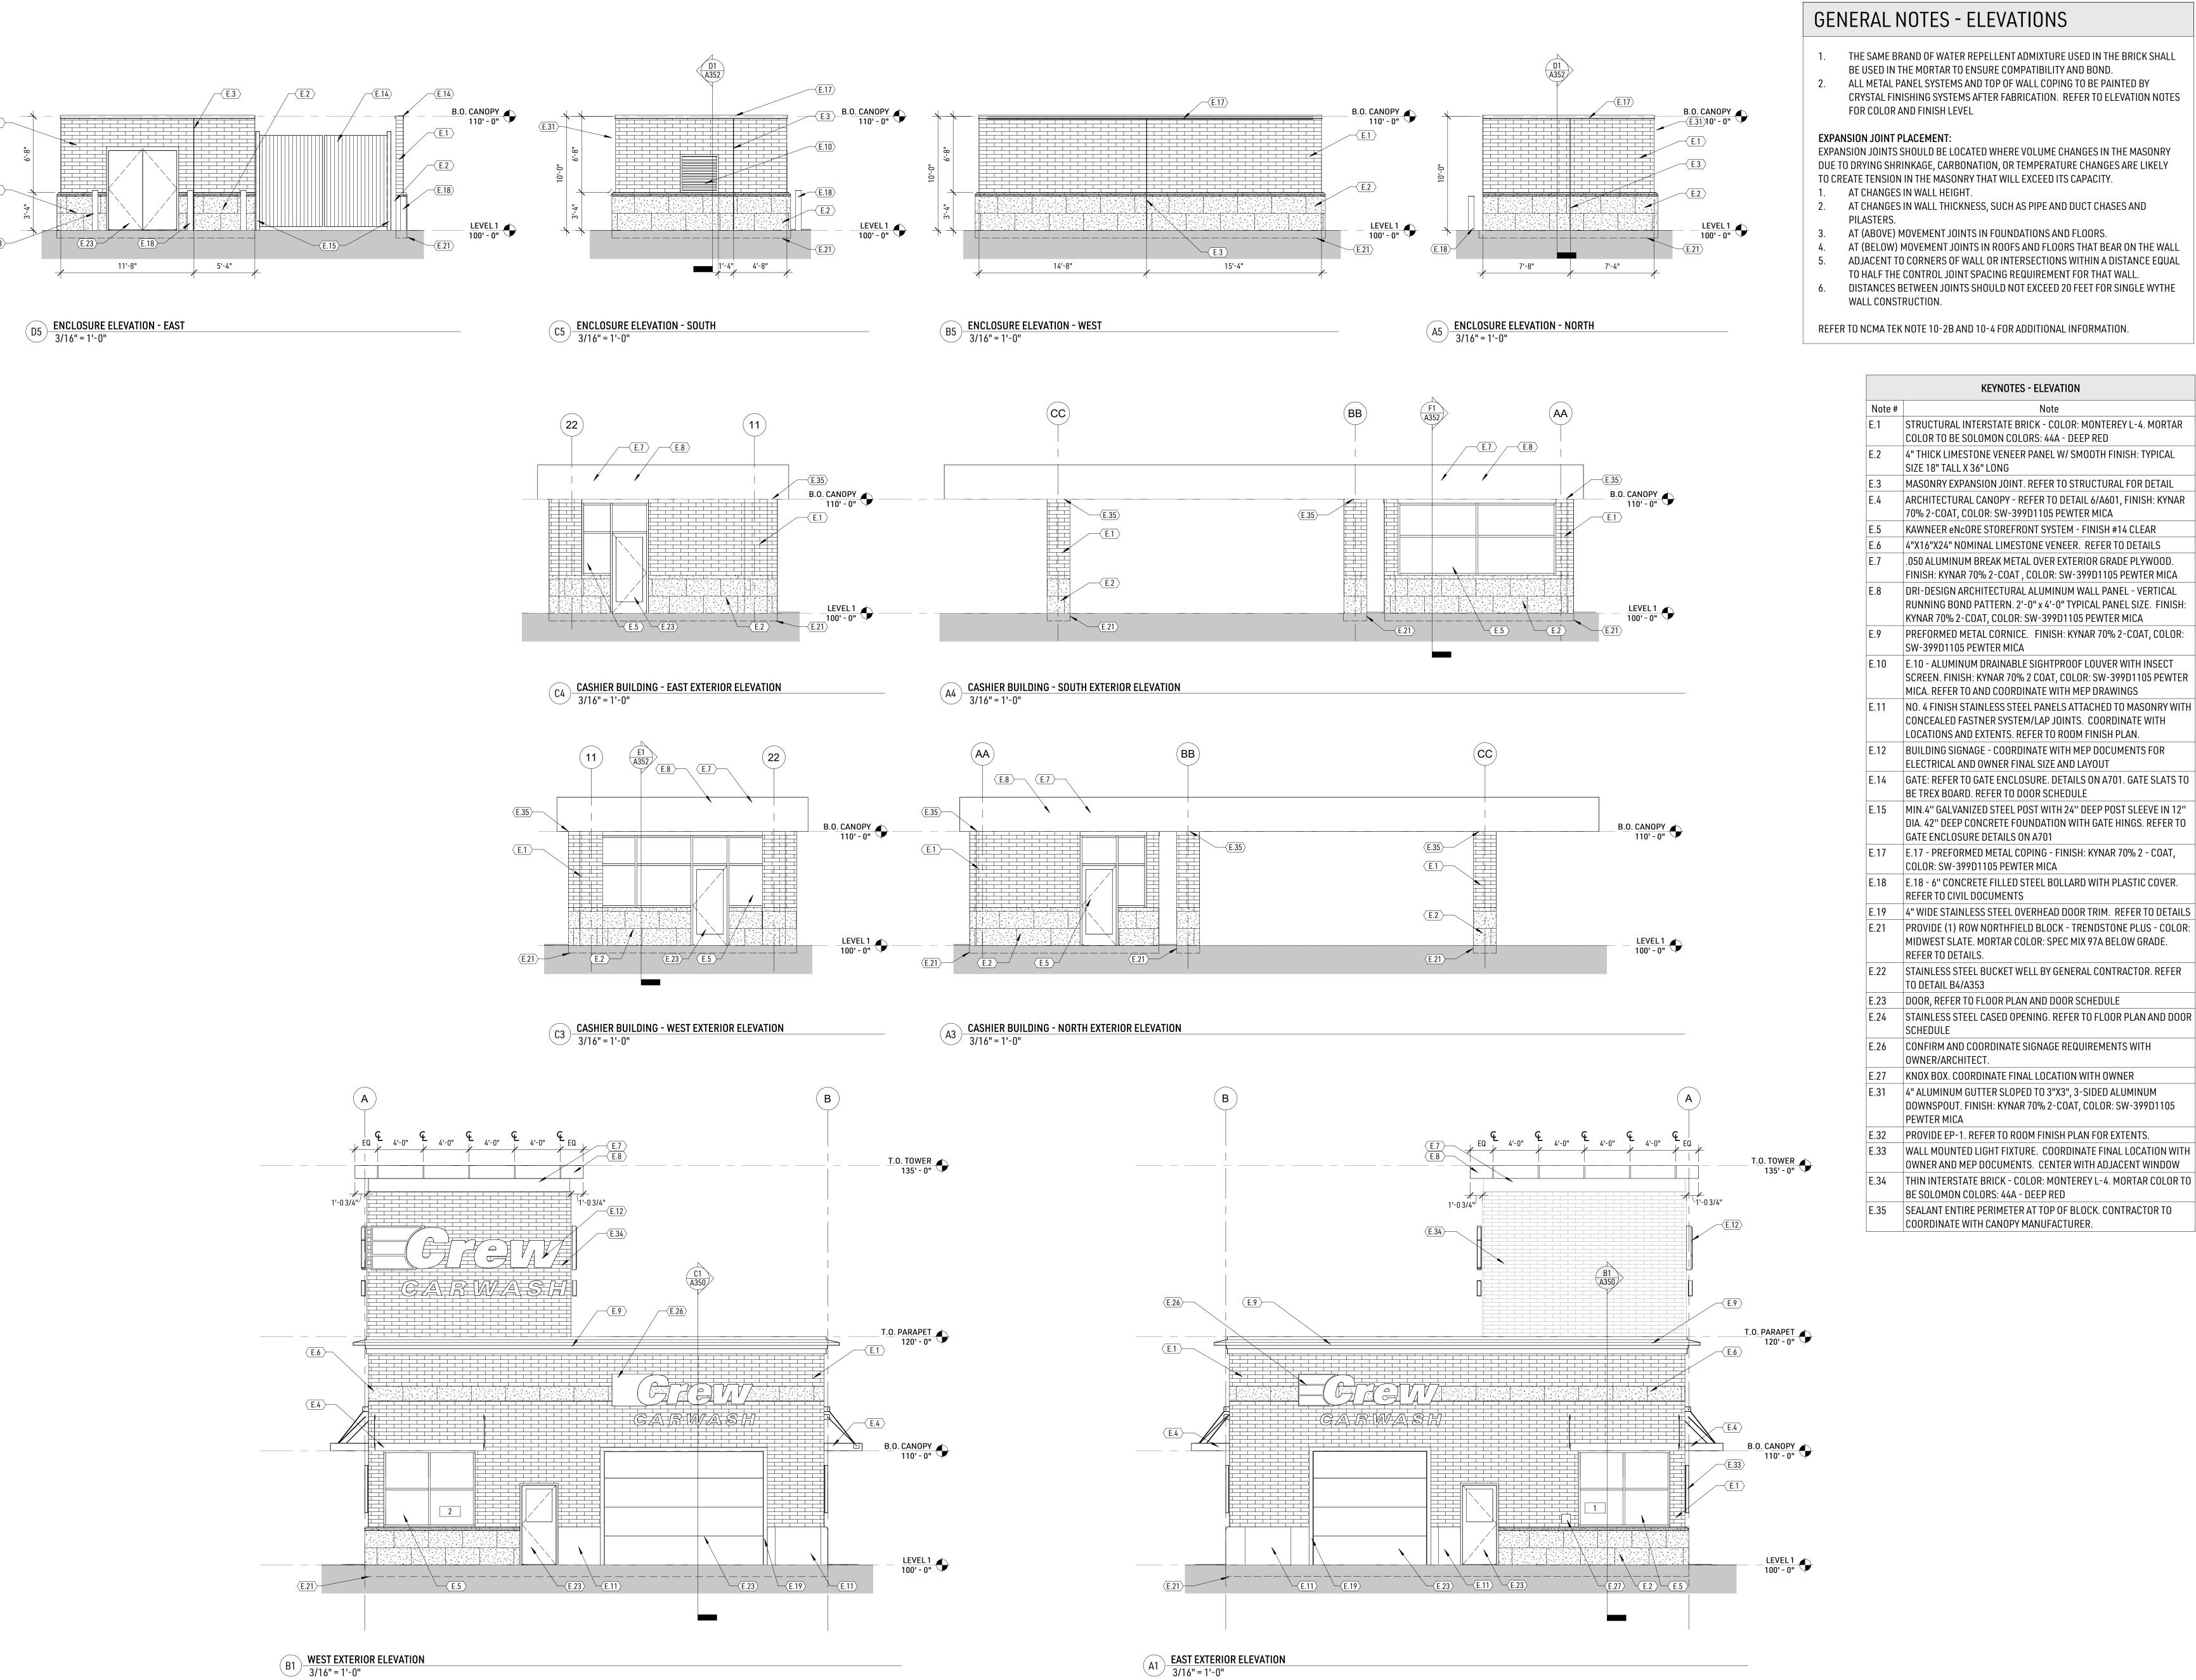

GENERAL NOTES - ELEVATIONS

- THE SAME BRAND OF WATER REPELLENT ADMIXTURE USED IN THE BRICK SHALL BE USED IN THE MORTAR TO ENSURE COMPATIBILITY AND BOND.
- 2. ALL METAL PANEL SYSTEMS AND TOP OF WALL COPING TO BE PAINTED BY CRYSTAL FINISHING SYSTEMS AFTER FABRICATION. REFER TO ELEVATION NOTES

EXPANSION JOINT PLACEMENT:

EXPANSION JOINTS SHOULD BE LOCATED WHERE VOLUME CHANGES IN THE MASONRY DUE TO DRYING SHRINKAGE, CARBONATION, OR TEMPERATURE CHANGES ARE LIKELY TO CREATE TENSION IN THE MASONRY THAT WILL EXCEED ITS CAPACITY.

- AT CHANGES IN WALL HEIGHT. AT CHANGES IN WALL THICKNESS, SUCH AS PIPE AND DUCT CHASES AND
- AT (ABOVE) MOVEMENT JOINTS IN FOUNDATIONS AND FLOORS.
- TO HALF THE CONTROL JOINT SPACING REQUIREMENT FOR THAT WALL.
- 6. DISTANCES BETWEEN JOINTS SHOULD NOT EXCEED 20 FEET FOR SINGLE WALL CONSTRUCTION.

KEYNOTES - ELEVATION

COLOR TO BE SOLOMON COLORS: 44A - DEEP RED

70% 2-COAT, COLOR: SW-399D1105 PEWTER MICA

STRUCTURAL INTERSTATE BRICK - COLOR: MONTEREY L-4. MORTAR

4" THICK LIMESTONE VENEER PANEL W/ SMOOTH FINISH: TYPICAL

MASONRY EXPANSION JOINT. REFER TO STRUCTURAL FOR DETAIL

KAWNEER eNcORE STOREFRONT SYSTEM - FINISH #14 CLEAR

4"X16"X24" NOMINAL LIMESTONE VENEER. REFER TO DETAILS .050 ALUMINUM BREAK METAL OVER EXTERIOR GRADE PLYWOOD. FINISH: KYNAR 70% 2-COAT, COLOR: SW-399D1105 PEWTER MICA

DRI-DESIGN ARCHITECTURAL ALUMINUM WALL PANEL - VERTICAL RUNNING BOND PATTERN. 2'-0" x 4'-0" TYPICAL PANEL SIZE. FINISH:

PREFORMED METAL CORNICE. FINISH: KYNAR 70% 2-COAT, COLOR:

SCREEN. FINISH: KYNAR 70% 2 COAT, COLOR: SW-399D1105 PEWTER

DIA. 42" DEEP CONCRETE FOUNDATION WITH GATE HINGS. REFER TO

MIDWEST SLATE. MORTAR COLOR: SPEC MIX 97A BELOW GRADE.

STAINLESS STEEL CASED OPENING. REFER TO FLOOR PLAN AND DOOR

DOWNSPOUT. FINISH: KYNAR 70% 2-COAT, COLOR: SW-399D1105

OWNER AND MEP DOCUMENTS. CENTER WITH ADJACENT WINDOW

BE SOLOMON COLORS: 44A - DEEP RED

COORDINATE WITH CANOPY MANUFACTURER.

CONCEALED FASTNER SYSTEM/LAP JOINTS. COORDINATE WITH

KYNAR 70% 2-COAT, COLOR: SW-399D1105 PEWTER MICA

MICA. REFER TO AND COORDINATE WITH MEP DRAWINGS

LOCATIONS AND EXTENTS. REFER TO ROOM FINISH PLAN.

ELECTRICAL AND OWNER FINAL SIZE AND LAYOUT

BE TREX BOARD. REFER TO DOOR SCHEDULE

GATE ENCLOSURE DETAILS ON A701

COLOR: SW-399D1105 PEWTER MICA

REFER TO CIVIL DOCUMENTS

REFER TO DETAILS.

TO DETAIL B4/A353

OWNER/ARCHITECT.

SCHEDULE

PEWTER MICA

ARCHITECTURAL CANOPY - REFER TO DETAIL 6/A601, FINISH: KYNAR

REFER TO NCMA TEK NOTE 10-2B AND 10-4 FOR ADDITIONAL INFORMATION.

SIZE 18" TALL X 36" LONG

SW-399D1105 PEWTER MICA

E WYTHE	CARWASH

NOT FOR CONSTRUCTION


333 Washington Ave N, Suite 210


Minneapolis, Minnesota 55401

612.676.2700 www.djr-inc.com

,		
4	Project #: Date:	24-071.00 10-28-2024
	Drawn by:	CW
	Checked by:	SB

ROSSE 4 RW 4 CREW

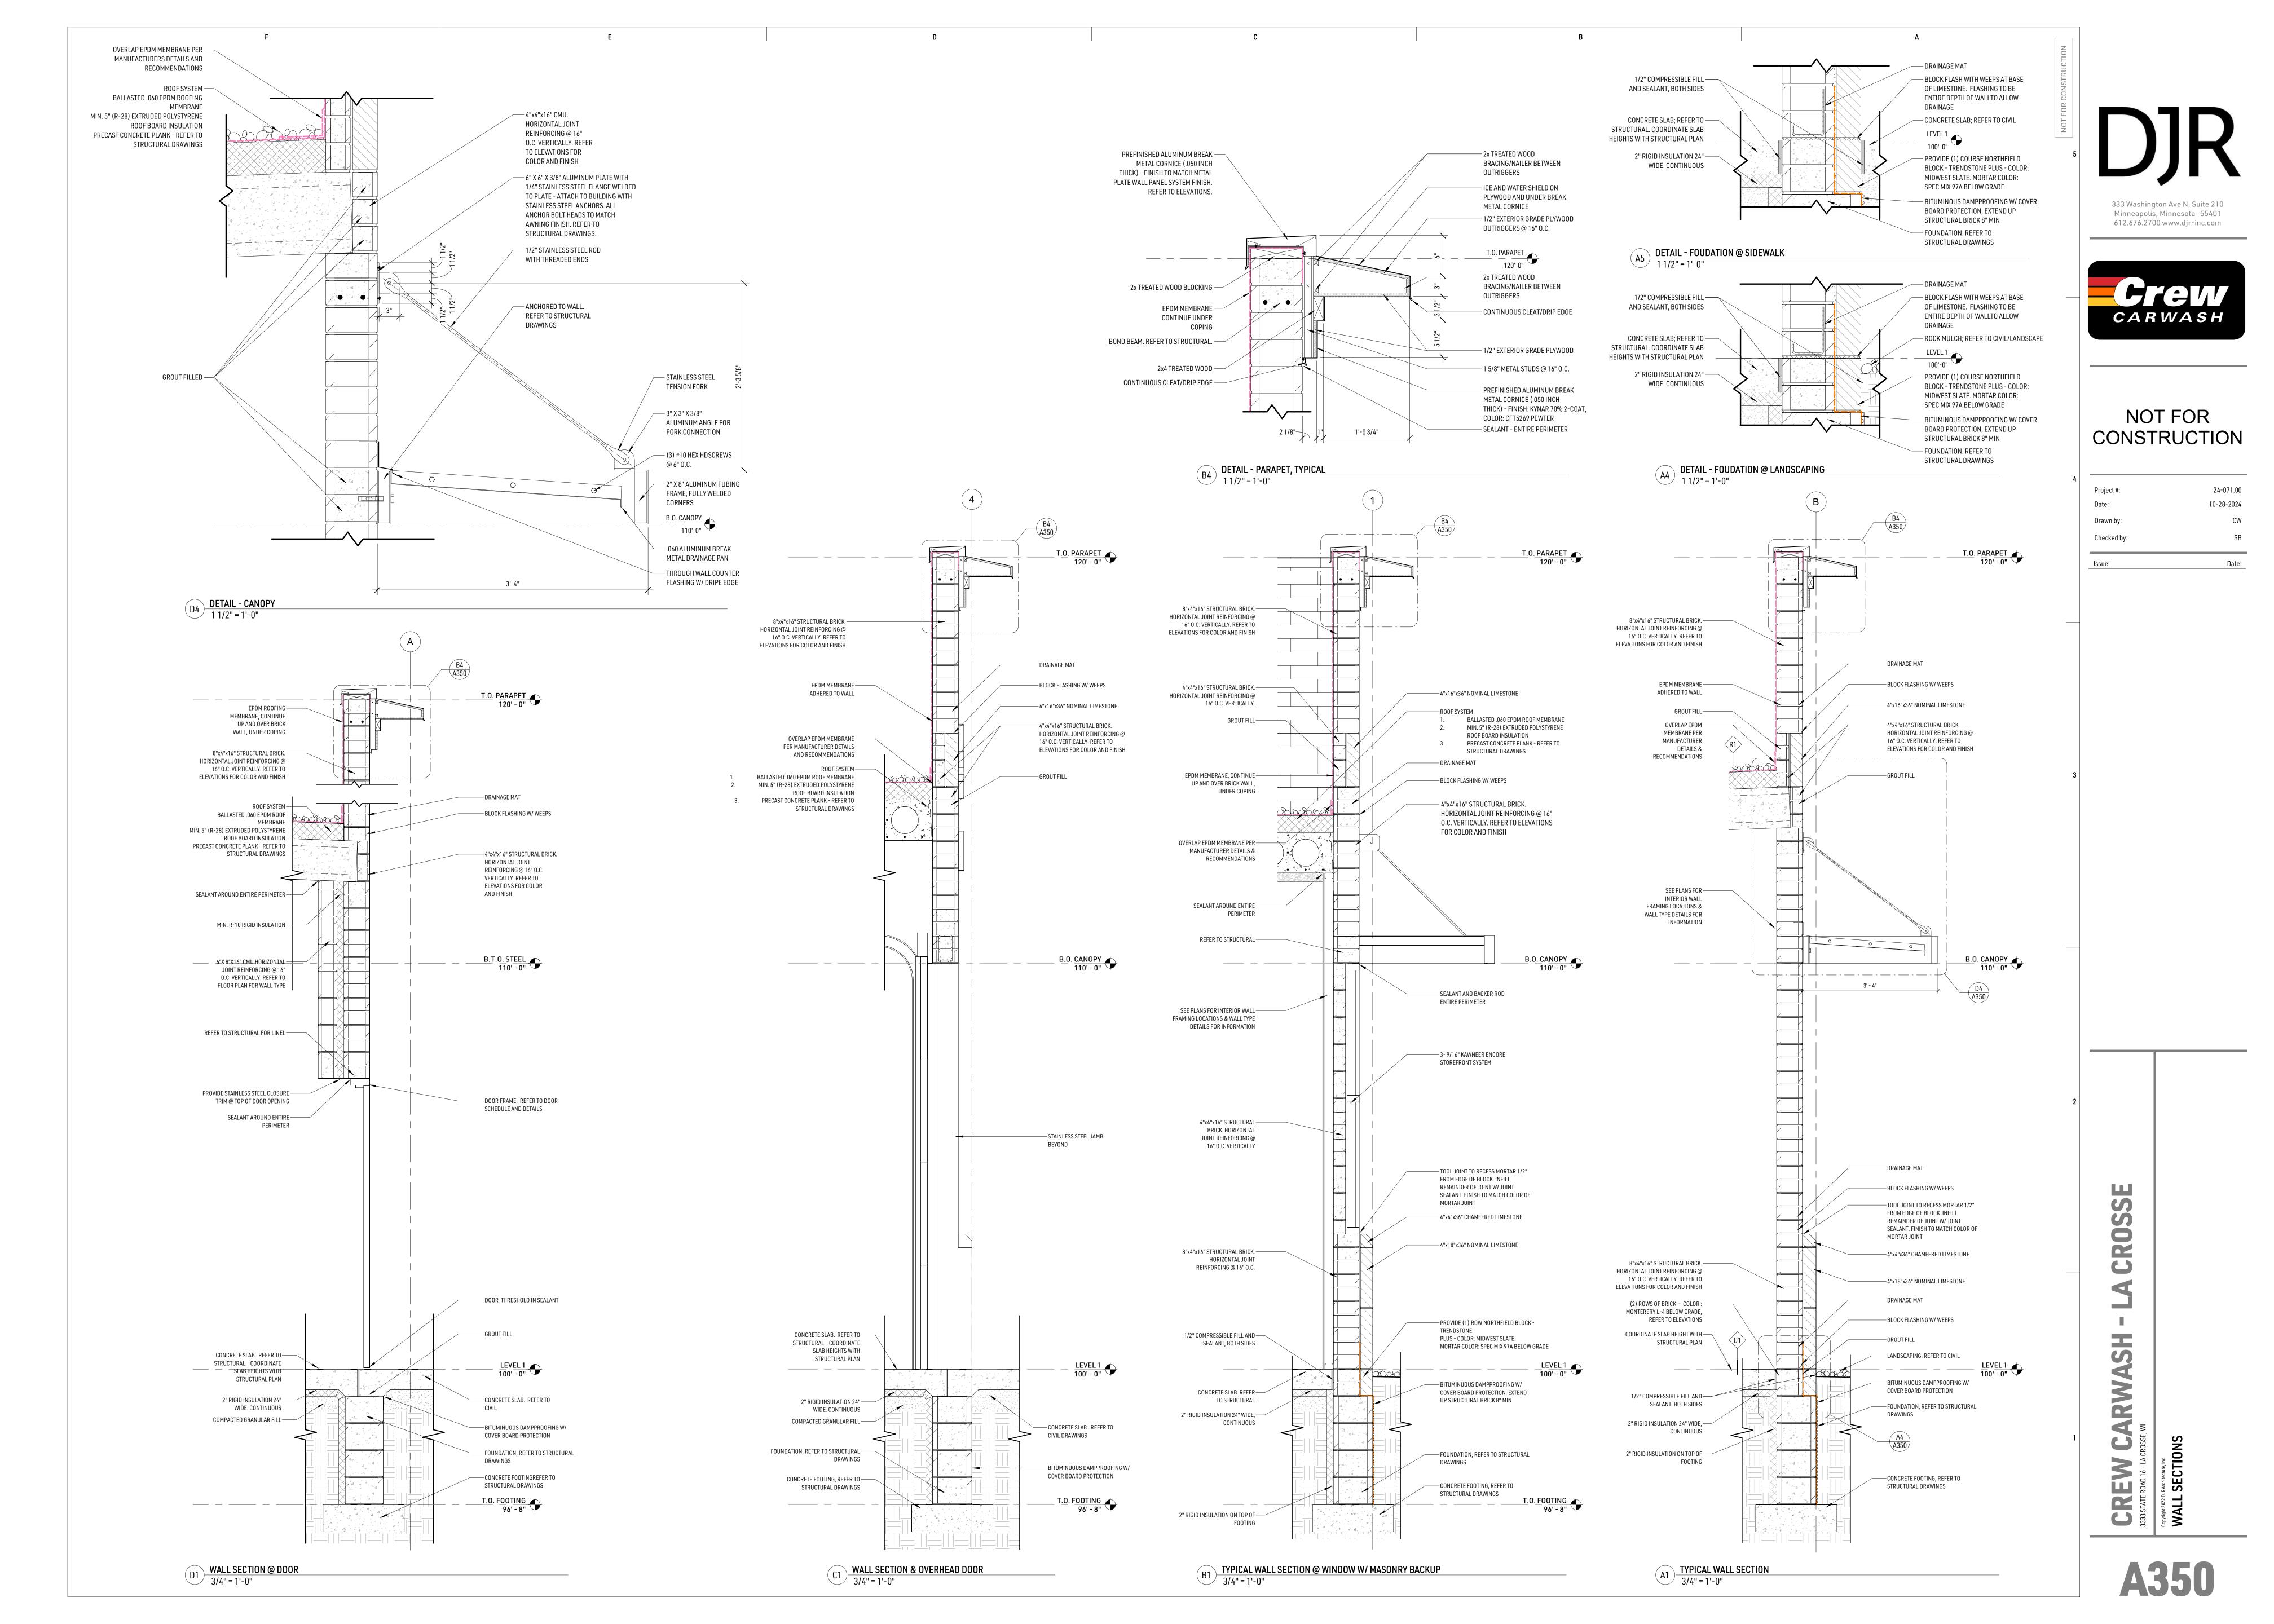

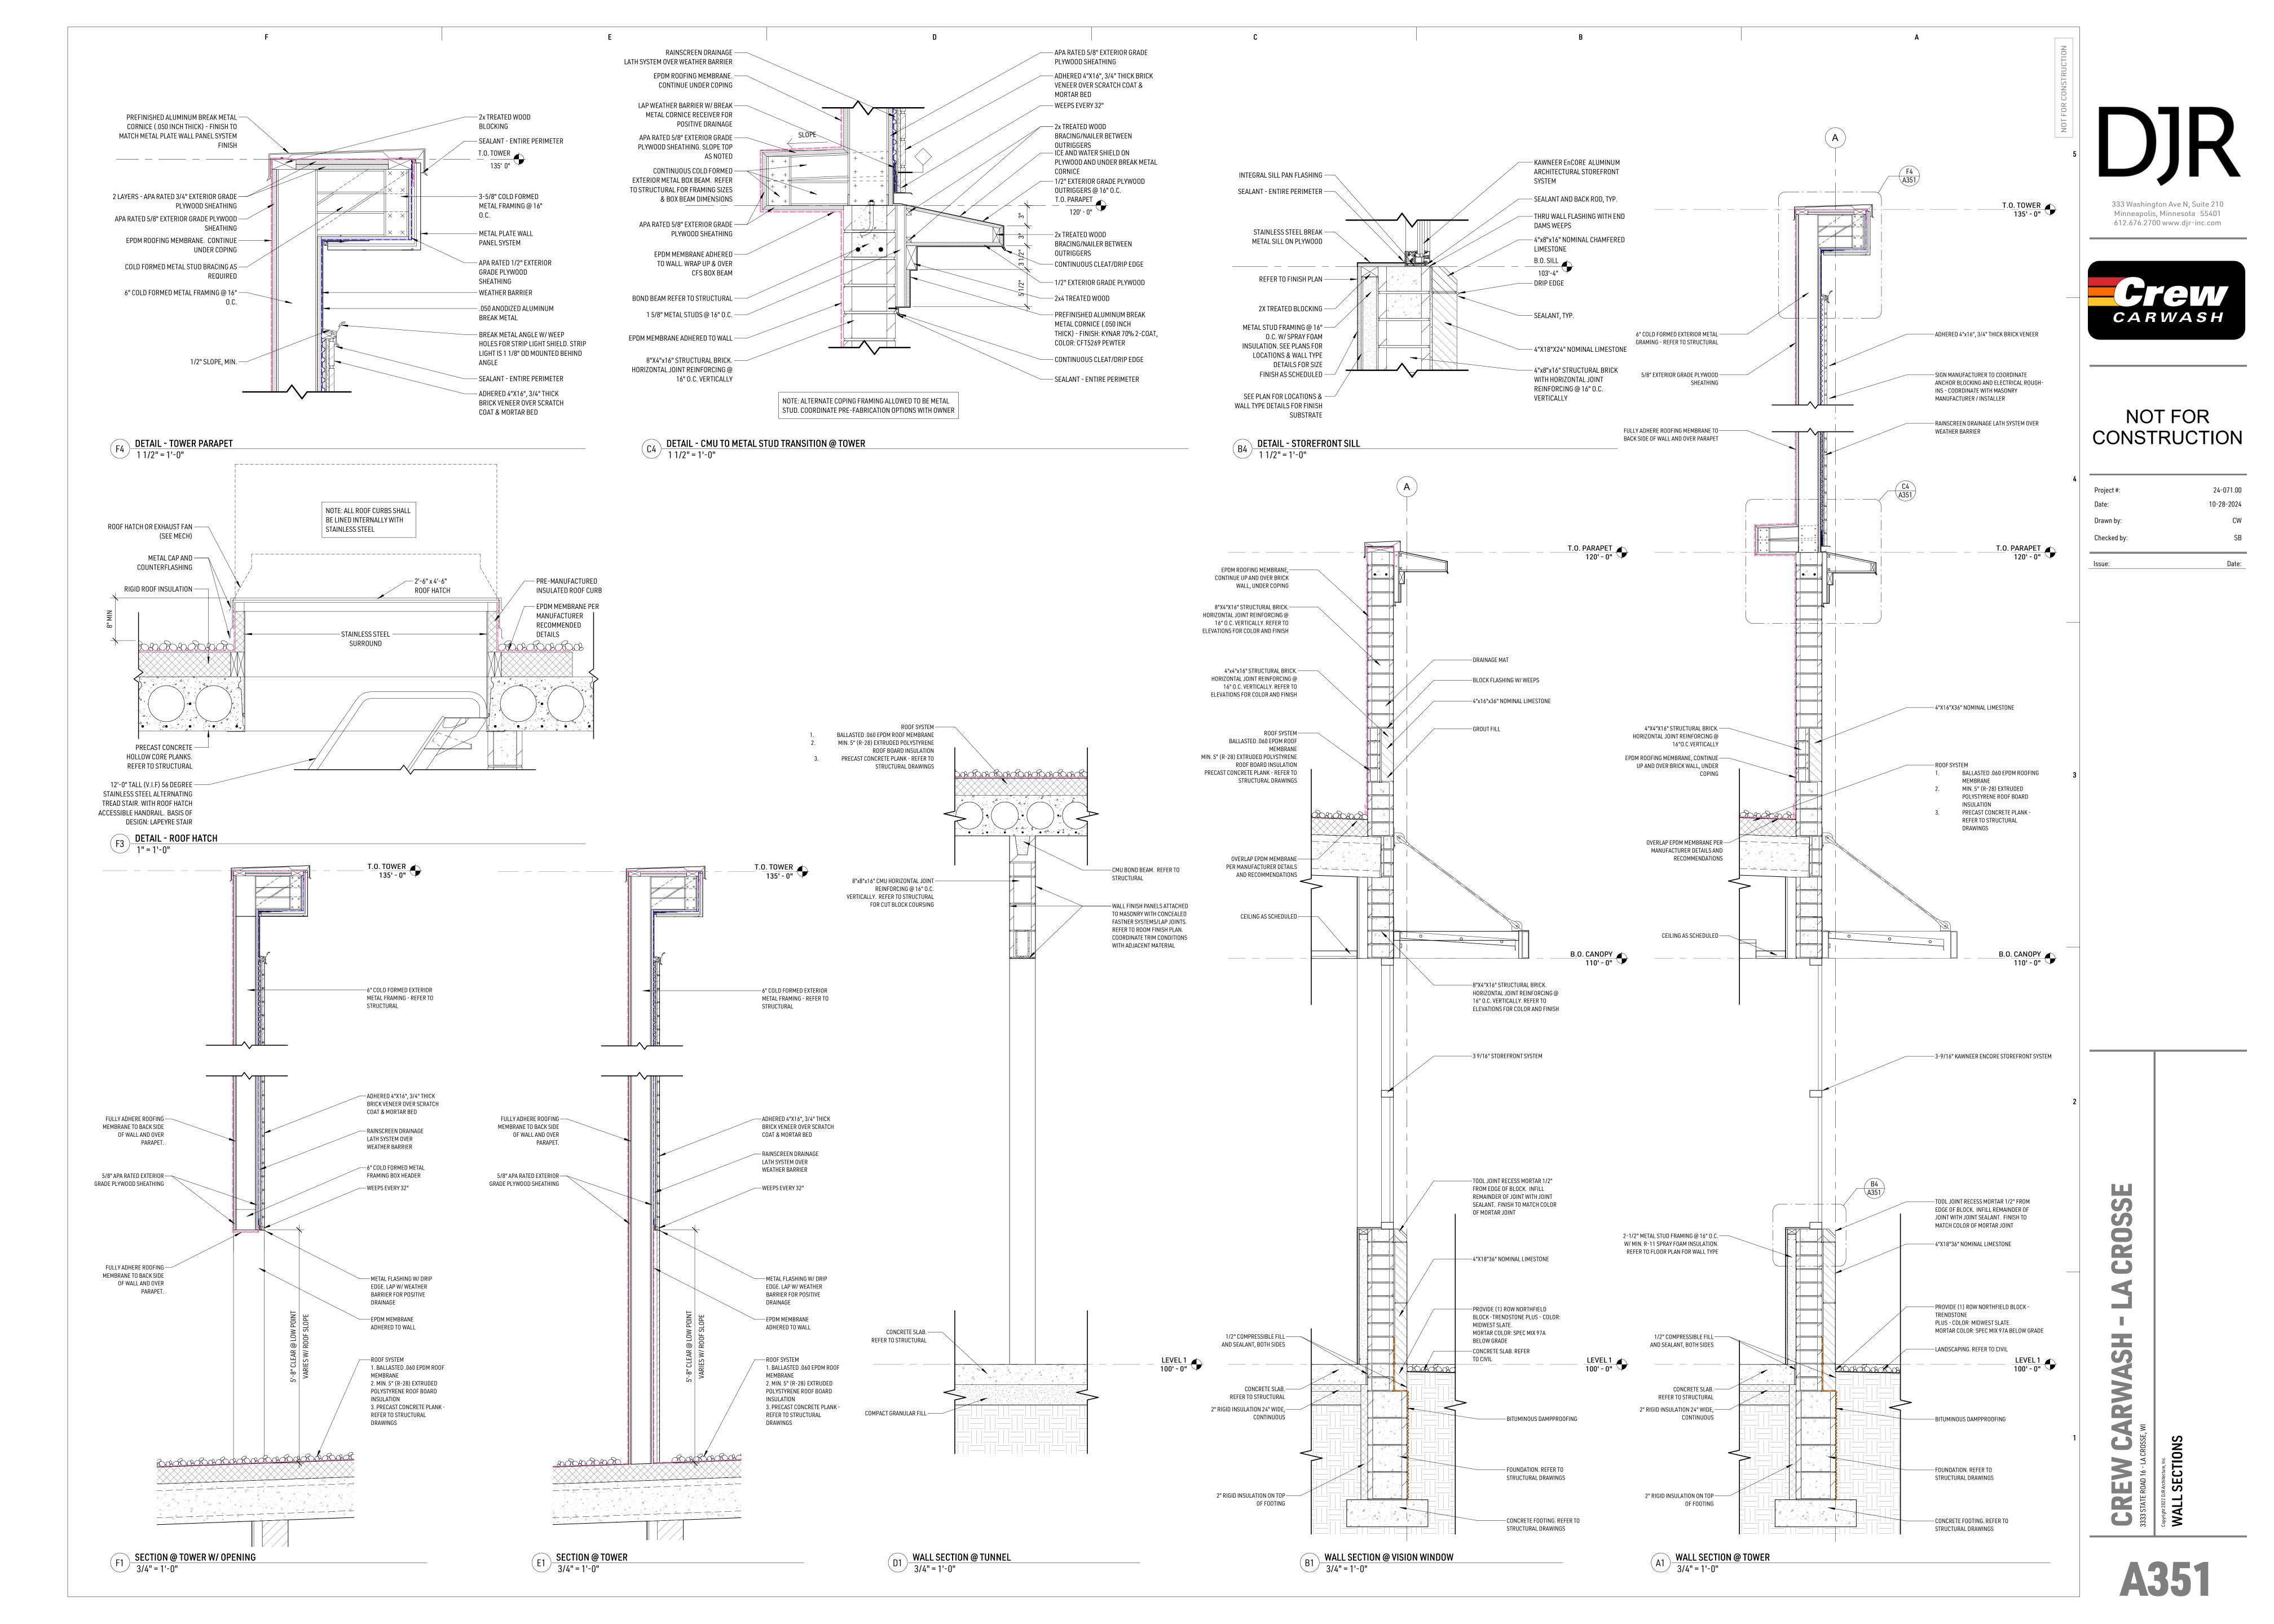







NOT FOR CONSTRUCTION

4		
	Project #:	24-071.00
	Date:	10-28-2024
	Drawn by:	CW
	Checked by:	SB
	laawa.	Data

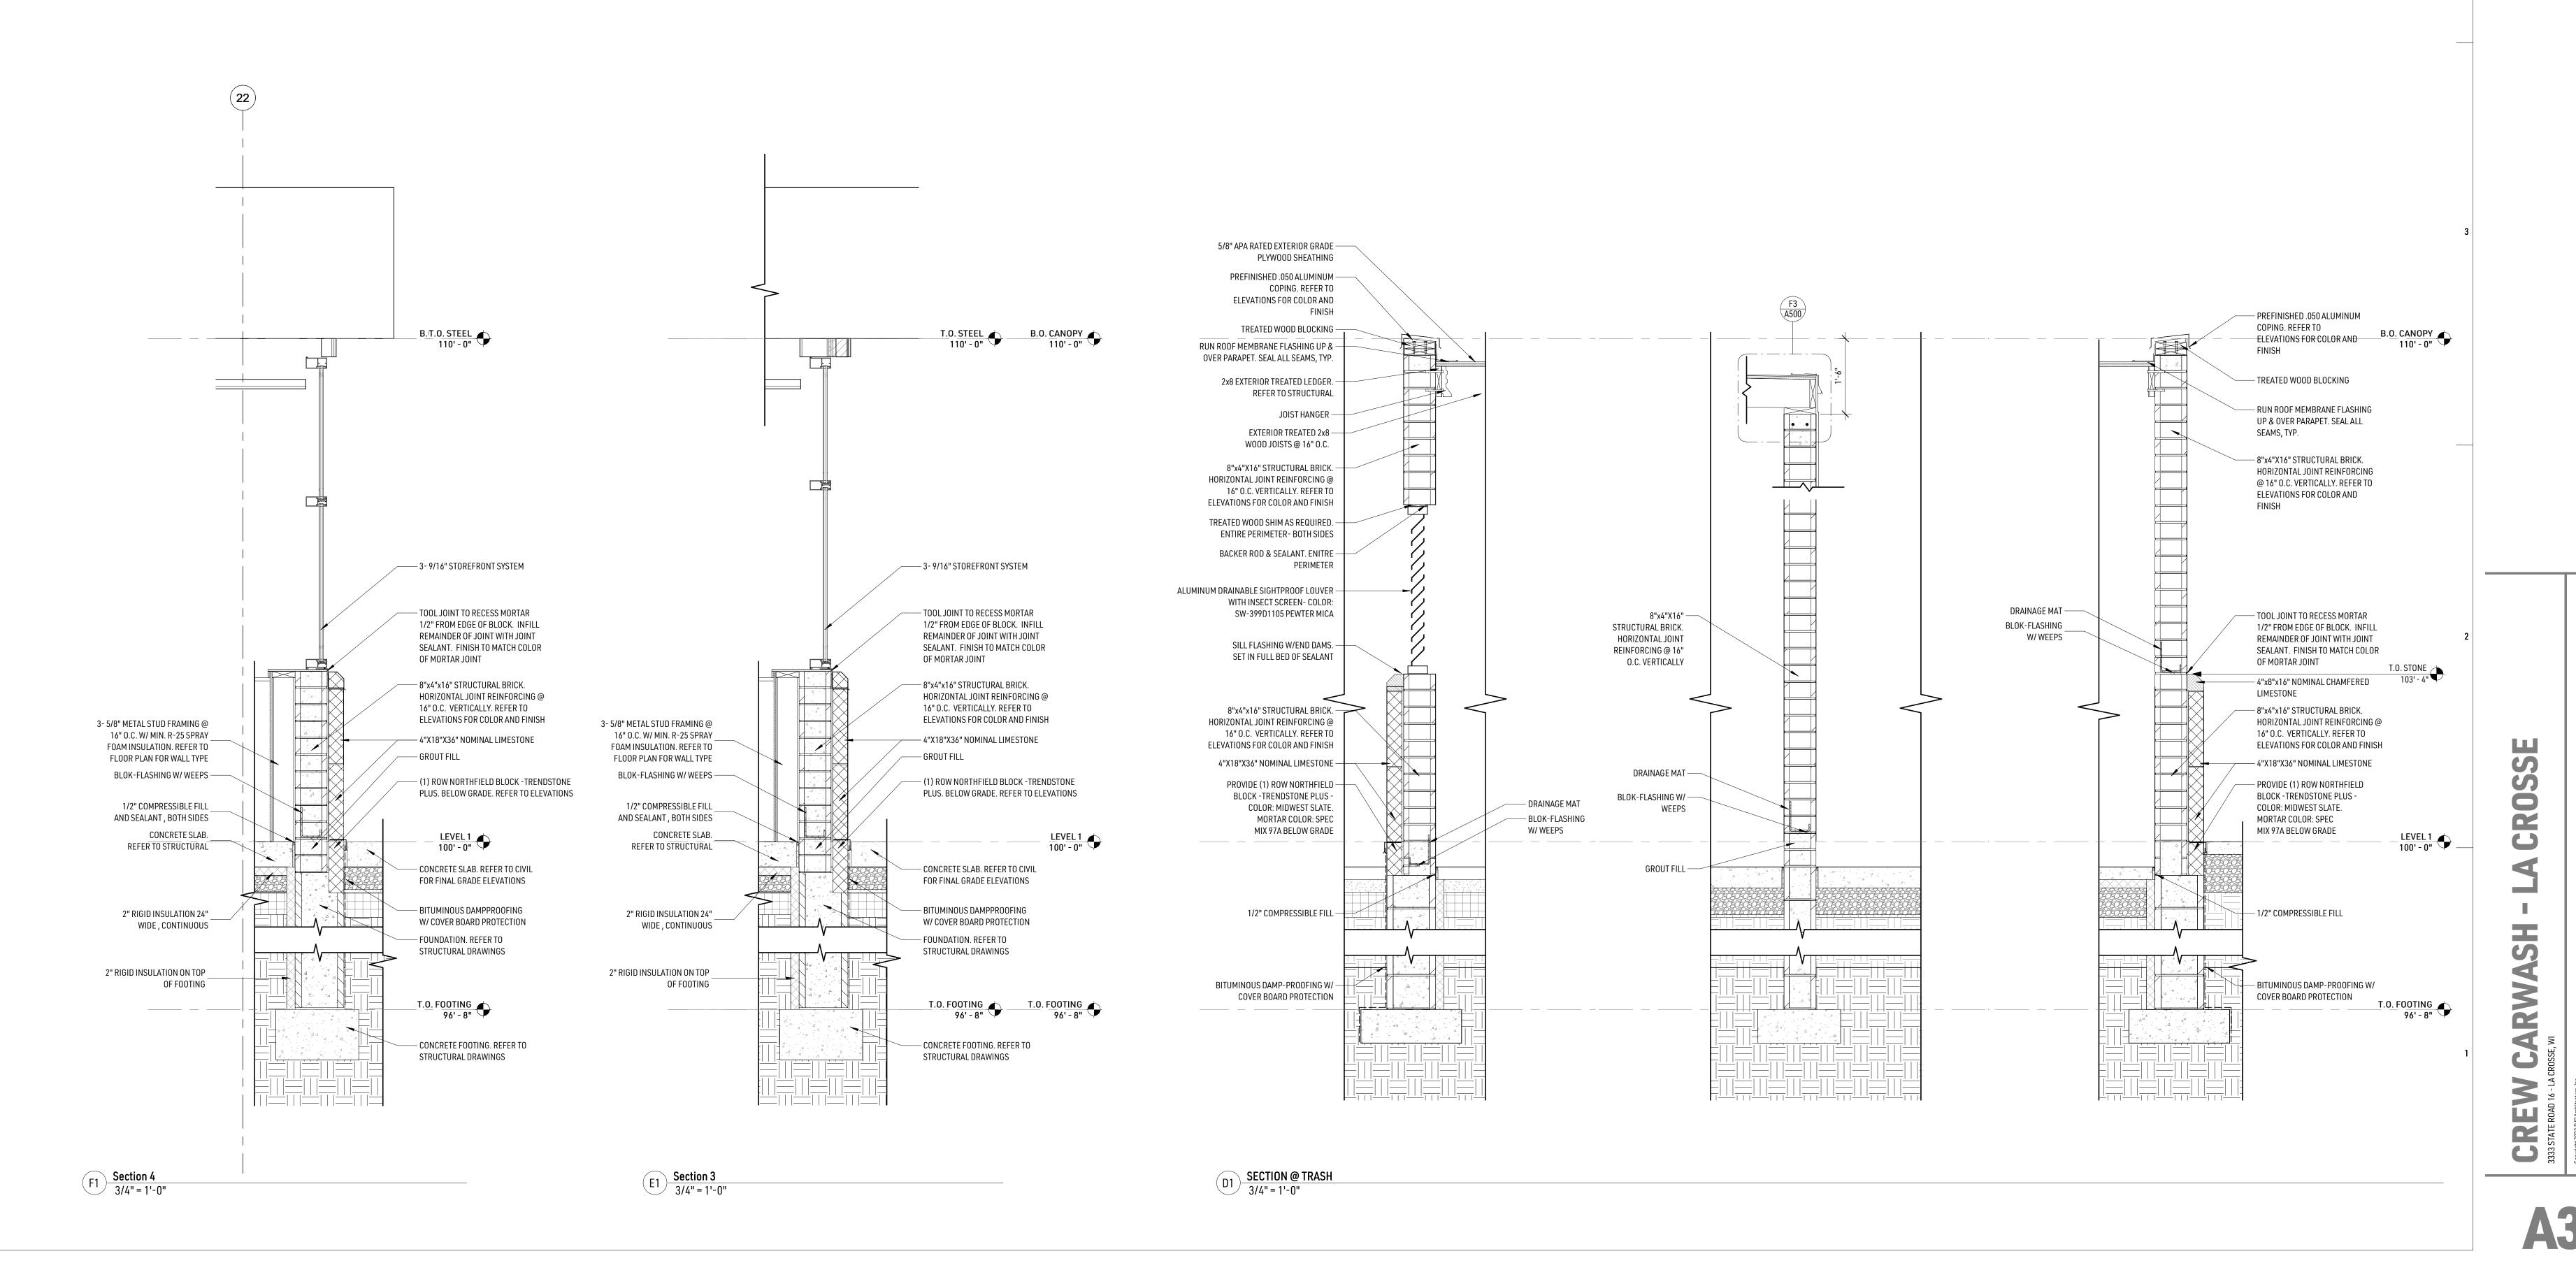

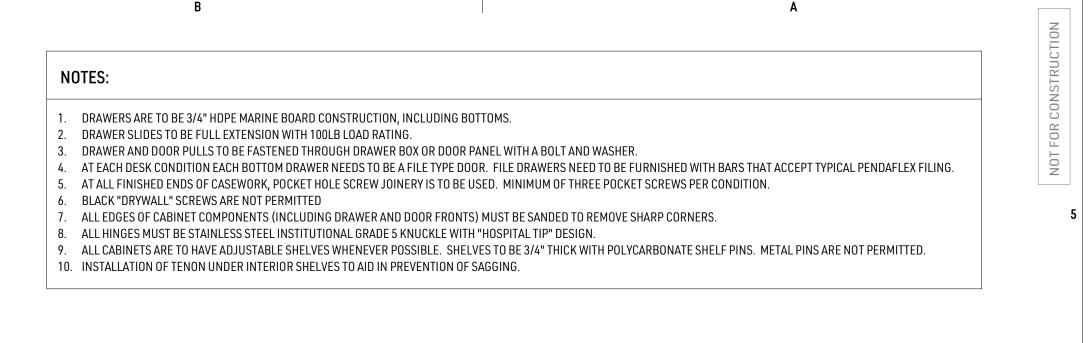





612.676.2700 www.djr-inc.com



NOT FOR CONSTRUCTION


Project #:	24-071.00
Date:	10-28-2024
Drawn by:	CW
Checked by:	SB

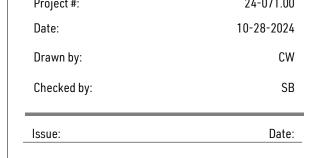


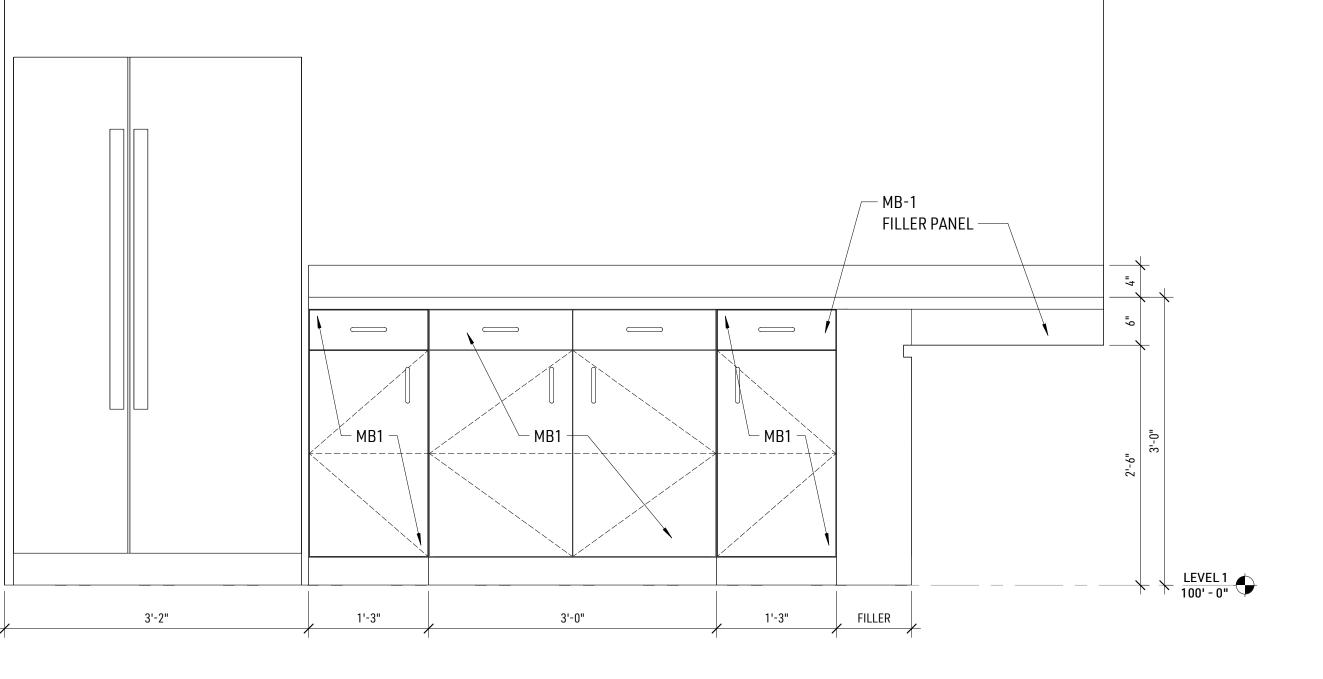



B3 TRAINING ROOM CASEWORK

1" = 1'-0"

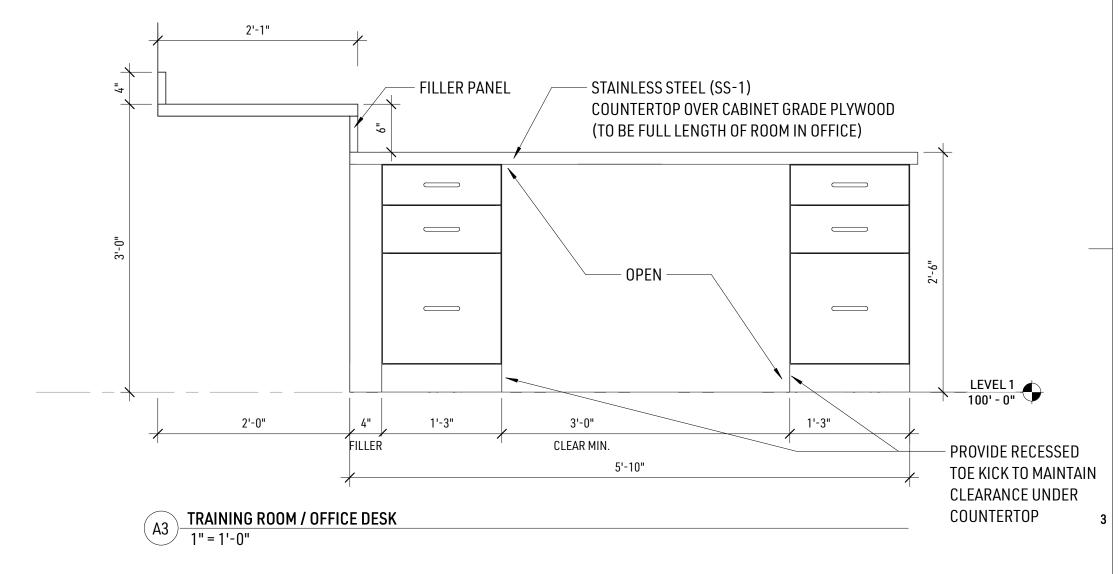

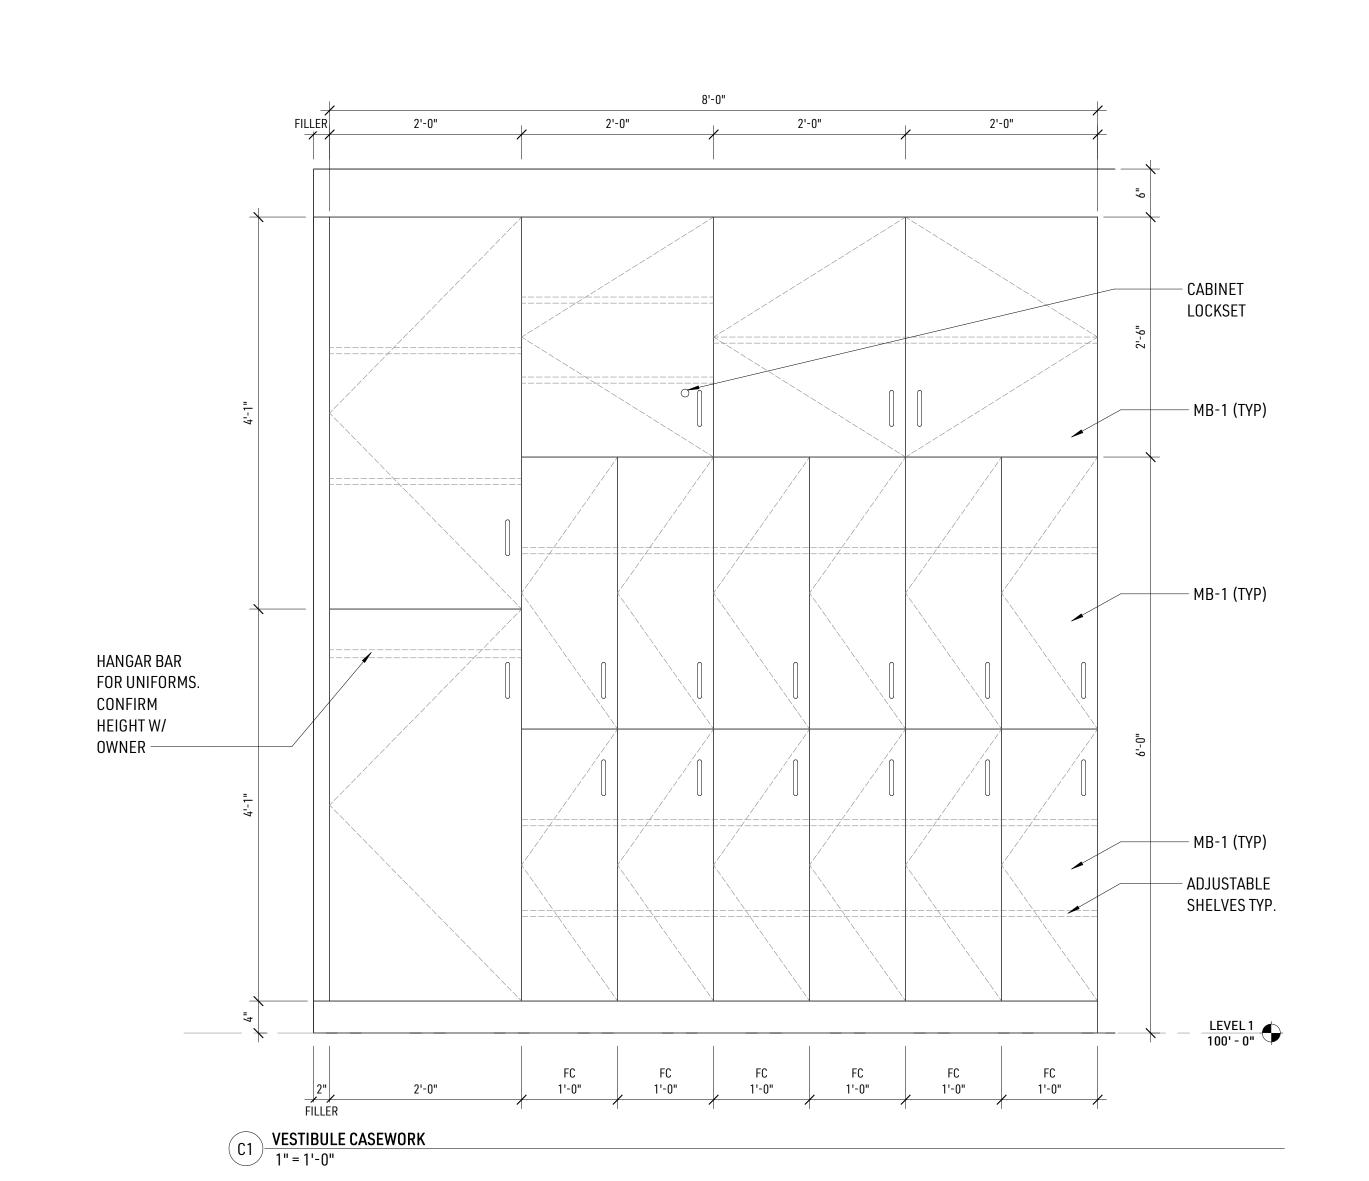

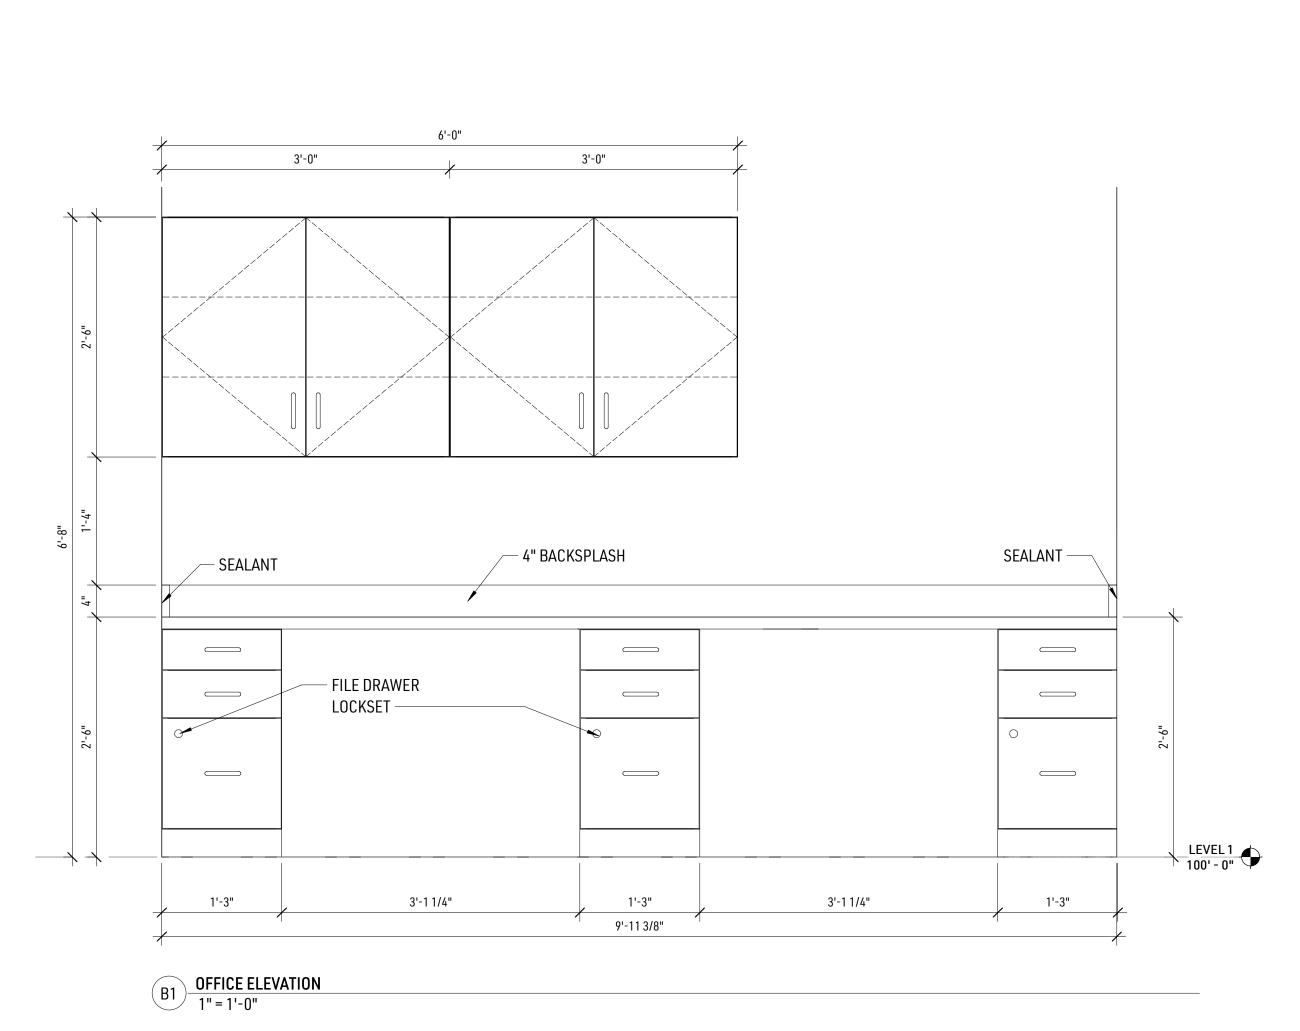


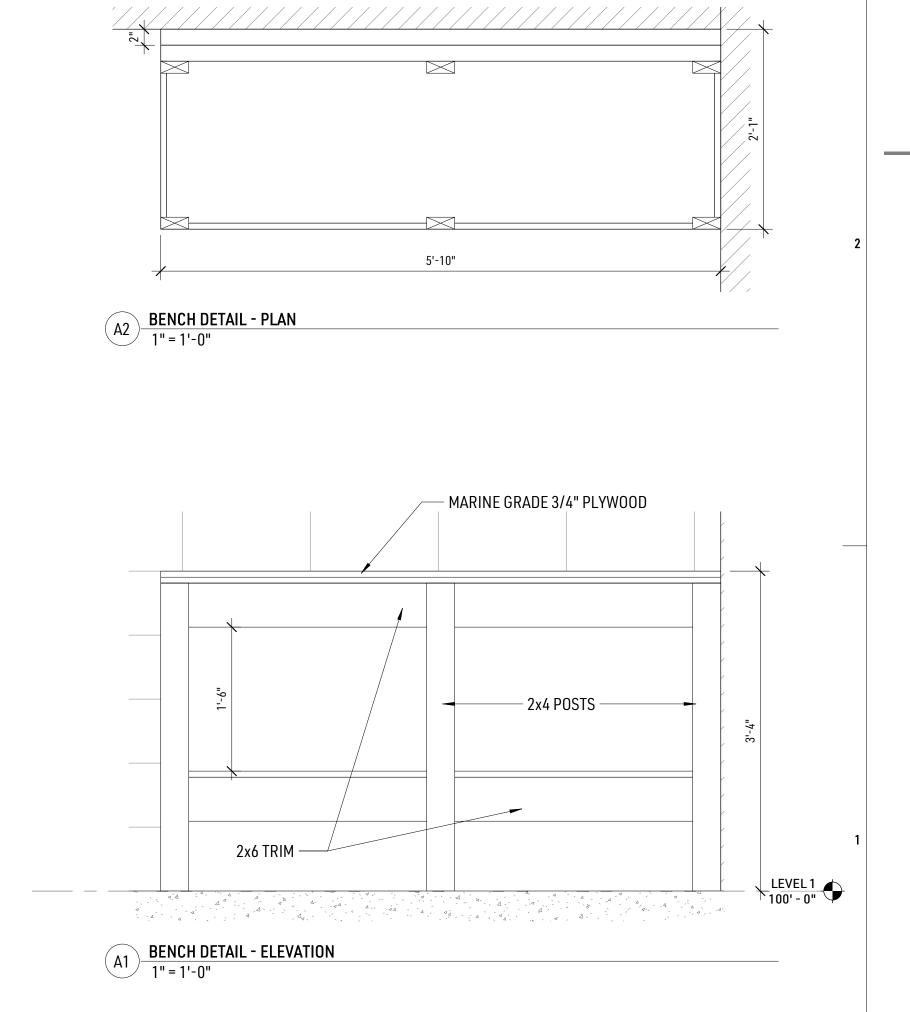


NOTES:


- DRAWERS ARE TO BE 3/4" HDPE MARINE BOARD CONSTRUCTION, INCLUDING BOTTOMS.
- DRAWER SLIDES TO BE FULL EXTENSION WITH 100LB LOAD RATING.
- DRAWER AND DOOR PULLS TO BE FASTENED THROUGH DRAWER BOX OR DOOR PANEL WITH A BOLT AND WASHER.
 AT EACH DESK CONDITION EACH BOTTOM DRAWER NEEDS TO BE A FILE TYPE DOOR. FILE DRAWERS NEED TO BE FURNISHED WITH BARS THAT ACCEPT TYPICAL PENDAFLEX FILING.
- 5. AT ALL FINISHED ENDS OF CASEWORK, POCKET HOLE SCREW JOINERY IS TO BE USED. MINIMUM OF THREE POCKET SCREWS PER CONDITION.
- 6. BLACK "DRYWALL" SCREWS ARE NOT PERMITTED
 7. ALL EDGES OF CABINET COMPONENTS (INCLUDING DRAWER AND DOOR FRONTS) MUST BE SANDED TO REMOVE SHARP CORNERS.
- 8. ALL HINGES MUST BE STAINLESS STEEL INSTITUTIONAL GRADE 5 KNUCKLE WITH "HOSPITAL TIP" DESIGN.
 9. ALL CABINETS ARE TO HAVE ADJUSTABLE SHELVES WHENEVER POSSIBLE. SHELVES TO BE 3/4" THICK WITH POLYCARBONATE SHELF PINS. METAL PINS ARE NOT PERMITTED.
- 9. ALL CABINETS ARE TO HAVE ADJUSTABLE SHELVES WHENEVER POSSIBLE. SHELVES TO BE 3/4"

 10. INSTALLATION OF TENON UNDER INTERIOR SHELVES TO AID IN PREVENTION OF SAGGING.

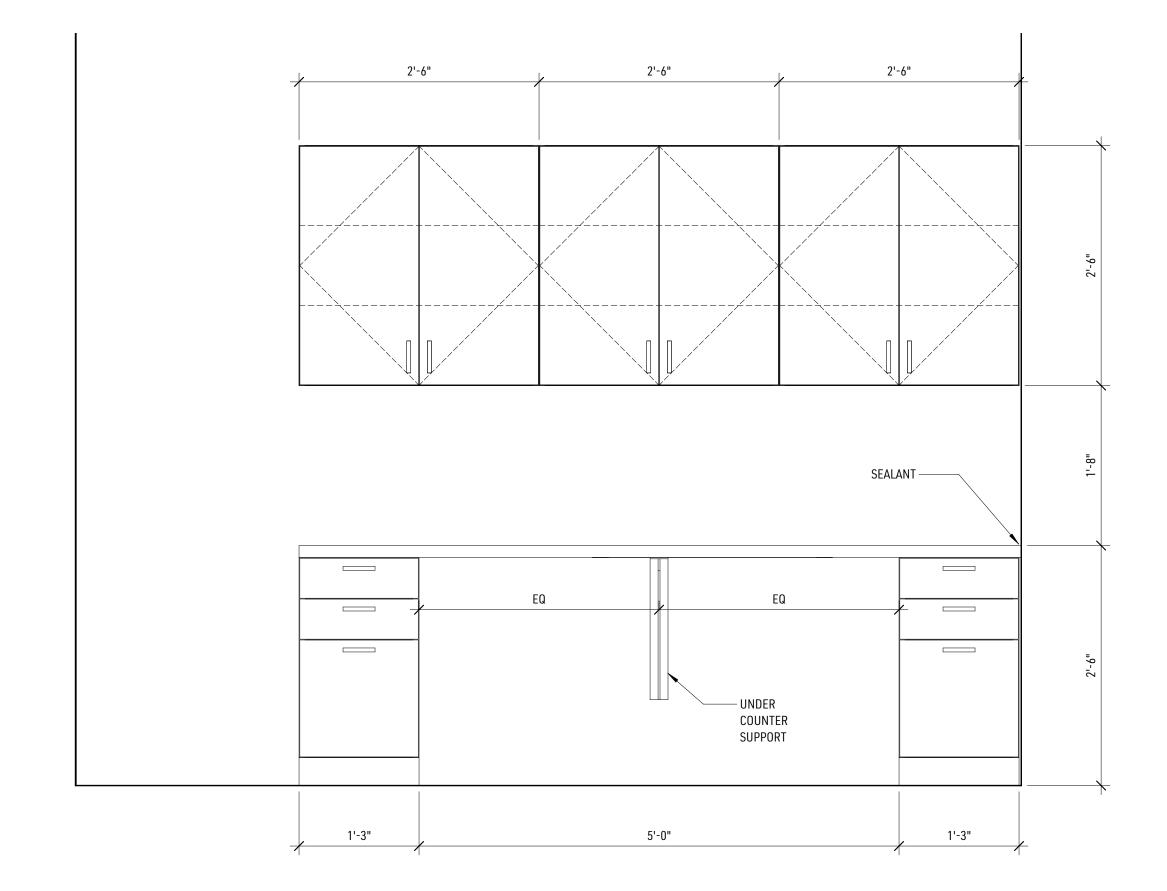

3 Elevation 2 - a
1" = 1'-0"

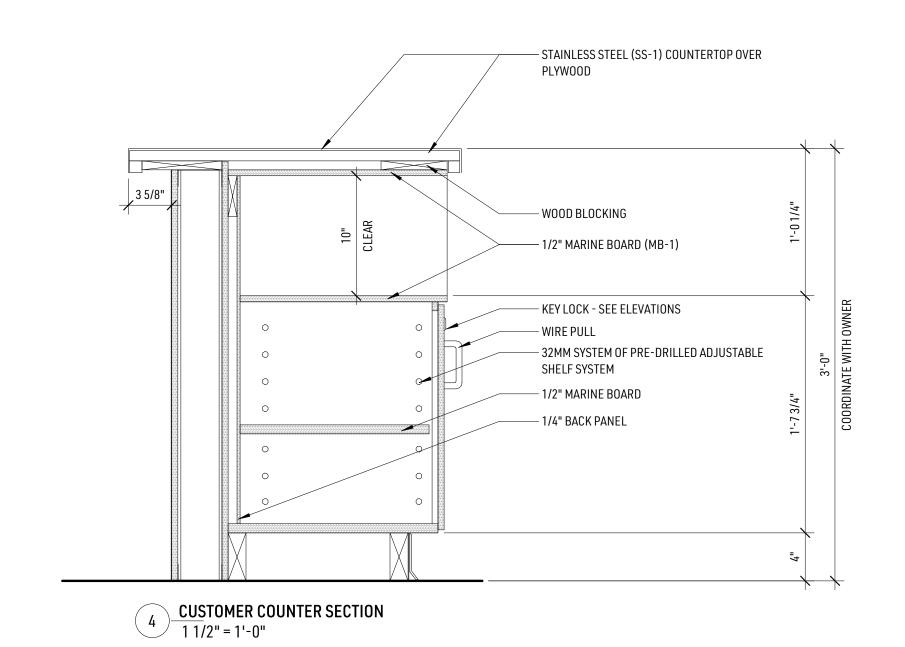

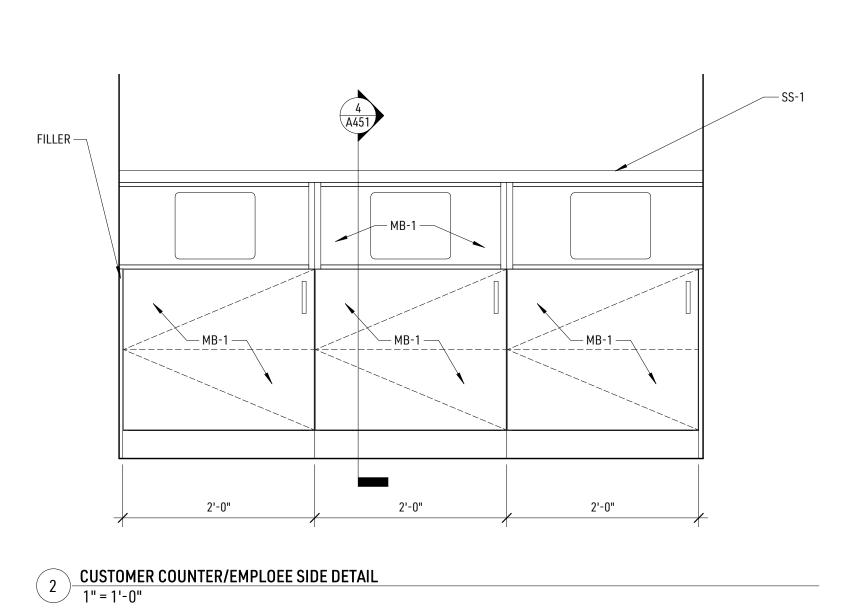

590 dall

1-1-10-10-97-08-20-0-1000

192-1

192-1

1 CASHIER/EMPLOYEE SIDE DETAIL
1" = 1'-0"






NOT FOR CONSTRUCTION

Project #:	24-071.00
Date:	11/08/24
Drawn by:	CN
Checked by:	CW,SB

CREW CARWASH - L
3333 STATE ROAD 16 - LA CROSSE, WI
Copyright 2022 DJRArchitecture, Inc.

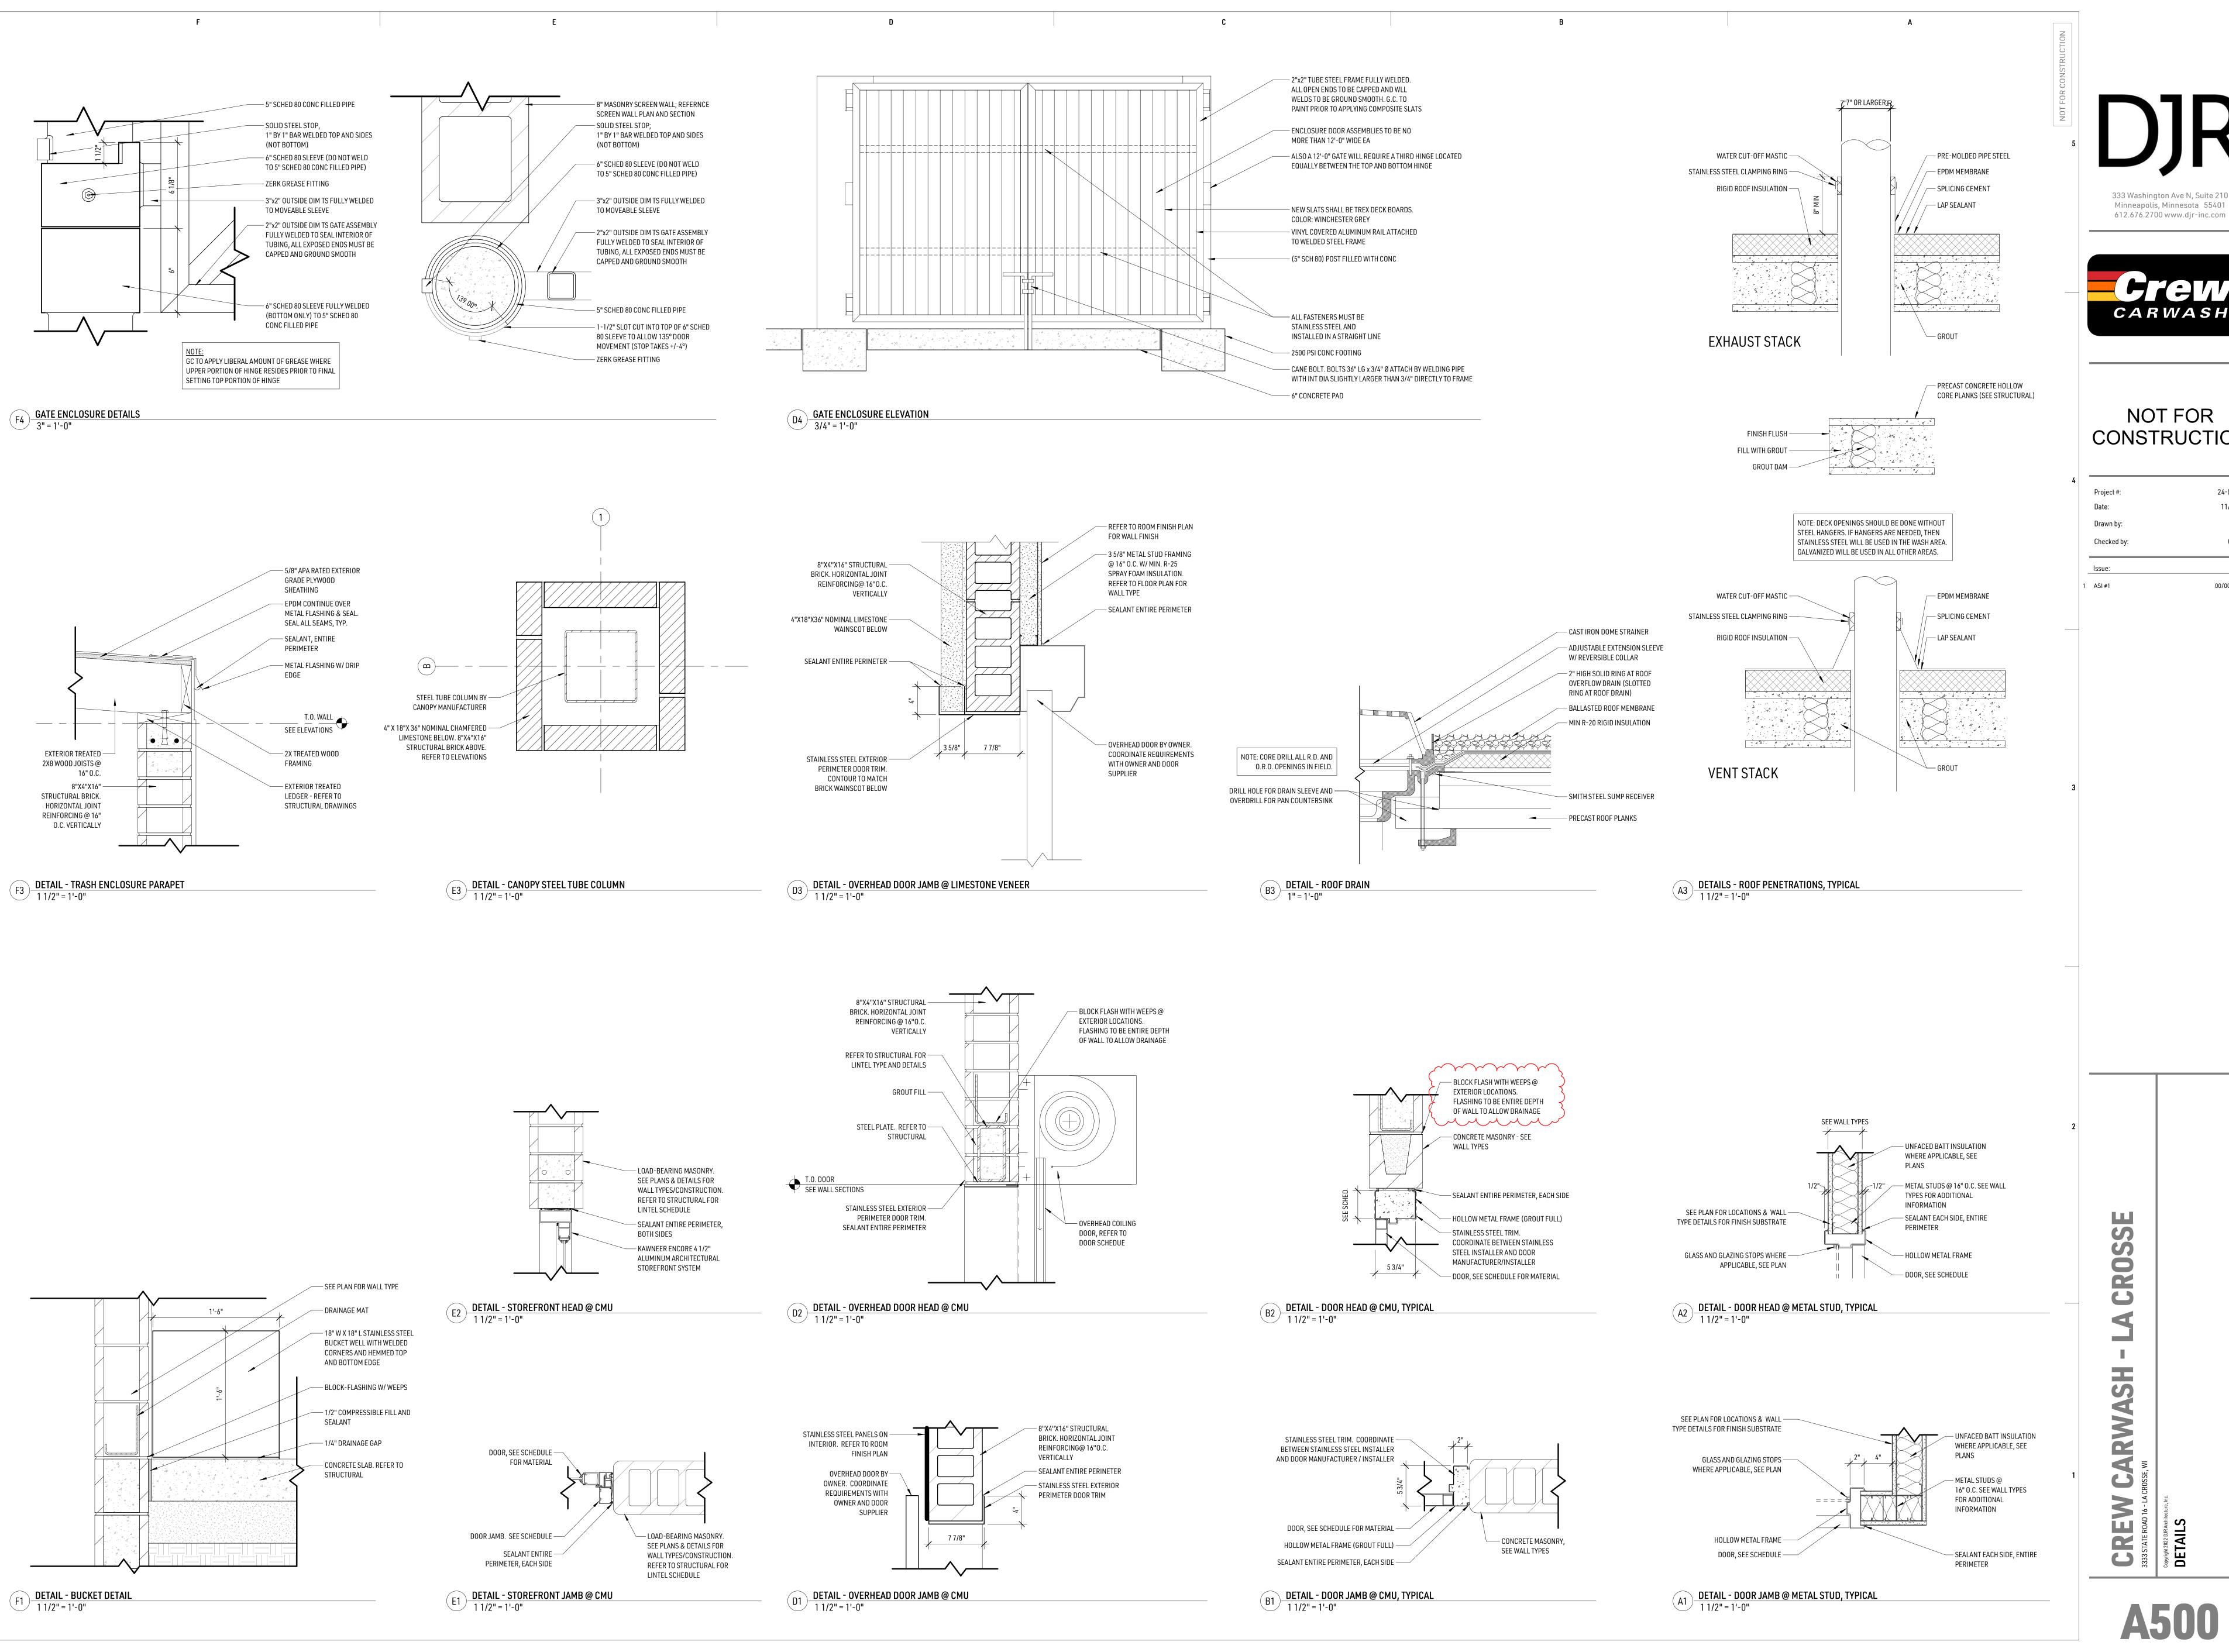

333 Washington Ave N, Suite 210 Minneapolis, Minnesota 55401



NOT FOR

4			
		Project #:	24-071.00
		Date:	11/15/24
		Drawn by:	WP
		Checked by:	CW,SB
		Issue:	Date:
	1	ASI #1	00/00/2016

SE S 4 4 RW 4






612.676.2700 www.djr-inc.com

NOT FOR CONSTRUCTION


4		
	Project #:	24-071.00
	Date:	10-28-2024
	Drawn by:	CW
	Checked by:	SB

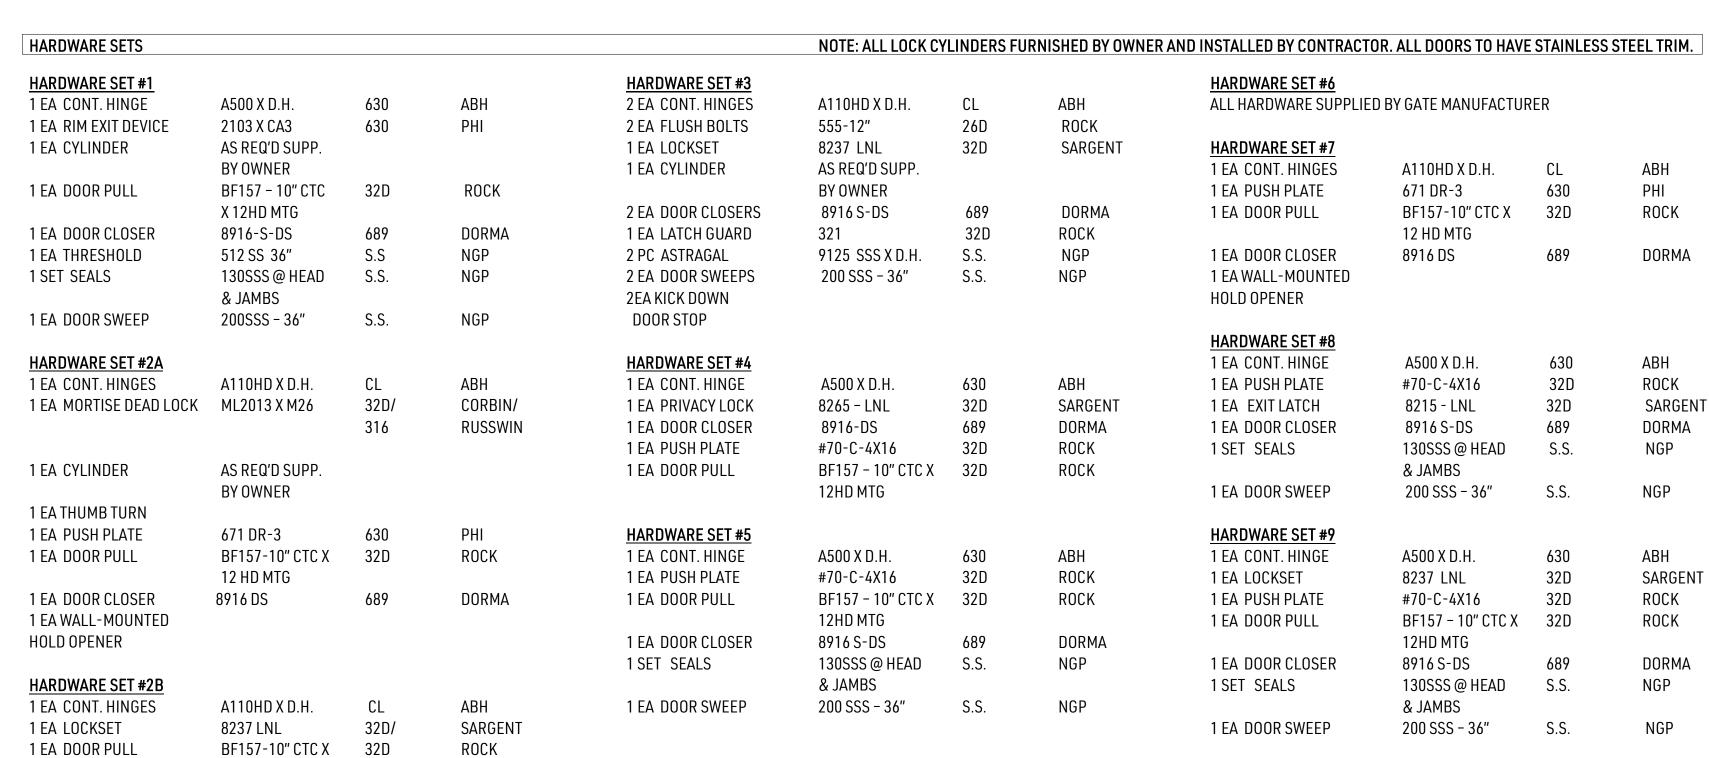

12 HD MTG

NOTE: DOOR HARDWARE NEEDS TO BE MADE TO FIT LARGE FORMAT MEDECO SYSTEM CYLINDERS AND CORES

						DOORS	SCHEDULE - CO	IMMON AREA						
				DO	ORS			FRAMES		HARDWARE	HARDWARE	FIRE		
#	ROOM	WIDTH	HEIGHT	PANEL TYPE	PANEL FINISH	ID - CODE	FRAME TYPE	FRAME FINISH	ID - CODE	GROUP	FINISH	RATING	COMMENTS	
100A	HALLWAY	3' - 0"	7' - 0"	С	STAINLESS STEEL		3	STAINLESS STEEL		1				
100B	HALLWAY	3' - 0"	7' - 2"	С	STAINLESS STEEL		4	STAINLESS STEEL		5				
100C	HALLWAY	3' - 0"	7' - 0"	В	CLEAR ANODIZED ALUMINUM		3	CLEAR ANODIZED ALUMINUM		1				
101A	TRAINING	3' - 0"	7' - 0"	E	ALUMINUM - CMI BOLDLINE		3	ALUMINUM - CMI FRAME		7				
102	TOILET	3' - 0"	7' - 0"	Α	ALUMINUM - CMI BOLDLINE		3	ALUMINUM - CMI FRAME		4				
103A	MECHANICAL ROOM	3' - 0"	7' - 0"	Α	STAINLESS STEEL		3	STAINLESS STEEL		8		45		
103B	MECHANICAL ROOM	3' - 0"	7' - 0"	Α	STAINLESS STEEL		3	STAINLESS STEEL		8		45		
103C	MECHANICAL ROOM	6' - 0"	7' - 0"	D	ALUMINUM - CMI BOLDLINE		3	ALUMINUM - CMI FRAME		3				
103D	BLOWER ROOM	3' - 0"	7' - 0"	Α	STAINLESS STEEL		3	STAINLESS STEEL		8		45		
104A	UTILITY ROOM	3' - 0"	7' - 0"	Α	ALUMINUM - CMI BOLDLINE		3	ALUMINUM - CMI FRAME		9		45		
105B	BLOWER ROOM	10' - 0"	10' - 0"	F	CLEAR ANODIZED ALUMINUM		MANF	CLEAR ANODIZED ALUMINUM		-				
105C	BLOWER ROOM	3' - 0"	7' - 0"	С	STAINLESS STEEL		3	STAINLESS STEEL		1				
						·	_			_	·			

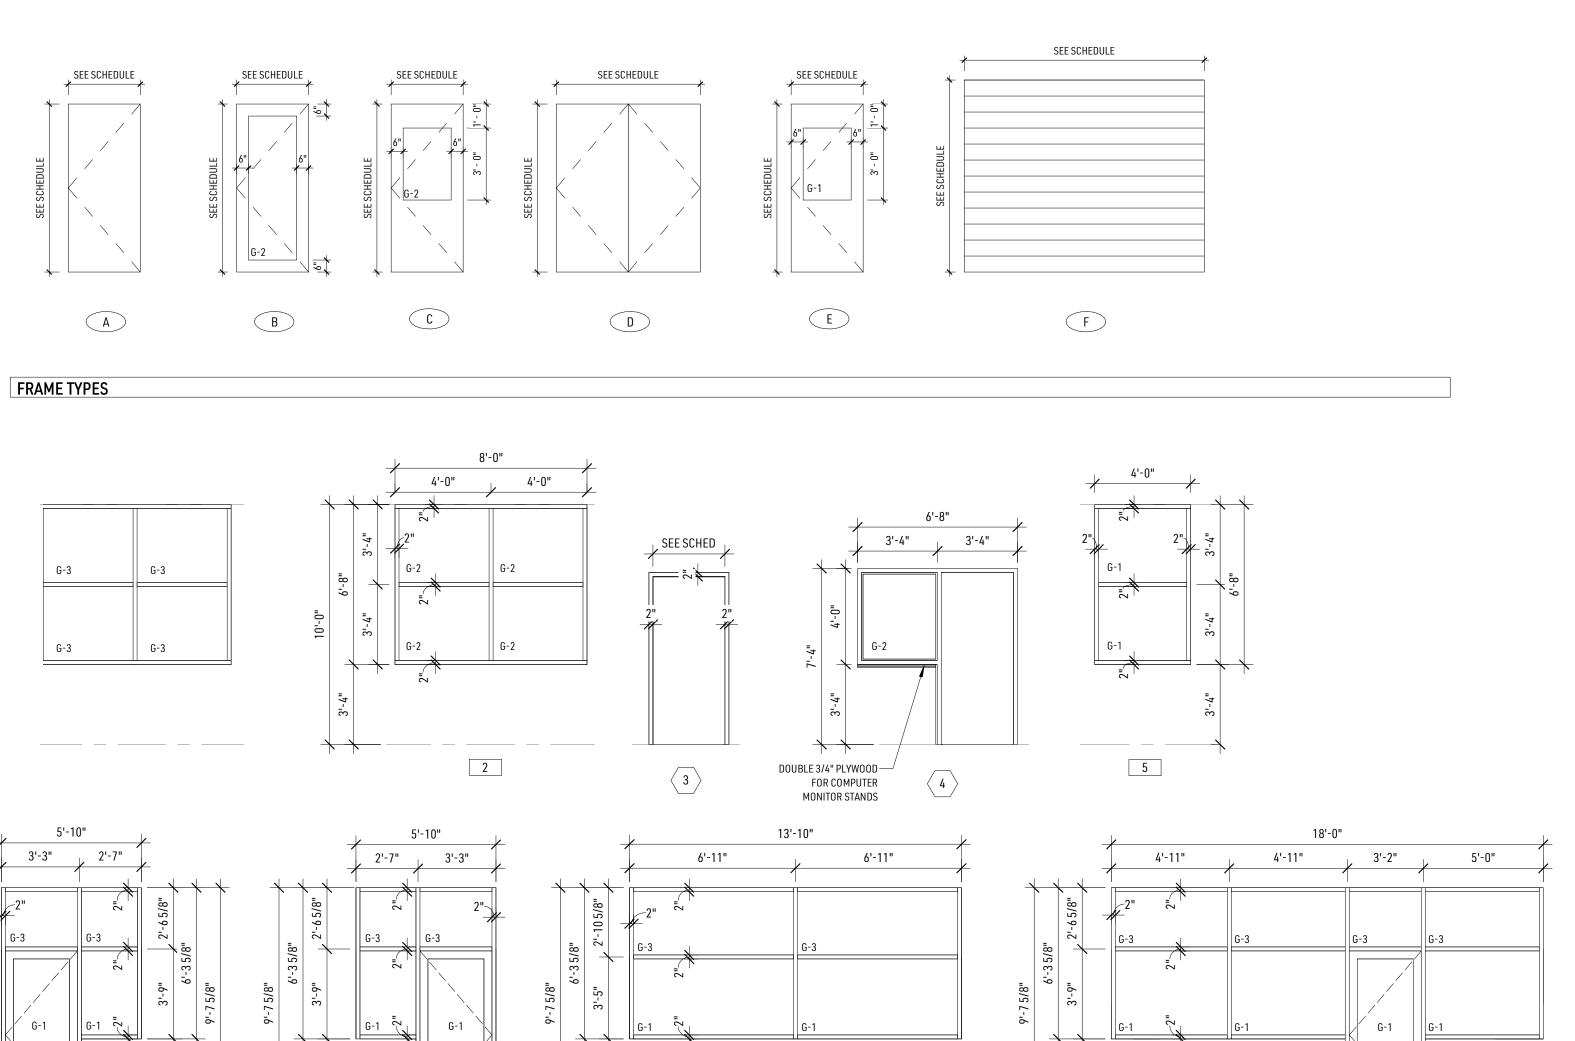


8

DOOR TYPES

NOTE: DOOR FIRE GLAZING RATING TO MEET REQUIREMENTS OF TABLE 716.1(2)

GLAZING TYPES	DOOR SCHEDULE - COMMON AREA												
G-1: 1" - SEALED INSULATING GLASS UNITS, MIRRORED				DO	ORS			FRAMES		HARDWARE	HARDWARE	FIRE	
SAFETY GLAZING G-2: 1" - SEALED INSULATING GLASS UNITS, SAFETY	# ROOM	WIDTH	HEIGHT	PANEL TYPE	PANEL FINISH	ID - CODE FF	RAME TYPE	FRAME FINISH	ID - CODE	GROUP	FINISH	RATING	COMMENTS
GLAZING (DOORS)	100A HALLWAY	3' - 0"	7' - 0"	С	STAINLESS STEEL	3		STAINLESS STEEL		1			
G-3: 1" SEALED INSULATING GLASS UNITS, SPANDREL	100B HALLWAY	3' - 0"	7' - 2"	С	STAINLESS STEEL	4		STAINLESS STEEL		5			
GLAZING	100C HALLWAY	3' - 0"	7' - 0"	В	CLEAR ANODIZED ALUMINUM	3		CLEAR ANODIZED ALUMINUM		1			
	101A TRAINING	3' - 0"	7' - 0"	Е	ALUMINUM - CMI BOLDLINE	3		ALUMINUM - CMI FRAME		7			
	102 TOILET	3' - 0"	7' - 0"	Α	ALUMINUM - CMI BOLDLINE	3		ALUMINUM - CMI FRAME		4			
	103A MECHANICAL ROOM	3' - 0"	7' - 0"	Α	STAINLESS STEEL	3		STAINLESS STEEL		8		45	
OTE : DOOR FIRE GLAZING AND SIDELIGHT /	103B MECHANICAL ROOM	3' - 0"	7' - 0"	Α	STAINLESS STEEL	3		STAINLESS STEEL		8		45	
RANSOM FIRE GLAZING RATING TO MEET	103C MECHANICAL ROOM	6' - 0"	7' - 0"	D	ALUMINUM - CMI BOLDLINE	3		ALUMINUM - CMI FRAME		3			
EQUIREMENTS OF TABLE 716.1(2)	103D BLOWER ROOM	3' - 0"	7' - 0"	Α	STAINLESS STEEL	3		STAINLESS STEEL		8		45	
	104A UTILITY ROOM	3' - 0"	7' - 0"	Α	ALUMINUM - CMI BOLDLINE	3		ALUMINUM - CMI FRAME		9		45	
	105B BLOWER ROOM	10' - 0"	10' - 0"	F	CLEAR ANODIZED ALUMINUM	IAM	NF	CLEAR ANODIZED ALUMINUM		-			
	105C BLOWER ROOM	3' - 0"	7' - 0"	С	STAINLESS STEEL	3		STAINLESS STEEL		1			
	106A ENTRY AREA	3' - 0"	7' - 0"	Α	ALUMINUM - CMI BOLDLINE	3		ALUMINUM - CMI FRAME		1			
	108A STORAGE	3' - 0"	7' - 0"	Α	ALUMINUM - CMI BOLDLINE	3		ALUMINUM - CMI FRAME		2B			
	110A OFFICE	3' - 0"	7' - 0"	E	ALUMINUM - CMI BOLDLINE	3		ALUMINUM - CMI FRAME		2A			
	111A ENTRY AREA	14' - 0"	10' - 0"	F	CLEAR ANODIZED ALUMINUM	IAM	NF	CLEAR ANODIZED ALUMINUM		-			
	112A EXTERIOR STORAGE	6' - 0"	7' - 0"	D	ALUMINUM - CMI BOLDLINE	3		ALUMINUM - CMI FRAME		3			

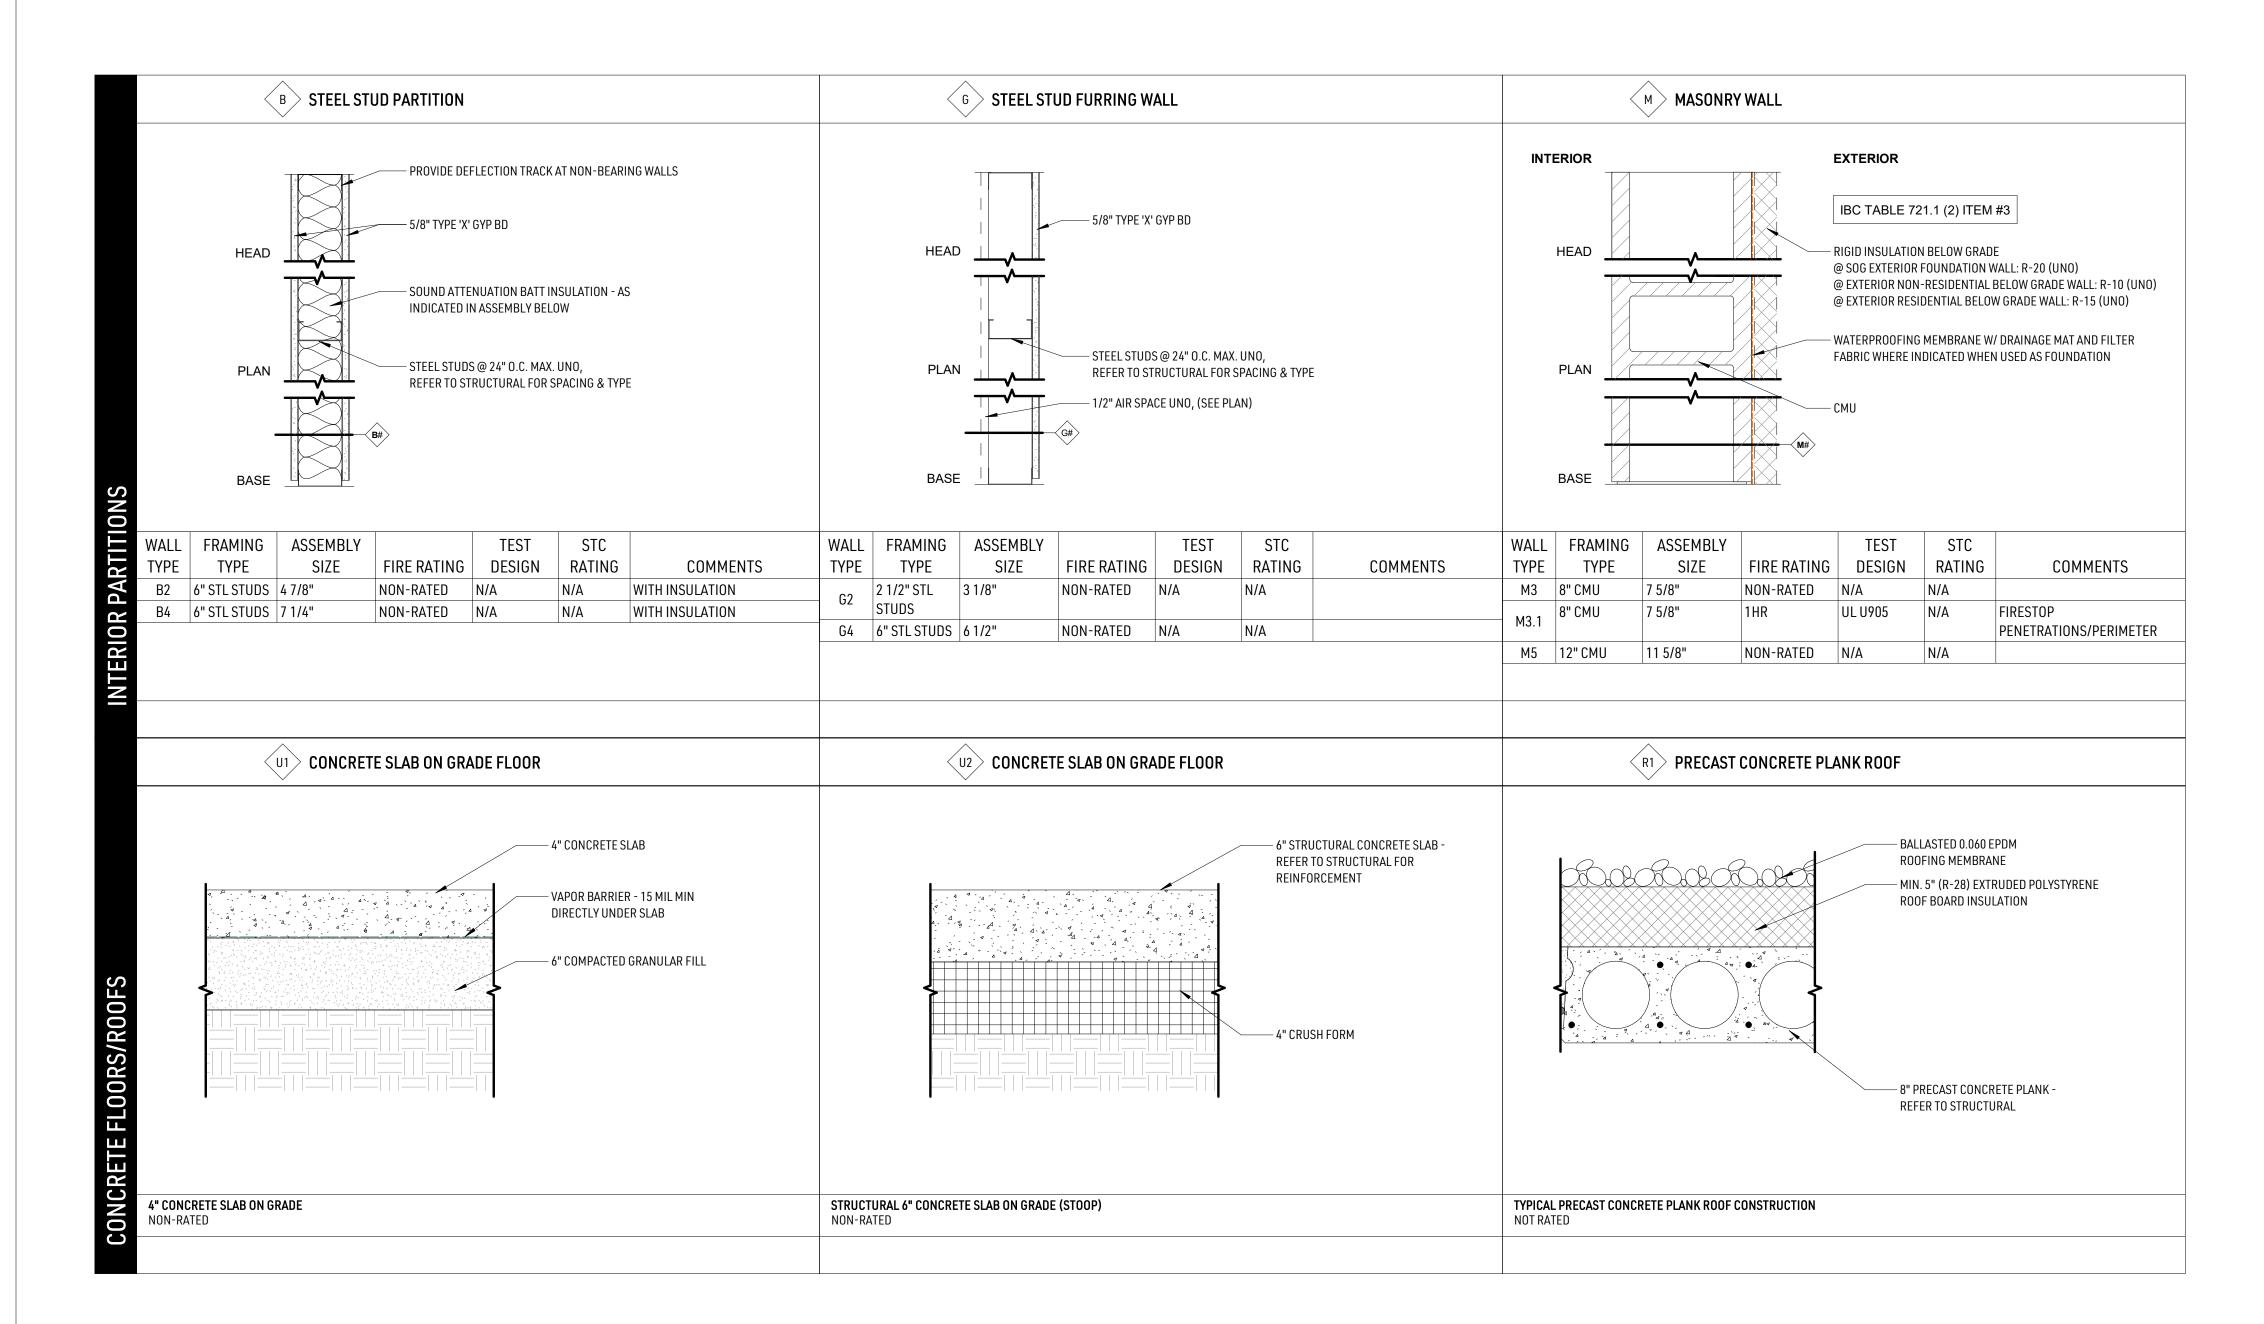

ROSSE 4 RW 4 CREW




CONSTRUCTION

Drainet #:	24-071.00
Project #:	
Date:	10-28-2024
Drawn by:	WP/CW
Checked by:	SB

NOT FOR


Project #:	24-071.0
Date:	10-28-202
Drawn by:	WP/CV
Checked by:	SI
Issue:	Date



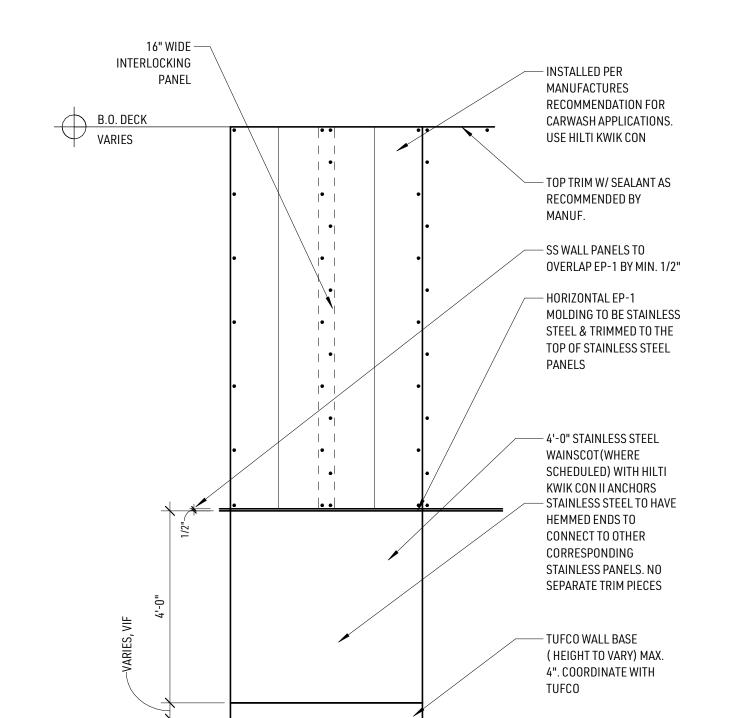



B.O. PANEL (BM)

F2 TUNNEL WALL ELEVATION - EP-1 & SS-2
1/2" = 1'-0"

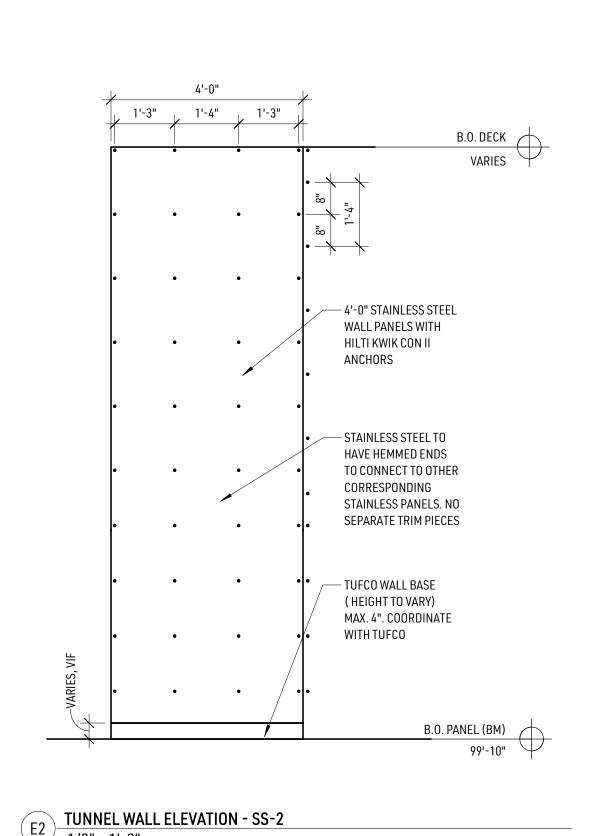


	ROOM FINISH LEGEND									
SYMBOL	MATERIAL	MANUFACTURER	STYLE	COLOR	NOTES					
ACT-1	FRP CEILING TILES	CRANE	1/2" THICK ,SMOOTH	WHITE	15/16" GRID, WHITE/WHITE					
EF	EPOXY FLOORING	TUFCO	SPECIFIED BY OWNER	SPECIFIED BY OWNER	FURNISHED BY OWNER					
EP-1	EXTRUTECH WALL PANEL	EXTRUTECH PLASTICS, INC.	P1600 FLAT	WHITE	16" WIDE PANEL WITH STAINLESS STEEL FASTENERS					
EXP	EXPOSED STRUCTURE									
FRP-1	FIBER REINFORCED PLASTIC	MARLITE	ARTIZAN FRP	MONTEREY, NO. 5408	HARMONIZED ALUMINUM TRIM MOULDING					
FRP-2	FIBER REINFORCED PLASTIC	CRANE	SM00TH	WHITE	PVC TRIM MOULDING, WHITE					
MB-1	MARINE BOARD	POLYMER INDUSTRIES	DENSITEC MARINE	DOLPHIN GREY						
SC	SEALED CONCRETE									
SS-1	18 GA. STAINLESS STEEL	16 GA. FOR COUNTERTOPS AND WINDOW	NO. 4 FINISH		FOR WALLS USE BEVELED EDGES, STAINLESS STEEL FASTENERS					
SS-2	18 GA. STAINLESS STEEL		2B MILL FINISH		BEVELED EDGES, STAINLESS STEEL FASTENERS					
SS-3	18 GA. STAINLESS STEEL		2B MILL FINISH		SEE DETAIL					

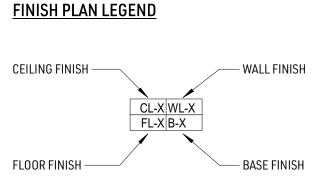

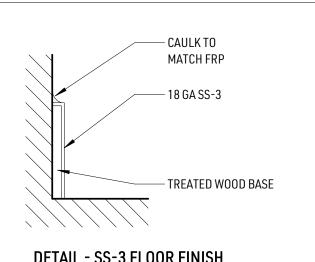

CL-X WL-X FL-X B-X BASE FINISH	TREATED
	<u>DETAIL - SS-3 FLOOR FINIS</u> 3" = 1'-0"

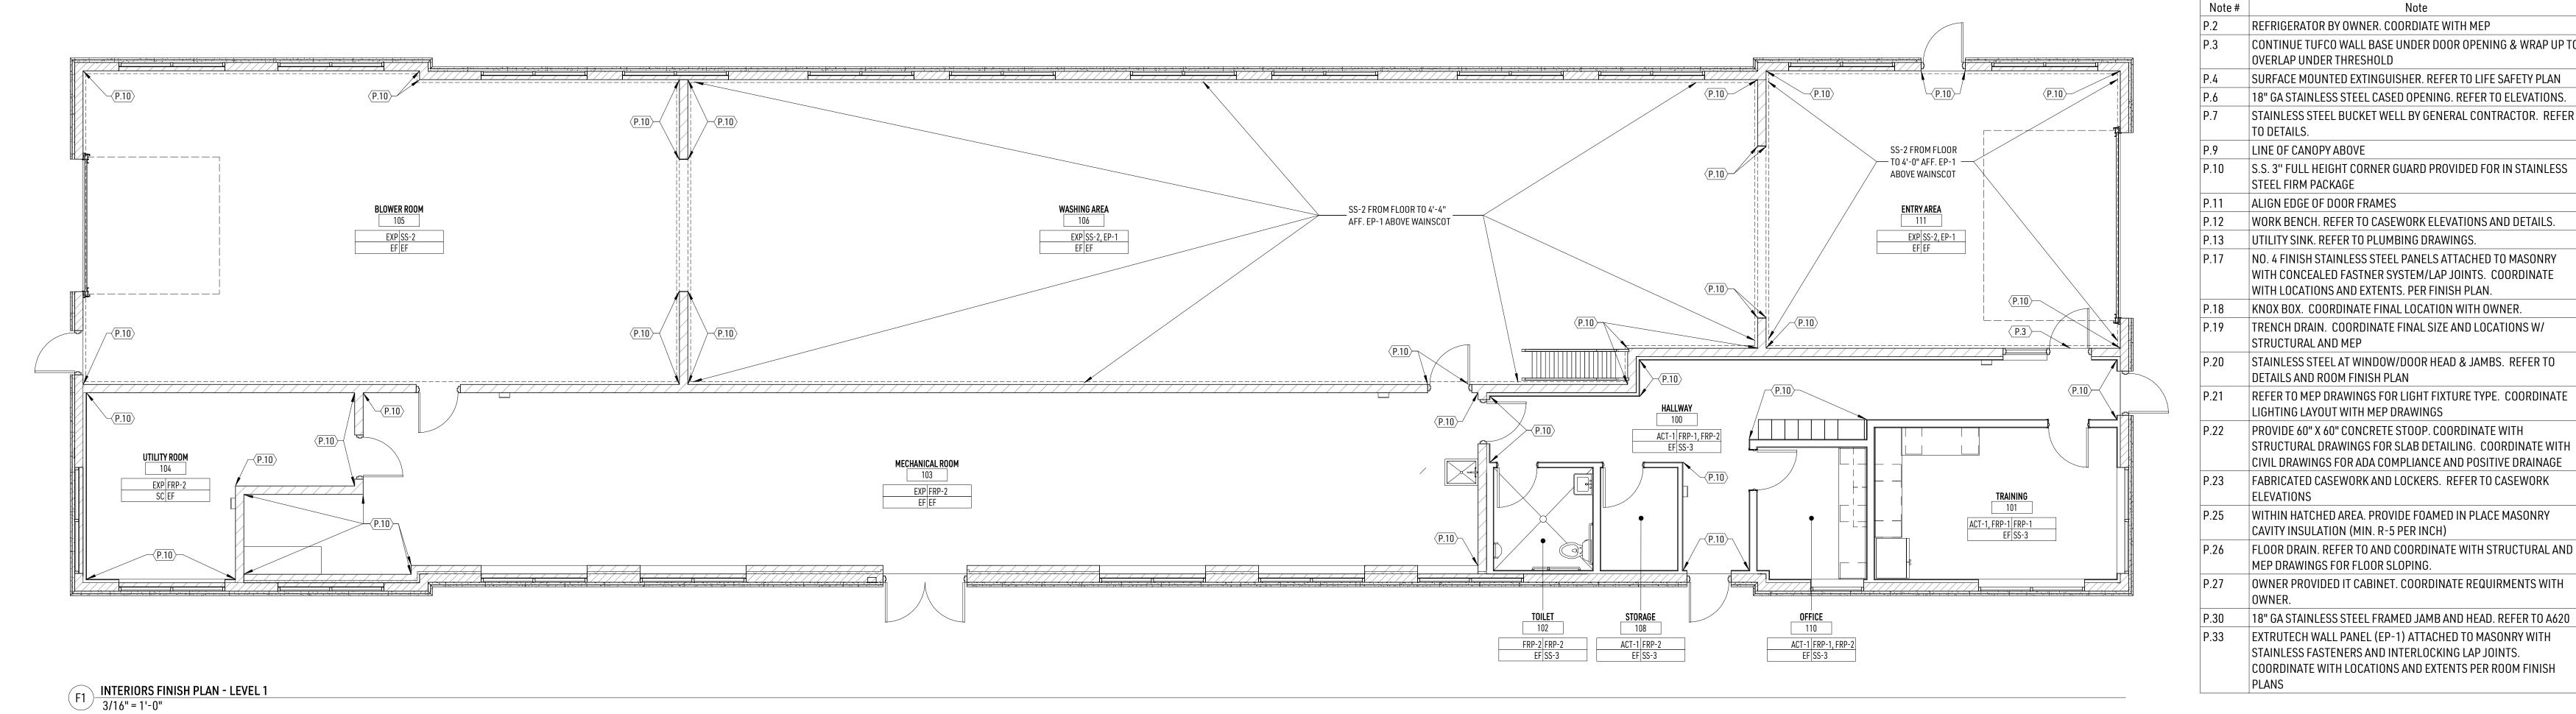

ARCHITECTURAL PLAN KEYNOTES Note# P.2 REFRIGERATOR BY OWNER. COORDIATE WITH MEP CONTINUE TUFCO WALL BASE UNDER DOOR OPENING & WRAP UP TO OVERLAP UNDER THRESHOLD P.4 SURFACE MOUNTED EXTINGUISHER. REFER TO LIFE SAFETY PLAN P.6 18" GA STAINLESS STEEL CASED OPENING. REFER TO ELEVATIONS. STAINLESS STEEL BUCKET WELL BY GENERAL CONTRACTOR. REFER TO DETAILS. P.9 LINE OF CANOPY ABOVE P.10 S.S. 3" FULL HEIGHT CORNER GUARD PROVIDED FOR IN STAINLESS STEEL FIRM PACKAGE P.11 ALIGN EDGE OF DOOR FRAMES P.12 WORK BENCH. REFER TO CASEWORK ELEVATIONS AND DETAILS. P.13 UTILITY SINK. REFER TO PLUMBING DRAWINGS. P.17 NO. 4 FINISH STAINLESS STEEL PANELS ATTACHED TO MASONRY WITH CONCEALED FASTNER SYSTEM/LAP JOINTS. COORDINATE WITH LOCATIONS AND EXTENTS. PER FINISH PLAN. P.18 KNOX BOX. COORDINATE FINAL LOCATION WITH OWNER. P.19 TRENCH DRAIN. COORDINATE FINAL SIZE AND LOCATIONS W/ STRUCTURAL AND MEP P.20 STAINLESS STEEL AT WINDOW/DOOR HEAD & JAMBS. REFER TO DETAILS AND ROOM FINISH PLAN P.21 REFER TO MEP DRAWINGS FOR LIGHT FIXTURE TYPE. COORDINATE LIGHTING LAYOUT WITH MEP DRAWINGS P.22 PROVIDE 60" X 60" CONCRETE STOOP. COORDINATE WITH STRUCTURAL DRAWINGS FOR SLAB DETAILING. COORDINATE WITH CIVIL DRAWINGS FOR ADA COMPLIANCE AND POSITIVE DRAINAGE P.23 FABRICATED CASEWORK AND LOCKERS. REFER TO CASEWORK ELEVATIONS P.25 WITHIN HATCHED AREA. PROVIDE FOAMED IN PLACE MASONRY

CAVITY INSULATION (MIN. R-5 PER INCH)

EXTRUTECH WALL PANEL (EP-1) ATTACHED TO MASONRY WITH

COORDINATE WITH LOCATIONS AND EXTENTS PER ROOM FINISH

STAINLESS FASTENERS AND INTERLOCKING LAP JOINTS.

MEP DRAWINGS FOR FLOOR SLOPING.

INTERIOR GENERAL NOTES

INFORMATION.

OTHERWISE.

DIVISION 15 / 16.

INTERIOR ABBREVIATIONS

AFF ABOVE FINISHED FLOOR

ACRYLIC RESIN PANEL

CUBICLE CURTAINS

CORNER GUARD

CPT CARPET OR CARPET TILE

CMT CERAMIC MOSAIC TILE

CONC. CONCRETE

CT CERAMIC TILE

CTB CERAMIC TILE BASE

FCB FLASH COVE BASE

N.I.C. NOT IN CONTRACT

O.C. ON CENTER

ETR EXISTING TO REMAIN

GYPSUM BOARD, PAINTED

GRANITE TILE / FLOORING

MULTI-COLOR COATING

GLASS TILE / GLASS

DISCREPANCIES TO DESIGNER / ARCHITECT.

TRANSITIONS BETWEEN MATERIALS.

AND/OR GRAIN PATTERN.

MOUNTED CORNER GUARDS.

1. CONTRACTOR SHALL FIELD VERIFY ALL DIMENSIONS, LOCATIONS, AND MATERIAL QUANTITIES PRIOR TO STARTING WORK AND PURCHASING MATERIALS. REPORT ANY

CONTRACTOR SHALL COMPLY WITH ALL MANUFACTURER'S INSTALLATION METHODS AND SHALL NOT EXECUTE WORK WITHOUT VERIFICATION OF FIELD CONDITIONS. 3. REFERENCE ROOM FINISH SPECIFICATIONS FOR MATERIAL TYPE AND ADDITIONAL

4. CONTRACTOR IS RESPONSIBLE TO PROVIDE AND FOR PLACEMENT OF ALL FLOOR FINISH

5. REFERENCE FLOOR FINISH PLAN FOR DIMENSIONS, DIRECTION OF INSTALLATION

ARE OWNER PROVIDED, NOT IN CONTRACT (N.I.C.) UNLESS NOTED OTHERWISE. 8. CASEWORK/MILLWORK INSTALLER IS RESPONSIBLE TO COORDINATE INSTALLATION IN FIELD OF MEP DIVISION 15 / 16 ITEMS INCLUDING CUT-OUTS IN CASEWORK OR

10. PROVIDE STAINLESS STEEL BASE AT FIXED CASEWORK AND SUPPORTS UNLESS NOTED

11. ALL APPLIANCES (EX. REFRIGERATORS, DISHWASHERS, MICROWAVES, ETC.) ARE OWNER

PROVIDED, (N.I.C.) COORDINATE ROUGH OPENING SIZES AND LOCATIONS WITH MEP

12. REFERENCE REFLECTED CEILING PLAN FOR CEILING HEIGHTS, EXTENT OF BULKHEADS,

13. ALL STAINLESS STEEL WALL COVERINGS, CORNER GUARDS, AND MISC. STAINLESS ITEMS

ACOUSTICAL PANEL CEILING PPT PORCELAIN PAVER TILE

CONCRETE FLOOR COATINGS RBF RUBBER FLOORING

PLAM PLASTIC LAMINATE

QUARRY TILE

RCB RUBBER COVE BASE

RF RESINOUS FLOORING

SC SEALED CONCRETE

SPC SPECIAL COATINGS

SSURF SOLID SURFACE

TWC TEXTILE / TACKABLE

TERRAZZO

WALLCOVERING

UNO UNLESS NOTED OTHERWISE

VCT VINYL COMPOSITION TILE

VWC VINYL WALLCOVERING

WC WALLCOVERING

WDP WOOD PANELING WP WALL PROTECTION

WDB WOOD BASE

SV SHEET VINYL

9. MOUNT TOP OF WALL CABINETS @ 7'-2" A.F.F., UNLESS NOTED OTHERWISE.

AND ANY SPECIAL PAINT COLOR DESIGNATIONS.

ARE TO BE DEBARRED & HAVE EASED EDGES.

6. REFERENCE ARCHITECTURAL FLOOR PLANS FOR LOCATION OF FULL HEIGHT SURFACE

LOOSE FURNITURE AND OTHER LOOSE EQUIPMENT ITEMS INDICATED ON THIS DRAWING