## CITY OF LA CROSSE MYRICK PARK PLAYGROUND PHASE 2

LA CROSSE, WISCONSIN

**LEGEND** 

75% PLAN REVIEW

PROJECT LOCATION

SQUARE YARD

TOP OF CURB

TELEPHONE

THROUGH

TRANSFORMER

TOP OF WALL

WITHOUT

WITH

YARD

YEAR

TOP NUT OF FIRE HYDRANT

UTILITY, UNDERGROUND

ISG

VITRIFIED CLAY PIPE

TEMP TEMPORARY

TRANS

W/O

**ISG PROJECT # 22-28015** 

### **SHEET INDEX**


- C0-10 TITLE SHEET
- C0-11 ALTERNATES KEY PLAN
- C0-20 SITE DETAILS
- C0-30 FURNISHING DETAILS
- C0-40 LIMESTONE DETAILS
- C0-50 PLAY EQUIPMENT SECTIONS
- C0-60 SITE SECTIONS
- C1-20 EROSION CONTROL PLAN
- C2-10 EXISTING SITE AND REMOVALS PLAN
- C3-10 SITE PLAN
- C3-20 PLAY EQUIPMENT PLAN
- C3-30 UTILITY PLAN
- C4-10 GRADING PLAN
- C5-10 PLANTING PLAN
- C5-20 PLANTING DETAILS
- E2-10 SITE ELECTRICAL PLAN
- E2-01 SITE LIGHTING PHOTOMETRIC PLAN
- E2-02 MANUFACTURER CATALOGUE PAGES

### **PROJECT GENERAL NOTES**

- SUBCONTRACTORS BY THE GENERAL CONTRACTOR IN COMPLETE SETS IN ORDER TO ACHIEVE THE FULL EXTENT AND COMPLETE COORDINATION OF ALL WORK.
- 3. WRITTEN DIMENSIONS TAKE PRECEDENCE OVER SCALED DIMENSIONS. NOTIFY ARCHITECT/ENGINEER OF ANY DISCREPANCIES OR CONDITIONS REQUIRING INFORMATION OR CLARIFICATION BEFORE PROCEEDING WITH THE WORK.
- 4. FIELD VERIFY ALL EXISTING CONDITIONS AND DIMENSIONS NOTIFY ARCHITECT/ENGINEER OF ANY DISCREPANCIES OF CONDITIONS REQUIRING INFORMATION OR CLARIFICATION BEFORE PROCEEDING WITH THE WORK.
- 5. DETAILS SHOWN ARE INTENDED TO BE INDICATIVE OF THE PROFILES AND TYPE OF DETAILING REQUIRED THROUGHOUT THE WORK. DETAILS NOT SHOWN ARE SIMILAR IN CHARACTER TO DETAILS SHOWN. WHERE SPECIFIC DIMENSIONS, DETAILS, OR DESIGN INTENT CANNOT BE DETERMINED, NOTIFY ARCHITECT/ENGINEER BEFORE PROCEEDING WITH THE WORK.
- 6. ALL MANUFACTURED ARTICLES, MATERIALS, AND EQUIPMENT SHALL BE APPLIED, INSTALLED, CONNECTED, ERECTED, CLEANED, AND CONDITIONED ACCORDING TO MANUFACTURERS' INSTRUCTIONS. IN CASE OF DISCREPANCIES BETWEEN MANUFACTURERS INSTRUCTIONS AND THE CONTRACT DOCUMENTS, NOTIFY ARCHITECT/ENGINEER BEFORE PROCEEDING WITH THE

- ALL EXISTING UTILITIES PRIOR TO CONSTRUCTION. CONTRACTOR SHALL IMMEDIATELY NOTIFY ENGINEER OF ANY DISCREPANCIES OR VARIATIONS FROM PLAN.
- 9. THE CONTRACTOR IS TO CONTACT "DIGGERS HOTLINE" FOR UTILITY LOCATIONS A MINIMUM OF 3 BUSINESS DAYS PRIOR TO ANY EXCAVATION / CONSTRUCTION (811 OR



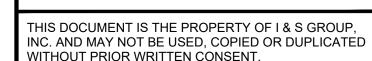

### CITY OF LA CROSSE **MYRICK PARK PLAYGROUND** PHASE 2

LA CROSSE **WISCONSIN** 

REVISION SCHEDULE	
DATE DESCRIPTION	BY

PROJECT NO. 22-28015 **FILE NAME** 28015 C0-TITLE **DRAWN BY DESIGNED BY REVIEWED BY** ORIGINAL ISSUE DATE 02/02/23

## PROJECT INDEX:

CMP

C&G

DIM

CONC CONCRETE

CONST CONSTRUCTION

CUBIC YARD

DOWNSPOUT

ELEVATION

EXISTING

FIRE DEPARTMENT CONNECTION HH

CURB AND GUTTEI

CONT CONTINUOUS

CORRUGATED METAL PIPE

### **OWNER:**

**ABBREVIATIONS:** 

APPROX APPROXIMATE

CAST IRON PIP

CONTROL JOINT

CENTERLINE

CAST IN PLACE CONCRETE

ABOVE FINISHED FLOOR

**CITY OF LA CROSSE 400 LA CROSSE STREET LA CROSSE, WI, 54601** 608-789-7533

**PROJECT ADDRESS / LOCATION:** 789 MYRICK PARK DR, **LA CROSSE, WI, 54601** 

**SECTION/TOWNSHIP/RANGE:** 33/16/7

**LOCATION MAP** 

SCALE IN FEET

HORIZ HORIZONTAL

HWL

HWY

HYD

J-BOX

HIGH WATER LEVE

INSIDE DIAMETER

HYDRANT

INVERT

**IRON PIPE** 

IRON PIPE SIZE

JUNCTION BOX

LINEAR FEET

LUMP SUM

LSO LOWEST STRUCTURAL OPENING PP

FFE FINISHED FLOOR ELEVATION

GENERAL CONTRACTOR

HDPE HIGH DENSITY POLYETHYLENE

FOOT, FEET

GAUGE

GALLON

GUTTER LINE

GPM GALLONS PER MINUT

GALV GALVANIZED

HD HEAVY DUTY

### **MANAGING OFFICE:**

201 MAIN STREET **SUITE 1020** LA CROSSE, WI 54601 PHONE: 608.789.2034

RAD RADIUS

REM REMOVE

SAN SANITARY

REBAR REINFORCING BAR

ROW RIGHT OF WAY

R/W RIGHT OF WAY

SPEC SPECIFICATION

SQ SQUARE

STA STATION

SQUARE FOOT

REINFORCED CONCRETE PIPE

#### SPECIFICATIONS REFERENCE

ALL CONSTRUCTION SHALL COMPLY WITH THE CITY OF LA CROSSE STANDARD SPECIFICATIONS, CURRENT EDITION, WISDOT STANDARD SPECIFICATIONS, 2023 EDITION, WISDOT CONSTRUCTION AND MATERIALS MANUAL, CURRENT EDITION WISCONSIN DEPARTMENT OF SAFETY AND PROFESSIONAL SERVICES STATE PLUMBING CODE, CURRENT EDITION, AND STANDARD SPECIFICATION FOR SEWER & WATER CONSTRUCTION IN WISCONSIN, 6th EDITION, UNLESS DIRECTED **OTHERWISE** 

HORIZONTAL COORDINATES HAVE BEEN REFERENCED TO THE NORTH AMERICAN DATUM OF 1983 (NAD83), 2011 ADJUSTMENT (NAD83(2011)) ON THE LA CROSSE COUNTY COORDINATE SYSTEM, IN U.S. SURVEY FEET.

### **B.M. ELEVATION = 664.62** TOP OF 3/4" BAR

NORTHING = 134914.100'

EASTING = 452055.128'

#### TOPOGRAPHIC SURVEY

THIS PROJECT'S TOPOGRAPHIC SURVEY CONSISTS OF DATA COLLECTED IN 11 / 2022 BY ISG.

### **TITLE SHEET**

RELIMINA

TITLE

CLIENT PROJECT NO.

**CO-10** 

**PROPOSED** 

 $\bigcirc$ 

STORM SEWER OVERHEAD ELECTRIC UNDERGROUND ELECTRIC **UNDERGROUND TV** CONTOUR **CATCH BASIN** HYDRANT

STORM SEWER (PIPE WIDTH) SANITARY SEWER (PIPE WIDTH) MANHOLE (STORM, SANITARY)

VALVE

**DECIDUOUS TREE** 

**CONIFEROUS TREE** 

MANHOLE/STRUCTURE

UTILITY PEDESTAL / CABINET

TREE LINE

CATCH BASIN

**HYDRANT** 

**CURB STOP** 

POWER POLE

VALVE

MAIL BOX

MANHOLE

MINIMUM

NUMBER

NOT TO SCALE

ON CENTER

OCEW ON CENTER EACH WAY

PERFORATED

PROPERTY LINE

POLYPROPYLENE

OVERHEAD DOOR

PEDESTAL, PEDESTRIAN

MECH MECHANICAL

LA CROSSE OFFICE

PROJECT MANAGER: Paul Nelson EMAIL: Paul.Nelson@ISGInc.com

					KEY
	<b>B</b>				A SITE EL  B SHADE  C SWINGS  D PLAY SU
		o 12°0, rubra	JdI JdI JdI Ld L		
	TPF TAPE	31°C occidentalis	27°C, projentalis		ejauca
	O 13° Q. bicolor				32°C, occide aniis
4 O 13'A rubrum		29°G. triacanthos		31°C. ooddenalis	
	Add o 7º 8, pejidula	C			
			26° Al riatanoides	B	A) (6)
		B)		TPF	O 17°P, strabus
		TPF TPF	TPF TPF	18"P. strobus	14°P. strobus
2:51 PM				O 18°P. strobus	
PLOT DATE: 2/17/2023 :		29° A. s	saccharinum		

		ALTERNATE	S	
KEY	DECRIPTION	BASE BID	ALTERNATE	REFERENCE
<b>(A</b> )	SITE ELECTRICAL	SITE ELECTRICAL NOT INCLUDED	INCLUDE SITE ELECTRCIAL	E2-10
B	SHADE CANOPIES	SHADE CANOPIES NOT INCLUDED	INCLUDE SHADE CANOPIES	C3-10
<b>(C)</b>	SWINGS	ARCH SWING AND FRIENDSHIP SWING SETS NOT INCLUDED	INCLUDE ARCH SWING AND FRIENDSHIP SWING SETS	C3-20
<b>D</b>	PLAY SURFACING	INSTALL POURED-IN-PLACE SURFACING PER PLANS	REPLACE POURED-IN-PLACE SURFACING WITH ENGINEERED WOOD FIBER	C3-10





PRELIMINARY NOT FOR CONSTRUCTION THIS DOCUMENT IS THE PROPERTY OF I & S GROUP, INC. AND MAY NOT BE USED, COPIED OR DUPLICATED WITHOUT PRIOR WRITTEN CONSENT.

PROJECT

## CITY OF LA CROSSE MYRICK PARK **PLAYGROUND** PHASE 2

CONSTRUCTION WISCONSIN LA CROSSE REVISION SCHEDULE DESCRIPTION 22-28015 PROJECT NO. FILE NAME 28015 C0-ALTERNATES


REVIEWED BY ORIGINAL ISSUE DATE 02/02/23 CLIENT PROJECT NO. -


DRAWN BY DESIGNED BY

**ALTERNATES KEY PLAN** 


**PRELIMINARY** 

C0-11

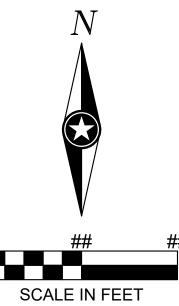

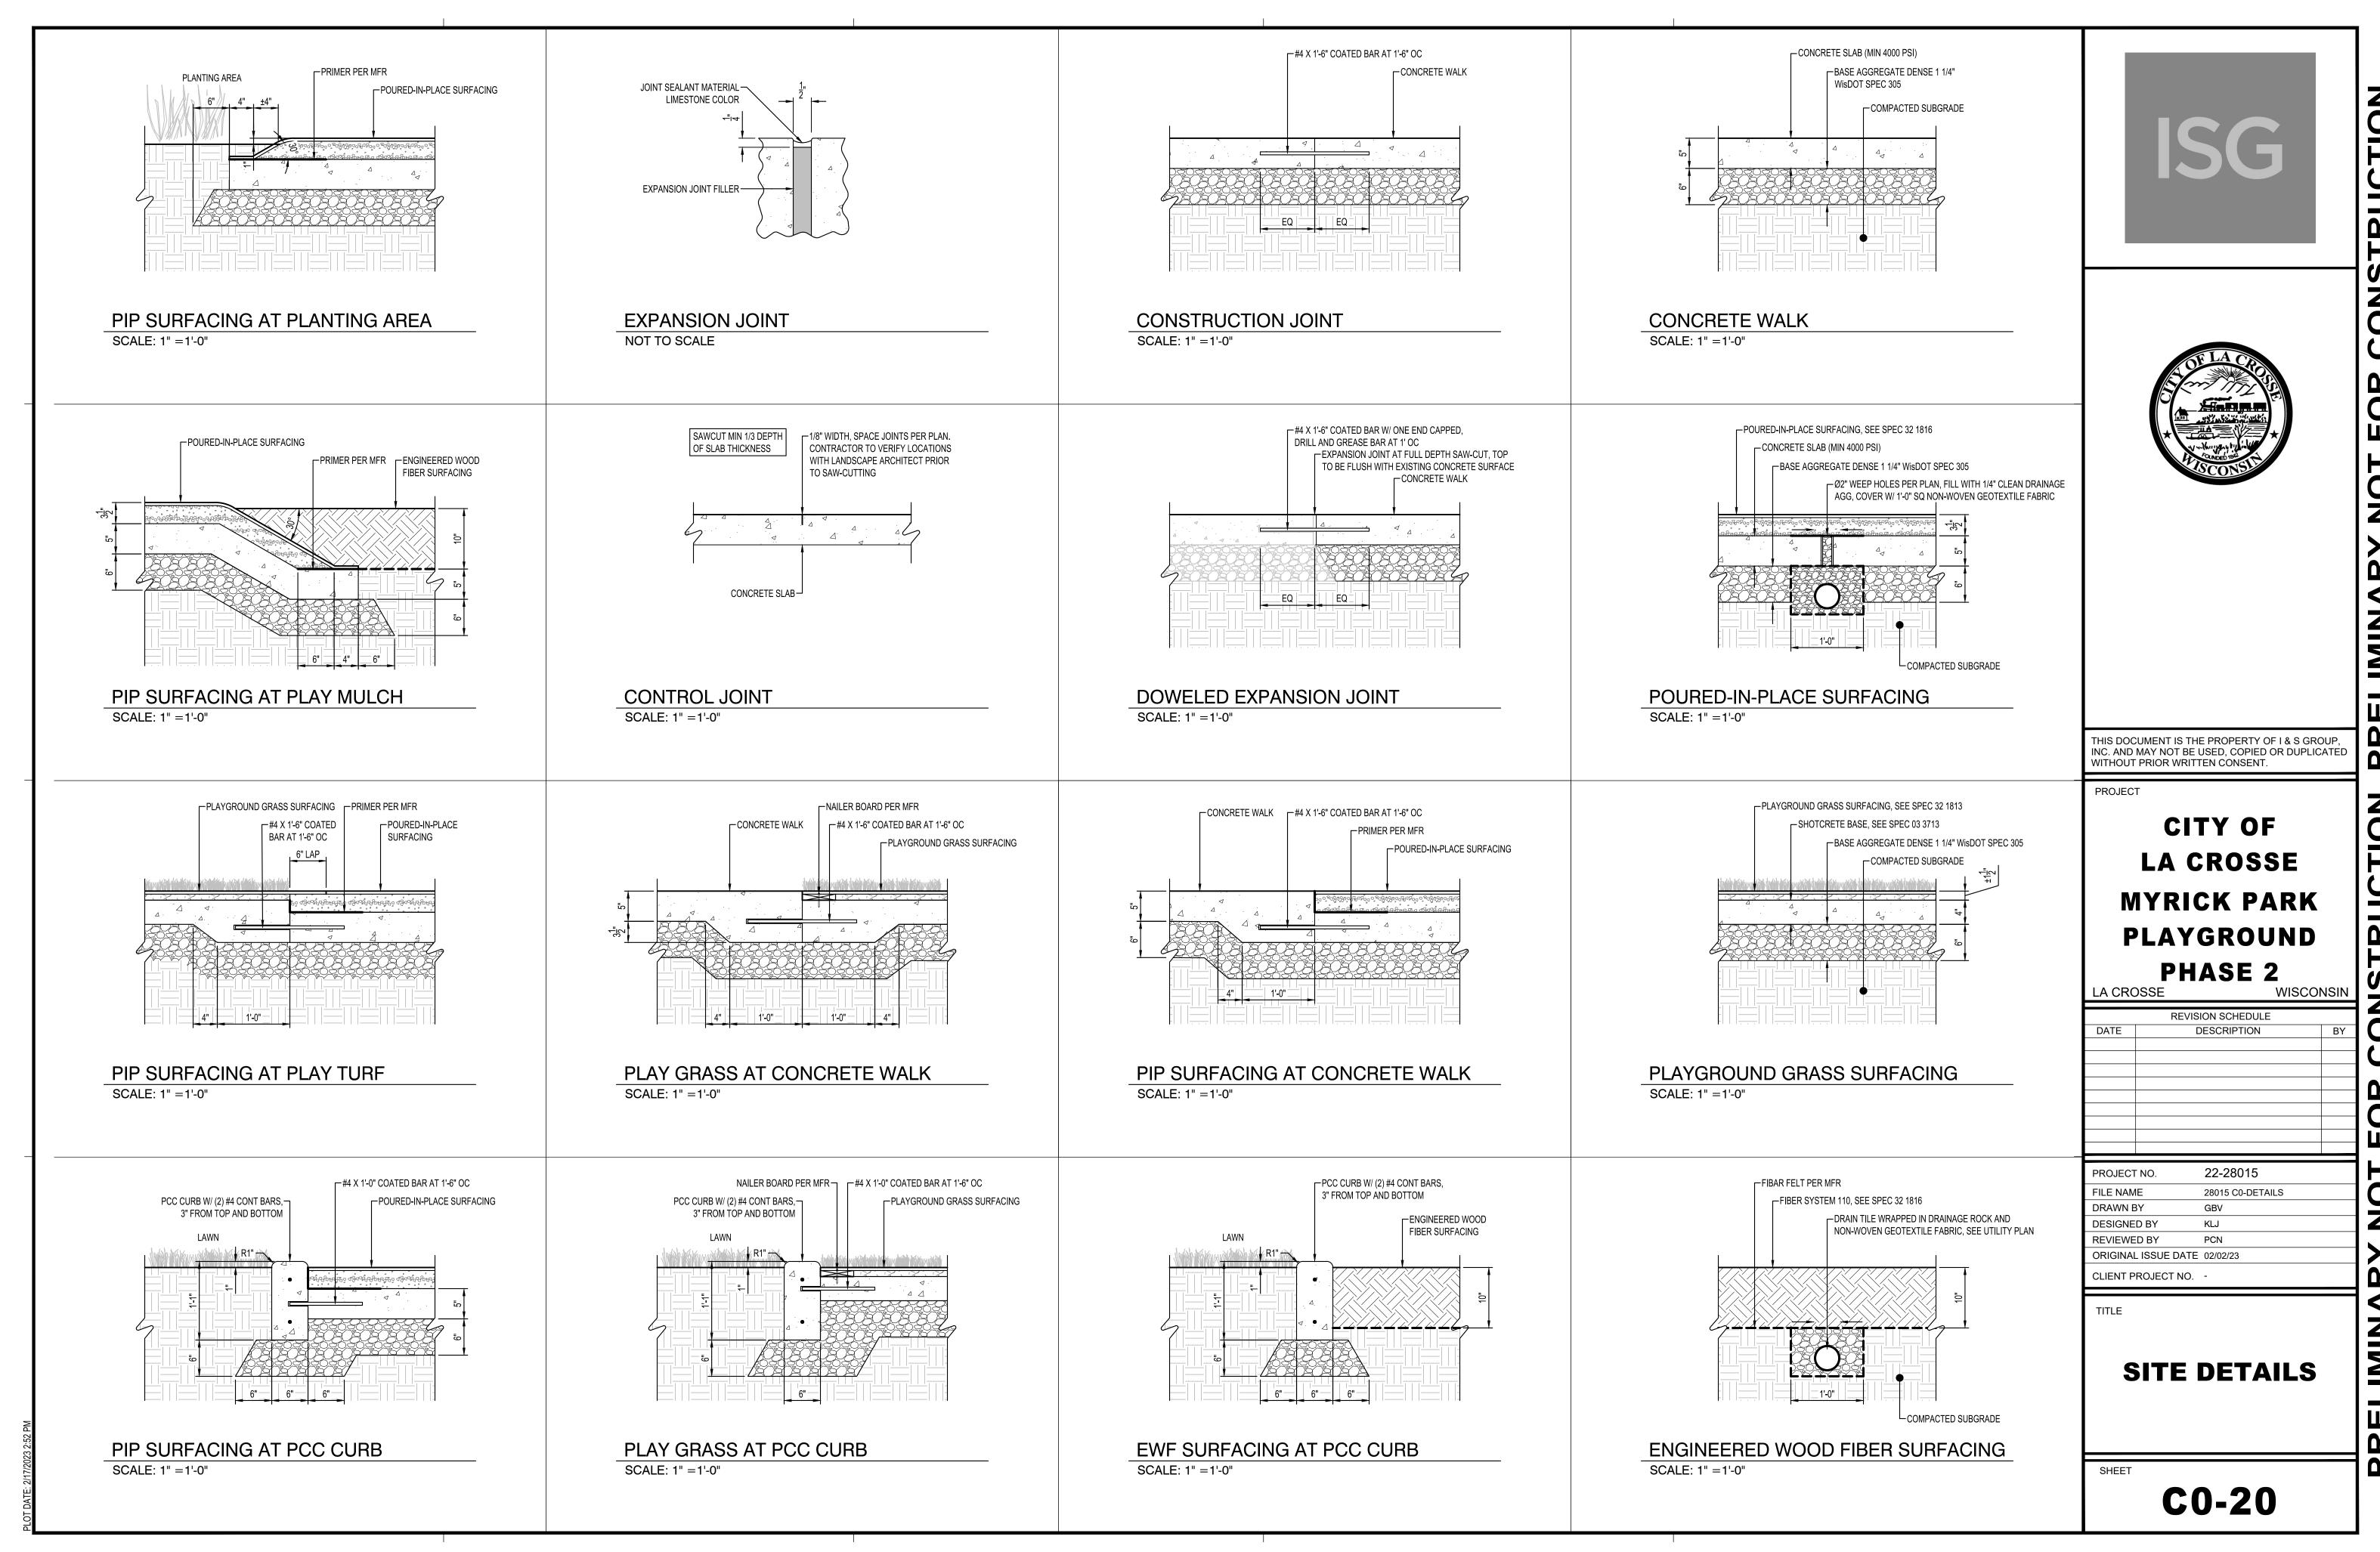

CONSTRUCTION LON **PRELIMINARY** NOIL **PRELIMINAR** 

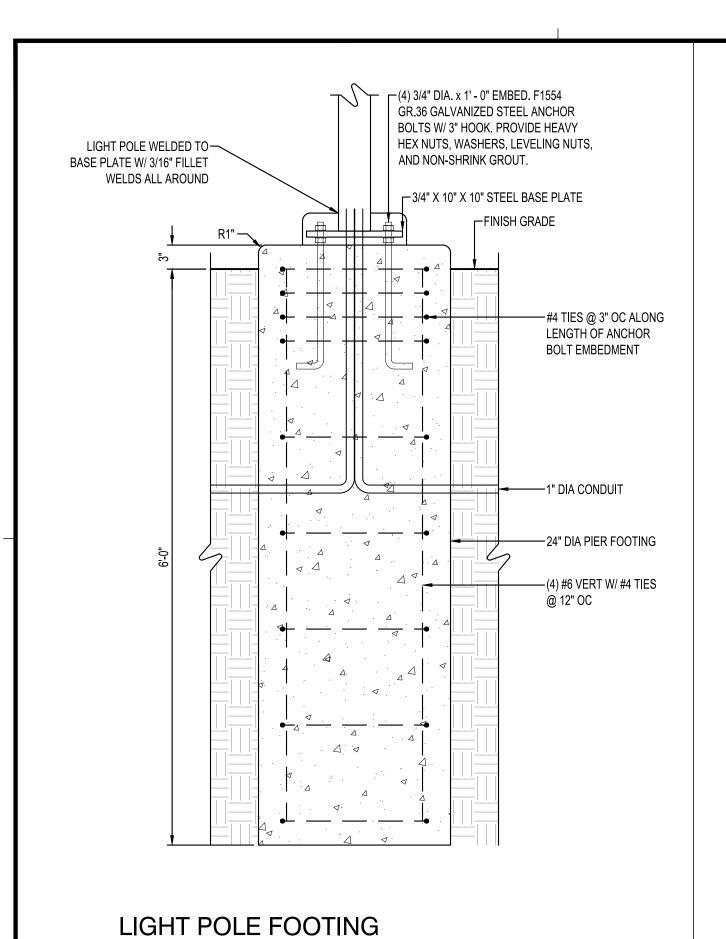

SCALE: 1" =1'-0"

STAINLESS STEEL ANCHORS PER MANUFACTURER RECOMMENATIONS

TIMBER BENCH

MANUFACTURER: TIMBERFORM
MODEL: 2219-16 COLOSSUS GIANT TIMBER SEAT
FRAME: GALVANIZED
MOUNTING: SURFACE MOUNT

TIMBER BENCH

SCALE: 1" =1'-0"

MANUFACTURER LANDSLATE FORMS
MODE, ORDING ARRORNED FALLE SEAT DRING HEIGHT HOOP SEATS STEELINGA AT DA MODO TABLETOP
HIT TALLETOP, AND ANA
MODITING SURFACE MOUNT

SURFACE MOUNT TABS

ISOMETRIC VIEW

ISOMETRIC VIEW

DINING HEIGHT TABLE

SCALE: 1" =1'-0"

ISG

CONSTRUCTION

LON

**PRELIMINARY** 

CTION

**PRELIMINAR** 



THIS DOCUMENT IS THE PROPERTY OF I & S GROUP, INC. AND MAY NOT BE USED, COPIED OR DUPLICATED WITHOUT PRIOR WRITTEN CONSENT.

PROJECT

# CITY OF LA CROSSE MYRICK PARK PLAYGROUND PHASE 2

LA CROSSE WISCONSIN

	REVISION SCHEDULE	
DATE	DESCRIPTION	BY
	NO 22 29015	

PROJECT NO. 22-28015

FILE NAME 28015 CO-DETAILS

DRAWN BY GBV

DESIGNED BY KLJ

REVIEWED BY PCN

ORIGINAL ISSUE DATE 02/02/23


CLIENT PROJECT NO. -

TITLE

FURNISHING DETAILS

LICCT

C0-30

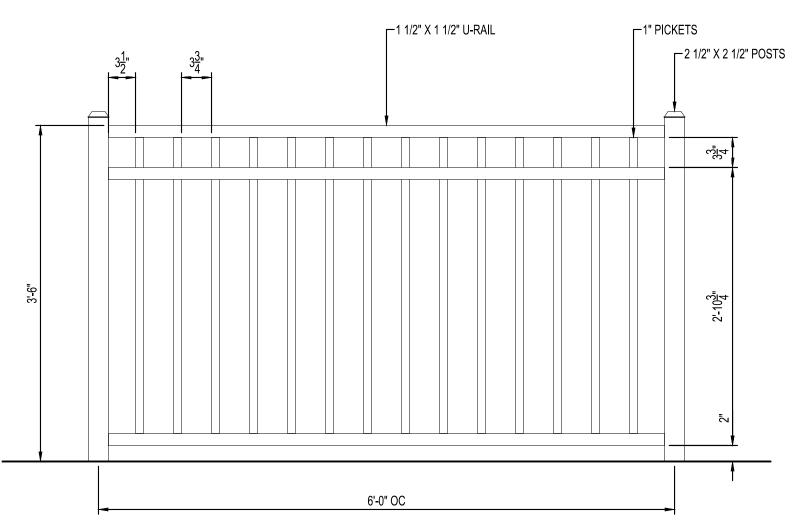



MANUFACTURER: DIGGER SPECIALTIES INC.
MODEL: COURTYARD ALUMINUM FENCING, 2000 SERIES, FLAT TOP STYLE, 3-RAIL FLUSH BOTTOM
COLOR: BLACK
MOUNTING: INSTALL POSTS PER MANUFACTURER'S INSTRUCTIONS


DECORATIVE FENCE

SCALE: 1" =1'-0"

ATE: 2/17/2023 2:52 PM

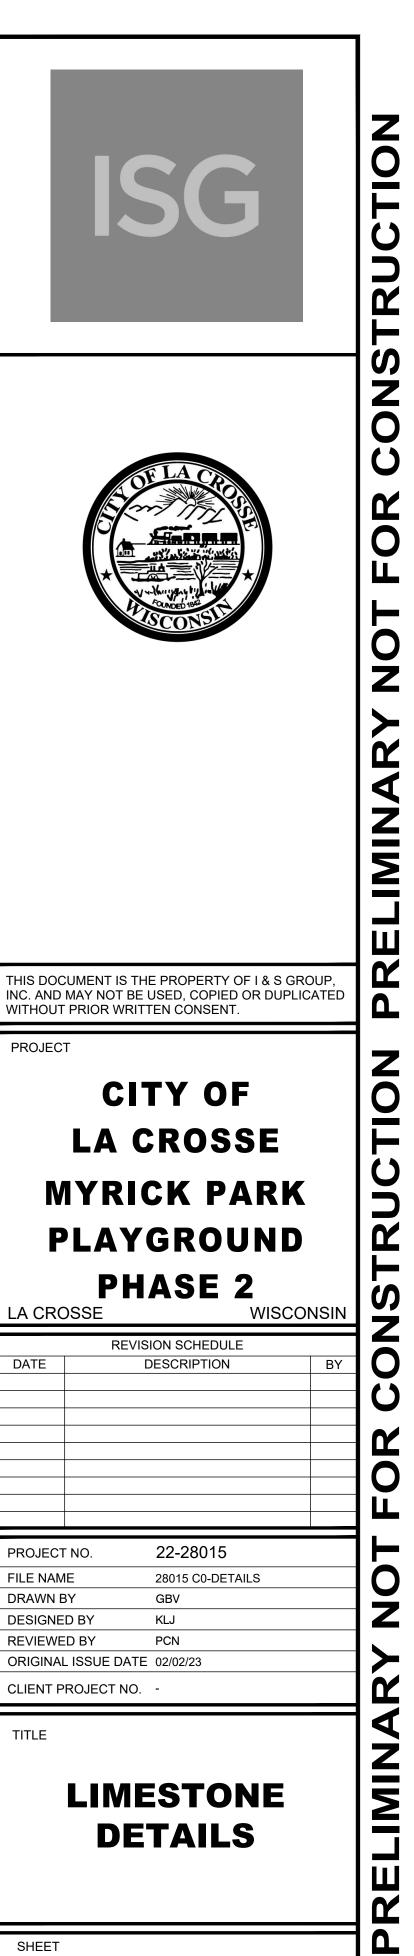

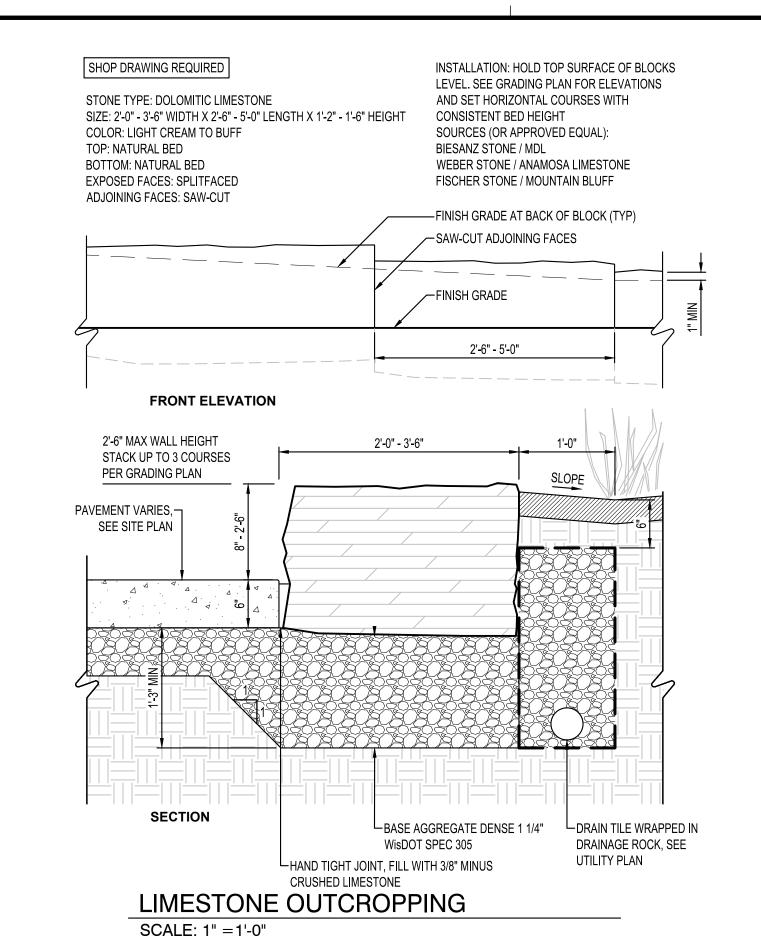

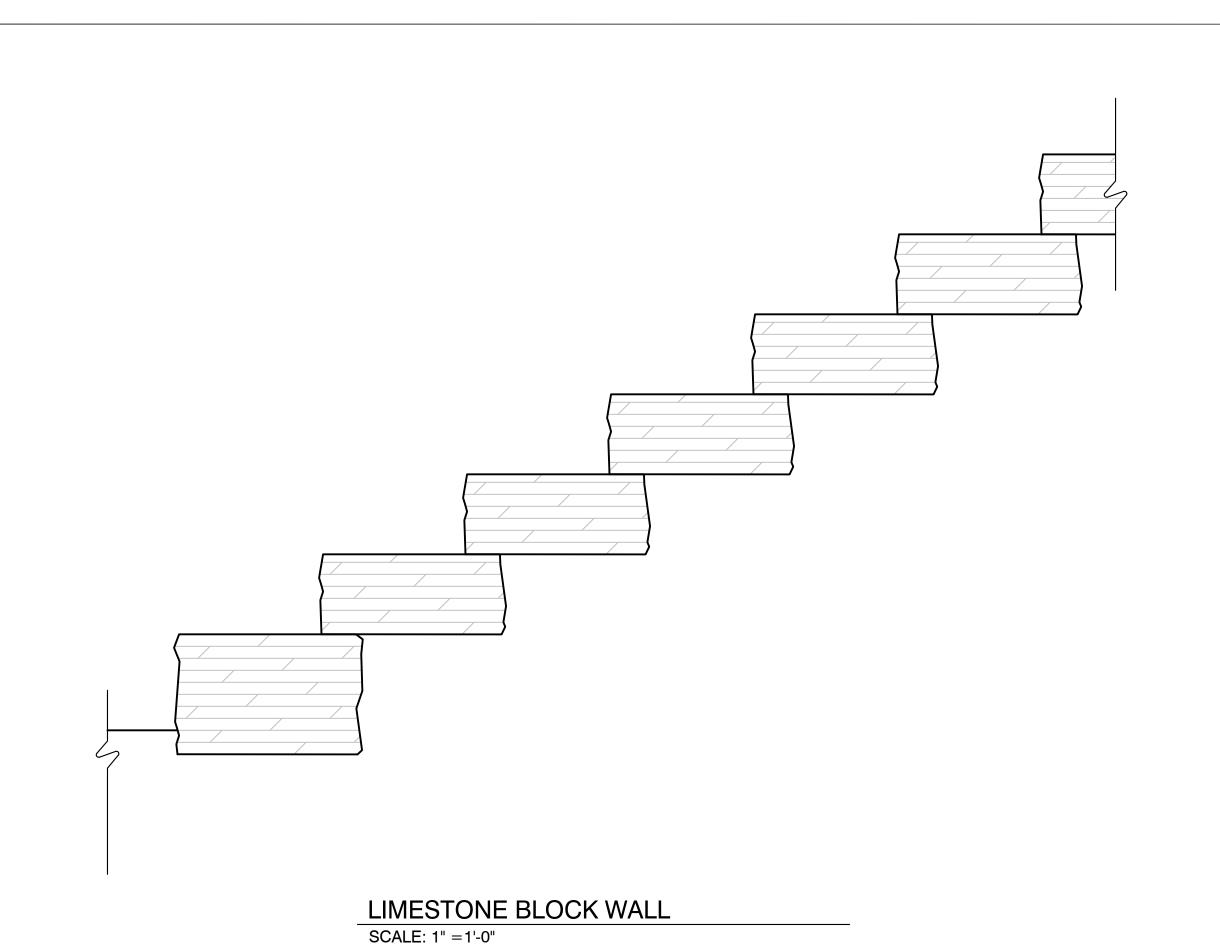






PROJECT

## LA CROSSE MYRICK PARK **PLAYGROUND**

LA CRO	DSSE		WISCO	NSIN
	REVISI	ION SCHEDULE	<u> </u>	
DATE	D	ESCRIPTION		BY
PROJEC1	 Г NO.	22-28015		

PROJECT NO.	22-28015
FILE NAME	28015 C0-DETAILS
DRAWN BY	GBV
DESIGNED BY	KLJ
REVIEWED BY	PCN
ORIGINAL ISSUE DATE	02/02/23
CLIENT DDO JECT NO	

C0-40

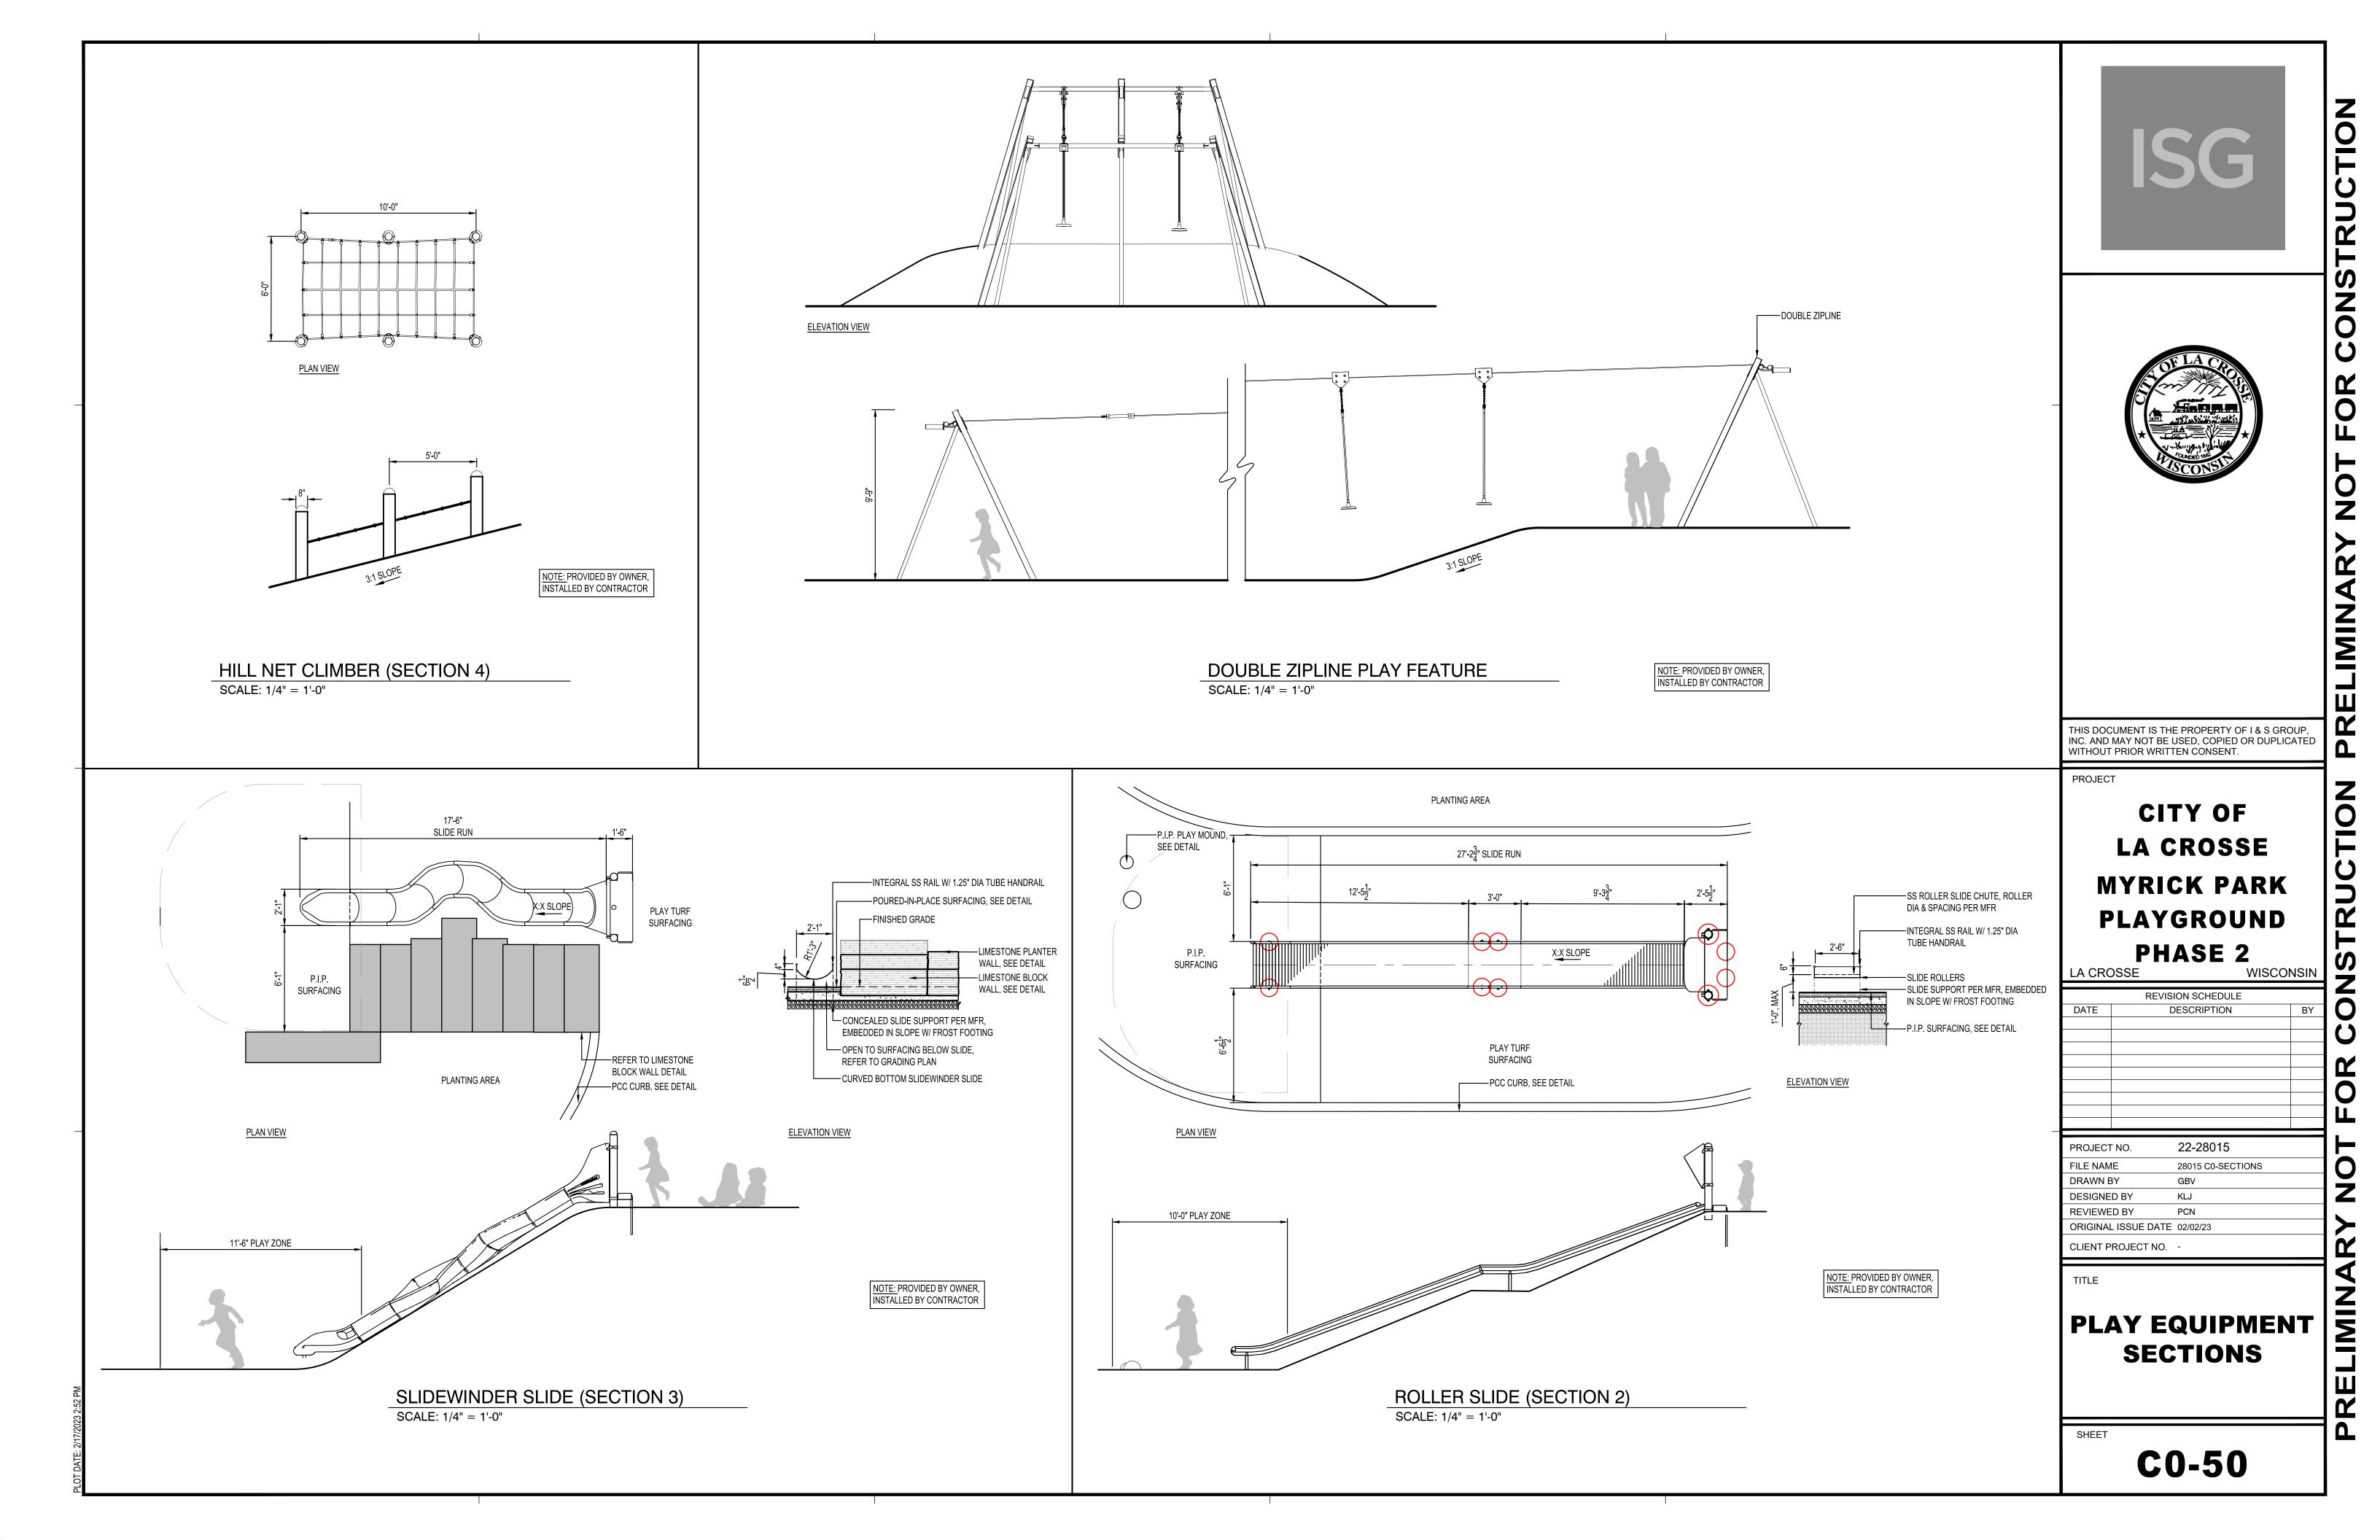





PRELIMINARY NOT FOR CONSTRUCTION

CONSTRUCTION

**PRELIMINARY** 

THIS DOCUMENT IS THE PROPERTY OF I & S GROUP, INC. AND MAY NOT BE USED, COPIED OR DUPLICATED WITHOUT PRIOR WRITTEN CONSENT.

PROJECT

## CITY OF LA CROSSE **MYRICK PARK PLAYGROUND**

PHASE 2 LA CROSSE


WISCONSIN

REVISION SCHEDULE  DATE DESCRIPTION BY			
DATE DESCRIPTION BY		REVISION SCHEDULE	
	DATE	DESCRIPTION	BY

PROJECT NO.	22-28015
FILE NAME	28015 C0-SECTIONS
DRAWN BY	GBV
DESIGNED BY	KLJ
REVIEWED BY	PCN
ORIGINAL ISSUE DATE	02/02/23
CLIENT PROJECT NO.	-

SITE SECTIONS

**CO-60** 

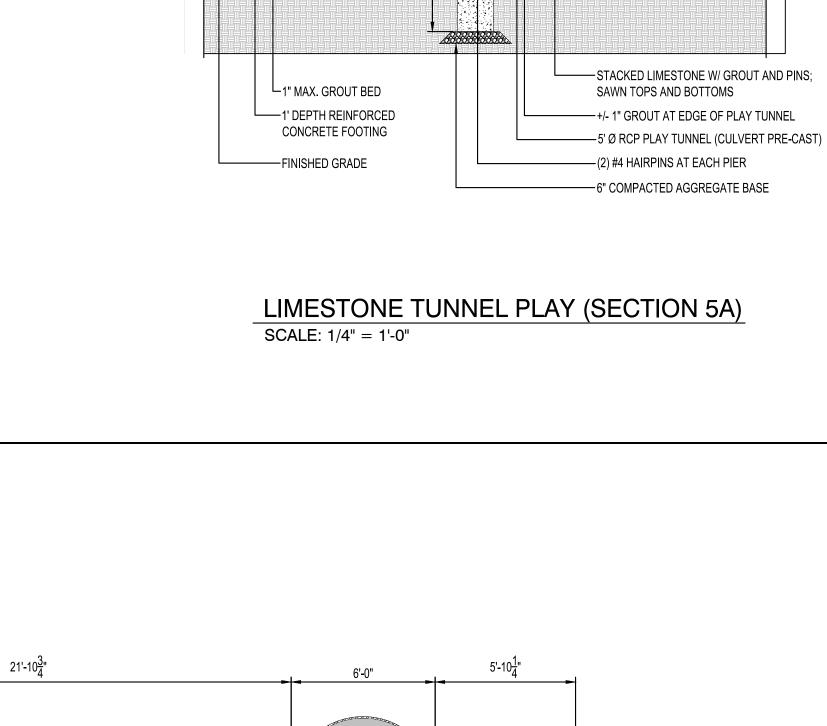

POURED-IN-PLACE SURFACING

—STACKED LIMESTONE W/ GROUT AND PINS; SAWN TOPS AND BOTTOMS

LIMESTONE TUNNEL PLAY (SECTION 5) SCALE: 1/4" = 1'-0"

4'-0", TYP.

L<sub>1"</sub> MAX. GROUT BED

—12" DEPTH REINFORCED CONCRETE FOOTING

11'-5<u>1</u>"

----+/- 1" GROUT AT EDGE OF PLAY TUNNEL


——5' Ø RCP PLAY TUNNEL (CULVERT PRE-CAST)

10'-11<u>1</u>"

---FINISHED GRADE

 $-rac{3}{8}$ " DOWEL @ X" OFFSET FROM EDGE OF LIMESTONE



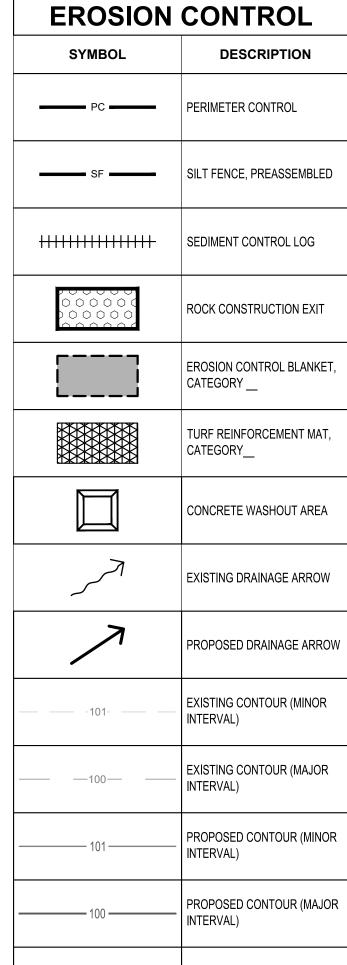

PERIMETER CONTROL CAN BE SILT FENCE OR SEDIMENT

NOTE: EROSION CONTROL PLAN COVERAGE INCLUDES COMPANY OR THEIR SUBCONTRACTOR IS RESPONSIBLE TO FOLLOW THE REQUIREMENTS OF THIS PLAN, INCLUDING
PROVIDING THEIR OWN RESTORATION IF INSTALLATION OCCURS
AFTER PRIMARY INSTALLATION OF SEEDING / SODDING / MULCHING DURING CONSTRUCTION OF EACH UTILITY.





LON

**PRELIMINARY** 

**PRELIMINAR** 

THIS DOCUMENT IS THE PROPERTY OF I & S GROUP, INC. AND MAY NOT BE USED, COPIED OR DUPLICATED WITHOUT PRIOR WRITTEN CONSENT.

PROJECT

## CITY OF LA CROSSE MYRICK PARK **PLAYGROUND** PHASE 2

A CRO	)SSE		WISCO	NSIN
	RI	EVISION SCHED	ULE	
DATE		DESCRIPTION	N	BY
ROJECT	NO.	22-2801	5	
ILE NAM	IE	28015 C1-E	ROSION	

DRAWN BY DESIGNED BY REVIEWED BY


ORIGINAL ISSUE DATE 02/02/23

CLIENT PROJECT NO.

## **EROSION CONTROL PLAN**

C1-20



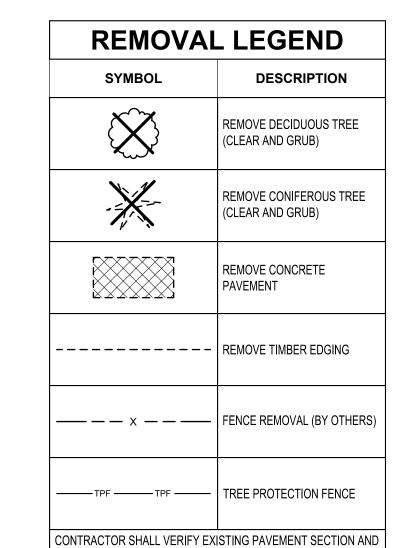

NOTIFY ENGINEER OF ANY DISCREPANCIES.

PAVEMENT REMOVALS SHALL INCLUDE FULL DEPTH SAWCUT AND SECTION REMOVAL.



CONSTRUCTION

**PRELIMINARY** 



THIS DOCUMENT IS THE PROPERTY OF I & S GROUP, INC. AND MAY NOT BE USED, COPIED OR DUPLICATED WITHOUT PRIOR WRITTEN CONSENT.

PROJECT

# CITY OF LA CROSSE MYRICK PARK PLAYGROUND PHASE 2

REVISION SCHEDULE

DATE DESCRIPTION BY

PROJECT NO. 22-28015

FILE NAME 28015 C2-EXIST

DRAWN BY GBV

DESIGNED BY KLJ

REVIEWED BY PCN

ORIGINAL ISSUE DATE 02/02/23


CLIENT PROJECT NO. -


TITLE

### EXISTING SITE AND REMOVALS PLAN

CLIEFT

C2-10

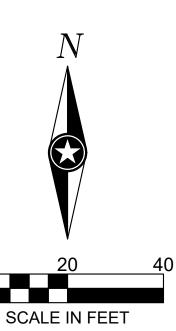

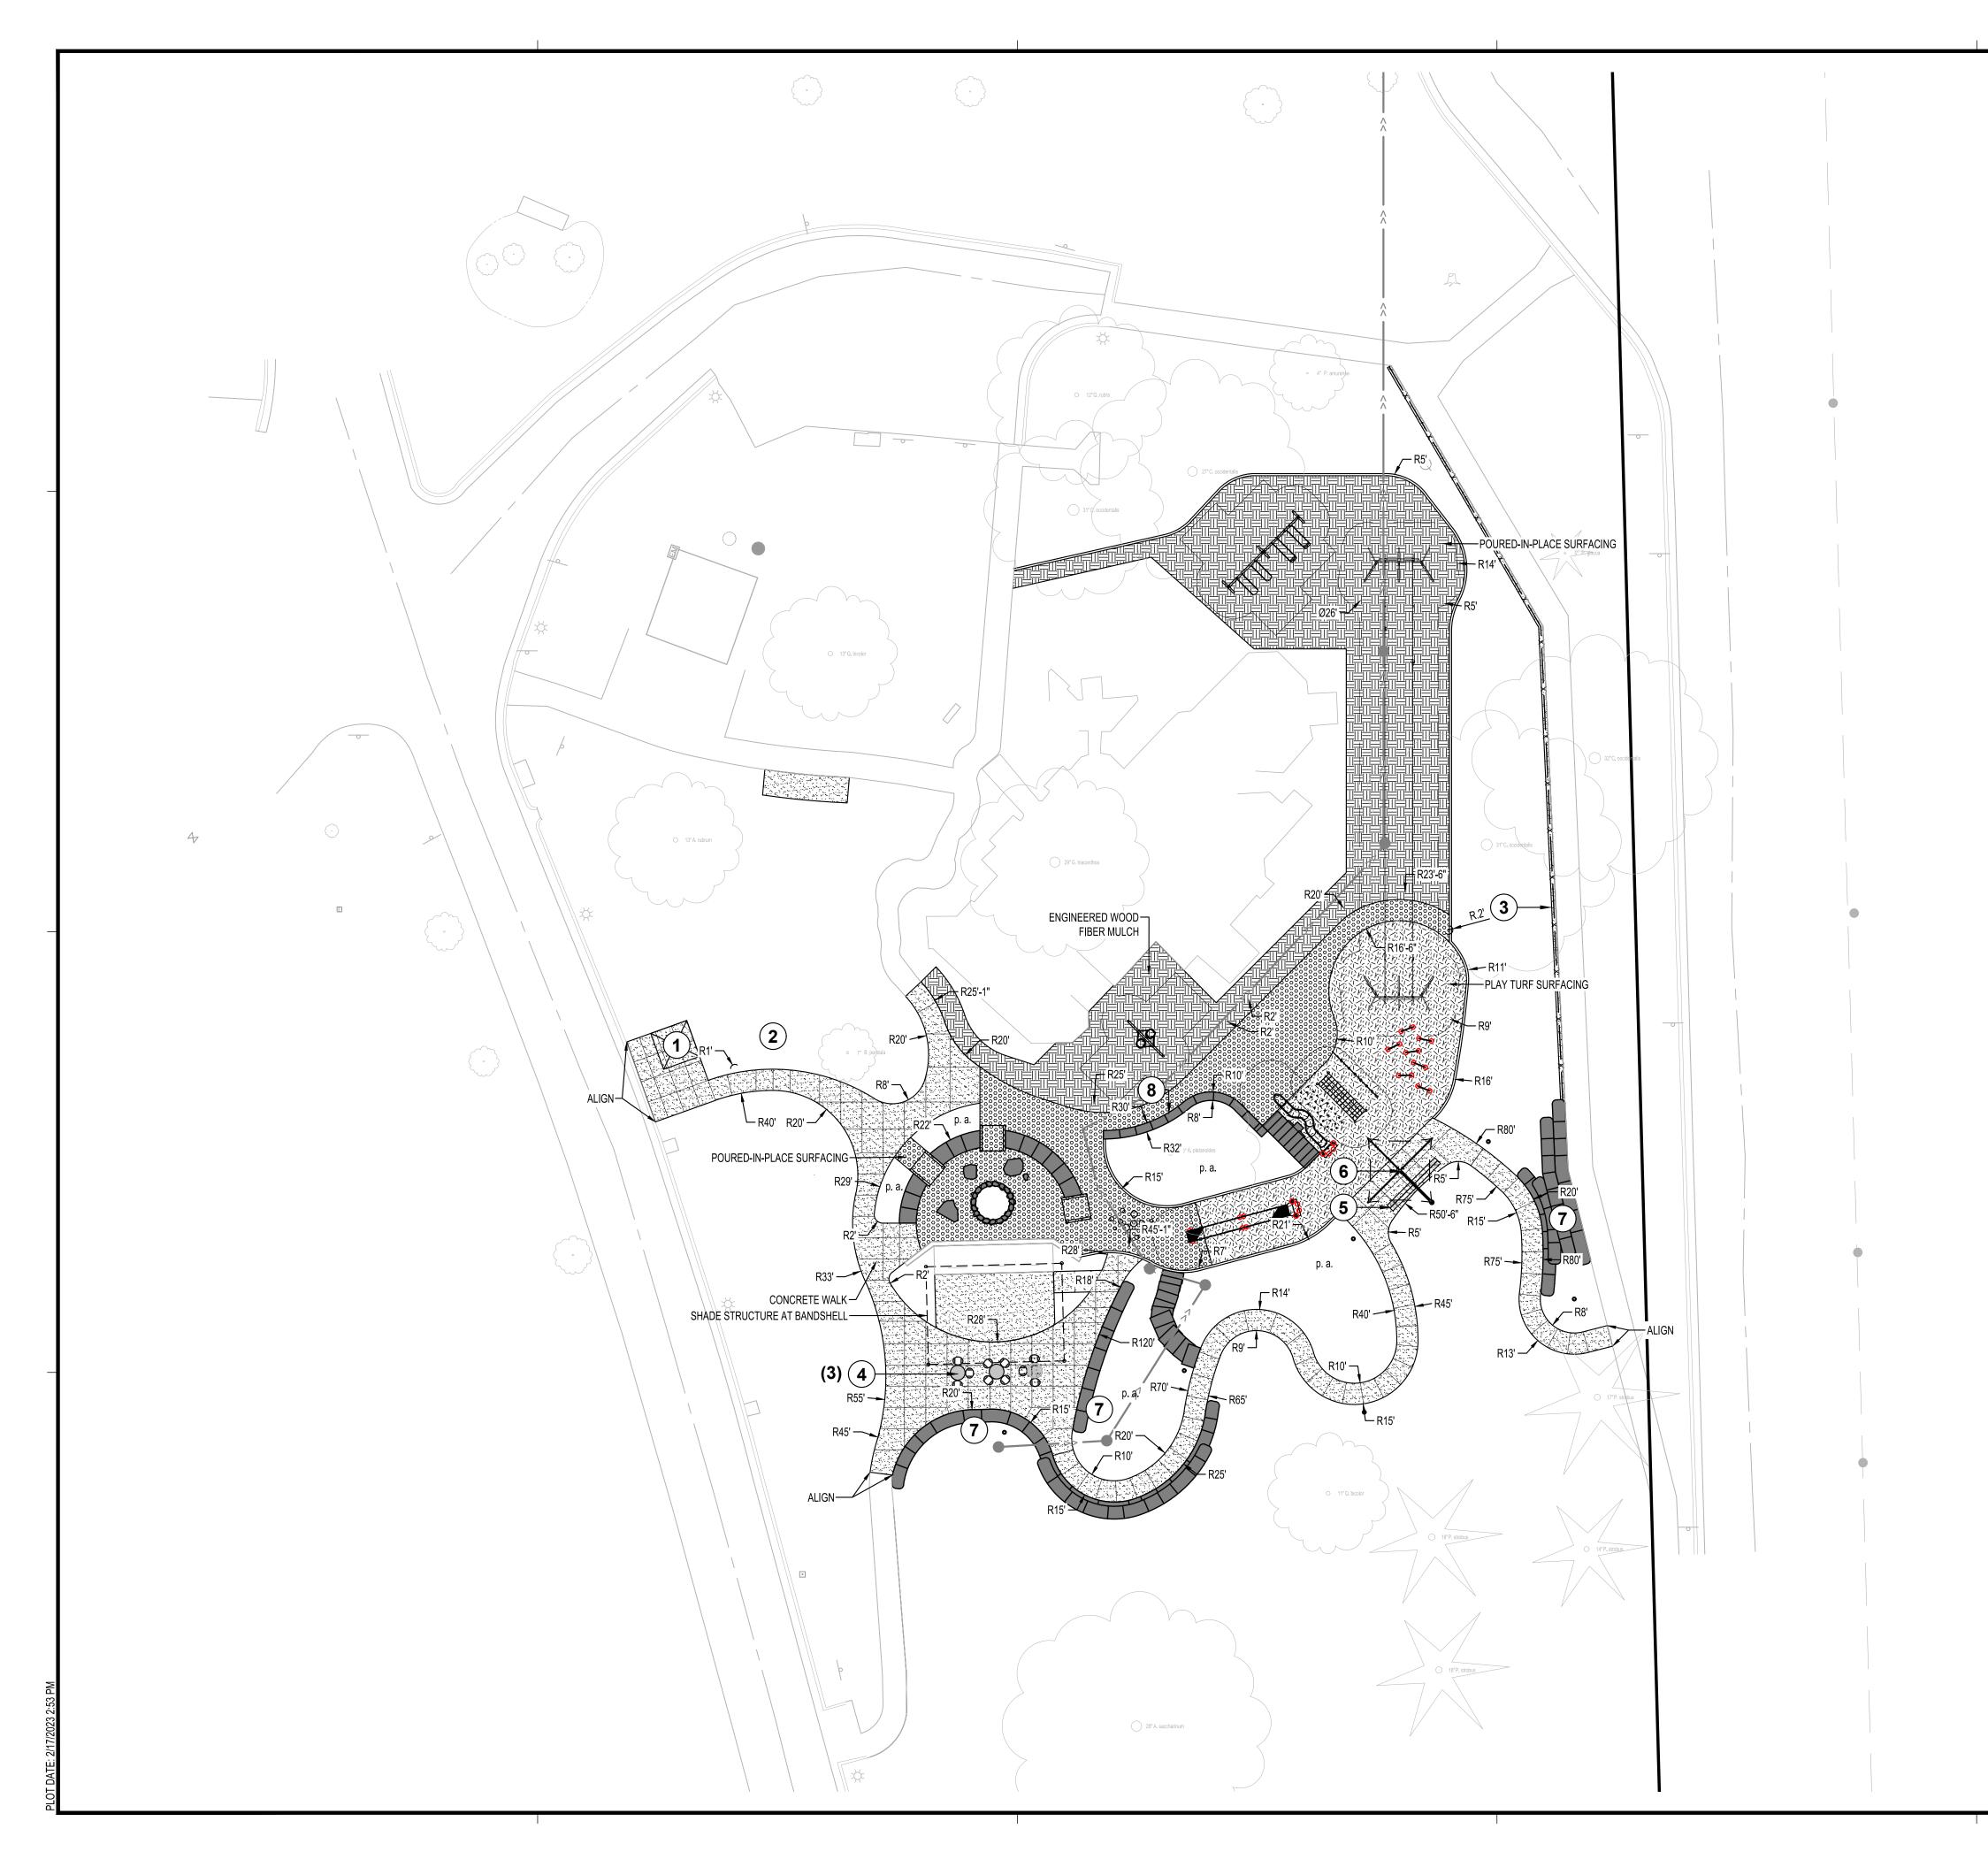



PAVEMENT LEGEND		
SYMBOL	DESCRIPTION	
	CONCRETE WALK	
	ENGINEERED WOOD FIBER MULCH	
	POURED-IN-PLACE SURFACING	

PLAY TURF SURFACING





THIS DOCUMENT IS THE PROPERTY OF I & S GROUP, INC. AND MAY NOT BE USED, COPIED OR DUPLICATED WITHOUT PRIOR WRITTEN CONSENT.

PRELIMINARY NOT

CTION

PRELIMINARY

PROJECT


CITY OF LA CROSSE MYRICK PARK **PLAYGROUND** PHASE 2

WISCONSIN LA CROSSE REVISION SCHEDULE DATE DESCRIPTION

22-28015 PROJECT NO. FILE NAME DRAWN BY DESIGNED BY REVIEWED BY ORIGINAL ISSUE DATE 02/02/23 CLIENT PROJECT NO.

SITE PLAN

C3-10

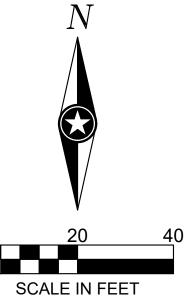

	O 12'O.ndra
O 13°O. bicolar	31°C coolertula  H  D  D  Regimus
4 O 15'A nárum	32°C, oxide Califa  31°C, oxide Califa  31°C, oxide Califa
	29° G. triacarithos
o 7 B. polytula	D C C A Distinction A
5	
	O 11'O bicolor
	18°P. strobus
PLOT DATE: 2/17/2023 2:53 PM	O 18°P, strokus

<b>KEY</b>	DESCRIPTION	MFR	MODEL
A	SLIDEWINDER2 SLIDE	LSI	CP024417
<b>B</b>	ROLLERSLIDE	LSI	CP002724
<u>c</u>	ROPE PULL CLIMBER	LSI	CP002725
<b>D</b>	HILL LOOP (SET)	LSI	CP001153
E	HILL NET CLIMBER	LSI	CP019684
F	DOUBLE ZIP-LINE	KOMPAN	M88101-3817
G	POURED-IN-PLACE MOUNDS		
H	5" ARCH SWING	LSI	221292
	5" ARCH SWING ADDITIONAL BAY	LSI	221293
J	FRIENDSHIP SWING, SINGLE POST	LSI	237296
$\overline{\mathbf{K}}$	TRI-HANDHOLD	LSI	CP007148





PRELIMINARY NOT FOR CONSTRUCTION THIS DOCUMENT IS THE PROPERTY OF I & S GROUP, INC. AND MAY NOT BE USED, COPIED OR DUPLICATED WITHOUT PRIOR WRITTEN CONSENT.

PROJECT

## CITY OF LA CROSSE MYRICK PARK **PLAYGROUND** PHASE 2

CITY OF LA CROSSE MYRICK PARK PLAYGROUND PHASE 2 LA CROSSE WISCONSIN					
	REVISION SCHEDULE				
DATE	DESCRIPTION BY	FOR CONSTRUCT			
PROJECT N FILE NAME DRAWN BY DESIGNED	28015 C3-SITE GBV	LON			

REVIEWED BY

ORIGINAL ISSUE DATE 02/02/23

CLIENT PROJECT NO. -

## | PLAY EQUIPMENT | **PLAN**


**PRELIMINARY** 

0 ##

SCALE IN FEET

C3-20



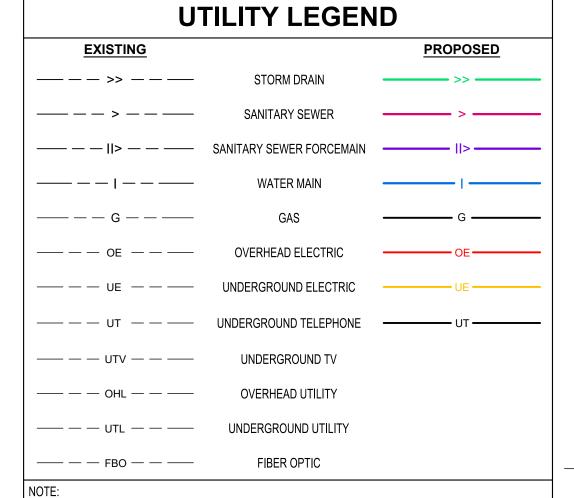





**PRELIMINARY** 

PROJECT

## CITY OF LA CROSSE MYRICK PARK **PLAYGROUND** PHASE 2

REVISION SCHEDULE DESCRIPTION


WISCONSIN LA CROSSE


ROJECT NO.	22-28015	
PROJECT NO.	22-28015 28015 C3-SITE	
ILE NAME	28015 C3-SITE	
ILE NAME PRAWN BY	28015 C3-SITE GBV	
ILE NAME PRAWN BY PESIGNED BY	28015 C3-SITE  GBV  KLJ  PCN	

**UTILITY PLAN** 

SCALE IN FEET

C3-30

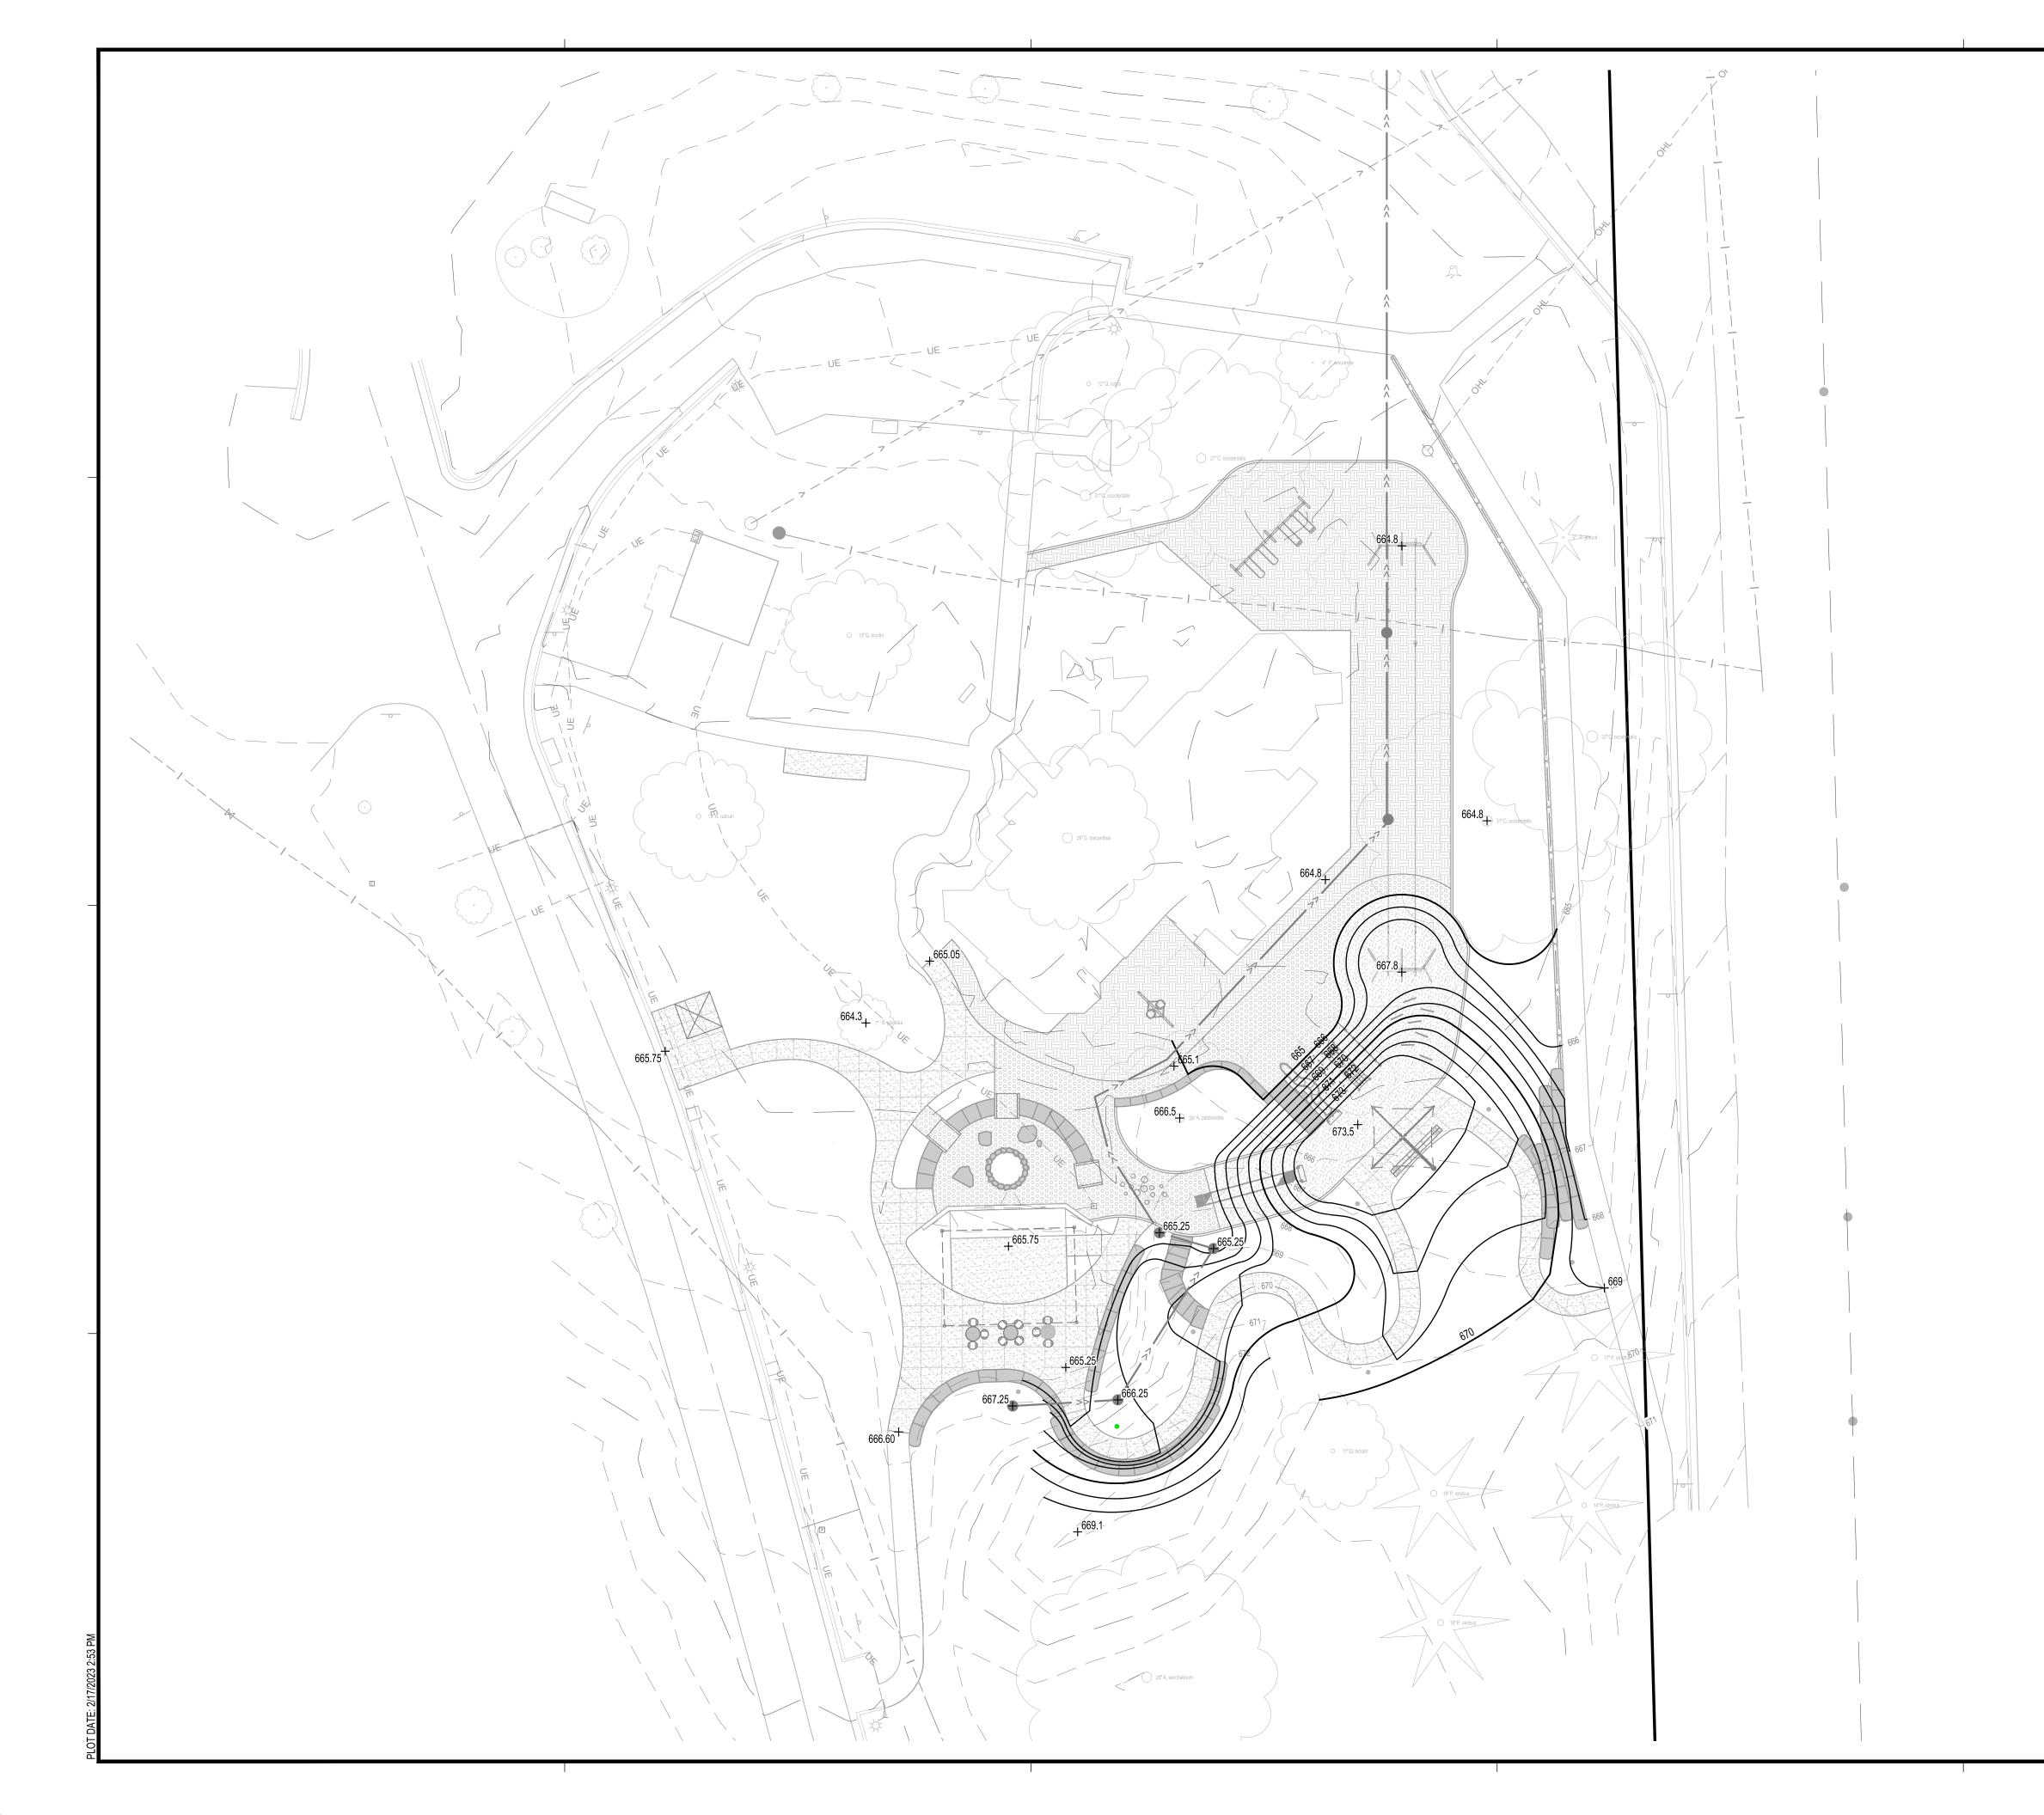

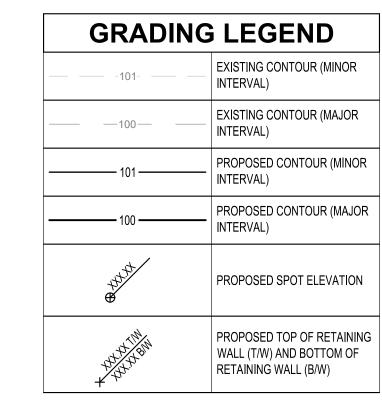





PRELIMINARY NOT

CTION

PROJECT

# CITY OF LA CROSSE MYRICK PARK PLAYGROUND PHASE 2

REVISION SCHEDULE

DATE DESCRIPTION BY

PROJECT NO. 22-28015

FILE NAME 28015 C4-GRADE

DRAWN BY GBV

TITLE

DESIGNED BY REVIEWED BY

ORIGINAL ISSUE DATE 02/02/23

CLIENT PROJECT NO.

**GRADING PLAN** 

CCT

SCALE IN FEET

C4-10



		PLA	NT SCHEDULE		
OVERSTORY TREES	CODE	QTY	BOTANICAL / COMMON NAME	SIZE	RO
$\bigcirc$	AK	3	ACER RUBRUM 'KARPICK' KARPICK RED MAPLE	4" - 6" CAL	В &
$\overline{}$	GI	2	GLEDITSIA TRIACANTHOS INERMIS 'SKYCOLE' SKYLINE® HONEY LOCUST	4" - 6" CAL	В &
\(\frac{1}{2}\)	QA	2	QUERCUS ALBA WHITE OAK	4" - 6" CAL	В&
UNDERSTORY TREES	CODE	QTY	BOTANICAL / COMMON NAME	SIZE	RO
$\overline{}$	AG	4	AMELANCHIER CANADENSIS 'GLENNFORM' RAINBOW PILLAR® CANADIAN SERVICEBERRY	1.5" CAL	В &
DECIDUOUS SHRUBS	CODE	QTY	BOTANICAL / COMMON NAME	SIZE	RO
6 6 6 6 6 6 6 6 6 6 6 6 6 6 6 6 6 6 6	CA	12	CEANOTHUS AMERICANUS NEW JERSEY TEA	1 GAL	СО
$\odot$	CF	6	CORNUS SERICEA 'FARROW' TM ARCTIC FIRE RED TWIG DOGWOOD	1 GAL	СО
$\odot$	PD	6	PHYSOCARPUS OPULIFOLIUS 'SMNPOTWG' TM TINY WINE GOLD NINEBARK	1 GAL	СО
SUNDIVINITY OF THE STATE OF THE	RG	38	RHUS AROMATICA 'GRO-LOW' GRO-LOW FRAGRANT SUMAC	1 GAL	СО
$\odot$	SP	6	SYRINGA X 'PENDA' BLOOMERANG® PURPLE LILAC	1 GAL	СО
$\langle \hat{\cdot} \rangle$	vc	7	VIBURNUM CARLESII KOREANSPICE VIBURNUM	1 GAL	СО
PERENNIALS	CODE	QTY	BOTANICAL / COMMON NAME	SIZE	RO
	AM	17	ALLIUM X 'ALLMIG1' MILLENIUM ORNAMENTAL ONION	1 GAL	СО
Synthetic	ST	29	SPOROBOLUS HETEROLEPIS 'TARA' TARA PRAIRIE DROPSEED	1 GAL	СО
GROUND COVERS	CODE	QTY	BOTANICAL / COMMON NAME		
		1,868 SF	NATIVE SEED MIX GRASSES, SEDGES AND FORBS		
	PPA	17	PERENNIAL PLANTING AREA #1 GALLON PERENNIALS AT 18" OC		
*	TGM	2,197 SF	TURF SEED LOW GROW MIX FINE FESCUE BLEND		
MULCH	CODE	QTY	BOTANICAL / COMMON NAME		
	RM	371 SF	DOUBLE SHREDDED WOOD MULCH (NATURAL COLOR)		

### **NATIVE SEED MIX**

SEEDING RATE: 7.31 LBS PER ACRE, 117 SEEDS PER SQUARE FOOT. FOLLOWING PERCENTAGES LISTED BY WEIGHT OF PURE LIVE SEED:

ALLIUM CERNUUM (NODDING ONION): 2.56% BOUTELOUA CURTIPENDULA (SIDE-OATS GRAMA): 15.38% BROMUS KALMII (PRAIRIE BROME): 13.68% CAREX BREVIOR (PLAINS OVAL SEDGE): 6.84% CAREX GRAYI (COMMON BUR SEDGE): 2.56% CAREX VULPINOIDEA (BROWN FOX SEDGE): 5.13% CHAMAECRISTA FASCICULATA (PARTRIDGE PEA): 6.84% DALEA PURPUREA (PURPLE PRAIRIE CLOVER): 2.56% JUNCUS EFFUSUS (COMMON RUSH): 1.71% PENSTEMON HIRSUTUS (HAIRY BEARDTONGUE): 1.71% SCHIZACHYRIUM SCOPARIUM (LITTLE BLUESTEM): 41.03%





THIS DOCUMENT IS THE PROPERTY OF I & S GROUP, INC. AND MAY NOT BE USED, COPIED OR DUPLICATED WITHOUT PRIOR WRITTEN CONSENT.

**PRELIMINARY** 

PROJECT

## CITY OF LA CROSSE **MYRICK PARK PLAYGROUND** PHASE 2


LA CROSSE WISCONSIN REVISION SCHEDULE DATE DESCRIPTION

22-28015 PROJECT NO. FILE NAME 28015 C5-LAND DRAWN BY DESIGNED BY REVIEWED BY ORIGINAL ISSUE DATE 02/02/23 CLIENT PROJECT NO.

## **PLANTING PLAN**

SCALE IN FEET

C5-10

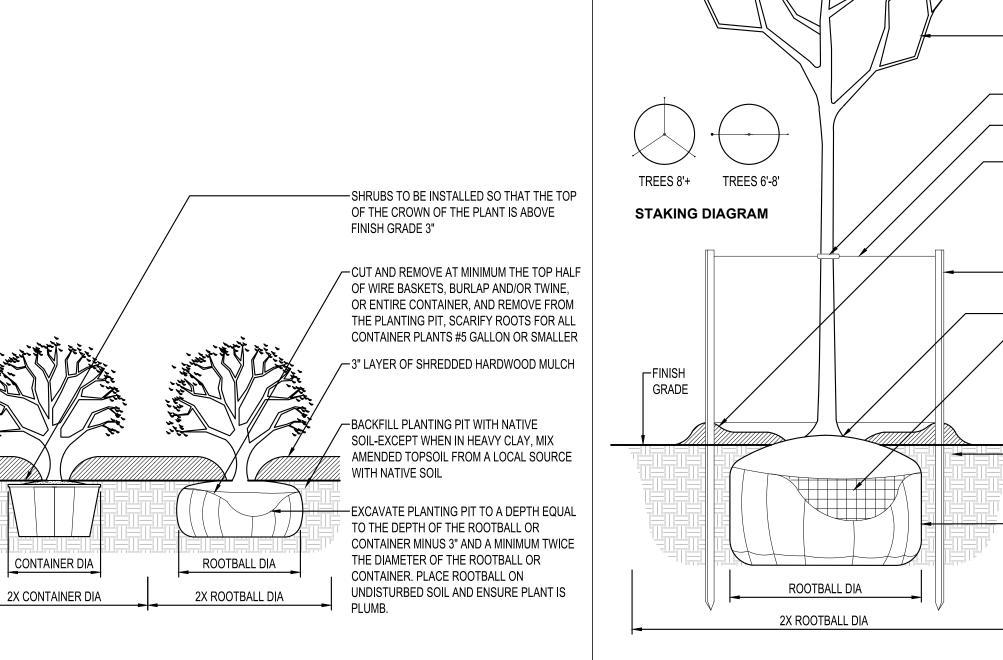

DECIDUOUS TREE PLANTING

-DO NOT CUT PRIMARY LEADER. ALL TREES

-PRUNE ALL BROKEN, DAMAGED, OR RUBBING

LIMBS AND BRANCHES IMMEDIATELY AFTER

PLANTING - ALL PRUNING CUTS CLEAN AT 90°

TIE NYLON STRAP AROUND TRUNK AS SHOWN

-1/2" WIDE NYLON STRAPPING - GREEN OR

-3" LAYER OF SHREDDED HARDWOOD MULCH

MOUNDED AT EDGE TO FORM A SHALLOW

SAUCER - DO NOT PLACE MULCH DIRECTLY

-HARDWOOD STAKES 2"X2"X8' LONG - INSTALL

- SET ROOT FLARE 3" ABOVE FINISH GRADE

-CUT AND REMOVE AT MINIMUM THE TOP HALF

AND REMOVE FROM THE PLANTING PIT. AVOID

OF WIRE BASKETS, BURLAP AND/OR TWINE

CUTTING OR SCARING ROOTS. ANY ROOTS

THAT ARE SCARED OR BROKEN DURING

PLANTING SHALL BE PRUNED 90°

ROOTBALL. PLACE ROOTBALL ON

WITH NATIVE SOIL

TREE IS PLUMB

-BACKFILL PLANTING PIT WITH NATIVE

SOIL-EXCEPT WHEN IN HEAVY CLAY, MIX

AMENDED TOPSOIL FROM A LOCAL SOURCE

-EXCAVATE PLANTING PIT TO A DEPTH EQUAL

TO THE DEPTH OF THE ROOTBALL MINUS 3"

AND A MINIMUM TWICE THE DIAMETER OF THE

UNDISTURBED SOIL AND ENSURE TRUNK OF

ON TREE TRUNK, LEAVE A MIN. 3" RING

OUTSIDE OF ROOTBALL AT 5' MAX HT

SHALL HAVE A STRONG (CENTRAL)

DOMINATE LEADER

BROWN COLOR

AROUND CROWN

#### **PLANTING NOTES**

SURROUNDING TREES.

- COORDINATE LOCATION OF ALL UTILITIES (LINES, DUCTS, CONDUITS, SLEEVES, FOOTINGS, ETC.) WITH LOCATIONS OF PROPOSED LANDSCAPE ELEMENTS (FENCE, FOOTINGS, TREE ROOTBALLS, ETC.). CONTRACTOR SHALL REPORT ANY
- DISCREPANCIES TO OWNER'S REPRESENTATIVE PRIOR TO CONTINUING WORK. SAVE AND PROTECT ALL EXISTING TREES NOT NOTED TO BE REMOVED.
- REMOVE ALL CONSTRUCTION DEBRIS AND MATERIALS INJURIOUS TO PLANT GROWTH FROM PLANTING PITS AND BEDS PRIOR TO BACKFILLING WITH PLANTING MIX. REFER TO PLANTING DETAILS FOR AMENDED SOIL DEPTH IN PLANTING BEDS AND
- 5. FIELD STAKE PLANTINGS ACCORDING TO PLAN. OWNER'S REPRESENTATIVE SHALL APPROVE ALL PLANT LOCATIONS PRIOR TO INSTALLATION. OWNER'S REPRESENTATIVE RESERVES THE RIGHT TO REVISE PLANTING LAYOUT AT TIME OF INSTALLATION.
- ALL PLANT MATERIALS SHALL BE TRUE TO THEIR SCIENTIFIC NAME AND SIZE AS INDICATED IN THE PLANT SCHEDULE.
- 7. IF DISCREPANCIES EXIST BETWEEN THE NUMBER OF PLANTS DRAWN ON THE PLANTING PLAN AND THE NUMBER OF PLANTS IN THE SCHEDULE, THE PLANTING PLAN
- ANY PROPOSED SUBSTITUTIONS OF PLANT SPECIES SHALL BE MADE WITH PLANTS OF EQUIVALENT OVERALL FORM, HEIGHT, BRANCHING HABIT, FLOWER, LEAF, COLOR, FRUIT AND CULTURE, AND ONLY AFTER WRITTEN APPROVAL OF THE OWNER'S REPRESENTATIVE.
- STOCK (ANSI Z60.1), LATEST EDITION PUBLISHED BY THE AMERICAN ASSOCIATION OF NURSERYMEN, WASHINGTON D.C. LARGER SIZED PLANT MATERIALS OF THE SPECIES LISTED MAY BE USED IF THE STOCK CONFORMS TO ANSI Z60.1. 10. ALL PLANT MATERIAL SHALL BE GUARANTEED BY THE CONTRACTOR TO BE IN A LIVE

ALL PLANT MATERIALS MUST CONFORM TO AMERICAN STANDARDS FOR NURSERY

- AND HEALTHY GROWING CONDITION FOR ONE FULL GROWING SEASON (ONE YEAR) AFTER FINAL PROJECT ACCEPTANCE OR SHALL BE REPLACED BY THE CONTRACTOR FREE OF CHARGE WITH THE SAME GRADE AND SPECIES.
- 11. ALL TREES SHALL HAVE A STRONG CENTRAL LEADER. ANY TREES DEEMED NOT TO HAVE A STRONG CENTRAL LEADER SHALL BE REJECTED.
- 12. CONTRACTOR IS RESPONSIBLE FOR ALL DAMAGE DUE TO CONSTRUCTION OPERATIONS. ANY AREAS THAT ARE DISTURBED SHALL BE RESTORED TO ITS ORIGINAL CONDITION AT NO ADDITIONAL COST TO THE OWNER.
- 13. PROVIDE SHREDDED HARDWOOD MULCH SURROUNDING ALL PROPOSED TREES (5' Ø) AND WITHIN PLANTING BEDS TO A 3" MINIMUM DEPTH AS SHOWN IN TREE PLANTING DETAIL. DO NOT USE AN UNDERLAYMENT SUCH AS PLASTIC SHEET OR LANDSCAPE FABRIC. APPLY PRE-EMERGENT TO ALL PLANTING BEDS PRIOR TO MULCHING. REFER TO PLANS FOR ADDITIONAL DETAILS. REFER TO STORMWATER DETAILS FOR BASIN CONSTRUCTION AND MULCH APPLICATION.
- 14. MULCHING MATERIAL SHALL BE SHREDDED HARDWOOD MULCH, WITH NO INDIVIDUAL PIECES LARGER THAN 3", FREE OF GROWTH OR GERMINATION INHIBITING INGREDIENTS, 3" MINIMUM DEPTH. MINIMUM DEPTHS AT LOCATIONS INDICATED ON
- 15. CONTRACTOR SHALL PROVIDE SAMPLE OF MULCH TO BE APPROVED BY THE LANDSCAPE ARCHITECT.
- 16. INDICATED QUANTITIES ARE ESTIMATES AND SHALL BE CONFIRMED BY THE CONTRACTOR.
- 17. ADJUST SPACING OF PLANT MATERIALS AROUND ADJACENT UTILITY STRUCTURES.

6' ORANGE CONSTRUCTION FENCE

-POSTS - 8' U-CHANNEL PAINTED OR GALVANIZED

CUT STRAIGHT WITH A SHARP BLADE. ROOT CUTTING

METHOD MUST BE REVIEWED AND APPROVED PRIOR TO





THIS DOCUMENT IS THE PROPERTY OF I & S GROUP, INC. AND MAY NOT BE USED, COPIED OR DUPLICATED WITHOUT PRIOR WRITTEN CONSENT.

PROJECT

### CITY OF LA CROSSE **MYRICK PARK PLAYGROUND** PHASE 2

LA CROSSE

	112110	ONCONEDULE	
DATE	С	ESCRIPTION	BY
PROJECT NO.		22-28015	
ILE NAME		28015 C5-LAND	
RAWN BY		GBV	
ESIGNED BY		KLJ	
REVIEWED BY		PCN	
BICINAI	ISSUE DATE	02/02/23	

TITLE

CLIENT PROJECT NO.

**PLANTING DETAILS** 

**C5-20** 

-PRUNE ALL BROKEN, DAMAGED, OR RUBBING LIMBS AND BRANCHES IMMEDIATELY AFTER -INSTALL PLANTS PER PLANS AND PLANT LIST PLANTING - ALL PRUNING CUTS CLEAN AT 90° -DO NOT CUT PRIMARY LEADERS - 3 LARGEST DIAMETER STEMS LAYOUT FOR BOTH TRIANGULAR AND LINEAR -3" LAYER OF SHREDDED HARDWOOD MULCH MOUNDED AT EDGE TO FORM A SHALLOW AROUND CROWN . DO NOT STAKE TREES 2. THOROUGHLY WATER-IN ALL TREES IMMEDIATELY AFTER PLANTING AND ENSURE NO UNDESIRABLE SETTLING OCCURS - TREE STAYS PLUMB -FINISH GRADE WITH NATIVE SOIL ROOTBALL DIA

SAUCER - DO NOT PLACE MULCH DIRECTLY ON TREE TRUNK, LEAVE A MINIMUM 3" RING -SET ROOT FLARE 3" ABOVE FINISH GRADE -CUT AND REMOVE AT MINIMUM THE TOP HALF OF WIRE BASKETS, BURLAP AND/OR TWINE AND REMOVE FROM THE PLANTING PIT. AVOID CUTTING OR SCARING ROOTS. ANY ROOTS THAT ARE SCARED OR BROKEN DURING PLANTING SHALL BE PRUNED AT 90° -BACKFILL PLANTING PIT WITH NATIVE SOIL-EXCEPT WHEN IN HEAVY CLAY, MIX AMENDED TOPSOIL FROM A LOCAL SOURCE -EXCAVATE PLANTING PIT TO A DEPTH EQUAL TO THE DEPTH OF THE ROOTBALL MINUS 3" AND A MINIMUM TWICE THE DIAMETER OF THE ROOTBALL. PLACE ROOTBALL ON UNDISTURBED SOIL AND ENSURE TRUNK OF 2X ROOTBALL DIA TREE IS PLUMB

PERENNIAL PLANTING

6' MIN -INSTALL FENCE 6' MIN OUTSIDE TREE DRIP LINE OR AS INDICATED ON PLAN COORDINATE CONSTRUCTION OPERATIONS AND EFFORTS TO MINIMIZE THE DISTURBANCE OF THE TREE CANOPY. ELIMINATE INSTANCES WHEN EQUIPMENT OPERATES WITHIN CLOSE PROXIMITY IN WHICH TURNING AND SWINGING MOVEMENTS OF EQUIPMENT COULD POTENTIALLY HARM THE TREE CANOPY. IF THE **PLAN** TREE CANOPY OR ROOT SYSTEM IS DAMAGED DURING CONSTRUCTION OPERATIONS INFORM THE OWNERS REPRESENTATIVE. IF THE DAMAGE TO THE TREE IS DETERMINED SIGNIFICANT, TREE WILL NOT SURVIVE, THE CONTRACTOR WILL REPLACE THE DAMAGED TREE IN COORDINATION WITH OWNER'S REPRESENTATIVE AND WILL BE INCIDENTAL TO THE CONTRACT. IF ROOT CUTTING/PRUNING IS REQUIRED THE ROOTS MUST BE

CRITICAL ROOT ZONE

CUTTING AS WELL AS THE INITIAL CUTTING BE OBSERVED BY THE OWNERS REPRESENTATIVE. GIVEN THE HEALTH AND MATURITY OF THE EXISTING TREES ON SITE PROTECTION IS A TOP PRIORITY AND ENFORCEMENT OF TREE PROTECTION MEASURES WILL BE STRICTLY → DRIPLINE -EXISTING GRADE

→EXISTING TREE

**SECTION** 

TREE PROTECTION FENCING

**SECTION** 

FINISH GRADE

⊢EDGE OF BED

SHRUB PLANTING

½ SPECIFIED

PLANT SPACING

-EDGE OF PLANTING BED / GROUND COVER AREA

PLANTING SCHEMES

-PERENNIALS TO BE INSTALLED SO THAT THE TOP OF THE CROWN OF THE PLANT IS SLIGHTLY ABOVE FINISH GRADE

SPACING - ALL PLANTS SHALL BE EQUALLY


SPACED TO ACHIEVE A SYMMETRICAL

—3" LAYER OF SHREDDED HARDWOOD MULCH -CUT AND REMOVE THE ENTIRE CONTAINER AND SCARIFY, AS NECESSARY, ROOTS FOR ALL CONTAINERIZED PLANTS #5 GALLONS OR SMALLER

-TILL ALL PLANT BEDS TO A MINIMUM DEPTH OF 6" AND BACKFILL PER SPECIFICATIONS, WHEN PROVIDED - IN AREAS WITH HEAVY CLAY OR ROCKY SOILS AMEND WITH AMENDED PLANTING SOIL FROM A LOCAL SOURCE. PLACE CONTAINER ON UNDISTURBED SOIL AND

ENSURE PLANT IS PLUMB

MULTI-STEM TREE PLANTING

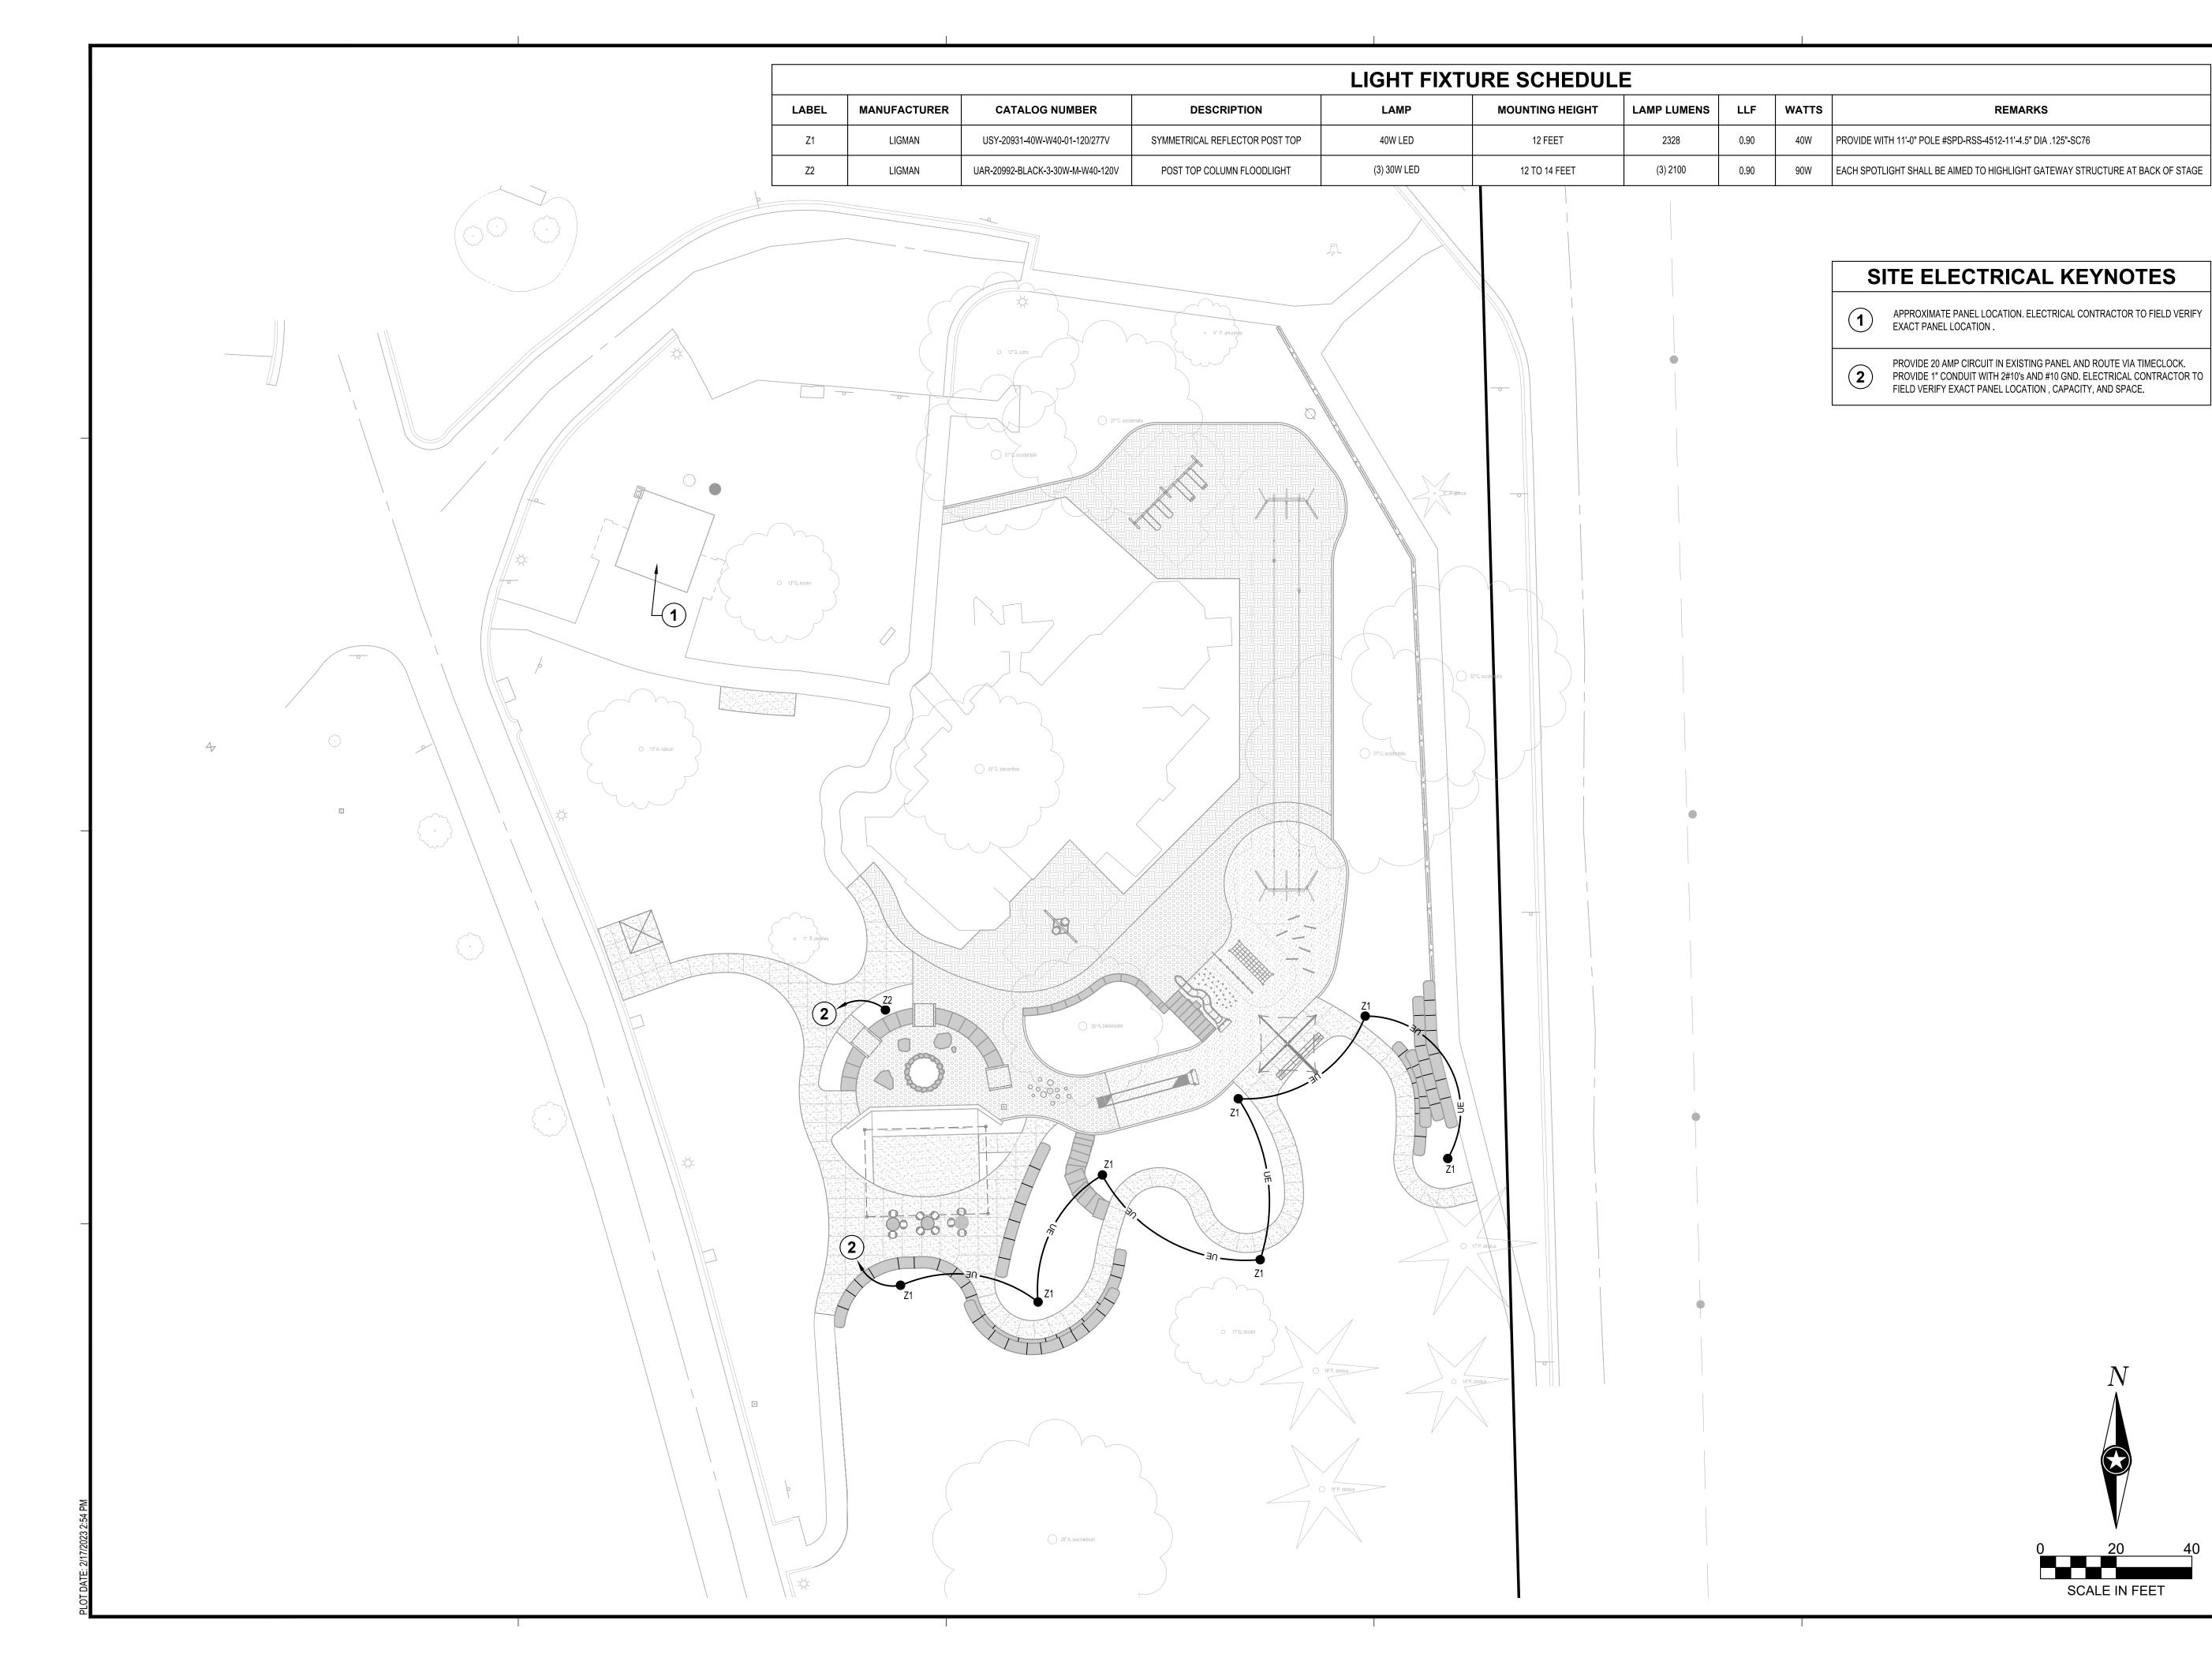





**PRELIMINARY** 

PRELIMINARY

PROJECT

# CITY OF LA CROSSE MYRICK PARK PLAYGROUND PHASE 2

LA CROSSE WISCONSIN

REVISION SCHEDULE						
DATE		DESCRIPTION	BY			
PROJECT NO.		22-28015				
FILE NAME		28015 E2-ELECTRIC	AL			

FILE NAME 28015 E2-ELECTRICAL

DRAWN BY GBV

DESIGNED BY KLJ

REVIEWED BY PCN

ORIGINAL ISSUE DATE 02/02/23

CLIENT PROJECT NO. -

TITLE

## SITE ELECTRICAL PLAN

ICCT

**E2-10** 

	LIGHT FIXTURE SCHEDULE							
LABEL	MANUFACTURER	CATALOG NUMBER	DESCRIPTION	LAMP	MOUNTING HEIGHT	LAMP LUMENS	LLF	WATTS REMARKS
Z1	LIGMAN	USY-20931-40W-W40-01-120/277V	SYMMETRICAL REFLECTOR POST TOP	40W LED	12 FEET	2328	0.90	40W PROVIDE WITH 11'-0" POLE #SPD-RSS-4512-11'-4.5" DIA .125"-SC76
Z2	LIGMAN	UAR-20992-BLACK-3-30W-M-W40-120V	POST TOP COLUMN FLOODLIGHT	(3) 30W LED	12 TO 14 FEET	(3) 2100	0.90	90W EACH SPOTLIGHT SHALL BE AIMED TO HIGHLIGHT GATEWAY STRUCTURE AT BACK OF ST





THIS DOCUMENT IS THE PROPERTY OF I & S GROUP, INC. AND MAY NOT BE USED, COPIED OR DUPLICATED

PROJECT

### CITY OF LA CROSSE **MYRICK PARK PLAYGROUND** PHASE 2

WISCONSIN LA CROSSE REVISION SCHEDULE DESCRIPTION

PROJECT NO.	22-28015	
FILE NAME	28015 E2-ELECTRICAL	
DRAWN BY	GBV	
DESIGNED BY	KLJ	
REVIEWED BY	PCN	
ORIGINAL ISSUE DATE	02/02/23	
CLIENT PROJECT NO.	-	

SITE LIGHTING **PHOTOMETRIC PLAN** 

RELIMINA

**E2-01** 



t.0 t.0

 $\frac{1}{2}$ 

 $\$  to  $\$  to

\ b.o \ b.o

FOOTCANDLE LEGEND

NOTE: SEE ELECTRICAL PLAN FOR SITE ELECTRICAL LAYOUT

SCALE IN FEET





S

ZO

**LON** 

ELIMINARY

NOIL

**PRELIMINA** 

THIS DOCUMENT IS THE PROPERTY OF I & S GROUP, INC. AND MAY NOT BE USED, COPIED OR DUPLICATED WITHOUT PRIOR WRITTEN CONSENT.

PROJECT

### CITY OF LA CROSSE **MYRICK PARK PLAYGROUND** PHASE 2

WISCONSIN

LA CROSSE **REVISION SCHEDULE** DESCRIPTION

22-28015 PROJECT NO. FILE NAME 28015 E2-ELECTRICAL DRAWN BY **DESIGNED BY** REVIEWED BY ORIGINAL ISSUE DATE 02/02/23 CLIENT PROJECT NO.

### **MANUFACTURER CATALOGUE PAGES**

**E2-02** 

