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City of La Crosse, Wisconsin

City Hall 400 La Crosse Street La Crosse, WI 54601

Meeting Agenda

Commercial/Multi-Family Design Review Committee

Friday, October 4, 2024 9:00 AM Virtual via Zoom

The meeting is conducted through video conferencing.

Members of the public will be able to attend the meeting via video conferencing with the link below.

Join Zoom Meeting

Click this link (or typing the URL in your web browser address bar): https://cityoflacrosse-org.zoom.us/j/82799188943?pwd=pAMS3MbJusyBqR9mjCiK3jH6cAP0rk.1

Meeting ID: 827 9918 8943

Passcode: 212646

Dial by your location 1 312 626 6799

If you wish to speak please provide written comments by emailing acklint@cityoflacrosse.org, using a drop box outside of City Hall or mailing the Department of Planning, Development, and Assessment at 400 La Crosse St, WI 54601.

Call to Order

Agenda Items:

1. <u>24-1316</u> Review of plans for the building addition located at 1331 Clinton Street. (Boys and Girls Club)

Attachments: Preliminary Plans 10-4-24

24-1317 Review of plans for the mixed-use development located at 1513 Market Street.

Attachments: Preliminary Plans 10-4-24

Adjournment

Notice is further given that members of other governmental bodies may be present at the above scheduled meeting to gather information about a subject over which they have decision-making responsibility.

NOTICE TO PERSONS WITH A DISABILITY

Requests from persons with a disability who need assistance to participate in this meeting should call the City Clerk's office at (608) 789-7510 or send an email to ADAcityclerk@cityoflacrosse.org, with as much advance notice as possible.



City of La Crosse, Wisconsin

City Hall 400 La Crosse Street La Crosse, WI 54601

Text File

File Number: 24-1316

Agenda Date: Version: 1 Status: Agenda Ready

In Control: Commercial/Multi-Family Design Review Committee File Type: Review of Plans

Agenda Number: 1.

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2	Name:	В

COMMERCIAL DEVELOPMENT DESIGN STANDARDS APPLICATION Permit No.:

Data.		
Date:		

	Planning Department • Phone 608. http://www.cityoflacrossse.org	789.7512 · Fax 608 78 Planning@cityoflad	II 12t0:
ISC	STATUS:		Parcel No.:
OWNER	Name: Boys & Girls Clubs of Greater La Crosse Inc - Address: 1331 Clinton Street City: La Crosse Phone: 608-881-7789 Cell:	Contact: Brian Fukuda	E-mail: brian.fukuda@bgclax.org
ARCHITECT CONTRACTOR	Name: Vantage Architects Address: 750 N. Third Street, Suite F City: La Crosse	Ir	E waile in @vanta googshita eta oom
	Phone: 608-784-2729 Cell: Check One:	Fax: Alteration/Remodel	E-mail: jw@vantagearchitects.com
PROJECT	Description of Work: New Life & Workforce Readiness Center Addition to east side of the property. The 2-Story addition is app parking lot on the east which encompasses sharing parking finishes on the new addition will match/comp	roximately 16,000 SF. Site property with the school dis	e work will include a new strict, refer to site plan.
	Pre-application Meeting Date:		
	Applying for Exception: No Yes	(Include \$300 Check for Pub	olic Notification)
PROPERTY	Project Address: 1331 Clinton Street Zoning District: PS - Public & Semi Public Address: 1331 Clinton Street City: La Crosse State: \(\)		roperty owner's address: Zip Code: 54603
	Date Received: Review		
CIAL	Exception Check:		
OFFI USE (Required Information: Site Plan Architecture Pl		☐Building Elevations & Materia Photos
of (7) cep	e applicant agrees that all design aspects and main Section 15.47 of the Code of Ordinances for the Cosets of required information must be submitted to otance. RINT) Architect/Engineer Name	ity of La Crosse. Applic	cation, the checklist, and seven
Sig	gnature (Architect/Engineer) Date	Signature (Owner)	Date



September 25, 2024

City of La Crosse Planning Department

Re: Preliminary Commercial Development Standards review - Boys and Girls Club Work Force Readiness Center

We have designed the site plan and associated green space, hard surface, parking, building access, fire lanes, ADA access, storm water management, and storm water BMPs in accordance with City ordinance requirements AS IF THE BGC OWNED ALL OF THE LAND BEING DEVELOPED. They do not. The project is being supported by the La Crosse School District and the District owns a significant portion of the land being used for parking, access, and storm water BMPs. The District parcel will have a recycle, refuse, and storage area that will be for the support of the BGC facility as well.

We understand that this probably complicates how this project will fit in to the typical project mold and there may be zoning issues as well. The District has provided verbal assurances that the District will work with and cooperate in providing necessary cross agreements and/or easements necessary to bring the project into acceptance.

As part of the City's preliminary review, we are asking for specific direction and additional assurances that the project, as visioned in this preliminary review submittal, is an approvable project knowing that all aspects of the storm water will likely be comingled across parcel lines as well as ownership lines.

We are also asking for feedback as to what specific agreements the City will require to be put into place in order to get final site plan approval and building permit.

We envision the following agreements and easements:

- 1. A joint development agreement which defines who owns and who maintains the improvements proposed on the District property as well as shared improvements on the BGC site.
- 2. Cross-access and cross-parking agreements.
- 3. Easement for storm water discharge from the BGC onto District property.
- 4. Easement for storm water BMPs on District property.
- 5. Easement for storm pipe systems on District property.
- 6. Easement for a fire lane crossing from BGC property onto District property.
- 7. Easement for trash/recycle area and storage area on District property.
- 8. Easement for the relocation, reconstruction, and maintenance of the City water main that is currently in the area of the proposed building that will cross on and within both properties.
- 9. Separate Long Term Management Agreement for the storm water BMPs

Sincerely,

Jeffrey S. Moorhouse, ASLA PLA

President

CIVIL ENGINEERING LANDSCAPE ARCHITECTURE SURVEYING

632 Copeland Avenue La Crosse, WI 54603 Tel. 608.781.3110 Fax 608.781.3197 www.paragon-assoc.biz

YES NO N/A

NOTES

The checklist must be completed in full by the applicant prior to submission. Completed elements should be checked. Any elements that do not apply to your site or you are requesting an exception on, check the corresponding column and include notes. Items in italics are recommended actions but not required.

PARKING LOT DESIGN AND PARKING STANDARDS No parking stall may be closer to the street than the building setback X line or the building on the same parcel, whichever is farther from the street unless the applicant can demonstrate that there are no practical alternatives related specifically to the site. **C**.3 All points of ingress and egress will be evaluated by the City Traffic X Engineer to determine if ingress and egress should be allowed directly to the street or via an alley. **C**.4 Parking areas shall be separated from primary buildings by a landscaped buffer. C.5 Minimum setback for parking stalls and drives is five (5) feet from all property lines with the exception of the alley (in order to accommodate landscaping or drainage swales). Parking for adjacent properties may be Note: new parking lot is combined into continuous paved lots, eliminating the required setback X shared property with school district at the shared property line, provided that 100% of the lost green space is replaced elsewhere on the parcel (e.g. with a 10' setback along the opposite lot line). **C**.6 A parking lot for more than 12 vehicles shall incorporate at least 288 square feet of planting islands at least 8 feet in width (face of curb to face of curb). Planting islands may be either parallel to parking spaces or perpendicular to the parking spaces. As parking lot size increase, and X additional planting island is required at the ratio of one planting island for every 20 automobile parking spaces. No less that 5 percent of the islands shall be interior to the parking lot. **C**.7 Landscaping buffers, green space, and planting islands must total a X minimum of 10 percent of the lot. Buffers, setbacks, and planting islands are encouraged to be used for C.8 stormwater infiltration. **C**.9 All approaches, parking and vehicular circulation areas shall be paved and graded for proper stormwater management. The use of pervious X pavement for stormwater infiltration is highly encouraged. C.10For structures not needing approval by the Wisconsin Department of Commerce, parking spaces shall not be less than 8.5 feet in width and 17 feet in length. The full dimensions of this rectangle must be maintained in angled parking designs. Drive aisle widths vary depending upon the angle of parking space. The following minimum standards apply and shall be consistent with requirements of the City Engineering Department adopted standards: 45 degrees – 12'10" aisle 55 degrees – 13'7" aisle 65 degrees – 15'4" aisle 75 degrees - 17'10" aisle 90 degrees – 22' aisle C.11Where maximums on parking ratios exist, parking surfaces and drive aisles shall be permitted to be increased in size by no more than five percent (5%), provided at least twenty-five percent (25%) of the parking lot and pedestrian sidewalks consist of paving blocks (plastic or concrete honeycomb grid) planted with grass. Parking lots shall be located on the same lot as the principal structure C.12 Note: new parking lot is (unless it can be demonstrated that shared parking will be beneficial to shared property with multiple property owners and does not result in a "gap tooth" effect on a school district block face).

YES NO N/A NOTES Raised curbs, parking blocks or stops, decorative bollards and/or fences, trees and/or shrubs shall be utilized along the edge(s) of parking lots to X prevent motor vehicles from parking on green space buffers, outdoor recreation space, bike parking areas, sidewalks and side and front yards. In the event the original protective measures are inadequate to preventing inappropriate parking, additional measures shall be taken. C.14a Parking lot snow storage area(s) shall be designated in the parking lot X and/or green space buffers. C.14b Snow storage areas shall not be located near parking lot entrances and impede driver vision. C.14c If these green space buffer(s) are no longer capable of storing snow, the property owner shall arrange for the excess snow to be removed. C.14.d To the greatest extent possible, melting snow or ice should not drain over sidewalks or across neighboring properties. Light-colored and/or reflective surface coating should be considered to X reduce the "heat island" effect of traditional asphalt parking lots. Environmentally-friendly paving materials and methods are encouraged, X including but not limited to using recycled asphalt tires and roofing shingles as part of the mix or base. Porous paving materials such as paving blocks with decorative gravel, or properly spaced cobbles, brick, and natural stone with grass planted in X between in small clusters and methods that reduce stormwater runoff are encouraged. The off-street parking provisions for all commercial development shall be in conformance with 15.04(G). Required off-street parking space, X including access drives and aisles, shall not cover more than seventy-five percent (75%) of the lot area in which such off-street parking space is permitted. PEDESTRIAN CIRCULATION D.2 There shall be a paved pedestrian route from the sidewalk or street to the X main building entrance, and from the parking area to the nearest building entrance. **D**.3 Pedestrian routes shall be paved with concrete. Bituminous material X shall not be allowed for pedestrian routes. **D**.4 Porous paving materials and methods that reduce stormwater runoff.is X encouraged. **BUILDING MECHANICAL SERVICE ELEMENTS** E.2 The design and location of the following items shall be indicated on X building and/or site plans, illustrated with spec sheets as appropriate, and submitted with the Design Standards Checklist: E.2a utility meters building mechanicals E.2b trash and recycling containers E.2c E.2d bicycle parking Note: bicycle parking is E.2e outdoor seating areas located at existing parking area and not E.2f solar and wind facilities review - are we showing roof locations? shown on new site plan dish antennas (not permitted to hang off the side of buildings) E.2g E.2h transformers E.2i back-up generators

		YES	NO	N/A	NOTES
E.3	Service areas, utility meters, and building mechanicals shall not be located on the street side of the building, nor on the side wall closer than 10 feet to the street side of the building. The location of emergency back-up generators and transformers shall be coordinated between the City, developer and the utility company. Screening of meters, generators, transformers, and mechanicals is required when visible from the street with an approved screen device. Screening materials shall match building materials. Cable, conduit and phone line shall not be visible on the exterior with the exception of conduit running directly to the meter/utility boxes at the time of initial occupancy. Mailboxes are permitted within 10 feet of the front of the building if not visible from the street.	×			
E.4	Trash and recycling containers, including cans and dumpsters, shall have covers and be screened so as not to be visible from the street or from neighboring properties. Screening shall be one foot higher than the container but no higher than six feet; however, roofed enclosures may exceed this limit.	X			
E.5	If a building owner chooses to provide a trash receptacle and/or a smoking materials receptacle, the receptacle(s) shall be decorative if located at the entrance that faces a public street. These receptacles shall be screened from view and/or designed to fit with the architecture and materials of the building.			X	
E.6a	High energy gas appliances shall have the air intakes and exhaust vents located on the sides or rear of the building where they do not interfere with any sidewalks, are not likely to be blocked or damaged by pedestrian traffic, snow or the removal of snow, and away from any trees or shrubs that would be harmed by the exhaust heat and gases.	X			
E.6b	Window-mounted air conditioners shall not be permitted.			X	
E.6c	PTAC air conditioner/heat pump units must be designed into the architecture of the building.			X	
E.6d	If heat pumps or air conditioners are located on the ground, they shall be on one side or the rear of the building and screened with evergreens or decorative screening that matches or complements the exterior siding of the building, such that proper clearances are maintained for the manufacturer's warranty.			X	
E.6e	If heat pumps or air conditioners are located on the roof, they shall be placed, painted and/or screened so as to minimize the visual impact to the street.	X			
E.7a	Bicycle parking using bike racks specifically designed for bike parking shall be provided at one (1) space per 10 automobile parking spaces or one (1) space per 20 employees, whichever is greater, and should be located near building entries, shall not interfere with pedestrian circulation, and shall be well-lit. Bikes are not permitted to be stored, locked or chained on decks, patios, fences or any other exterior location other than a bike rack specifically designed for bike parking.			X	Note: bicycle parking is located at existing parking area and not shown on new site plan
E.7b	Bicycle parking (to accommodate four bicycles) shall be nominally at least nine (9) by six (6) feet or fifty-four (54) square feet and increase by the same ratio to accommodate the number of bike spaces.			X	Based on existing and new proposed parking spaces (65 total), 7 bik
E.7c	The base for bike racks should be concrete to ensure their stability; however, the remaining bicycle parking area shall be porous paving materials (paving blocks with decorative gravel or wood mulch, or properly spaced cobbles, brick, and natural stone with grass planted in between in small clusters) to reduce stormwater runoff but shall not result in standing water. If an area for bike parking is designed using these standards, then up to 100 percent of the space taken for the bike parking shall count as green space.			X	parking spaces are required. There are 14 existing bike parking spots on site.

LAND	OSCAPING OPEN SPACE & PLANTINGS	YES	NO	N/A	NOTES
F.2	A landscape design and planting plan shall be prepared and submitted for all buildings. Landscape plans for developments shall be prepared and signed by a Landscape Architect, nurseryman, or professional site planner with educational training or work experience in land analysis and site plan preparation prior to submittal to the City.				
F.2a	No building permit shall be issued until the required landscaping plan has been submitted and approved, and no certificate of occupancy shall be issued until the landscaping is completed as certified by an on-site inspection by the Building Inspector, Planning Staff, or other designated official, unless a financial guarantee acceptable to the City has been submitted.				
F.2b	Landscape surety. The owner shall provide the City with a cash deposit, bond, or approved letter of credit to guarantee the proper installation and growth of all landscape improvements proposed in the approved landscape plan. Said surety may remain in effect for two full growing seasons. A growing season shall be considered a period from May 1 to September 30. The first year, the amount of the surety will be equal to 100% of the estimated cost of plant material, installation and tree preservation. Once installation has been completed per the approved landscape plan and verified by the City, 75% of the surety will be reimbursed back to the owner. The remaining 25% will be kept by the City for a period of twelve (12) months to cover any maintenance cost that may be needed. Such surety shall be filed with the City Finance Officer.				
F.2c	The City may allow an extended period of time for completion of all landscaping if the delay is due to conditions which are reasonably beyond the control of the developer. Extensions may not exceed nine months, and extensions may be granted due to seasonal weather conditions. When an extension is granted, the City may require such additional security and conditions as it deems necessary.				
F.3a	The plan shall address all parts of the parcel and shall indicate: Details of all proposed vegetative landscaping materials, including placement, common and botanical names, caliper/height or container size and quantity and maintenance requirements.				
F.3b	Details of proposed non-vegetative landscaping and screening materials.				
F.3c	Planting and construction schedule for completion of landscaping and screening plans.				
F.3d	Estimated cost from a landscaper on a bid or estimate form of the proposed landscaping.				
F.4	All portions of the site not covered by buildings, paving material, or other planned and approved surfaces shall be considered "landscaped area" and shall have a minimum of 4 inches of top soil and be planted with living plant materials and/or mulches. Overall site landscaping shall include not less than:				
F.4a	One tree placed in the boulevard per 40 linear feet of lot frontage;				
F.4b	Not less than two trees and eight shrubs per 600 square feet of landscaped area. These are minimum standards – more plantings are encouraged.				
F.5	All plant material used shall meet the minimum standards established by the American Association of Nurserymen as published in the American Standards for Nursery Stock and shall meet the following minimum requirements:				
F.5a	Deciduous trees: 2" dbh (diameter at breast height)				
F.5b	Ornamental trees: 2" dbh		Щ	Ш	
F.5c	Evergreen trees: 5' height	H			
F.5d F.5e	Shrubs: 5 gallon container Vines and Perennials: 1 gallon container				

		YES	NO	N/A	NOTES
F.6	Boulevard trees will be installed by the City Forester at City expense if the developer attends City tree school. If the developer installs boulevard trees they shall conform to City street standards. A complete list of trees and shrubs and other reliable plant material that has been approved by the City Forester is available in the City Planning and Development Department.				
F.7	Existing healthy trees should be preserved to the greatest extent practicable and shall be indicated on grading and landscape plans submitted for plan review; however, invasive trees shall be removed. Existing damaged, decayed, or diseased trees should be removed to protect remaining trees. Construction near existing trees should follow Best Management Practices to ensure their survival.				
F.8	Landscaping should reinforce pedestrian circulation routes and obstruct undesired routes of convenience. Bushes, trees, rocks, and other landscape features should be used to indicate where pedestrians should and should not travel.				
F.9a	Provide a five (5) to six (6) foot high solid screen to separate parking lots from abutting residential uses or other non-compatible uses. A solid landscape screen is defined as an evergreen or nearly evergreen mixture (minimum of 65% evergreen) of shrubs, bushes, or trees that produce a dense, sight-obscuring screen at least five (5) to six (6) feet in height within three years of planting. Berms may be included in this definition as long as the maximum height of the berm is five feet; both sides of the berm are planted with evergreen or nearly evergreen shrubs or bushes so that the total height of landscaping and berm will be at least six feet within three years of planting; and top of the berm plantings form a dense, sight-obscuring screen within the same three-year period.				
F.9b	Provide a minimum three (3) foot high visual relief screen when adjacent to a street in the form of a hedge, fence, planter, berm, dividers, shrubbery and trees or any combination. The visual relief screen shall extend the length of the parking lot. Three (3) feet in height shall be measured from surface of the parking lot and may be negotiable depending on the elevation of the parking lot in relation to the sidewalk and/or street. All landscaping to form such a visual relief shall be a minimum height of 2 feet at time of planting. Bark or other loose material shall not be placed on berms in these areas since it may be displaced on the street or sidewalk.				
F.10a	The property owner shall be responsible for maintenance and replacement of trees, shrubs, grass, ground covers, loose bark or gravel, and sod which are part of the approved landscape plan. If any such plant materials are not maintained or replaced, the City may utilize the required surety to replace the newly planted or protected landscaping or to deem this to be a Municipal Code Violation and issue an Order to Correct.				
F.10b	The owner is responsible for keeping trees in a plumb position. When staking or securing trees is done, it shall occur so as not to create any hazards or unsightly obstacles.				
F.10c	Plants must be maintained to be kept in sound, healthy and vigorous growing conditions and free of disease, insect eggs and larvae.				
F.10d	A sprinkler or lawn irrigation system shall be required in the front yard and boulevard of all developments if lawn or sod is proposed. This standard does not apply to boulevards if sprinkler or lawn irrigation systems are not needed for the front yard.				
WALI G.2	US AND FENCES Walls and fences located in the front yard setback shall not exceed six feet in height above the finished grade and shall be at least 50% transparent to retain the visual connection between street and building			X	Note: no walls or fence in front yard setback

		YES	NO	N/A	NOTES
G.3	The design and materials for walls and fences shall be coordinated with the design and materials of the principal buildings and should have substantially the same detail. This is not intended to require identical materials and design.				
G.3a	Pressure treated lumber fences shall not be permitted unless stained or painted.				
G.3b	All chain link fences must be plastic coated and shall only be permitted in side yards and backyard, and shall not extend nearer to the street than the front of the building nor used in the side yard on a corner property.				
G.3c	Smooth faced concrete (CMV) blocks or non-architectural poured walls used to construct a wall shall be covered with brick or some other decorative block or dimensional material such as a stained block product. Painted or colored smooth-faced concrete bricks or blocks shall not be considered decorative block.				
G.4	Walls and fences shall provide variety and articulation at each end and at intervals not exceeding 25 feet through at least one of the following methods: Changes in plane of not less than one (1) foot; Expression of structure, such as post, column, or pilaster; Variation of material; or Landscaping				
STOR H.2	MWATER INFILTRATION AND CONTROL A stormwater management and erosion control plan shall be required for all new construction, shall be coordinated with the Landscaping and Open Space Plan, and shall be designed by either a Registered Architect, Landscape Architect or a Professional Civil Engineer in accordance with the City of La Crosse's Stormwater Management Ordinance and shall include a maintenance plan and agreement.	X			
H.2a	Until such time as the City adopts a stormwater management ordinance, the City shall use the La Crosse County Stormwater Management Ordinance.				
H.2b	For parcels less than ¼ acre in size, the City shall work with the property owner/developer/applicant to develop a practical site-specific stormwater management plan that allows for flexibility in the use of stormwater treatment devices including rain barrels, rain gardens, swales, cisterns, drain tiles, soil amendments, porous pavements, grass pavers for overflow parking areas, etc.				
H.3	The use of bio-cells, living roofs and rain gardens is encouraged due to their aesthetic as well as utilitarian benefits.				
H.4	Newly concentrated stormwater, such as that from rooftop, impervious surface, or swales, shall not be directed onto or across adjacent properties or across sidewalks. Rooftop stormwater shall not be discharged within 5 feet of a sidewalk unless an intervening landscape element is used to promote infiltration, such as a rain garden.				
H.5	Stormwater detention and infiltration facilities shall be designed as visual and open space amenities that enhance the overall appearance of the site.				
EXTE I.2	RIOR LIGHTING All exterior lights shall be designed for commercial use. A lighting plan showing lighting levels on-site and at the property line as well as spec sheets with pictures must be submitted with the Design Standards Checklist for each exterior light to be used.				
I.3	Pedestrian lighting shall clearly indicate the path of travel, shall minimize dark spots along that path, and shall utilize coordinated light fixtures.				
I.4	The maximum height of wall-mounted parking lot light fixtures shall be 16 feet above the ground. Pole-mounted fixtures are acceptable but not required and will have a maximum height of 30 feet from the ground to the top of the fixture. Fixtures shall be of full-cut-off (FCO) design to minimize glare and spillover.				

		YES	NO	N/A	NOTES
I.5	Ornamental lighting to light the building façade is permitted provided that the light source is not visible from the property line and is designed to minimize glare and spillover.				
I.6	No overhead light source (i.e., the lamp or reflector) shall be visible from the property line. Shields may be employed, if necessary, to meet this requirement. The maximum allowable luminance measured 25 feet beyond the property line shall be .05 horizontal foot-candles (HFC).				
I.7	Lighting levels for parking lots and pedestrian routes: (horizontal luminance measured in foot-candles):	; 			
I.7a	Average: 2.4 foot-candles		Н	\vdash	
I.7b	Minimum: 1.0 foot-candles	Щ		닏	
I.7c	Uniformity Ratio (Bright spots to dark spots): 4:1		<u> </u>	\sqcup	
I.7d	Maximum Average: .5 foot-candles				
I.8	Each exterior entry to structures on the property shall have an exterior light.				
I.9	For properties adjacent to residential uses, motion sensor flood or spot lights shall have shrouds, be limited to two (2) bulbs pointed at least thirty degrees downward and not directly into windows or doors of neighboring building and the light sources shall not be visible from the street.			X	
PATIO J.2	OS, PORCHES, DECKS, AND ROOFTOP GARDENS/DECKS Every residential unit is encouraged to have its own patio or balcony and shall be incorporated into the architectural façade of the building and may encroach into the building setback area but not more than 25%. Commercial structures are also permitted to have exterior balconies. No patio or balcony can hang over a sidewalk.			×	
J.3	For commercial developments, ground level patios or decks for customer seating are permitted in the setback areas and should include some screening for noise.			X	
J.4	Exterior stairs leading to a deck or balcony are permitted provided that they are decorative and are architecturally compatible with the building and constructed of compatible materials. Exterior corridors visible from a street are not permitted.			X	
J.5	Rooftop green roofs or rooftop patios and decks are permitted and if intended for occupied use shall have a railing height or parapet of at least 42 inches. Only outdoor furniture is permitted.	X			
BIIII	DING DESIGN: FORM, SCALE AND CONTEXT				
K.2	Photos of at least four (4) street views of nearby blocks shall be submitted with the Design Standards checklist.	X			
K.3	Buildings shall be designed to provide human scale, interest, and variety. The following techniques may be used to meet this objective:	X			
K.3a	Variation in the building form such as recessed or projecting bays, shifts in	X			
K.3b	massing, or distinct roof shapes. Emphasis of building entries through projecting or recessed forms, detail, color, or materials.	X			
K.3c	Variation of materials. Variation of material, modules, expressed joints and details, surface relief, color, and texture to break up large building forms and wall surfaces. Such detailing could include sills, headers, belt courses, reveals, pilasters, window bays, and similar features.	X			
K.4	For all non-manufacturing or retail buildings, where the allowable building is more than 50% wider than adjacent buildings, one of the following techniques shall be employed to minimize the apparent width of the primary façade:			X	
K.4a	Articulate the façade with projections or bays.			X	
K.4b	Use architectural elements such as column, canopies, glass, changes in materials, and covered entries to interrupt the façade.			X	

		YES	NO	N/A	NOTES
K.5	The first floor façade shall include windows to provide visual interest and visual connection to the street. The total area of windows and doors on the street-facing façade, including trim, shall not be less than 20% of the total area of the façade, excluding gables.			X	
K.6	Buildings shall be built to the front yard setback line. In highway commercial areas, the building setback shall not be greater than 25 feet and no parking is permitted in the front yard setback area.			X	
K.7	Commercial buildings within Historic Districts or adjacent to any designated historic building must first receive DRC review and approval prior to submittal to the Heritage Preservation Commission for their review. Approval by the Heritage Preservation Commission is necessary prior to the issuance of any building permit. The developer can appeal to the City Plan commission if denied by the Heritage Preservation Commission.			X	
BUIL L.2	DING ENTRANCES, DETAILS, TRIM, DOORS AND WINDOWS The primary entrance to the building shall be covered at least three (3) feet from the door. Entrance features may encroach into the front yard setback a maximum of three (3) feet. Building entrances shall be emphasized through projecting or recessing forms, detail, color or materials. Buildings shall be oriented toward the street with pedestrian access.	X			Note: entry cannot be oriented towards the street. There is no street on east side of property
L.3	All openings shall be articulated or appropriately trimmed through the use of materials such as flat or arched lintels, projecting sills, or surrounds.			X	Note: openings match existing building design
L.4a	All windows shall be in keeping with the architectural character of the	X			
L.4b	All windows shall have an interior locking or securing mechanism.		X		Note: windows are fixed
L.4c	For mixed used developments that include residential units, exterior entry doors for individual units shall be residential in style (real or decorative styles, rails or panels) solid or insulated or multiple units may be commercial in style (glass). If the door does not have a translucent window lower than five (5) feet, it shall have a security peephole.			X	
ROOH M.2	S AND ROOF LINES Any roof style such as hip, gambrel, mansard, colonial, flat or another				
101.2	roof style is permitted so long as the roof pitch is appropriate to the architectural style of the building (e.g. prairie school) and the roof element contains additional architectural elements such as dormers, long overhangs, windows or other feature.	X			Note: roof line matches and compliments existing building roof lines
M.3	Flat roofs are permitted, and must incorporate a parapet wall on all sides, unless the rear side of the building is sloped for drainage. The parapet should include architectural details appropriate to the building design that create a positive visual termination for the building (a "top").	X			
M.4	A minimum of 50% of a building's linear roof drip edge should fall to ground surfaces that do not contain impervious surface. If gutters or other stormwater drains toward neighboring properties, then water shall be directed to an onsite rain garden(s) designed to retain a 0.5 inch-1hr rainfall. For information regarding directing clean roof water to rain gardens, the Wisconsin DNR and UW-Extension have extensive publications on the proper calculation for the size and planting materials for rain gardens in Wisconsin.			X	Note: new roof drains to be connected to underground storm.
	RIOR MATERIALS				
N.2	The use of identical materials on all sides of the building is encouraged; however; higher-quality materials on street-facing façade and complementary materials on other façade is acceptable.	X			Note: addition will match/compliment the
N.3	Use of decorative accessories and trim is highly encouraged.			X	existing building

		YES	NO	N/A	NOTES
N.4	Vinyl, plywood, chipboard, T1-11, asphalt siding, non-architectural metal siding and smooth-faced concrete block are prohibited as exterior finish materials unless the architect can demonstrate that the materials are appropriate to the design of the building. Treated wood shall be painted or stained.	X			Note: addition will match/compliment the existing building
N.5	Natural wood shall be painted or stained, unless it is cedar, redwood or some other naturally weather resistant species and is intended to be exposed.			X	Note: no natural wood building addition
N.6a	Since the selection of building colors has a significant aesthetic and visual impact upon the public and neighboring properties, as well as an impact on the energy use and comfort of customers and tenants, designs and color shall be selected in general harmony with the overall existing neighborhood.	X			Note: addition will match/compliment the existing building
N.6b	Neutral or natural colors for the primary siding material with brighter or darker colors for accent and trim that provide for a more interesting building and are cooler in the summer are preferred.			X	Note: addition will match/compliment the existing building
N.6c	Complementary multi-color and textured roofing materials that provide for a more interesting building and are cooler in the summer are preferred.			X	
GAR	AGES AND ACCESSORY BUILDINGS				
O .2	Street-facing overhead doors on garages are not permitted on lots served by an alley.	X			
0.3	The cumulative length of all garage doors facing the street shall not exceed 50% of the total length of the street-facing elevation unless architecturally justified.	X			
O.4	Accessory buildings shall be architecturally compatible and be constructed of the same materials as the primary building(s). All changes to the approved plans such as the addition of an accessory structure shall be approved by the Design Review Committee if not submitted at the time of initial review.	X			Note: exterior storage shed and refuse/recycl enclosure will match/compliment the existing building mater
BUIL P.2	DING CONSTRUCTION A completed LEED checklist must be submitted with the Design Standards checklist to demonstrate compliance with the standard.			X	
Q.2	DING, PROPERTY AND LANDSCAPING MAINTENANCE All commercial structures and buildings that are developed and constructed under this ordinance shall maintain the property through an ongoing maintenance program. The maintenance program is to include all exterior aspects of the development and include but is not limited to parking lots, building mechanicals, service elements, customer and tenant amenities, landscaping open space and plantings, wall and fences, signage, stormwater facilities, exterior lighting, patios and decks, exterior finishes, windows, architectural detail, and accessory structures.	×			
Q.3	The project shall be maintained over the life of the development in a like-new condition with an on-going maintenance program that adheres to the intent of the original building plans and is subject to inspection by the City at anytime. Failure to maintain the project may subject the property to fines as permitted under this Chapter and the City of La Crosse Stormwater Management Ordinance. (#4513-7/9/09)	X			

Boys & Girls Clubs of Greater La Crosse

Life & Workforce Readiness Center Addition

1331 Clinton Street La Crosse, WI 54603

Progress Set 9.25.2024







ARCHITECTS TINC
750 N. Third Street La Crosse, W! WI

Girls Clubs of Greater La Crosse Vorkforce Readiness Center Additic

PROJECT NO: **24153**

DRAWING DATE: 9.25.24

DRAWN BY: JWS

SET TYPE:
Progress Set

REVISIONS NO. DATE

SHEET TITLE

Cover Sheet

SHEET NO.

G000

Scale:

SECOND FLOOR - OVERALL PLAN

1/16" = 1'-0"

ARCHITECTS IN C

's & Girls Clubs of Greater La Crosse

& Workforce Readiness Center Addition

PROJECT NO: 24153

DRAWING DATE: 9.25.24

DRAWN BY:

SET TYPE:
Progress Set

REVISIONS NO. DATE

SHEET TITLE

Overall Plan

SHEET NO.

A002

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Roof Plan

SHEET NO.

Scale: 1/8" = 1'-0"

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A R C H I T E C T S IN C

PROJECT TITLE:

Boys & Girls Clubs of Greater La Crosse

Life & Workforce Readiness Center Addition
PROJECT LOCATION:
1331 Clinton Street
La Crosse, WI 54603

PROJECT NO: **24153**

DRAWING DATE: 9.25.24

DRAWN BY: JWS

SET TYPE:
Progress Set

REVISIONS NO. DATE

SHEET TITLE

Exterior Elevations

SHEET NO.

A201

Scale: As indicated

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SANITARY MH RIM = 646.64 INV 4" E (in) = 641.54 (PLUGGED) INV 6" NW (in) = 641.54 INV 6" N (in) = 641.46 INV 12" W (out) = 641.44

X 642.44°

GENERAL NOTES

THE LOCATION OF EXISTING UTILITIES, BOTH UNDERGROUND AND OVERHEAD ARE APPROXIMATE ONLY AND HAVE NOT BEEN INDEPENDENTLY VERIFIED BY THE OWNER OR ITS REPRESENTATIVES. THE CONTRACTOR SHALL BE RESPONSIBLE FOR DETERMINING THE EXACT LOCATION OF ALL EXISTING UTILITIES, WHETHER SHOWN ON THESE PLANS OR NOT, BEFORE COMMENCING WORK, AND SHALL BE FULLY RESPONSIBLE FOR ANY AND ALL DAMAGES WHICH MIGHT BE CAUSED BY THE CONTRACTOR'S FAILURE TO EXACTLY LOCATE AND PRESERVE ANY AND ALL UTILITIES. DIAL 811 OR (800) 242-8511

THE UNDERGROUND LOCATIONS OF THE PUBLIC UTILITIES WERE MARKED BY REPRESENTATIVES OF THOSE COMPANIES. THE LOCATIONS OF THE PRIVATELY OWNED UNDERGROUND UTILITIES WERE NOT MARKED.

THERE MAY BE MORE UNDERGROUND UTILITY INSTALLATIONS WITHIN THE PROJECT AREA THAT ARE NOT SHOWN.

ANY AND ALL PARTIES UTILIZING VERTICAL DATUM SHALL ALWAYS CHECK INTO AT LEAST TWO (2) BENCHMARKS TO AVOID MISTAKES DUE TO HYDRANT ADJUSTMENTS OR TRANSPOSITIONAL ERRORS. FAILURE TO DO SO WILL BE CONSIDERED TANTAMOUNT TO GROSS NEGLIGENCE AND SUBJECT THE OFFENDING PARTY TO ANY DAMAGES RESULTING THEREFROM.

Existing Conditions
Map

SHEET TITLE

PROJECT NO:

DRAWING DATE:

8.12.24

JWS

DRAWN BY:

SET TYPE:

REVISIONS NO. DATE

Design Concept


SHEET NO.

C00 2

PLAN SCALE: 1"=20'

Scale: 1" = 20'

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SITE NOTES

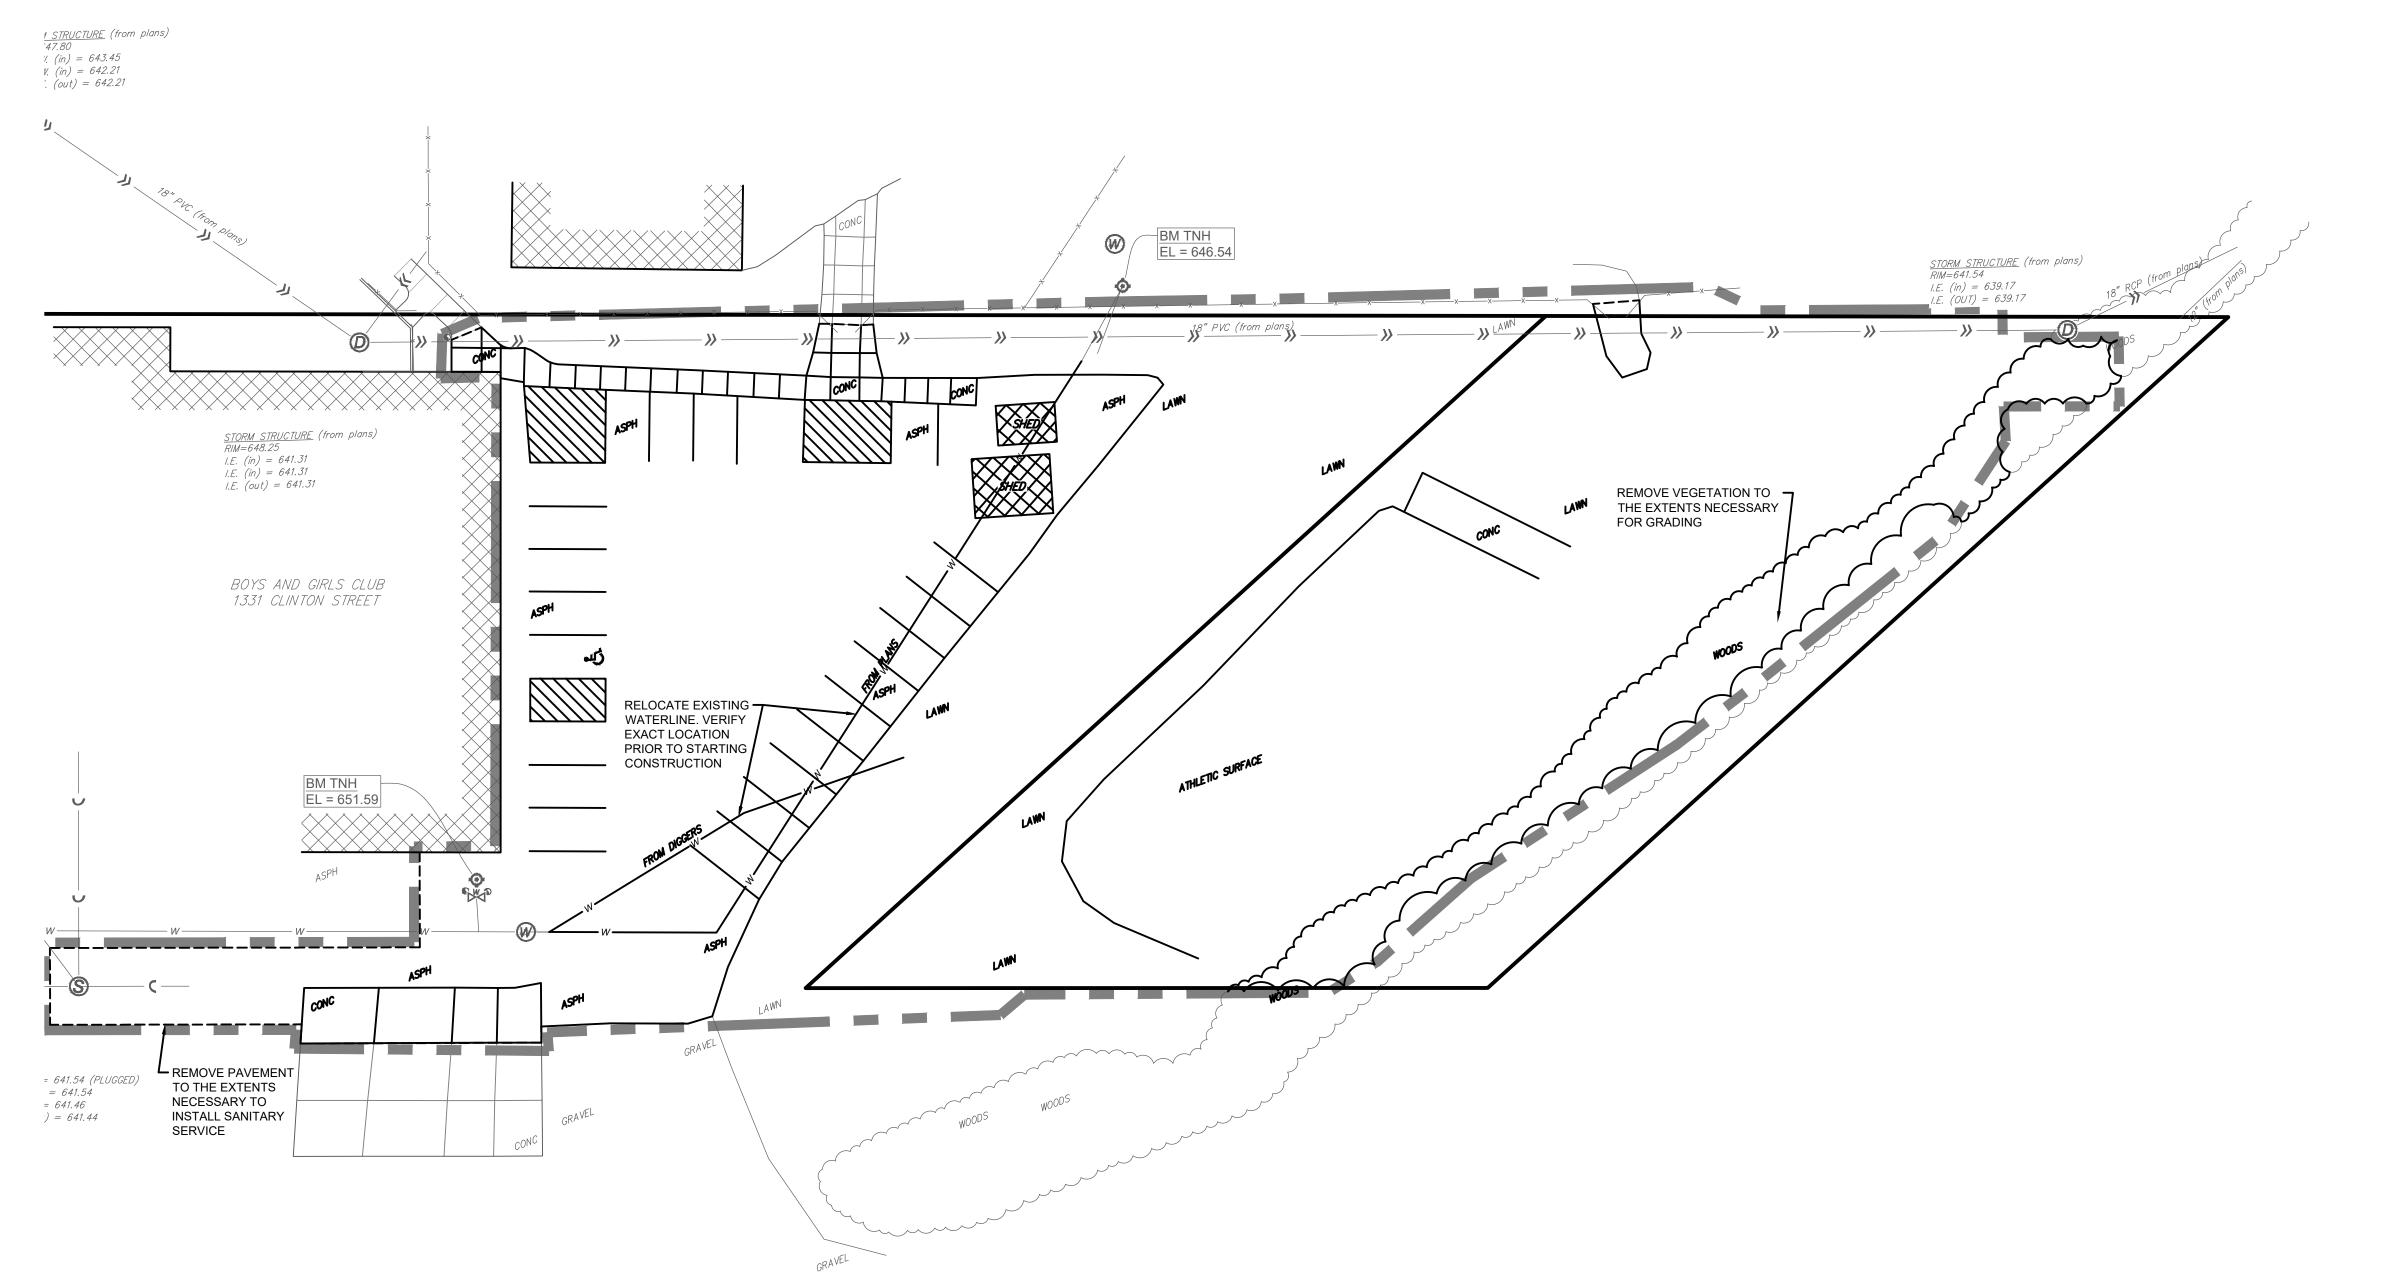-The location of existing utilities, both underground and overhead are approximate only and have not been independently verified by the owner or its representatives. The contractor shall be responsible for determining the exact location of all existing utilities, whether shown on these plans or not, before commencing work, and shall be fully responsible for any and all damages which might be caused by the contractor's failure to exactly locate and preserve any and all utilities. CALL DIGGERS HOTLINE (800) 242-8511

-The underground locations of the Public Utilities were marked by representatives of those companies. The locations of the privately owned underground utilities were not marked.

-There may be more underground utility installations within the project area that are not shown.

-It shall be the contractors responsibility to arrange for any necessary inspections by local government that may be required.

-Any and all parties utilizing vertical datum shall always check into at least two (2) benchmarks to avoid mistakes due to hydrant adjustments or transpositional errors. failure to do so will be considered tantamount to gross negligence and subject the offending party to any damages resulting therefrom.

-There may be discrepancies between the building exterior as located on the survey and what was provided by the architect. Verify dimensions prior to construction.

DEMOLITION NOTES

 $\langle 1 \rangle$ SAW CUT AND REMOVE EXISTING PAVEMENT

 $\langle 2 \rangle$ REMOVE EXISTING CONCRETE CURB OR PAVEMENT TO NEAREST JOINT

(3) PROTECT EXISTING IMPROVEMENT IN PLACE

4 PROTECT EXISTING UTILITY IN PLACE

5 REMOVE EXISTING UTILITY

6 REMOVE EXISTING TREE

7 PROTECT EXISTING TREE (WITH TEMPORARY FENCING WHERE NOTED)

8 REMOVE EXISTING SIGN. SALVAGE SIGN FACE FOR REINSTALLATION AS DIRECTED BY OWNER.

(9) CONTRACTOR SHALL EXCAVATE AND UNCOVER EXISTING WATER SERVICE TO VERIFY SERVICE MATERIAL AND SIZE WITHIN 30 DAYS OF MOBILIZATION TO THE SITE. IDEALLY DONE AT THE TIME THE SERVICE VALVE IS REPLACED. SEE UTILITY SHEET.

HITECTS

& Girls Clubs of Greater La Crosse
Workforce Readiness Center Addition

PROJECT NO:

DRAWING DATE: 09/25/2024


DRAWN BY:

SET TYPE:
Design Concept

REVISIONS NO. DATE


SHEET TITLE

Demolition Plan

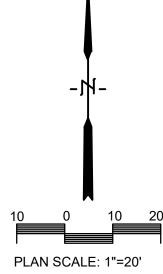

SHEET NO.

C050

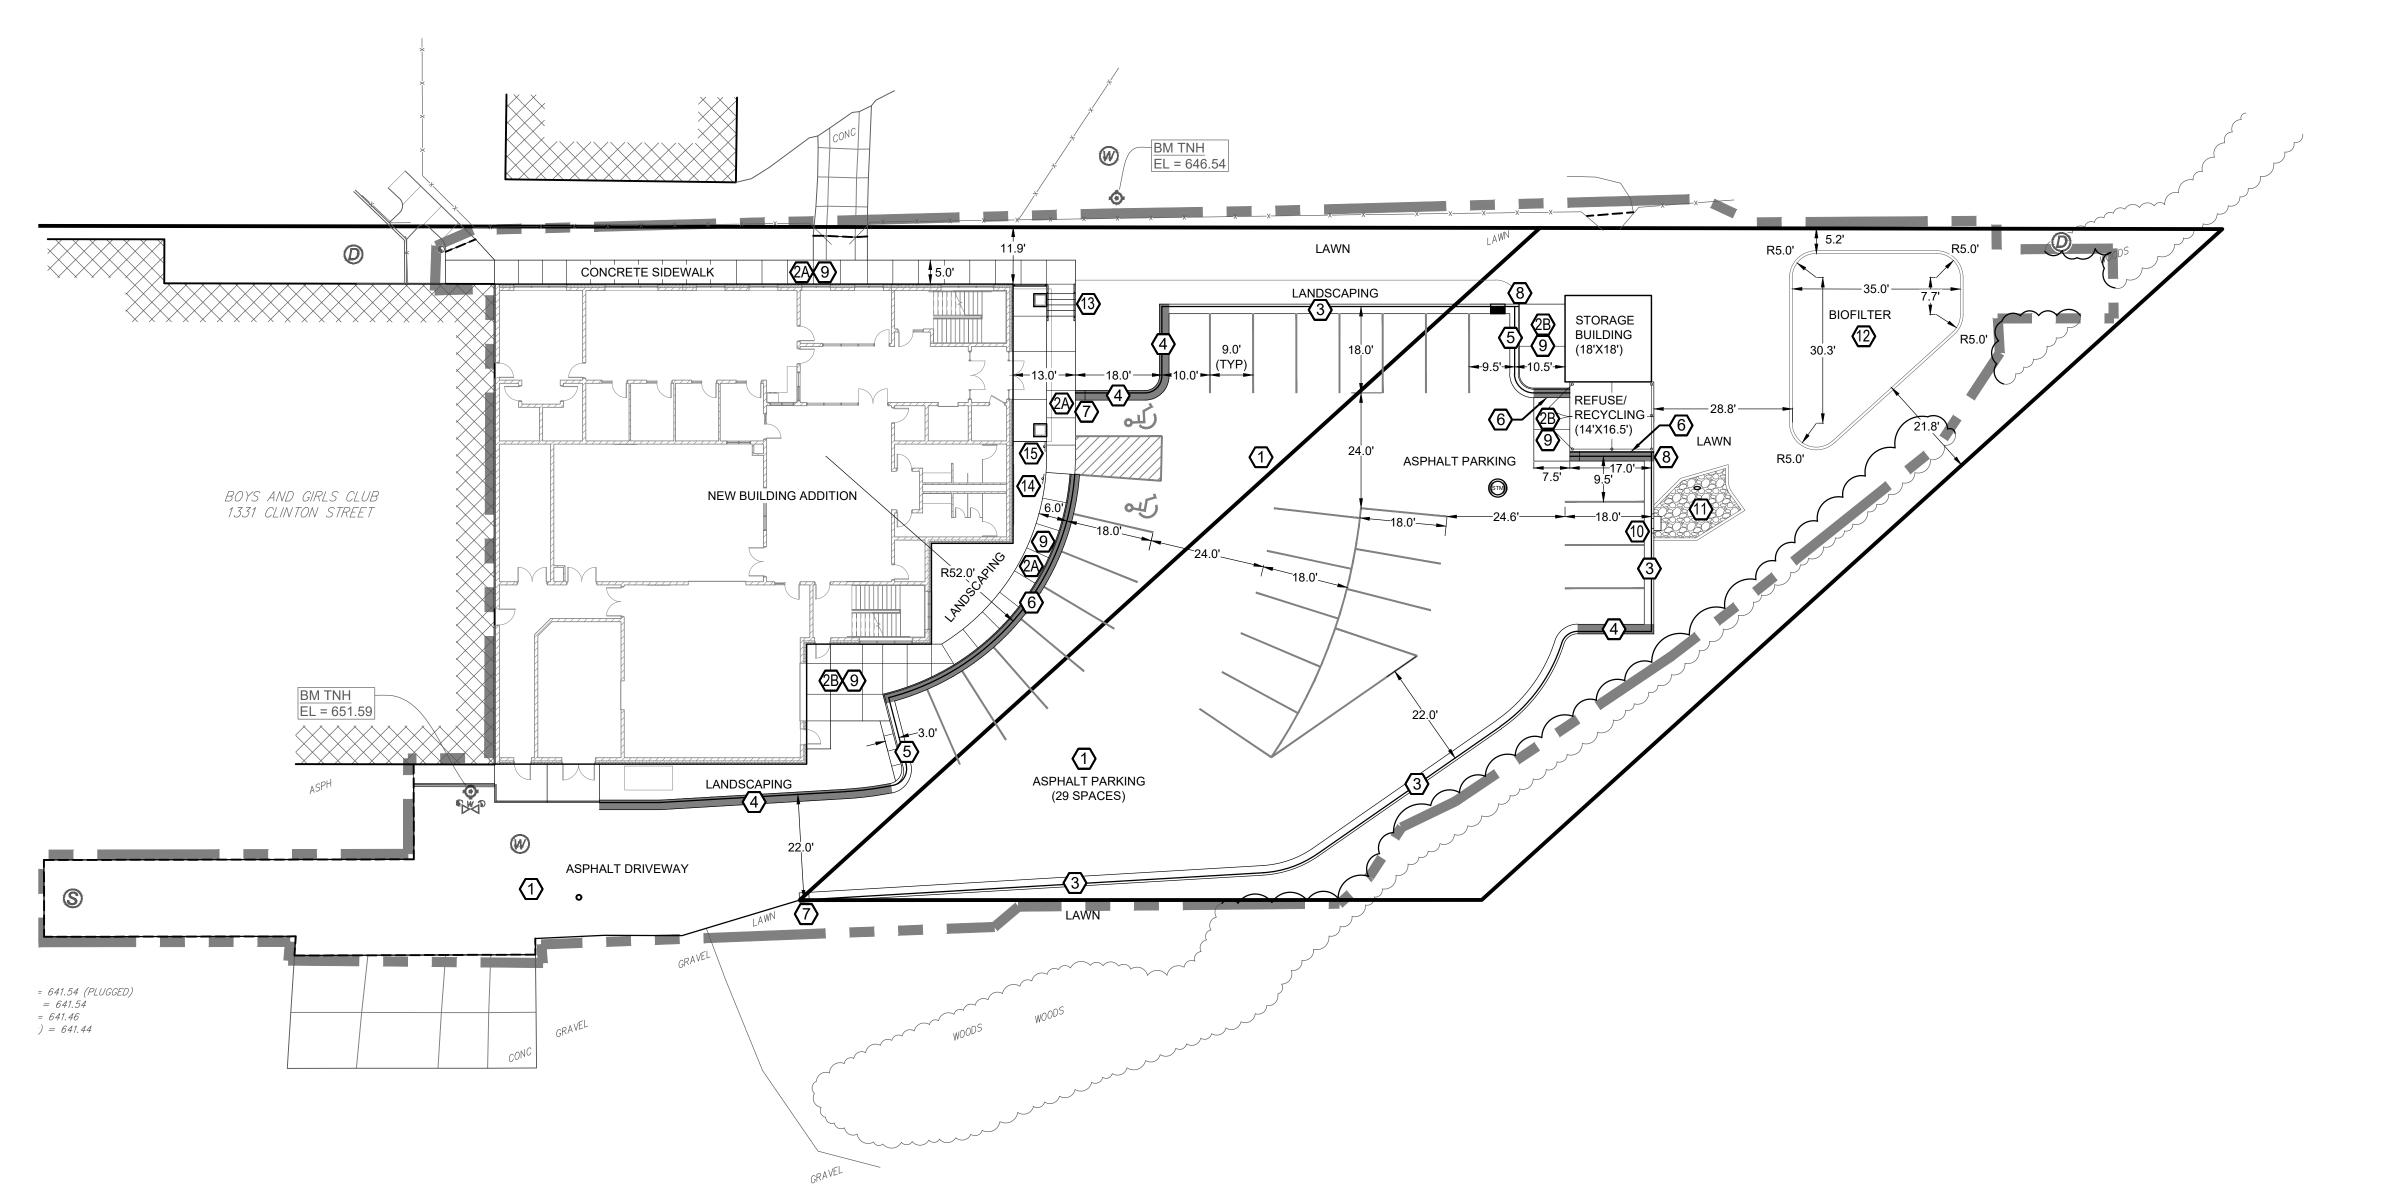

SITE NOTES

-The location of existing utilities, both underground and overhead are approximate only and have not been independently verified by the owner or its representatives. The contractor shall be responsible for determining the exact location of all existing utilities, whether shown on these plans or not, before commencing work, and shall be fully responsible for any and all damages which might be caused by the contractor's failure to exactly locate and preserve any and all utilities. CALL DIGGERS HOTLINE (800) 242-8511

-The underground locations of the Public Utilities were marked by representatives of those companies. The locations of the privately owned underground utilities were not marked.

-There may be more underground utility installations within the project area that are not shown.

-It shall be the contractors responsibility to arrange for any necessary inspections by local government that may be required.

-Any and all parties utilizing vertical datum shall always check into at least two (2) benchmarks to avoid mistakes due to hydrant adjustments or transpositional errors. failure to do so will be considered tantamount to gross negligence and subject the offending party to any damages resulting therefrom.

-There may be discrepancies between the building exterior as located on the survey and what was provided by the architect. Verify dimensions prior to construction.

SITE NOTES

 $\overbrace{1}$ SEE DETAIL $\overbrace{_{ ext{C500}}^{ ext{A}}}$ FOR ASPHALT PAVEMENT

②A SEE DETAIL B FOR CONCRETE PAVEMENT - TYPE 1

②B SEE DETAIL B FOR CONCRETE PAVEMENT - TYPE 2

(4) SEE DETAIL (D) FOR 24" CURB AND GUTTER SECTION - REVERSE SLOPE

5 SEE DETAIL E FOR TYPICAL 24" MOUNTABLE CURB & GUTTER

6 SEE DETAIL FOR TYPICAL 24" MOUNTABLE CURB & GUTTER - REVERSE SLOPE

 $\overline{7}$ SEE DETAIL $\overline{\overset{ extbf{G}}{\text{C500}}}$ FOR END SECTION CURB AND GUTTER

8SEE DETAIL $\frac{H}{C500}$ FOR END SECTION CORNER MOUNTABLE CURB

9 SEE DETAIL (1) FOR CONCRETE PAVING AND JOINTING

(10) SEE DETAIL (J) FOR CURB CUT

 $\langle \overline{11} \rangle$ SEE DETAIL $\stackrel{K}{\underset{C5500}{\text{c}}}$ FOR SPLASH PAD SECTION

 \bigcirc SEE DETAIL \bigcirc FOR BIOFILTER

(13) SEE DETAIL M CSSOO FOR REINFORCED CONCRETE STEP

 $\stackrel{\frown}{14}$ SEE DETAIL N FOR DISABLED PARKING SIGN - TYPE 1

(5) SEE DETAIL N FOR DISABLED PARKING SIGN - TYPE 2

COMMERCIAL DESIGN REVIEW

REQUIRED PARKING: EXISTING AND PROPOSED PARKING: 58 SPACES (4 ADA SPACES) (+ 5 ADDITIONAL ON SCHOOL DISTRICT PROPERTY OF SHARED CIRCLE DRIVE)

STREET FRONTAGE: 312 L.F. = 8 REQUIRED TREES

EXISTING AND PROPOSED TREES: 25

PLANTING ISLANDS: 1,022 SF REQUIRED

EXISTING AND PROPOSED ISLANDS: 1,115+ SF

GREENSPACE: (112,385 SF BETWEEN TWO LOTS) = 11,239 SF REQUIRED EXISTING AND PROPOSED GREENSPACE: 17,621+ SF

DRAWING DATE:

PROJECT NO:

09/25/2024

DRAWN BY: C.G.


SET TYPE:

Design Concept

REVISIONS NO. DATE


SHEET TITLE

Site Plan

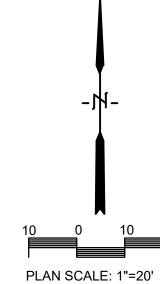

SHEET NO.

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GRADING NOTES

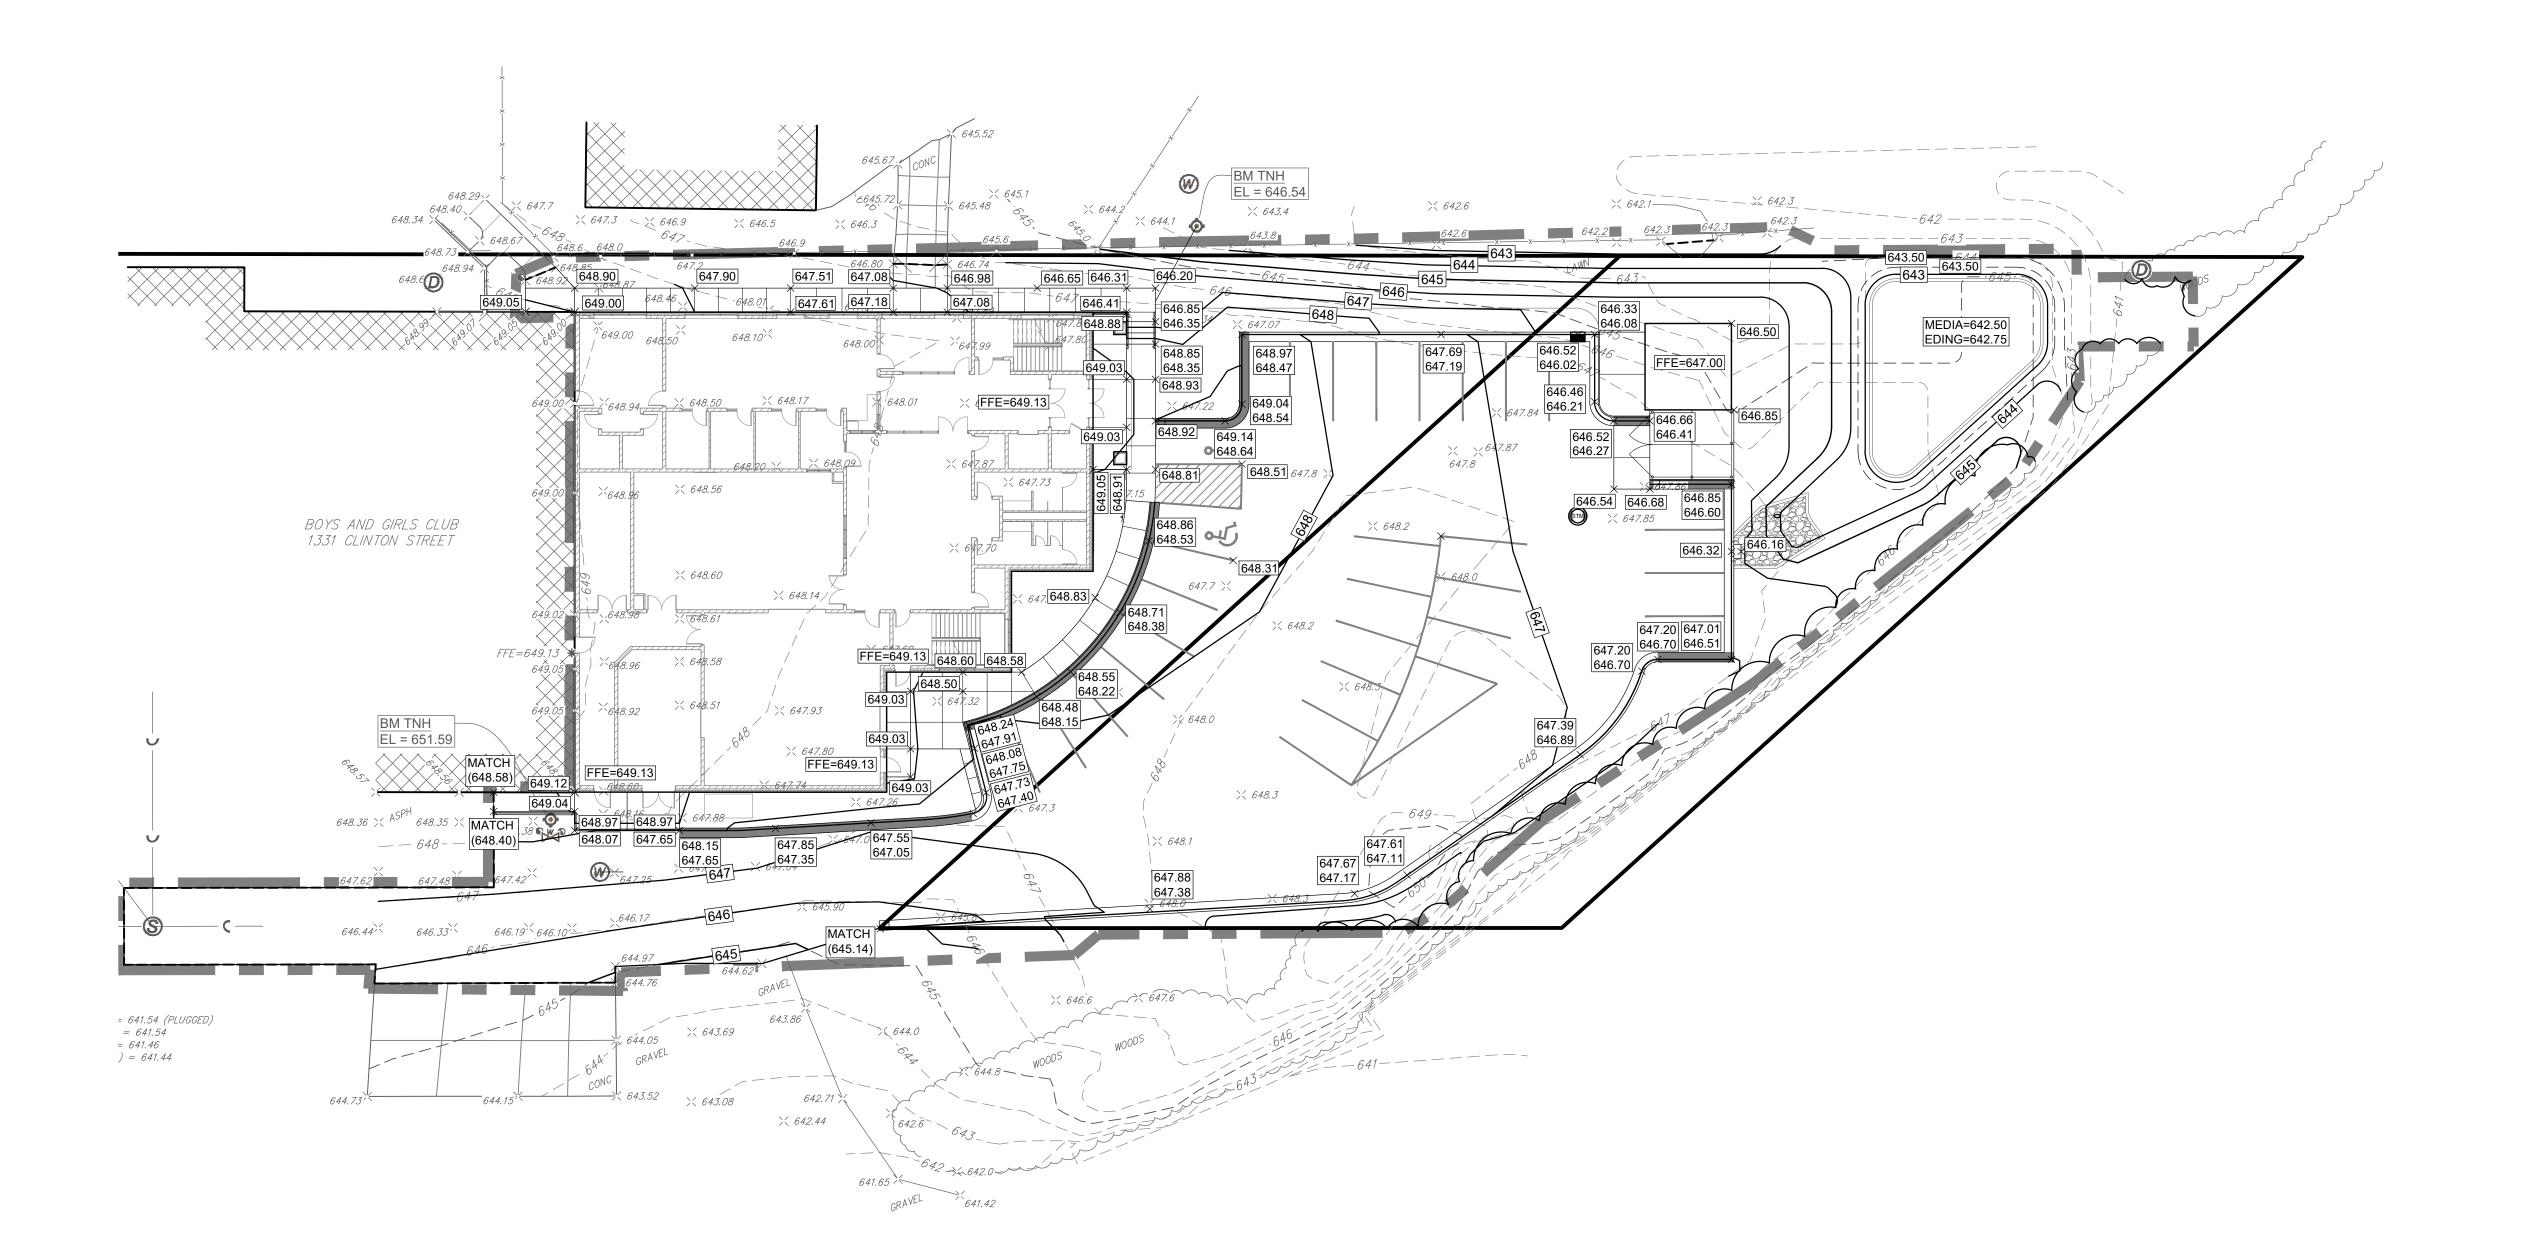-CONTOURS SHOWN ARE FOR FINISHED SURFACES, ANY ADJUSTMENT TO SUBGRADE IS THE CONTRACTOR'S RESPONSIBILITY.

-ALL DISTURBED AREAS THAT ARE UNPAVED ARE TO BE LANDSCAPED OR HAVE LAWN ESTABLISHED AS INDICATED ON THE LANDSCAPE PLAN.

-ALL LANDSCAPED OR LAWN AREAS SHALL HAVE A MINIMUM OF 6" OF TOPSOIL (EXCLUDING GRASS PAVING AREA).

-SPOT ELEVATIONS SHALL TAKE PRECEDENCE OVER CONTOURS AND SLOPES SHOWN. HOWEVER, THE CONTRACTOR SHALL NOTIFY THE ENGINEER IF SPOT ELEVATIONS DO NOT APPEAR TO AGREE WITH THE CONTOURS AND SLOPES LABELED. SPOT ELEVATIONS AND SPECIFIC PROFILE INFORMATION SHALL BE USED FOR ESTABLISHING THE ELEVATION OF CURBS, DRIVEWAYS, AND OTHER UTILITIES.

-ALL FINISHED GRADING SHALL PROVIDE FOR A SMOOTH TRANSITION TO UNGRADED AREAS.

-ALL PVC STORM SEWER PIPING SHALL BE MINIMUM SDR 35



& Girls Clubs of Greater La Crosse

Workforce Readiness Center Addition

Boy ECT NO:

Life
1331

DRAWING DATE:

09/25/2024


DRAWN BY: C.G.

SET TYPE:
Design Concept

REVISIONS NO. DATE

SHEET TITLE


Grading Plan

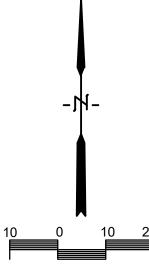

SHEET NO.

C200

Scale: 1" = 20'

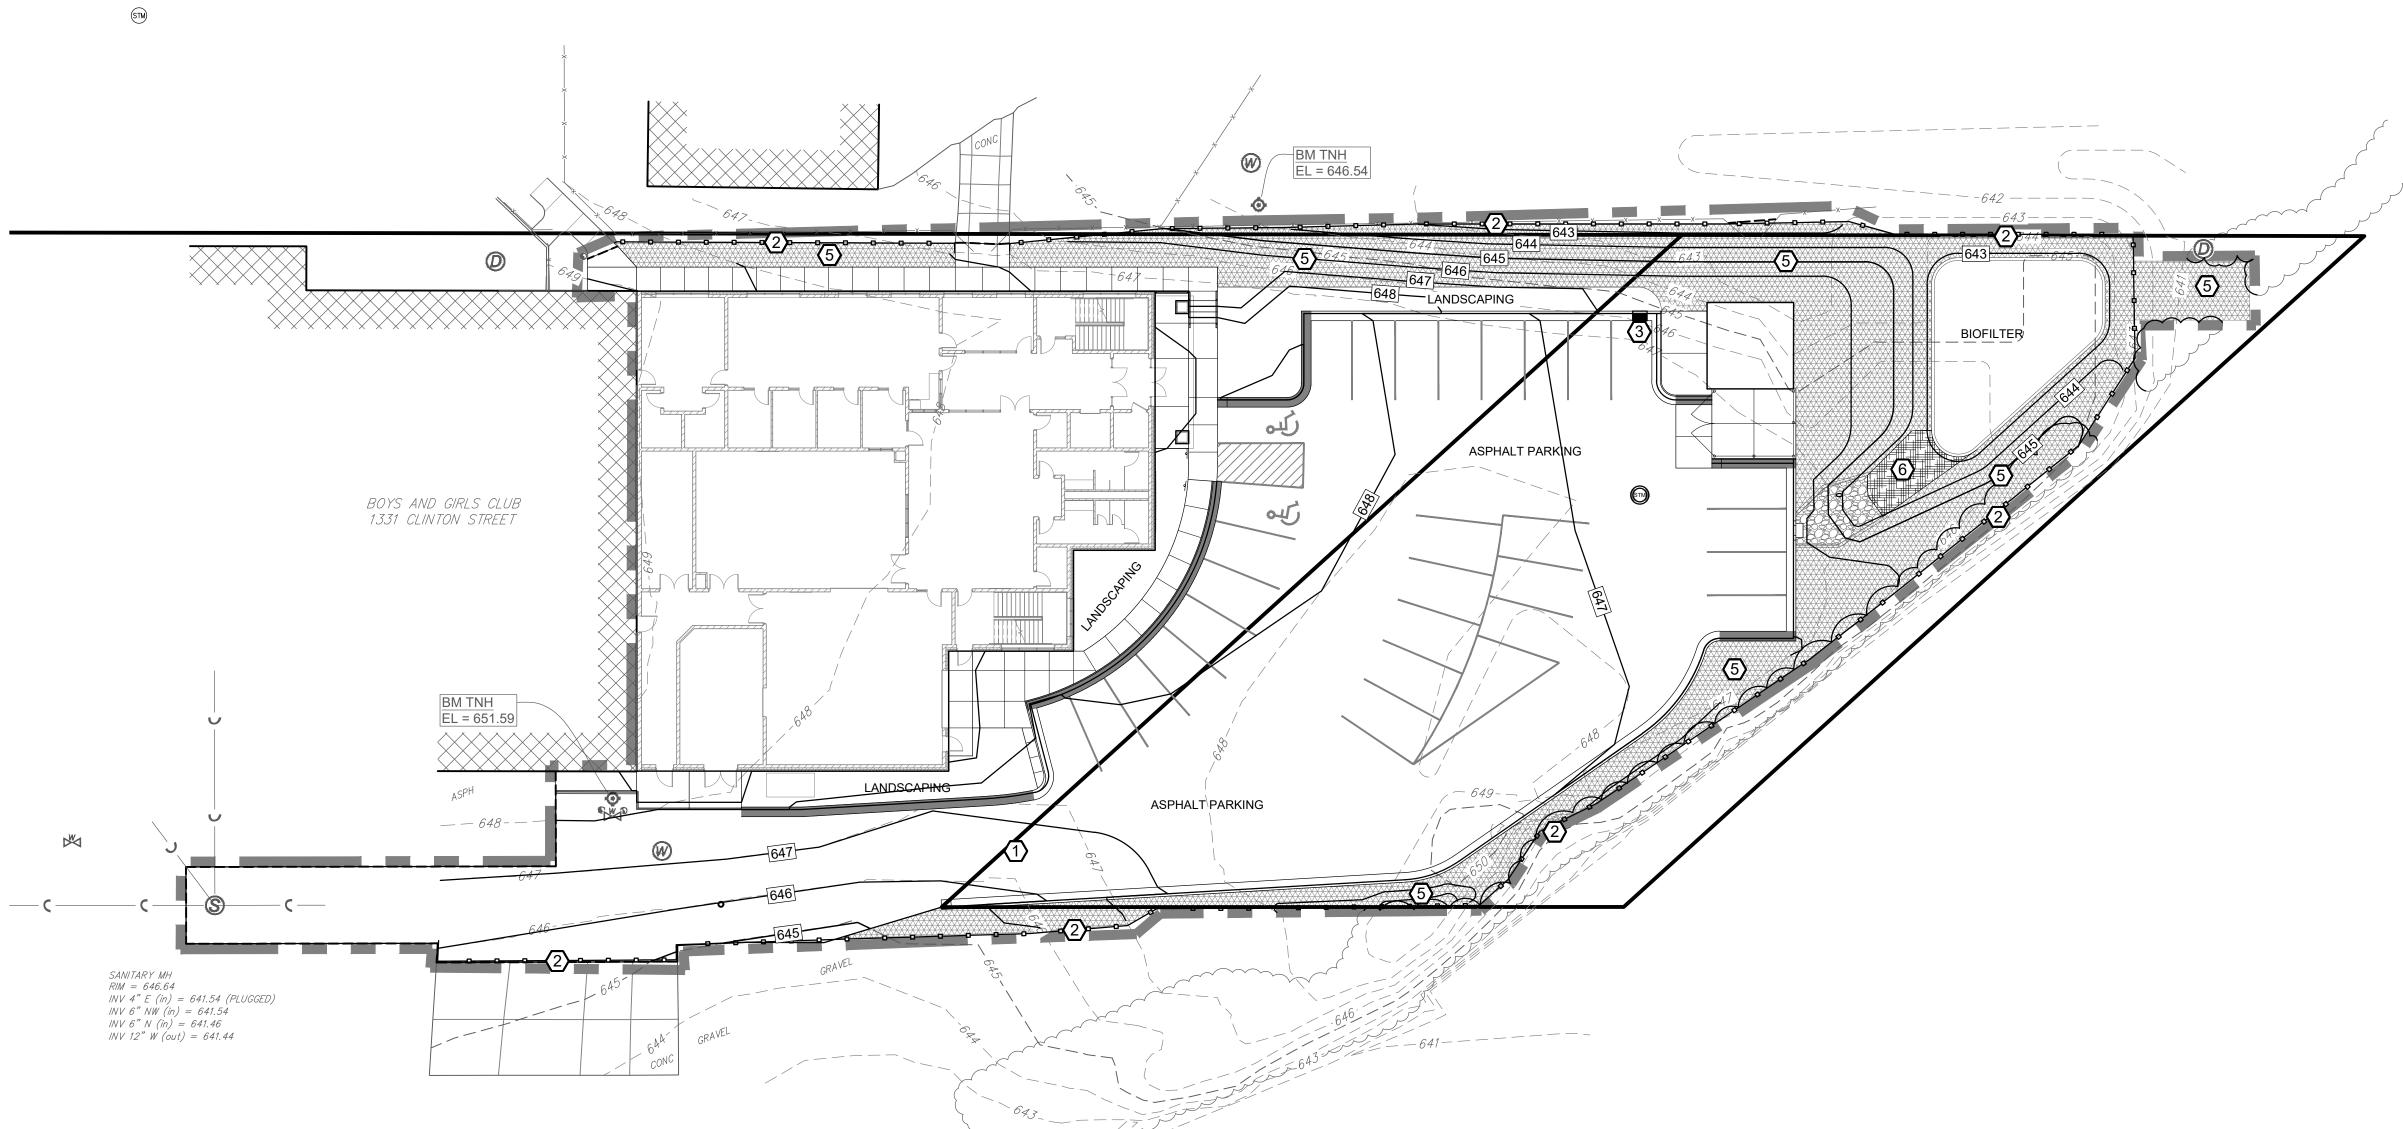

STORM WATER CONSTRUCTION POLLUTION PREVENTION NOTES

SITE CLEARING SHALL APPLY TO ALL AREAS INSIDE LIMITS AS SHOWN ON THE PLANS. REMOVE ALL TREES COMPLETELY AS DIRECTED BY THE OWNER. ANY STRIPPED TOPSOIL SHALL BE STOCKPILED INSIDE THE LIMITS OR PLACED IMMEDIATELY ON SLOPES BEING RESTORED.

SEDIMENT CONTROL STRUCTURES BELOW SEEDED AREAS MUST REMAIN IN PLACE UNTIL THE ENTIRE AREA HAS ESTABLISHED A MATURE COVERING OF HEALTHY VEGETATION.

ALL DISTURBED AREAS SCHEDULED FOR PERMANENT COVER SHALL HAVE TOPSOIL APPLIED, AND BE SEEDED AND MULCHED AS SPECIFIED WITHIN 7 DAYS OF FINAL DISTURBANCE.

MAINTENANCE OF ALL INSTALLED EROSION AND SEDIMENT CONTROL DEVICES SHALL BE THE RESPONSIBILITY OF THE CONTRACTOR AND REMOVED WHEN NO LONGER NECESSARY

MINIMUM MAINTENANCE SHALL CONSIST OF, BUT NOT LIMITED TO:

- INSPECTING ALL EROSION AND SEDIMENT CONTROL DEVICES AFTER EACH RAINFALL.

- FINISHED AREAS THAT HAVE BEEN DAMAGED OR ERODED SHALL BE RESTORED WITHIN THREE DAYS OF THE DAMAGE.

- UNFINISHED AREAS THAT HAVE BEEN DAMAGED OR ERODED SHALL HAVE THE PREVIOUS MEASURE REAPPLIED WITHIN SEVEN DAYS.

- VEHICLE TRACKING CONTROL APRON SHALL BE REMOVED AND REPLACED WHEN VOIDS BECOME FILLED WITH SEDIMENT OR IF SURFACE OPENINGS BECOME PLUGGED SO THAT THE APRON DOES NOT FUNCTION.

- SILT FENCES SHALL BE MAINTAINED IN A FUNCTIONING MANNER. FENCES SHALL NOT BE ALLOWED TO SAG, FALL DOWN, OR BECOME FILLED WITH SILT ON THE BACK SIDE. IF SILT BUILDS UP BEHIND A SILT FENCE, IT SHALL BE REMOVED IMMEDIATELY. UNDER NO CIRCUMSTANCES SHALL SILT DEPOSITS BE ALLOWED TO REACH MORE THAN $\frac{1}{3}$ THE HEIGHT OF THE FENCE.

SILT FENCE SHALL BE PLACED DOWN SLOPE OF ALL SOIL STOCK PILES DURING CONSTRUCTION IF LEFT MORE THAN SEVEN DAYS. STOCK PILES SHALL BE SEEDED AND MULCHED IF LEFT FOR MORE THAN 14 DAYS.

ADDITIONAL EROSION CONTROL FACILITIES MAY BE REQUIRED DUE TO UNFORESEEN SITE CIRCUMSTANCES OR SITE OPERATIONS.

SEDIMENT CONTROL STRUCTURES BELOW LAWN AREAS MAY BE REMOVED ONCE LAWN AND FINAL LANDSCAPING IS IN PLACE. SEDIMENT CONTROL STRUCTURES BELOW SEEDED AREAS MUST REMAIN IN PLACE UNTIL THE ENTIRE AREA HAS ESTABLISHED A MATURE COVERING OF HEALTHY VEGETATION. SEDIMENT CONTROL STRUCTURES IN PAVED AREAS SHALL REMAIN IN PLACE UNTIL PAVING IS COMPLETE.

SEDIMENT DEPOSITED IN ROADS OR RIGHT OF WAY DITCHES ADJACENT TO THIS SITE AS A RESULT OF THIS WORK SHALL BE REMOVED. VEGETATION SHALL BE ESTABLISHED WHEN SEDIMENT REMOVAL DESTROYS THE EXISTING VEGETATION. THE ESTABLISHMENT OF VEGETATION SHALL BE IN THE SAME MANNER AS SPECIFIED FOR SEEDING SPECIFIED ELSEWHERE ON THIS PLAN.

NOTES

- 1 PROVIDE VEHICLE TRACKING CONTROL APRON AT LOCATION WHERE ENTERING AND EXITING THE SITE. SEE DETAIL $\widehat{\mathbb{A}}_{CSG1}$
- 2>SEE DETAIL B FOR SILT FENCE INSTALLATION
- \bigcirc SEE DETAIL \bigcirc C FOR INLET PROTECTION (WITH CURB BOX)
- 4SEE DETAIL FOR INLET PROTECTION (WITHOUT CURB BOX)
- 5 EROSION CONTROL MATTING, SHALL BE CURLEX BY AMERICAN EXCELSIOR OR APPROVED EQUAL. INSTALL TO MANUFACTURER'S RECOMMENDATION.
- 6 EROSION CONTROL MATTING, SHALL BE CURLEX HV BY AMERICAN EXCELSIOR OR APPROVED EQUAL. INSTALL TO MANUFACTURER'S RECOMMENDATION.
- $\overline{7}$ ALL DISTURBED AREAS NOT PROTECTED WITH EROSION CONTROL MATTING SHALL HAVE SOD INSTALLED.
- 8 PROVIDE CONCRETE WASHOUT AREA PER DETAIL 5 . UNDER NO CIRCUMSTANCES SHALL CONCRETE WASHOUT BE ALLOWED IN ANY OTHER LOCATION ON THE SITE.

RCHITECTS | IN

ys & Girls Clubs of Greater La Crosse

e & Workforce Readiness Center Addition

JECT LOCATION:

1 Clinton Street

Crosse, WI 54603

PROJECT NO: **24153**

DRAWING DATE: 09/25/2024


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Design Concept

REVISIONS NO. |DATE

SHEET TITLE


Erosion Control Plan

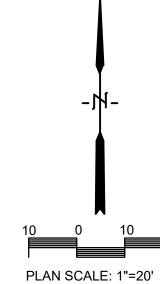

SHEET NO.

C300

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UTILITY NOTES:

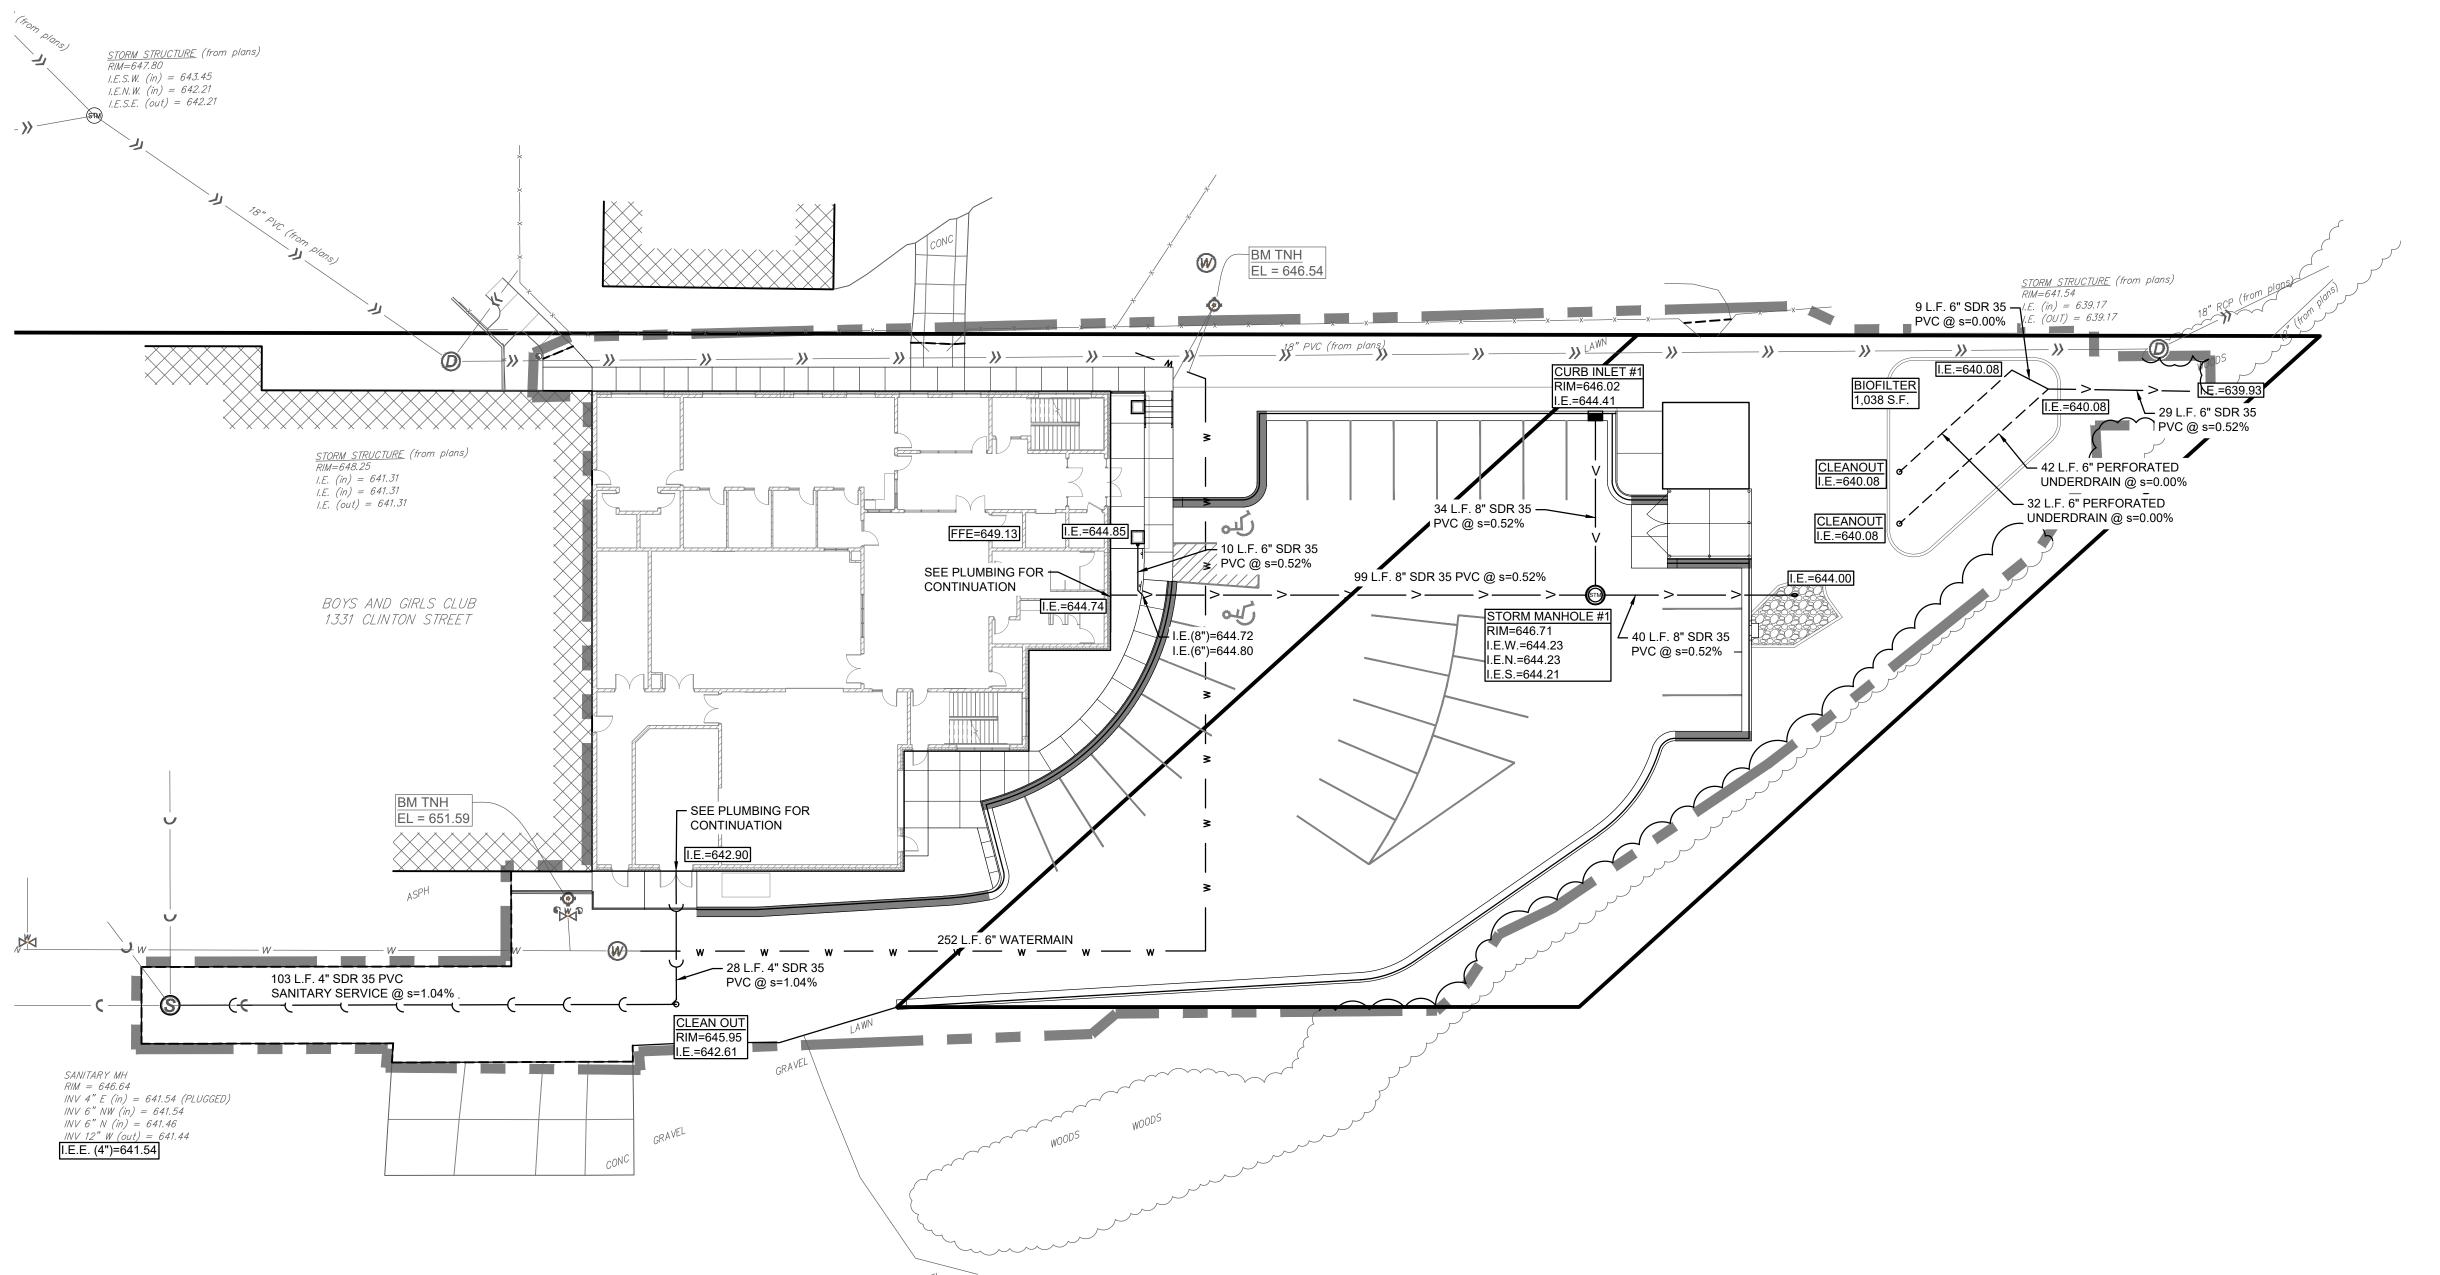ALL WATER & SEWER (STORM & SANITARY) CONSTRUCTION SHALL COMPLY WITH THE LATEST EDITION OF "STANDARD SPECIFICATIONS FOR SEWER & WATER IN THE STATE OF WISCONSIN," ALONG WITH THE CITY OF ONALASKA STANDARD SPECIFICATIONS, AS APPROPRIATE.

SANITARY LATERALS SHALL HAVE A MINIMUM DEPTH 6' BELOW FINISHED FLOOR ELEVATIONS. WATER LATERAL TO HAVE MINIMUM 7.5' COVER. THE CONTRACTOR IS TO COORDINATE ACTIVITIES & CONFIRM LOCATION & ELEVATION OF SERVICES WITH THE ENGINEER.

SUITABLE ON-SITE GRANULAR MATERIAL SHALL BE USED FOR TRENCH BACKFILL TO PROPOSED ELEVATIONS. BACKFILL SHALL BE COMPACTED AS SPECIFIED.

ALL EXISTING INVERTS & LOCATIONS SHALL BE VERIFIED PRIOR TO CONSTRUCTION. ALL DISCREPANCIES FROM INFORMATION SHOWN ON THE PLANS SHALL BE REPORTED TO THE ENGINEER IMMEDIATELY.

CONTRACTOR SHALL IDENTIFY & MARK THE EXACT LOCATIONS OF ALL UNDERGROUND CONNECTIONS TO WATER AND SEWER MAINS, BENDS, CURB BOXES, CLEAN OUTS, ETC. ON THE AS-BUILT PLANS. COPIES OF THESE DOCUMENTS SHALL BE DELIVERED TO THE ENGINEER FOR RECORD.

LOCATION REQUIREMENT: NON-METALLIC SEWER/MAINS AND SERVICES MUST BE PROVIDED WITH TRACE WIRE OR OTHER METHODS IN ORDER TO BE LOCATED.

SHOP DRAWINGS FOR UTILITIES ARE REQUIRED.

ALL SANITARY SERVICES ARE 4" IN DIAMETER.

UTILITY NOTES

1SEE DETAIL FOR DOWNSPOUT

2SEE DETAIL GFOR MANHOLE FOR STORM SEWER 48"

 \bigcirc 3 SEE DETAIL \bigcirc FOR STORM SEWER INLET 3' X 2'

4 SEE DETAIL FOR EXTERIOR CLEAN OUT

 $\langle \overline{5} \rangle$ SEE DETAIL $\overline{\bigcup_{C501}}$ FOR WATER MAIN WET TAP

Girls Clubs of Greater La Crosse

Vorkforce Readiness Center Addition

PROJECT NO:

DRAWING DATE: 09/25/2024

DRAWN BY:

C.G.


SET TYPE:

Design Concept

REVISIONS NO. DATE

SHEET TITLE

Utility Plan

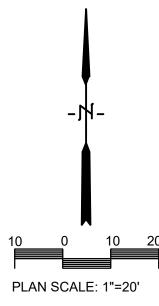

SHEET NO.

C400

Scale: 1" = 20'
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PLAN NOTES: 1. VERIFY UTILITY LOCATION BEFORE BEGINNING ANY WORK. 2. PLANTING BEDS SHALL HAVE 6" TOPSOIL AND 4" OF SHREDDED HARDWOOD BARK MULCH. ALL SHADE TREES IN LAWN AREAS SHALL BE MULCHED WITH 4" SHREDDED HARDWOOD BARK MULCH RING. PROVIDE STEEL EDGING AROUND ALL LANDSCAPE BEDS AS PER PLANS. PROVIDE BELGIAN WALL AND WEDGE BLOCKS AROUND ALL BIOFILTERS AND SPLASH PADS PER PLANS. 3. NEW AND DISTURBED LAWN AREAS SHALL BE RESTORED WITH SEED AND MULCH OR SOD. REFER TO EROSION CONTROL PLAN. 4. MODIFICATIONS TO PLANT SPACING MAY BE ADJUSTED IN THE FIELD BY LANDSCAPE CONTRACTOR. LANDSCAPE ARCHITECT SHALL BE NOTIFIED OF ANY PROPOSED CHANGES TO PLANT MATERIALS OR DESIGN. 5. LANDSCAPE CONTRACTOR SHALL VISIT SITE, INSPECT EXISTING CONDITIONS AND REVIEW PROPOSED PLANTING AND RELATED WORK. 6. THE LANDSCAPE ARCHITECT'S ESTIMATED QUANTITIES ARE SHOWN IN THE MATERIAL LIST-SCHEDULE FOR THE CONVENIENCE OF THE CONTRACTOR ONLY. CONTRACTOR SHALL VERIFY QUANTITIES SHOWN ON THE PLAN AND SHALL RELY ON THE SCHEDULED QUANTITIES AT THEIR OWN RISK. THE CONTRACTOR SHALL INCLUDE IN THE BID ALL PLANTINGS SHOWN ON THE DRAWINGS, WHETHER INCLUDED IN THE SCHEDULE OR NOT PLANT MATERIAL LIST-SCHEDULE (BIOFILTER) BOTANICAL NAME KEY COMMON NAME Echinacea purpurea Purple Coneflower Monarda fistulosa Bergamot Panicum virgatum Switchgrass Rudbeckia fulgida 'Blovi' Tradescantia bracteata Prairie Spiderwort

SIZE

4" pot


4" pot


4" pot


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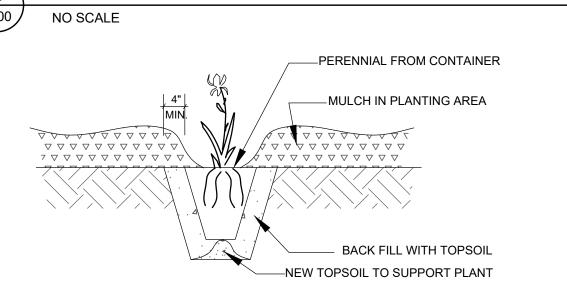
30

27




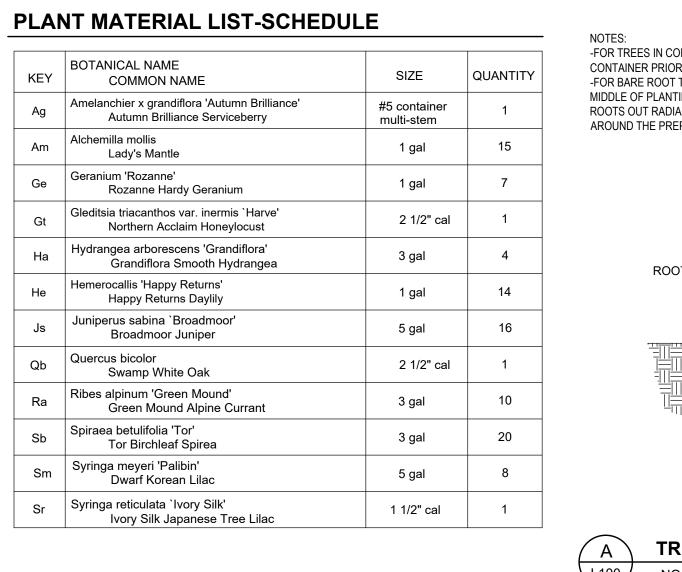

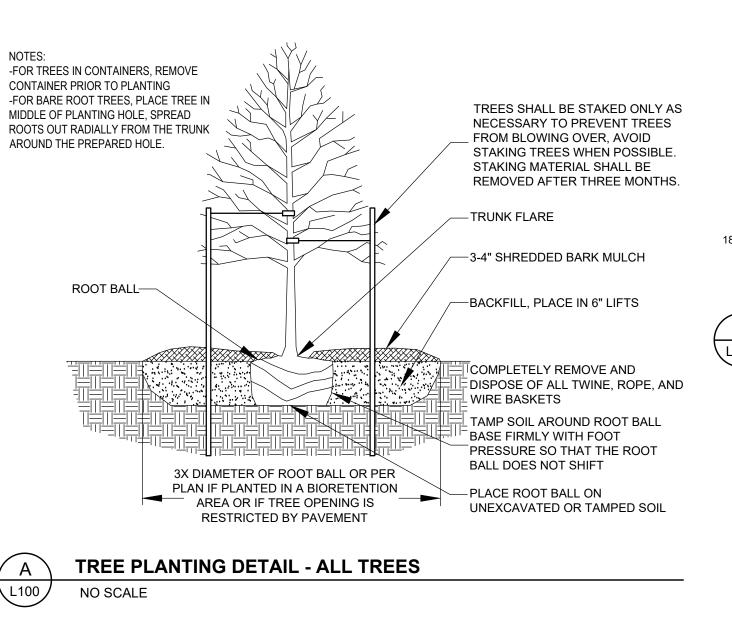

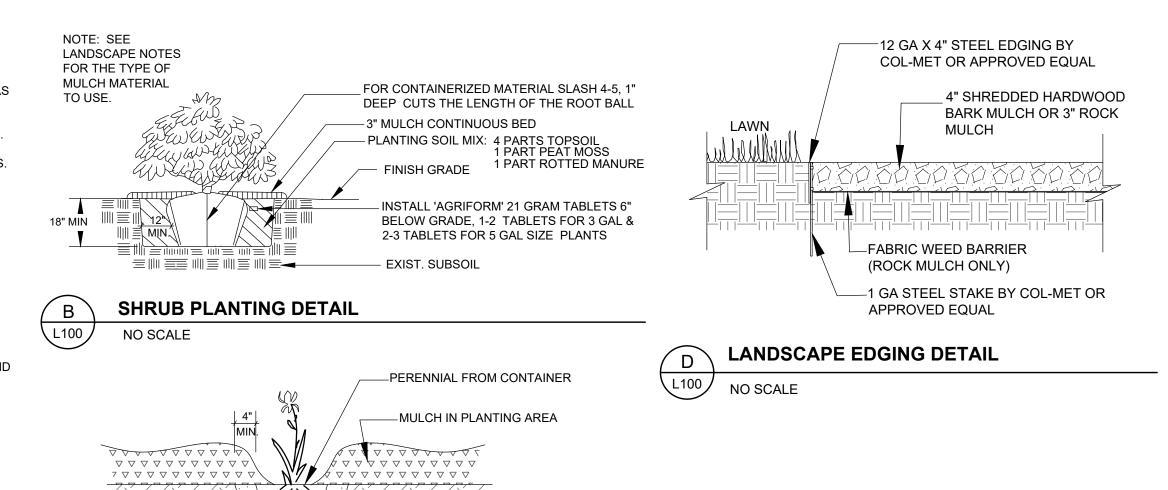

POTTED PLANTS PLANTING DETAIL

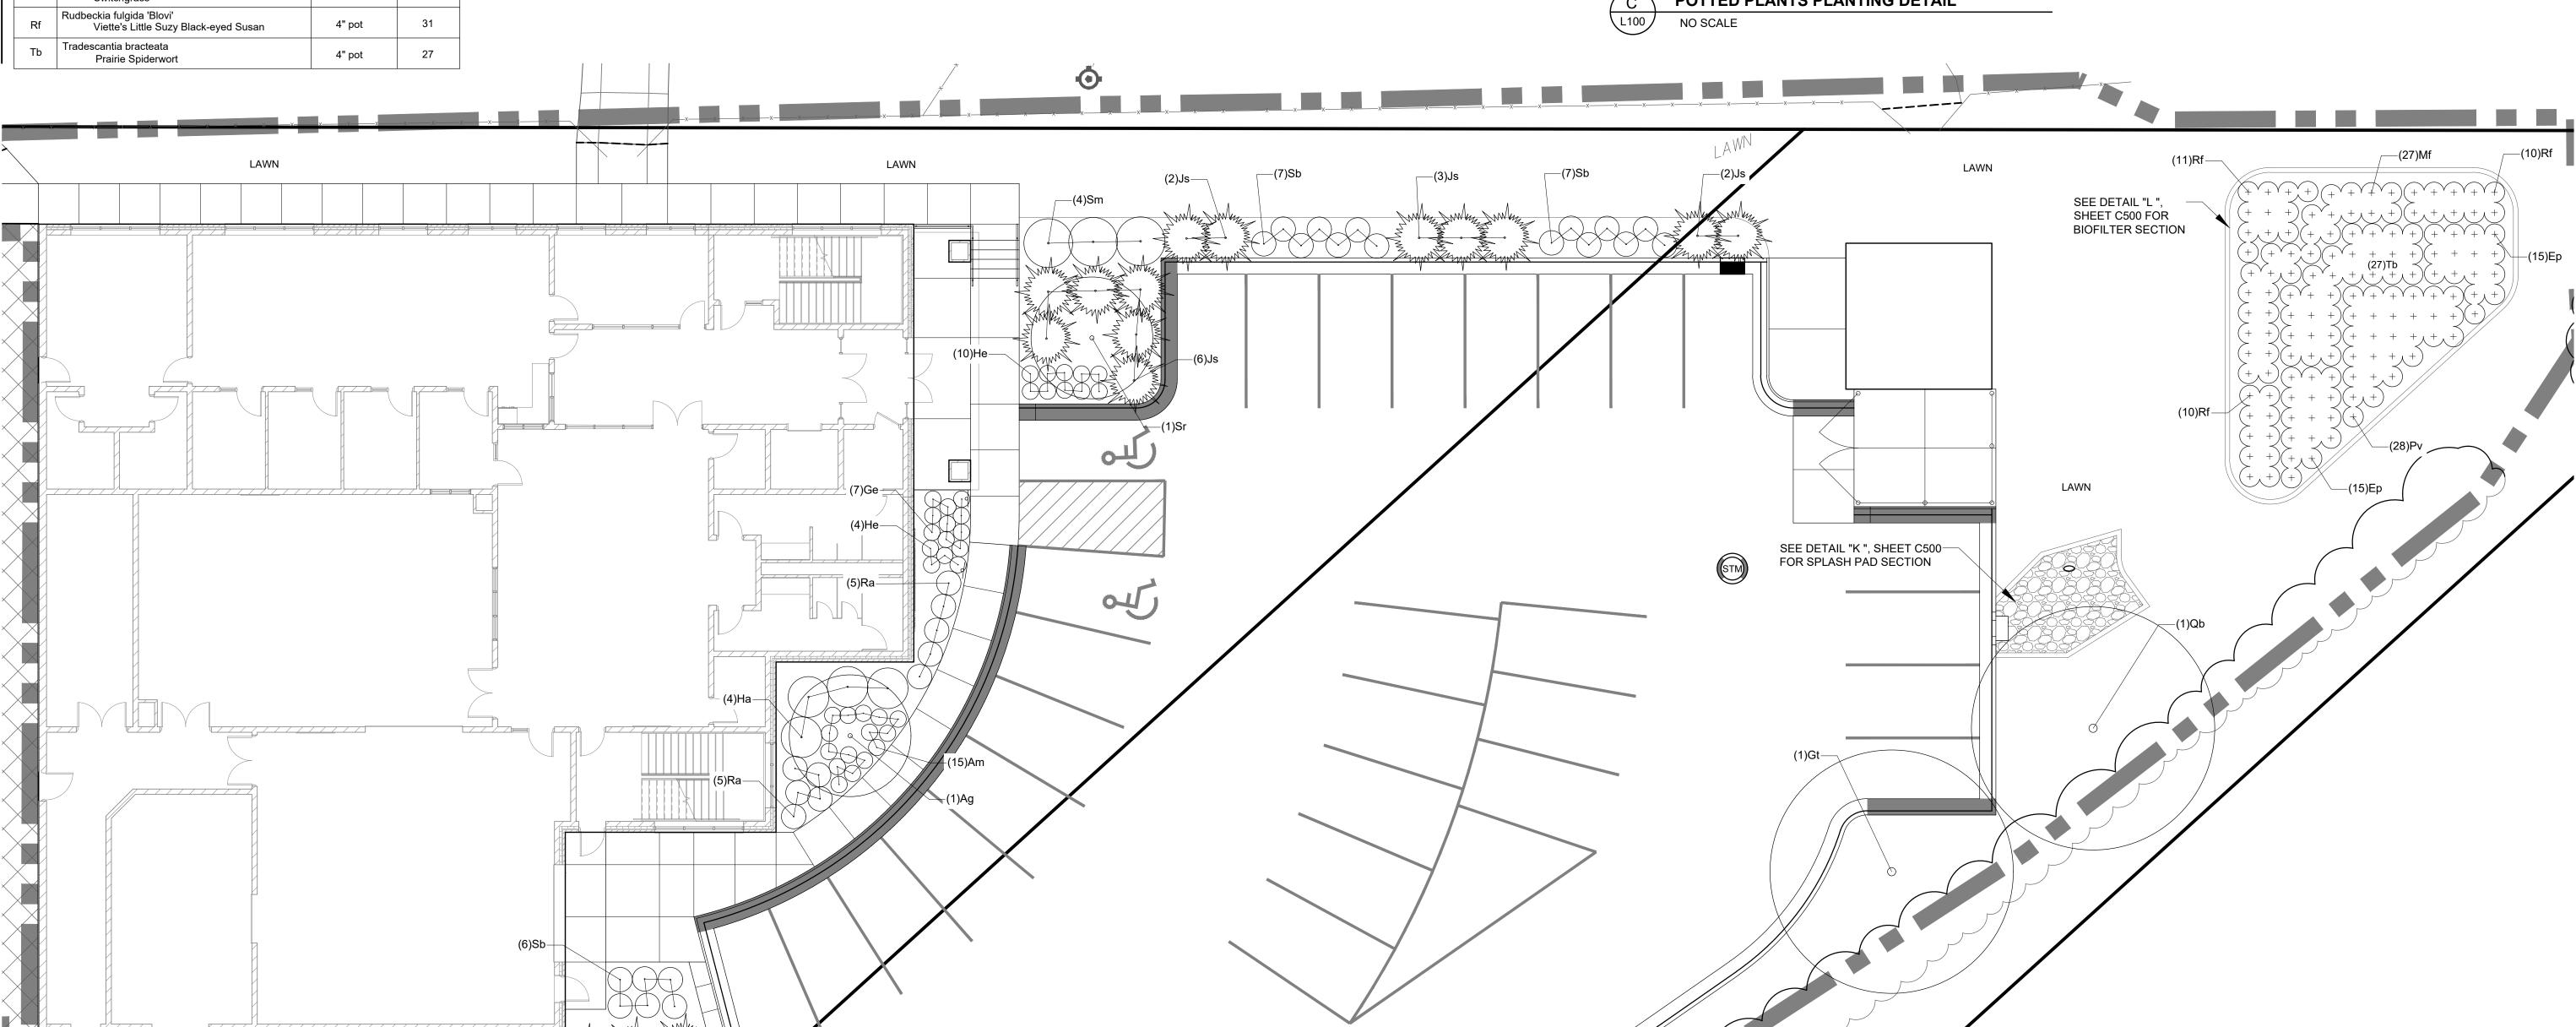

PROJECT NO:

DRAWN BY:

DRAWING DATE:

09/25/2024

C.G. SET TYPE:

Design Concept REVISIONS NO. DATE

SHEET TITLE

Landscape Plan

SHEET NO.



City of La Crosse, Wisconsin

City Hall 400 La Crosse Street La Crosse, WI 54601

Text File

File Number: 24-1317

Agenda Date: 10/4/2024 Version: 1 Status: Agenda Ready

In Control: Commercial/Multi-Family Design Review Committee File Type: Review of Plans

Agenda Number: 2.

NEW BAKERY/SANDWICH SHOP & RESIDENCE for JOSEPH & TRACY ENDRIZZI 1513 MARKET STREET LA CROSSE, WISCONSIN 54601




3D YIEWS FROM MARKET STREET

PRELIMINARY DESIGN REVIEW

SCALE @ 24" X 36" DATE: 09/27/2024

N II N



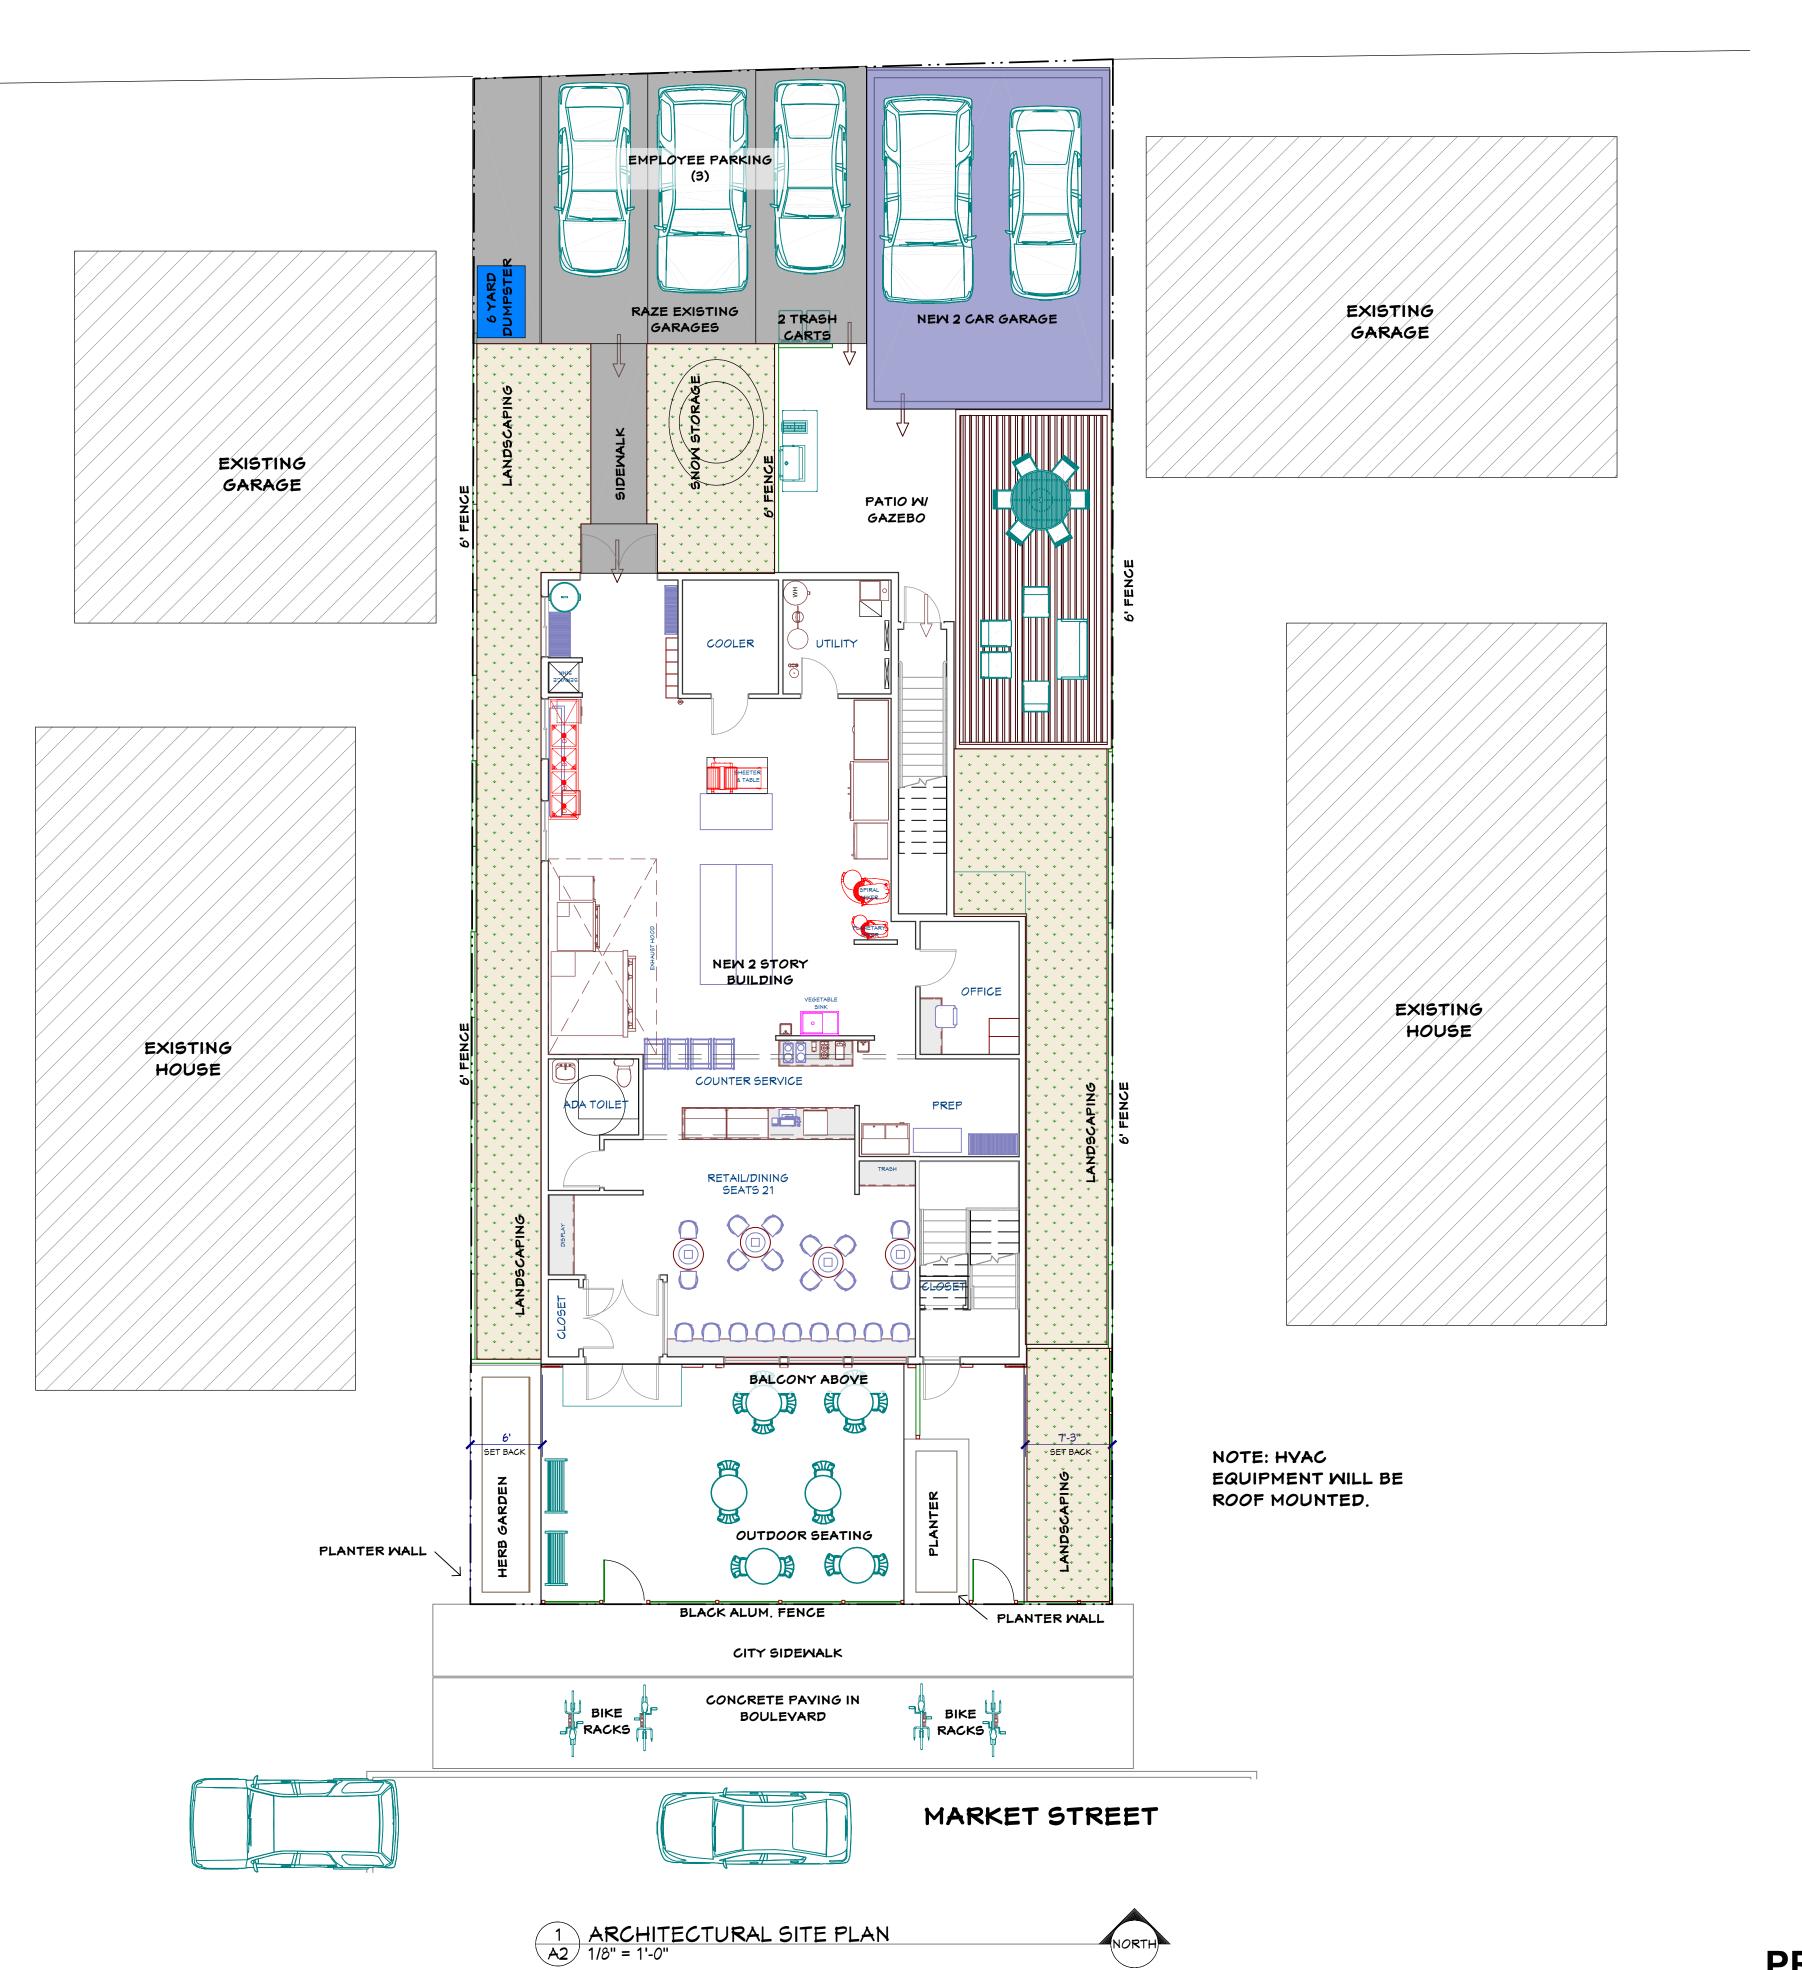

Design Focusion Stle Consin 54650


Ernie Tourville Architect 608-780-1820

NEW BAKERY/SANDWICH SHOP & RESIDENCE for JOSEPH & TRACY ENDRIZZI 1513 MARKET STREET LA CROSSE, WISCONSIN 54601

SCALE @ 24" X 36" DATE: 09/27/2024

SHEET



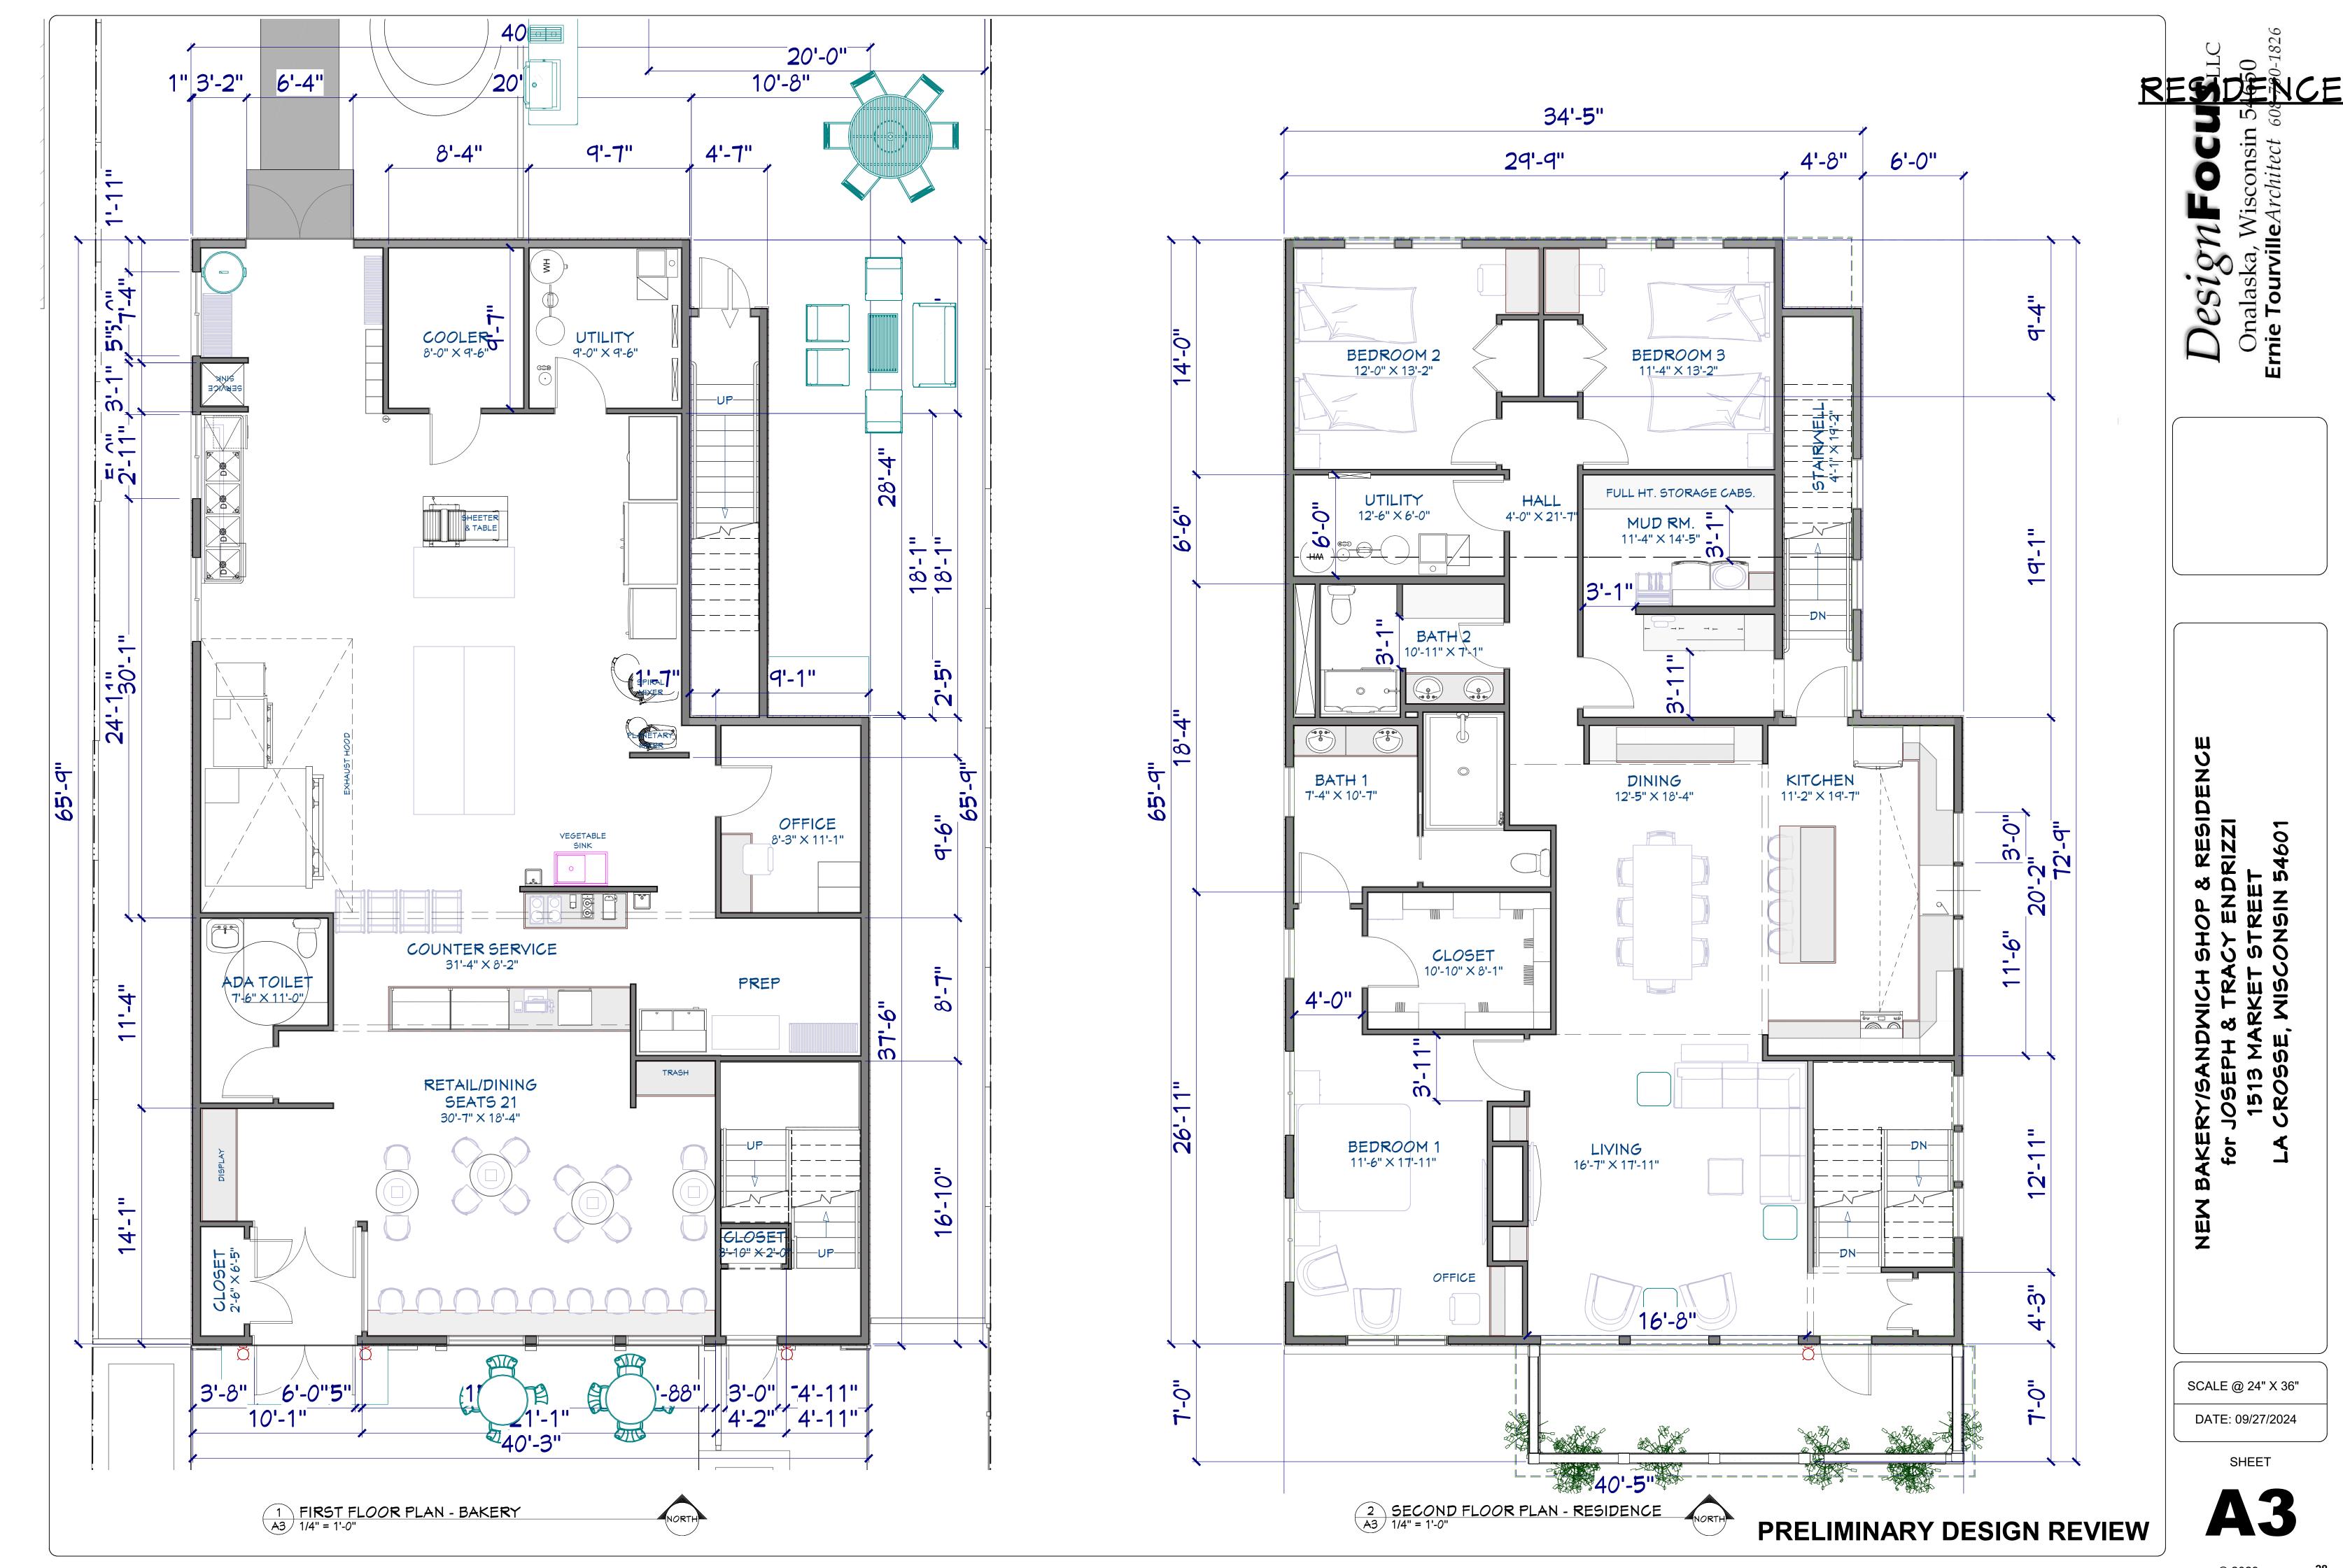

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