

City of La Crosse, Wisconsin

City Hall 400 La Crosse Street La Crosse, WI 54601

Meeting Agenda - Final

Board of Public Works

Monday, June 16, 2025

10:00 AM

Council Chambers
City Hall, First Floor

The Board of Public Works meeting is open for in-person attendance and will also be conducted through video conferencing. The meeting can be viewed by visiting the Legislative Information Center (https://cityoflacrosse.legistar.com/Calendar.aspx) and clicking on the video link to the far right in the meeting list.)

Call to Order

Roll Call

Shaundel Washington-Spivey, Tamra Dickinson, Erin Goggin, Matt Gallager, Andrea Trane.

Approval of Minutes

Minutes from June 9, 2025.

Agenda Items:

<u>25-0101</u>	Bidder's Proof of Responsibility.
<u>25-0672</u>	Finding and Order to amend the traffic control at the intersection of 2nd St S, Jackson St, and Norplex Dr, requiring southbound traffic to stop.
<u>25-0674</u>	Metronet Street Privilege Permit request for communications in right-of-way in the area bound by Badger St, 10th St, and 6th St.
<u>25-0675</u>	Metronet Street Privilege Permit request for communications in the right-of-way from 10th St S to Division St.
<u>25-0676</u>	Charter Communications Street Privilege Permit request for communications in right-of-way near 3939 County Rd B.
<u>25-0677</u>	Brightspeed Street Privilege Permit request for communications in right-of-way near 2525 Shelby Rd.
<u>25-0678</u>	Brightspeed Street Privilege Permit request for communications in right-of-way near 3910 Mormon Coulee Rd.
<u>25-0679</u>	Xcel Energy Street Privilege Permit request to renew gas main services along the 300 & 200 blocks of Caledonia St.

Adjournment

Notice is further given that members of other governmental bodies may be present at the above scheduled meeting to gather information about a subject over which they have decision-making responsibility.

NOTICE TO PERSONS WITH A DISABILITY

Requests from persons with a disability who need assistance to participate in this meeting should call the City Clerk's office at (608) 789-7510 or send an email to ADAcityclerk@cityoflacrosse.org, with as much advance notice as possible.



City of La Crosse, Wisconsin

City Hall 400 La Crosse Street La Crosse, WI 54601

Text File

File Number: 25-0101

Agenda Date: 6/16/2025 Version: 1 Status: Agenda Ready

In Control: Board of Public Works File Type: General Item



City of La Crosse, Wisconsin

City Hall 400 La Crosse Street La Crosse, WI 54601

Text File

File Number: 25-0672

Agenda Date: 6/16/2025 Version: 1 Status: Agenda Ready

In Control: Board of Public Works File Type: Finding & Order



From the Offices of the Traffic Engineer and the Chief of Police City Hall

CITY OF LA CROSSE BOARD OF PUBLIC WORKS Findings & Orders:

June 11, 2025				
() ESTABLISHING		(X) AMENDING	() VACATING	
TYPE OF ALTERATI	ON: STOP Contro	ol, requiring Southbound traffic t	o STOP	
GENERAL LOCATIO	N: Intersection of	2 nd Street South, Jackson Stree	et and Norplex Drive	
Report:				
Street and Norplex I recommended to am	Drive, which is cu end the North-faci	affic control at the intersection of rrently yield to Westbound and ing yield to a STOP sign, requidance to users of the intersection	I Southbound traffic. It is ring Southbound traffic to	
after obtaining a rep	WHEREAS, Section 44-39 of the City of La Crosse Municipal Code of Ordinances provides that after obtaining a report and recommendation of the Traffic Engineer, the Chief of Police shall forward recommendations and appropriate orders to the Board of Public Works.			
		raffic Engineer state the public in rders the above traffic alteration		
 STOP sign at 	2 nd Street South,	Jackson Street and Norplex Driv	ve as defined above.	
•	-	lic Works hereby approves the a prized to effect said changes.	aforementioned traffic	
Matthew A. Gallage Director of Enginee		orks	Shawn Kudron Chief of Police	
Date Filed: BPW Approval:	2025-06-11 ———————————————————————————————————		Presiding Officer	



City of La Crosse, Wisconsin

City Hall 400 La Crosse Street La Crosse, WI 54601

Text File

File Number: 25-0674

Agenda Date: 6/16/2025 Version: 1 Status: Agenda Ready

In Control: Board of Public Works File Type: General Item

TASK NAME: CITY HALL

TASK DESCRIPTION: FIBER OPTIC CONDUIT PLACEMENT


SITE LOCATION: LACROSSE, WI

metronet

3701 COMMUNICATIONS WAY
FVANSVILLE IN 477.15



1100 E. WOODFIELD ROAD, SUITE 500 SCHAUMBURG, ILLINOIS 60173 TEL: 847-908-8400 COA# 3620-11

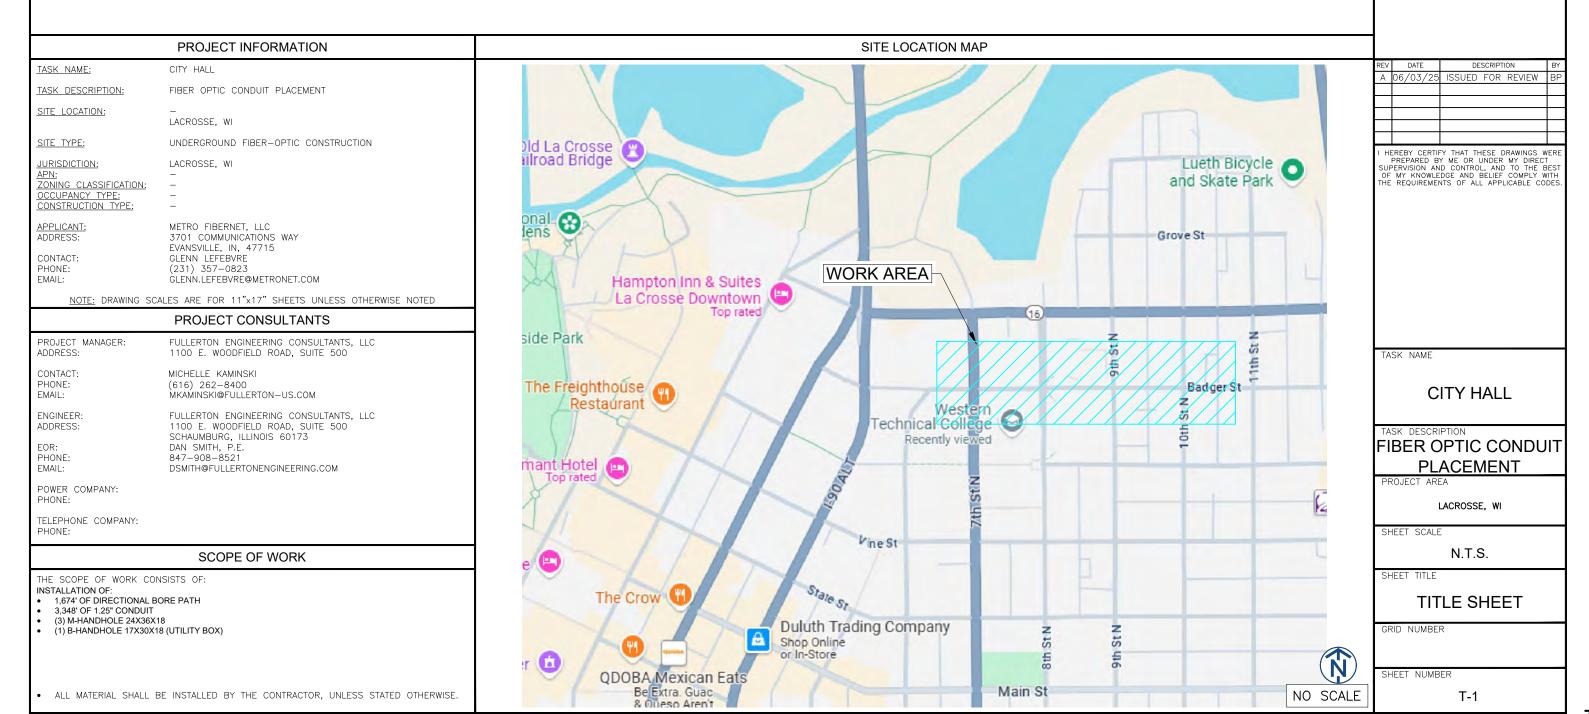

SHEET NUMBER	SHEET TITLE
T-1	TITLE SHEET
T-2	SHEET INDEX
T-3	LEGEND
GN-1	GENERAL NOTES
MAP-1	PLANSET
C-001	DESIGN LAYOUT
C-002	DESIGN LAYOUT
C-003	DESIGN LAYOUT
C-004	DESIGN LAYOUT
D-1	DETAILS
D-2	DETAILS
D-3	DETAILS
D-4	DETAILS
TCP-1	TRAFFIC CONTROL STANDARD



3701 COMMUNICATIONS WAY EVANSVILLE, IN, 47715



1100 E. WOODFIELD ROAD, SUITE 500 SCHAUMBURG, ILLINOIS 60173 TEL: 847-908-8400 COA# 3620-11 www.fullerton-us.com

REV	DATE	DE	DESCRIPTION		
Α	06/03/25	ISSUED	FOR	REVIEW	BP

I HEREBY CERTIFY THAT THESE DRAWINGS WERE PREPARED BY ME OR UNDER MY DIRECT SUPERVISION AND CONTROL, AND TO THE BEST OF MY KNOWLEDGE AND BELIEF COMPLY WITH THE REQUIREMENTS OF ALL APPLICABLE CODES.

TASK NAME

CITY HALL

TASK DESCRIPTION

FIBER OPTIC CONDUIT PLACEMENT

PROJECT AREA

LACROSSE, WI

SHEET SCALE

N.T.S.

SHEET TITLE

SHEET INDEX

GRID NUMBER

SHEET NUMBER

T-2

LEGEND

metronet
3701 COMMUNICATIONS WAY EVANSVILLE, IN, 47715

Fullerten DESIGN DEVELOP CONSTRUCT

1100 E. WOODFIELD ROAD, SUITE 500 SCHAUMBURG, ILLINOIS 60173 TEL: 847-908-8400 COA# 3620-11

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LEGEND

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SHEET TITLE

SHEET NUMBER

T-3

	PROPOSED				<u>cc</u>
	PROPOSED OPEN CUT TRENCH	В	PROPOSED B-UTILITY BOXES(17X30X18)	TTATTA	EXISTING AT&T
	PROPOSED DIRECTIONAL BORE	TB	PROPOSED TERMINAL BOXES(13X24X15)	——————————————————————————————————————	EXISTING AT&T (ABANDON)
	PROPOSED BORE PIT	D8	PROPOSED DROP BOXES(11X11X12)	ooo	EXISTING COMMUNICATIONS
LHH	PROPOSED L-HANDHOLE(30X48X24)			MCI MCI MCI	EXISTING MCI
HH	PROPOSED M-HANDHOLE(24X36X18)			SPSP	EXISTING SPRINT
					EXISTING SUNESYS
	SEWER				EXISTING VERIZON
<u> </u>	EXISTING SEWER MAIN	S	EXISTING SEWER MANHOLE	- UF	EXISTING CITY FIBER
	EXISTING SEWER MAIN (ABANDON)	(1)	EXISTING SEWER CATCH BASIN		
>>	EXISTING STORM SEWER MAIN		EXISTING SEWER INLET		
	EXISTING STORM MANHOLE				<u>N</u>
				xxx	EXISTING FENCE
	WATER				EXISTING CONSTRUCTION FENC
	EXISTING WATER MAIN	W	EXISTING WATER MANHOLE		EXISTING GUARDRAIL
	EXISTING WATER MAIN (ABANDON)	⊗	EXISTING WATER VALVE		EXISTING PROPERTY LINE/ R.O.V
*50	EXISTING WATER SHUT OFF	•	EXISTING WATER METER	(——)	EXISTING BIKE RACK
(F)	EXISTING FIRE CISTERN MANHOLE	.	EXISTING FIRE HYDRANT		EXISTING TREE
Ē	EXISTING WATER CAP	▶	EXISTING WATER REDUCER		EXISTING BUSH
					EXISTING STREET SIGN POST
	GAS			₿	EXISTING POST/BOLLARD
	EXISTING GAS MAIN	\bigotimes	EXISTING GAS MANHOLE	¤	EXISTING GROUND LIGHT
——————————————————————————————————————	EXISTING GAS MAIN (DEAD)	⊗	EXISTING GAS VALVE	~	EXISTING UTILITY POLE
q	EXISTING GAS CAP	\boxtimes	EXISTING GAS METER	Ω	EXISTING ADA DAMP
\triangleright	EXISTING GAS REDUCER			ADA	EXISTING ADA RAMP
	DEO/ELECTRIC				
ЕЕ	EXISTING DEO/ELECTRIC	\	EXISTING STREET LIGHT POLE		
SLC	EXISTING STREET LIGHT CONTROL BOX	- \$\psi_	EXISTING TRAFFIC LIGHT POLE		
TLC	EXISTING TRAFFIC LIGHT CONTROL BOX	· Ø -	EXISTING DEO POLE		
	EXISTING STREET LIGHT HANDHOLE	E	EXISTING ELECTRIC MANHOLE		
T	EXISTING TRAFFIC LIGHT HANDHOLE	0	EXISTING ELECTRIC HANDHOLE		
	EXISTING RED LIGHT CAMERA POLE	Ē	EXISTING RED LIGHT FLASH POLE		

-UF	EXISTING CITY FIBER		
	MISCELLANEOUS		
xxx	EXISTING FENCE	(?)	EXISTING MISCELLANEOUS MANHOLE
	EXISTING CONSTRUCTION FENCE	G	EXISTING GARBAGE CAN
	EXISTING GUARDRAIL	(P)	EXISTING PARK DISTRICT MANHOLE
	EXISTING PROPERTY LINE/ R.O.W.	M	EXISTING MONITORING WELL
←	EXISTING BIKE RACK	F	EXISTING FIRE ALARM
	EXISTING TREE	P	EXISTING STREET PARKING PAY BOX
	EXISTING BUSH		EXISTING PEDESTAL
- o-	EXISTING STREET SIGN POST	M	EXISTING MAILBOX
®	EXISTING POST/BOLLARD	N	EXISTING NEWSPAPER BOX
¤	EXISTING GROUND LIGHT		EXISTING PHONE
r\O_*	EXISTING UTILITY POLE	S	EXISTING SPRINKLER CONTROL BOX
Ω	EXISTING STANDPIPE	S	EXISTING SPRINKLER VALVE
ADA	EXISTING ADA RAMP	H	EXISTING SUPPORT COLUMN

COMMUNICATIONS

A

<u>CO</u>

MC

(SP)

(SN)

(VZ)

EXISTING AT&T MANHOLE

EXISTING MCI

EXISTING COMMUNICATIONS MANHOLE

EXISTING SPRINT/NEXTEL MANHOLE

EXISTING SUNESYS MANHOLE

EXISTING VERIZON MANHOLE

- THE ENCLOSED DESIGN MAY IMPLY EXISTING UTILITIES. THE UTILITIES HAVE NOT BEEN FIELD VERIFIED FOR LOCATION. THEREFORE, ALL UTILITIES IMPLIED WITHIN THIS DOCUMENT ARE TO BE REFERRED TO AS A "REFERENCE TOOL". IT IS THE RESPONSIBILITY OF THE GENERAL CONTRACTOR AND/OR IT'S SUBCONTRACTOR TO VERIFY THESE UTILITIES USING ANY AND ALL METHODS AND INSTRUMENTS AVAILABLE IF/WHEN NECESSARY, FULLERTON CANNOT IN GOOD FAITH GUARANTEE UTILITY LOCATIONS. ANY AND ALL DOCUMENTATION ON EXISTING UTILITIES HAS BEEN IMPLIED UTILIZING INFORMATION RETRIEVAL PROCESSES FROM EACH JURISDICTION INVOLVED (STATE, COUNTY AND/OR MUNICIPALITY, TO INCLUDE OTHERS).
- 2. IT IS THE RESPONSIBILITY OF THE GENERAL CONTRACTOR TO ENSURE ALL CONDUITS ARE PLACED WITHIN THE GIVEN & DEDICATED SPACE LICENSED FOR THIS PARTICULAR CLIENT. FULLERTON ENGINEERING CONSULTANTS, INC. (FULLERTON) WAS NOT RETAINED FOR THE PURPOSE OF SUPPORTING A SURVEY OF THE AREA AND PROPERTY BOUNDARIES, THEREFORE FULLERTON CAN NOT AND WILL NOT SUPPORT THE ACCURACY OF ANY IMPLIED BOUNDARY (I.E. PUBLIC WAY, PRIVATE PROPERTY, EASEMENT ETC.) NOR IS IT TO BE ASSUMED THAT THE SALE OF PROPERTIES HAS NOT OCCURRED DURING & AFTER FULLERTON'S RESPONSIBILITIES FOR THIS PROJECT HAVE PAST. ALL BOUNDARIES, EASEMENTS, PROPERTY LINES, ETC. ARE TO BE USED AS A GUIDELINE OR REFERENCE AND SHOULD NOT BE TAKEN LITERALLY, IT IS THE CONTRACTOR'S RESPONSIBILITY TO HAVE ASSOCIATED BOUNDARIES SURVEY STAKED IF SO QUESTIONED. ALL ASPECTS OF BOUNDARIES IMPLIED HEREIN, HAVE BEEN DERIVED THROUGH AVAILABLE MEDIA SUCH AS BUT NOT LIMITED TO (SIDWELL, GOOGLE EARTH PRO, MUNICIPAL, STATE, COUNTY, GIS, AND OTHER RECORD TYPES). FULLERTON DOES NOT AGREE NOR DISAGREE WITH THE ABOVE-MENTIONED RECORDS AS THEY ARE USED JUST A REFERENCE TOOL
- ALL BURIED OBSTRUCTIONS KNOWN BY FULLERTON ARE SHOWN ON THE CONSTRUCTION DRAWINGS. ANY AND ALL OTHERS ENCOUNTERED DURING CONSTRUCTION ARE THE RESPONSIBILITY OF THE CONTRACTOR TO LOCATE AND PROTECT.
- CONTRACTOR IS RESPONSIBLE FOR LOCATING ALL UTILITIES 48 HOURS PRIOR TO CONSTRUCTION ACTIVITY
- SHORING MAY BE REQUIRED AND SHALL COMPLY TO O.S.H.A. STANDARDS.
- ALL BURIED CONDUIT/CABLE WILL BE PLACED AT 30-48" MINIMUM COVER UNLESS SPECIFIED OR OTHERWISE NOTED ON THE CONSTRUCTION DRAWINGS
- ANY AND ALL IMPROVEMENTS, IF DAMAGED, SHALL BE RESTORED TO ORIGINAL OR BETTER CONDITION. THIS INCLUDES BUT IS NOT LIMITED TO: ASPHALT, CONCRETE PAVEMENT, CURBS, GUTTERS, SIDEWALKS, DRAINAGE DITCHES, EMBANKMENTS, SHRUBS, TREES GRASS SOD ETC
- ALL FIBER INSTALLATIONS SHALL OBSERVE A MINIMUM DYNAMIC BEND RADIUS OF 20X THE CABLE DIAMETER FOR ALL OSP FIBER SHEATHS AND 15X THE CABLE DIAMETER FOR ALL ISP FIBER SHEATHS. ADDITIONALLY, ALL INSTALLATIONS SHALL OBSERVE A MINIMUM STATIC BEND RADIUS OF 15X THE CABLE DIAMETER FOR ALL OSP FIBER SHEATHS AND 10X THE CABLE DIAMETER FOR ALL ISP FIBER SHEATHS. IF THE MANUFACTURER'S SPECIFICATIONS FOR BEND RADIUS ARE GREATER. THEN THEY SHALL BE FOLLOWED.
- ALL NEW METALLIC AERIAL STRAND SHALL BE BONDED/GROUNDED (PREFERABLY TO THE POWER COMPANY NEUTRAL) PER LOCAL REQUIREMENTS. AT A MINIMUM, THE BONDING/GROUNDING PATTERN SHALL BE THE FIRST AND LAST POLE OF A RUN AND EVERY TENTH POLE IN THE RUN. SHOULD ONE OF THESE DESIGNATED POLES SUPPORT A POWER TRANSFORMER, THE POLES ON EITHER SIDE OF SAID POLE SHALL BE BONDED/GROUNDED AND THE PATTERN SHOULD CONTINUE EVERY TENTH POLE FROM THAT STARTING POINT.
- 10. ALL AERIAL FIBER OPTIC CABLES SHALL BE SECURELY LASHED TO AERIAL STRAND BY METHOD OF MECHANICAL LASHING CARRIAGE OR APPROVED EQUAL.
- 11. ALL FIBER OPTIC CABLES INSTALLED BELOW GRADE SHALL BE OF AN ARMORED VARIETY WITH METALLIC INNER SHEATH, OR BE PLACED WITH A METALLIC LOCATING WIRE TO FACILITATE FUTURE LOCATING SERVICES.
- 12. ALL CONDUIT OR DUCT CONSTRUCTION SHALL INCLUDE THE PLACEMENT OF PULLING TAPE OF SUFFICIENT SIZE AND GRADE TO FACILITATE THE INSTALLATION OF THE SPECIFIED FIBER TYPE THROUGH CONDUIT BEING UTILIZED (JETLINE USE TO BE APPROVED BY CLIENT)
- 13. ALL FUSION SPLICING SHALL BE COMPLETED BY A QUALIFIED FIBER SPLICER IN A CLEAN TEMPERATURE CONTROLLED TRUCK, TRAILER, OR SHELTER SPECIFICALLY TOOLED OR DESIGNED FOR THE PURPOSE OF FUSION SPLICING FIBER OPTIC CABLES IN A FIFI D ENVIRONMENT
- 14. ALL MECHANICAL SPLICES AND FACTORY ENDS SHALL BE KEPT CLEAN AND FREE FROM DUST, DIRT, OILS, AND SMEARS. CARE SHOULD BE TAKEN TO MATCH POLISH TYPES ON FACTORY ENDS.
- 15. CONTRACTOR SHALL BE RESPONSIBLE FOR ANY AND ALL CORRECTIONS TO WORK IDENTIFIED AS UNACCEPTABLE BY CLIENT, ENGINEER, OR INSPECTOR, DURING SITE INSPECTION ACTIVITIES AND/OR AS A RESULT OF TESTING, CONTRACTOR SHALL ALSO PROVIDE ALL AS-BUILT INFORMATION UPON COMPLETION OF INSPECTION.
- 16. CONTRACTOR SHALL KEEP THE SITE FREE FROM ACCUMULATING WASTE MATERIAL, DEBRIS, AND TRASH. AT THE COMPLETION OF THE WORK, CONTRACTOR SHALL REMOVE FROM THE SITE ALL REMAINING RUBBISH, IMPLEMENTS, TEMPORARY FACILITIES, AND SURPLUS MATERIALS. CONTRACTOR TO RETURN SITE TO PREVIOUS OR BETTER CONDITION.
- 17. DRAWINGS ARE INTENDED TO SHOW DESIGN INTENT. CONTRACTOR SHALL PROVIDE MATERIALS AND LABOR AS REQUIRED TO PRODUCE A COMPLETE AND FUNCTIONING SYSTEM WHILE MEETING ALL CODES AND SPECIFICATIONS. MODIFICATIONS MAY BE REQUIRED TO SUIT JOB DIMENSIONS OR CONDITIONS. SUCH MODIFICATIONS SHALL BE INCLUDED IN THE WORK. SAID DESIGN IS INTENDED TO AVOID DISRUPTION OF ANY HANDICAP RAMPS OR STRUCTURES AS DESCRIBED PER THE AMERICANS WITH DISABILITIES ACT OF 1990.

- 18. CONTRACTOR SHALL WORK WITH CLIENT TO IDENTIFY ALL CONTRACTOR SUPPLIED MATERIALS TO CONSTRUCT NETWORK PER SPECIFICATIONS.
- 19. THE CONTRACTOR SHALL PROVIDE ALL MATERIAL, EQUIPMENT, LABOR, INSTALLATION, RESTORATION, UTILITY RELOCATION CHARGES, JOB SITE DELIVERY COSTS AND INCIDENTALS TO COMPLETE THE DESCRIBED OR ILLUSTRATED WORK UNDER THIS CONTRACT.
- 20. ANY CHANGE-ORDER REQUEST MUST BE PRESENTED IN WRITING TO THE OWNER'S REPRESENTATIVE AND APPROVED PRIOR TO PROCEEDING WITH THE REQUESTED CHANGE.
- 21. THE ENGINEER WILL NOT BE RESPONSIBLE NOR ASSUME ANY LIABILITY FOR NEGLIGENT ACTS OR ERRORS OF OMISSIONS OF ANY CONTRACTOR, ANY SUBCONTRACTOR, OR ANY OF THE PERSONS (EXCEPT ENGINEER'S OWN EMPLOYEES) AT THE PROJECT SITE OR OTHERWISE PERFORMING ANY OF THE WORK OF THE PROJECT. ANY CONTRACTOR OR SUBCONTRACTOR, AS WELL AS THE ENGINEER, WILL BE RESPONSIBLE FOR HIS OWN SAFETY PROGRAM. NEITHER THE PROFESSIONAL ACTIVITIES OF THE ENGINEER, NOR THE PRESENCE OF THE ENGINEER OR HIS OR HER EMPLOYEES AND SUB-CONSULTANTS AT THE CONSTRUCTION SITE, SHALL RELIEVE ANY CONTRACTOR OF HIS OR HER OBLIGATIONS, DUTIES AND RESPONSIBILITIES INCLUDING, BUT NOT LIMITED TO, CONSTRUCTION MEANS, METHODS, SEQUENCE, TECHNIQUES OR PROCEDURES NECESSARY FOR PERFORMING, SUPERINTENDING OR COORDINATING ALL PORTIONS OF THE WORK OF CONSTRUCTION IN ACCORDANCE WITH THE CONTRACT DOCUMENTS AND ANY HEALTH OR SAFETY PRECAUTIONS REQUIRED BY ANY REGULATORY AGENCIES. THE ENGINEER AND HIS OR HER PERSONNEL HAVE NO AUTHORITY TO EXERCISE ANY CONTROL OVER ANY CONSTRUCTION CONTRACTOR OR OTHER ENTITY OR THEIR EMPLOYEES IN CONNECTION WITH ANY HEALTH OR SAFETY PRECAUTIONS.
- 22. ALL MATERIALS INSTALLED WITHIN THE LIMITS OF THIS PROJECT SHALL BE IN CONFORMANCE WITH STANDARD RECOMMENDATIONS OF THE NATIONAL ELECTRIC MANUFACTURER'S ASSOCIATION (NEMA) AND THE AMERICAN NATIONAL STANDARDS INSTITUTE (ANSI).
- 23. THE CONTRACTOR SHALL OBTAIN ALL PERMITS AND COMPLY WITH THE REQUIREMENTS OF ALL AGENCIES HAVING JURISDICTION OVER THE WORK AND SHALL COORDINATE HIS WORK WITH THE WORK PERFORMED BY OTHERS FOR THE PURPOSE OF INSTALLATION. THIS INCLUDES, BUT IS NOT LIMITED TO, ALL WORK WITH ALL PUBLIC AND PRIVATE UTILITIES AS WELL AS CITY AND STATE AGENCIES.
- 24. CONTRACTOR SHALL RECORD THE LOCATION AND ELEVATION OF ALL UTILITIES ENCOUNTERED, AND INSTALLATION OF NEW WORK, AS THE WORK PROGRESSES AND SHALL PREPARE RECORD DRAWINGS (RED-LINES) BASED ON HIS RECORDS. AS A PART OF THE RECORD DRAWINGS. CONTRACTOR SHALL ALSO PROVIDE HORIZONTAL AND VERTICAL CONFIGURATION OF CONDUITS WHERE MULTIPLE CONDUITS ARE INSTALLED. THESE RECORDS ARE TO BE SUPPLIED TO FULLERTON ENGINEERING AT COMPLETION OF WORK.
- 25. MAINTAIN MORE THAN 2'-0" VERTICAL CLEARANCE AND MORE THAN 4'-0" HORIZONTAL CLEARANCE BETWEEN EXISTING SEWER OR SEWER STRUCTURES AND UTILITY. IF CITY SEWER FACILITIES ARE DAMAGED DURING CONSTRUCTION, IT MUST BE REPORTED TO CITY ENGINEERING SECTION AND MUST BE REPAIRED BY A LICENSED DRAIN LAYER UNDER THE SUPERVISION OF THE MASON INSPECTOR.
- 26. NO STORAGE OF EQUIPMENT OR MATERIALS IN THE ROADWAY IS PERMITTED UNLESS THE CONTRACTOR OBTAINS WRITTEN PERMISSION FROM THE CITY, STATE, AND/OR GOVERNING BODY.
- 27. CONTRACTOR RESPONSIBLE FOR OBTAINING AND PROVIDING REVIEW AND DESIGN OF ANY AND ALL SHORING SYSTEMS PRIOR TO CONSTRUCTION.
- 28. THE ENGINEER SHALL BE NOTIFIED FOR DISPOSITION OF SITUATIONS WHERE THE CONDUIT CANNOT MAINTAIN SEPARATIONS
- 29. THE CONTRACTOR IS RESPONSIBLE FOR THE RESTORATION OF THE AREAS DISTURBED BY CONSTRUCTION ACTIVITIES. CONTRACTOR IS TO PAY ALL FEES AND OBTAIN ALL PERMITS FOR RESTORATION. CONTRACTOR IS TO RESTORE ALL DAMAGED STRUCTURES AND UTILITIES TO THE SATISFACTION OF THE FACILITY OWNER OR THE GOVERNING BODY. IN THE EVENT THAT DAMAGE OCCURS
- 30. USE EXTREME CAUTION NEAR ALL GAS FACILITIES DURING CONSTRUCTION AND RELATED EXCAVATION ACTIVITIES. HAND EXCAVATION IS REQUIRED TO VERIFY THE HORIZONTAL AND VERTICAL LOCATION OF GAS MAIN(S) PRIOR TO CROSSING AND WORKING WITHIN 3 FEET OF ALL GAS FACILITIES. A MINIMUM OF 3 FEET HORIZONTAL EDGE TO EDGE CLEARANCE IS REQUIRED FOR GAS MAINS WITH DIAMETERS OF 16 INCHES OR SMALLER, AND 5 FEET EDGE TO EDGE CLEARANCE FOR GAS MAINS WITH DIAMETERS 18 INCHES AND LARGER IN DIAMETER. THE USE OF CONCRETE, FLOW FILL, OR THE LIKE IS PROHIBITED WITHIN 24 INCHES OF ALL GAS FACILITIES, NOR SHALL IT ENCASE ANY GAS FACILITY. SAND IS TO BE USED AS A BUFFER BETWEEN FLOWABLE FILL AND ALL GAS FACILITIES, ANY DAMAGE TO GAS FACILITIES SHALL BE THE RESPONSIBILITY OF THE INSTALLING UTILITY AND THEIR CONTRACTORS.

3701 COMMUNICATIONS WAY **EVANSVILLE IN 47715**



LIOUE WOODFIELD ROAD SUITE 500 SCHAUMBURG, ILLINOIS 60173 TEL: 847-908-8400 COA# 3620-11

REV	DATE	DESCRIPTION	BY
Α	06/03/25	ISSUED FOR REVIEW	BP

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TASK NAME

CITY HALL

TASK DESCRIPTION

FIBER OPTIC CONDUIT **PLACEMENT**

LACROSSE, WI

SHEET SCALE

N.T.S.

SHEET TITLE

GENERAL NOTES

GRID NUMBER

SHEET NUMBER





3701 COMMUNICATIONS WAY EVANSVILLE, IN, 47715



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LACROSSE, WI

SHEET SCALE

N.T.S.

SHEET TITLE


MAP

GRID NUMBER

SHEET NUMBER

MAP-1

11'x17' SCALE: NTS **PLANSET** 24'x36' SCALE: NTS

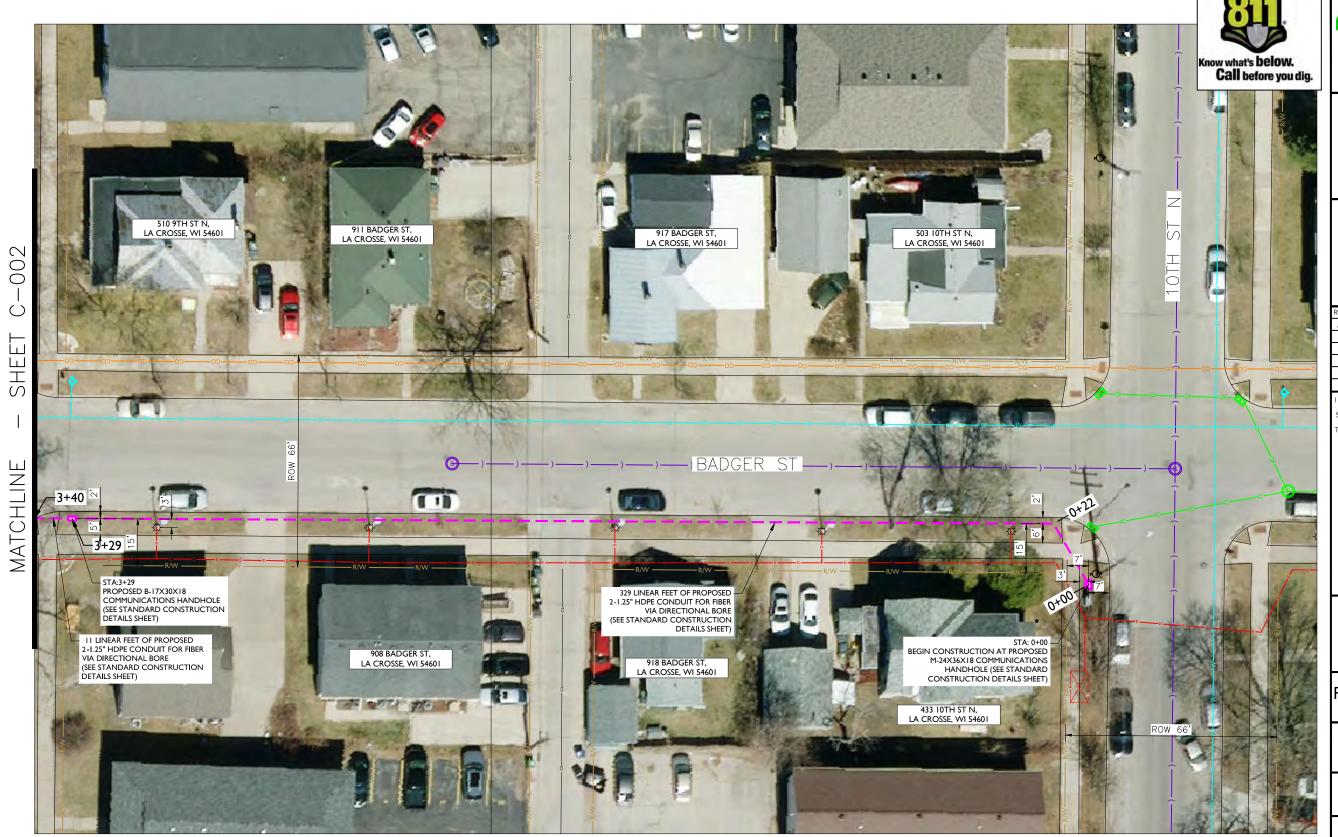

3701 COMMUNICATIONS WAY EVANSVILLE, IN, 47715

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CITY HALL

TASK DESCRIPTION

FIBER OPTIC CONDUIT **PLACEMENT**

LACROSSE, WI

SHEET SCALE

1" = 30'-0"

SHEET TITLE

DESIGN LAYOUT

GRID NUMBER

SHEET NUMBER

C-001

NOTE:

PROPOSED CONDUIT SHALL AVOID EXISTING SEEPAGE BEDS


BURY AT 24" MIN. UNDER SOFT SURFACE

BURY AT 36" MIN. UNDER HARD SURFACE MAINTAIN 1' FROM BACK OF SIDEWALK, WHEN APPLICABLE.

METRONET WILL MAINTAIN 5' CLEARANCE FROM EXISTING INLETS, MANHOLES, VALVES, AND FIRE HYDRANTS & 7.5' CLEARANCE FROM MANHOLES AND CATCH BASINS.

NOTE:

RIGHT-OF-WAY LINES SHOWN ARE INFORMATION PROVIDED IN GIS FILE OBTAINED FROM LA CROSSE COUNTY. THE INTENT OF THIS DRAWING IS THAT ALL PROPOSED CONDUIT IS TO BE PLACED WITHIN THE RIGHT-OF-WAY, AT THE BACK OF THE RIGHT-OF-WAY, OR WITHIN THE CITED EASEMENTS.

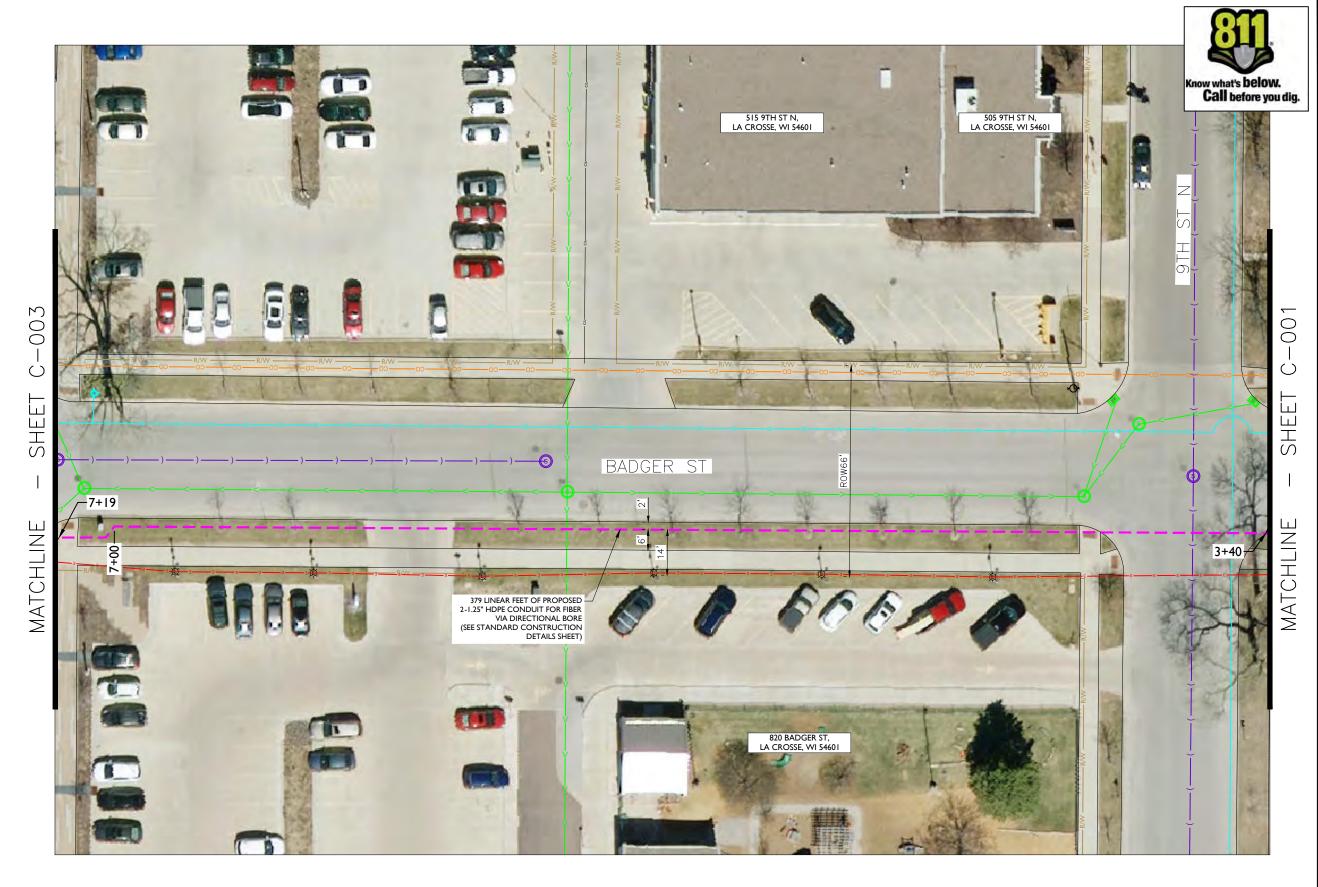

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CITY HALL

TASK DESCRIPTION

FIBER OPTIC CONDUIT **PLACEMENT**

LACROSSE, WI

SHEET SCALE

1" = 30'-0"

SHEET TITLE

DESIGN LAYOUT

GRID NUMBER

SHEET NUMBER

C-002

NOTE:

PROPOSED CONDUIT SHALL AVOID EXISTING SEEPAGE BEDS BURY AT 24" MIN. UNDER SOFT SURFACE

BURY AT 36" MIN. UNDER HARD SURFACE
MAINTAIN 1' FROM BACK OF SIDEWALK, WHEN APPLICABLE.

METRONET WILL MAINTAIN 5' CLEARANCE FROM EXISTING INLETS, MANHOLES, VALVES, AND FIRE HYDRANTS & 7.5' CLEARANCE FROM MANHOLES AND CATCH BASINS.

NOTE:

RIGHT-OF-WAY LINES SHOWN ARE INFORMATION PROVIDED IN GIS FILE OBTAINED FROM LA CROSSE COUNTY. THE INTENT OF THIS DRAWING IS THAT ALL PROPOSED CONDUIT IS TO BE PLACED WITHIN THE RIGHT-OF-WAY, AT THE BACK OF THE RIGHT-OF-WAY, OR WITHIN THE CITED EASEMENTS.



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PROPOSED CONDUIT SHALL AVOID EXISTING SEEPAGE BEDS

BURY AT 24" MIN. UNDER SOFT SURFACE

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metronet

3701 COMMUNICATIONS WAY EVANSVILLE, IN, 47715

Fullerten DESIGN DEVELOP CONSTRUCT

I 100 E. WOODFIELD ROAD, SUITE 500 SCHAUMBURG, ILLINOIS 60173 TEL: 847-908-8400 COA# 3620-11

REV	DATE	DESCRIPTION	BY
Α	06/03/25	ISSUED FOR REVIEW	BP

I HEREBY CERTIFY THAT THESE DRAWINGS WERE PREPARED BY ME OR UNDER MY DIRECT SUPERVISION AND CONTROL, AND TO THE BEST OF MY KNOWLEDGE AND BELIEF COMPLY WITH THE REQUIREMENTS OF ALL APPLICABLE CODES.

TASK NAME

CITY HALL

TASK DESCRIPTION

FIBER OPTIC CONDUIT PLACEMENT

PROJECT ARE

LACROSSE, WI

SHEET SCALE

1" = 30'-0"


SHEET TITLE

DESIGN LAYOUT

GRID NUMBER

SHEET NUMBER

C-003

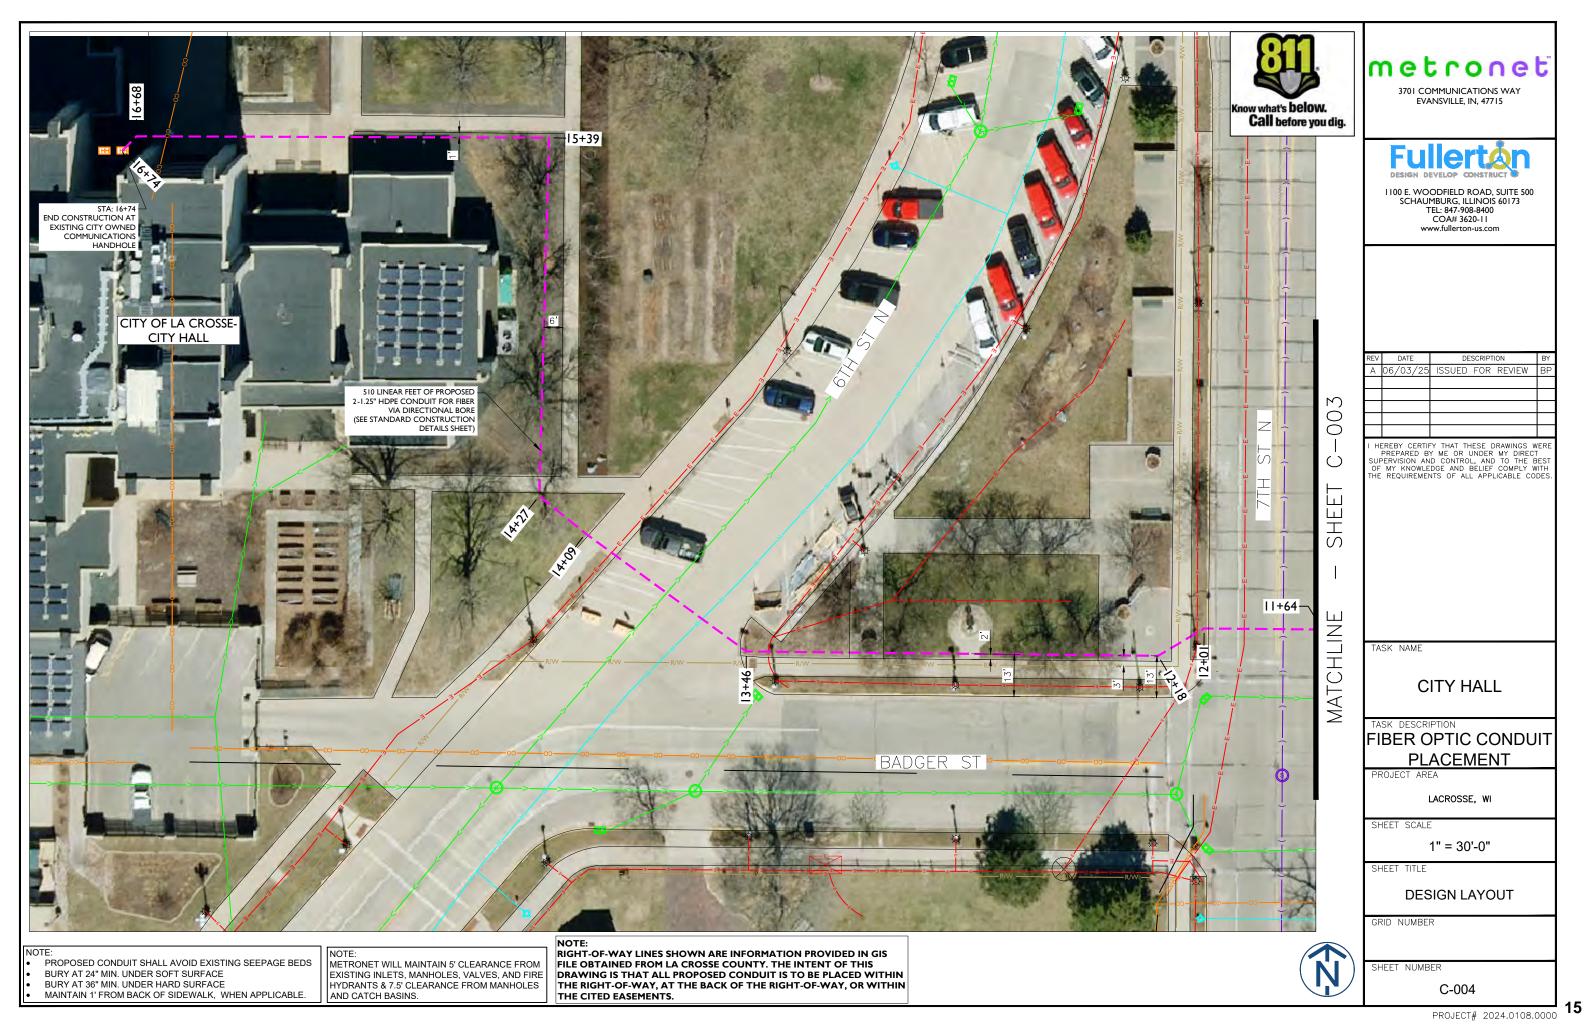


TYPICAL DETAIL DIRECTIONAL BORE CROSS SECTION (1) 1.25" CONDUIT AT 30"MIN EXISTING GRADE NOTE: DEPTH WILL VARY AND WILL BE ADJUSTED TO A GREATER DEPTH AS EXISTING UTILITIES ARE LOCATED AND DEPTHS ARE PROVIDED BY LOCATOR.

ADDITIONAL NOTES:

- EXCEPT AS OTHERWISE NOTED, CONTRACTOR SHALL MAINTAIN A MINIMUM OF 24 INCHES OF SEPARATION FROM EXISTING UTILITIES.
- 2. CONTRACTOR SHALL POTHOLE EACH UTILITY TO DETERMINE SIZE, LOCATION, AND DEPTH PRIOR TO CROSSING.
- 3. CONTRACTOR IS CAUTIONED TO PROTECT SEWER MANHOLES, CATCH BASINS, LATERALS AND INLETS.
- 4. CONTRACTOR WILL PROVIDE BARRICADING TO INSURE CORRECT TRAFFIC CONTROL WHILE MAINTAINING VEHICULAR TRAFFIC AT ALL TIMES.
- 5. RESTORATION TO BE IN COMPLIANCE WITH APPLICABLE PERMITING AGENCIES.
- 6. BONDING AND GROUNDING PER NESC.

PUBLIC UTILITY NOTE:

CONTRACTOR SHALL NOTIFY ALL PUBLIC UTILITY COMPANIES (GAS, ELECTRIC, TELEPHONE, SEWER, WATER, ETC) PRIOR TO COMMENCING ANY CONSTRUCTION.
THESE COMPANIES WILL LOCATE, ON THE GROUND, THE LOCATION OF ALL CONDUITS, DUCTS, UNDERGROUND PIPING, ETC., ADJOINING & CROSSING PROPOSED CONSTRUCTION.

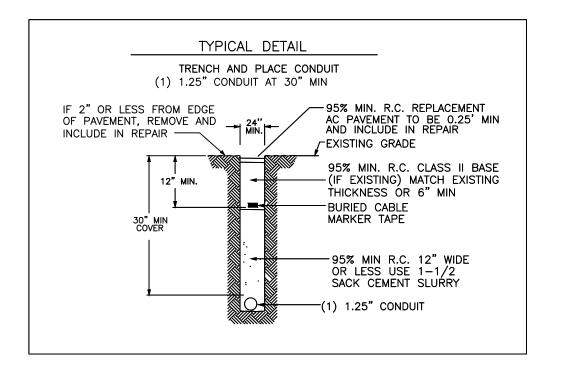

metronet
3701 COMMUNICATIONS WAY

EVANSVILLE, IN, 47715

Fullerten

DESIGN DEVELOP CONSTRUCT

1100 E. WOODFIELD ROAD, SUITE 500 SCHAUMBURG, ILLINOIS 60173 TEL: 847-908-8400 COA# 3620-11

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CITY HALL

TASK DESCRIPTION

FIBER OPTIC CONDUIT
PLACEMENT

PROJECT ARE

LACROSSE, WI

SHEET SCALE

N.T.S.

SHEET TITLE

DETAILS


GRID NUMBER


SHEET NUMBER


D-

TRENCH AND BORE TYPICAL DETAIL

11'x17' SCALE: NTS
24'x36' SCALE: NTS

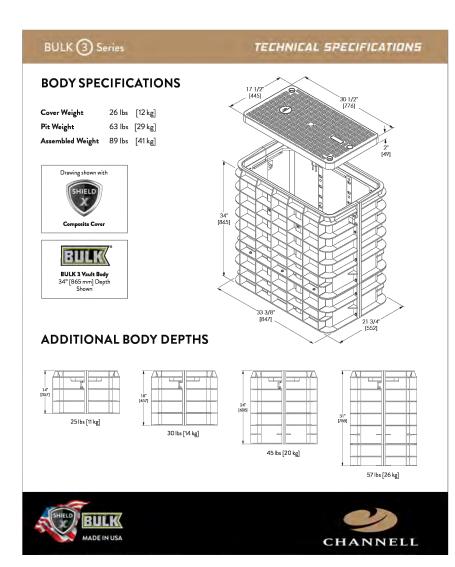

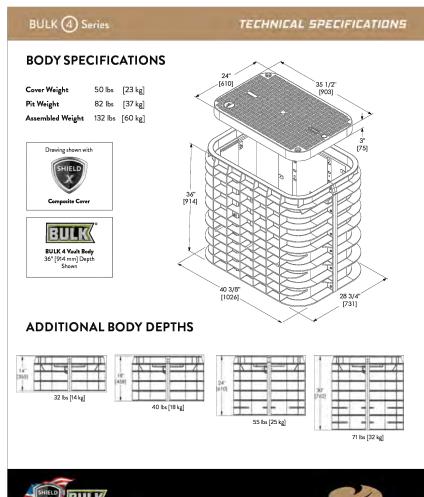

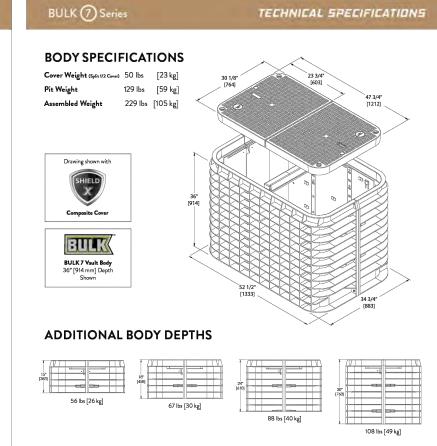

CHANNELL

B-HANDHOLE (17X30X18) SCALE: N.T.S.

M-HANDHOLE (24X36X18) SCALE: N.T.Ś.

CHANNELL

LHH-HANDHOLE (30X48X24) SCALE: N.T.Ś.

metronet 3701 COMMUNICATIONS WAY EVANSVILLE, IN, 47715



1100 E. WOODFIELD ROAD, SUITE 500 SCHAUMBURG, ILLINOIS 60173 TEL: 847-908-8400 COA# 3620-11

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TASK NAME

CITY HALL

TASK DESCRIPTION

FIBER OPTIC CONDUIT **PLACEMENT**

LACROSSE, WI

SHEET SCALE

SHEET TITLE

N.T.S.

DETAILS

GRID NUMBER

SHEET NUMBER

11'x17' SCALE: NTS HANDHOLE DETAIL 24'x36' SCALE: NTS



DATA SHEET

SGLB-0 NEW SIGNATURE SERIES GRADE LEVEL BOX WITH SELFLOCK" PROTECTION





SELF_LOCK


The New Signature Series SGLB High Density Polyethylene (HDPE) grade level box line come standard with Logo Disk and the Patented SELFLOCK automatic locking mechanism.

FEATURES

- 13" (330mm) Depth
- No bolts to be lost, misplaced, or not installed back into the unit
- Captive bolt device, that opens with a ¼ turn
- Press/Push lid closed, and it will automatically lock in place (with an audible "click")
- Protects your investment, and ensures the needed protection for your network
- Eliminates the risk of lids floating off, being throw be lawnmowers (i.e. reduces potentially liability)


SIMPLE AND WORRY FREE PROTECTION



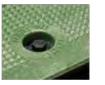



DIMENSIONS

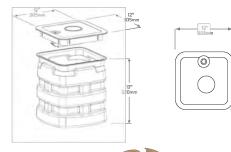



WORLDWIDE HEADQUARTERS: Channell Commercial Corporation, Rockwall, TX, United States • Tel 800.423.1863 • Fax 951.296.2322

CANUARA: Channell Canada, Inc., Mississauga, ON, Canada • Tel 905.565.1700 • Fax 905.565.8782

EURORY, MIDDILE EAST, APRIDA: Channell Ltd., Darford, United Kingdom • Tel 44.1322.312590 • Fax 44.1322.508490

AUSTRALA, SISI, PROFITE BIBL: Channell Py, Ltd., Seven Hilb, NSW, Australa • Tel 61.28894.411 • Fax 61.28814.8841

www.channell.com

All specifications subject to change without notice. © 2022 Channell Commercial Corporation. All rights reserved.

DB-HANDHOLE (12X12X13)SCALE: N.T.Ś.

DATA SHEET

SGLB-2 SIGNATURE SERIES GRADE LEVEL BOX



SELFLOCK[™]

The Signature Series SGLB-2 High Density Polyethylene (HDPE) grade level box line comes standard with Customizable Logo Disk and the Patented SELFLOCK automatic locking mechanism.

FEATURES

- Designed for Greenbelt/Pedestrial
- No bolts to be lost, misplaced, or not installed back into the unit Press/Push lid closed, and it will
- automatically lock in place (with an audible "click")
- Secondary lock option
- Temporary drop port
- Protects your investment, and ensures the needed protection for your network
- Eliminates the risk of lids floating off, being thrown by lawnmowers (i.e. reduce
 - TB-HANDHOLE (15X24X18)

SIMPLE AND WORRY FREE PROTECTION



SELF<u>L</u>OCK






DIMENSIONS





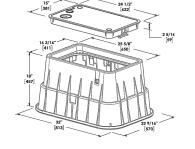



SCALE: N.T.Ś.

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3701 COMMUNICATIONS WAY EVANSVILLE, IN, 47715



1100 E. WOODFIELD ROAD, SUITE 500 SCHAUMBURG, ILLINOIS 60173 TEL: 847-908-8400 COA# 3620-11

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TASK NAME

CITY HALL

TASK DESCRIPTION

FIBER OPTIC CONDUIT **PLACEMENT**

LACROSSE, WI

SHEET SCALE

N.T.S.

DETAILS

GRID NUMBER

SHEET TITLE


SHEET NUMBER


11'x17' SCALE: NTS

24'x36' SCALE: NTS

HANDHOLE DETAIL


- CALL FOR LOCATES AT LEAST 72 HOURS IN ADVANCE OF ANY CONSTRUCTION FOR MARKINGS.
- 2. FOR LABEL AND TAG INFORMATION SEE DRAWING OSP 16.
- 3. THE VAULT W/ BOTTOM ENTRY ELEVATION VIEW SHOWN BELOW ONLY INDICATES THE BACK FILL REQUIREMENTS NECESSARY FOR VAULTS PLACED IN SIDEWALKS, ETC. (WHERE THEY NEED TO COMPLY WITH ADA REQUIREMENTS). TO ENSURE COMPLIANCE WITH CURRENT ADA REQUIREMENTS, THE HEIGHT OF THE BACK FILL IS SHOWN HELD DOWN TO ALLOW CONCRETE TO FLOW DOWN AND AROUND THE LIFTING LUGS/BOLTS WHICH WILL SERVE AS DOWELS INTO THE FINISHED CONCRETE SLAB.

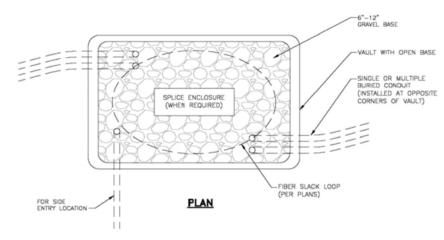

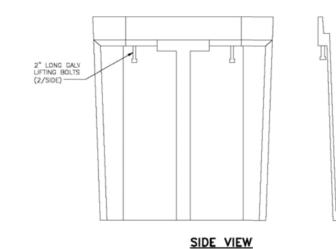

NOTE:

 ENCLOSURES, BOXES AND COVERS ARE REQUIRED TO MEET OR EXCEED ALL TESTS PROVISIONS OF THE MOST CURRENT ANSI/SCTE 77-2007 "SPECIFICATIONS FOR UNDERGROUND INTEGRITY" FOR TIER 15 OR BETTER.

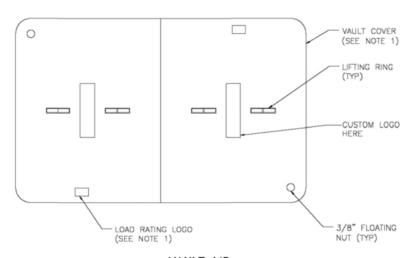

ADA REQUIREMENTS:

SURFACE LEVEL CRITERIA: NO HEIGHT DIFFERENTIALS WITH A LIP GREATER THAN 1/4 IN HEIGHT. EXCEPTIONS: A HEIGHT DIFFERENTIAL BETWEEN 1/4 AND 1/2 IS ACCEPTABLE IF IT IS BEVELED AT A 2:1 SLOPE, OR A HEIGHT DIFFERENTIAL GREATER THAN 1/2 IS ACCEPTABLE IF IT IS RAMPED WITH A SLOPE OF 8.33% (1V:12H) OR LESS.

UTILITY COVERS SHALL HAVE A SLIP RESISTANT TOP, AS MUCH AS POSSIBLE, AND MEET CHANGES IN LEVEL CRITERIA AS STATED ABOVE.

LIFT HOLES FOR UTILITY COVERS SHALL NOT HAVE AN OPENING GREATER THAN 1/2 PLUGGING OF HOLES GREATER THAN ½ WITH A MATERIAL APPROVED BY THE ENGINEER IS ACCEPTABLE AS LONG AS IT IS FLUSH WITH THE COVER SURFACE.

A LEVEL PEDESTRIAN ACCESS ROUTE (PAR) OR WALKWAY SHALL BE PROVIDED ACROSS COMMERCIAL AND RESIDENTIAL ENTRANCES, MEETING THE FOLLOWING CRITERIA:


- THE WALKWAY IS AT MINIMUM 3 WIDE.

- CROSS SLOPE OF WALKWAY IS 2% OR LESS.

- WALKWAY IS AT THE SAME GRADE AS THE ADJACENT ROADWAY.

- THE WALKWAY DOES NOT HAVE TO BE MARKED, BUT PROVIDES A STRAIGHT LINE BETWEEN THE ADJOINING SIDEWALKS OR RAMPS.

- THERE IS NOT AN ABRUPT TRANSITION FROM THE DRIVEWAY TO THE ROADWAY FOR VEHICLES, I.E., VEHICLES WILL NOT BOTTOM OUT WHEN DRIVING OVER THE TRANSITION.

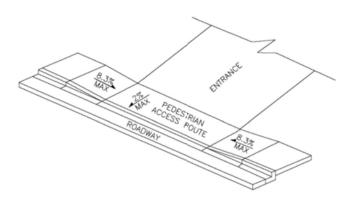

PEDESTRIAN ACCESS ROUTE

metronet 3701 COMMUNICATIONS WAY

EVANSVILLE, IN, 47715



1100 E. WOODFIELD ROAD, SUITE 500 SCHAUMBURG, ILLINOIS 60173 TEL: 847-908-8400 COA# 3620-11 www.fullerton-us.com

REV	DATE	DESCRIPTION	BY
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TASK NAME

CITY HALL

TASK DESCRIPTION

FIBER OPTIC CONDUIT **PLACEMENT**

PROJECT AREA

LACROSSE, WI

SHEET SCALE


N.T.S.

SHEET TITLE

DETAILS


GRID NUMBER

SHEET NUMBER

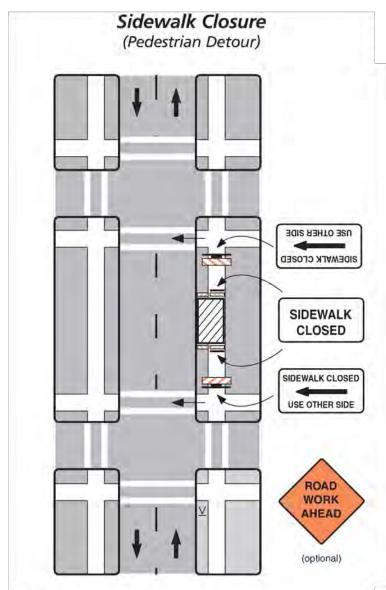

Notes

- 1. Additional advance warning may be necessary.
- 2. Only the traffic control devices related to pedestrians are shown. Other devices may be needed to control traffic on the streets such as lane closure signs, ROAD NARROWS or LANE NARROWS signs.
- 3. For nighttime closures, Type A flashing warning lights may be used on barricades supporting signs and closing walkways.
- 4. Audible devices should be considered to alert pedestrians with visual disabilities of closings and crosswalk changes.

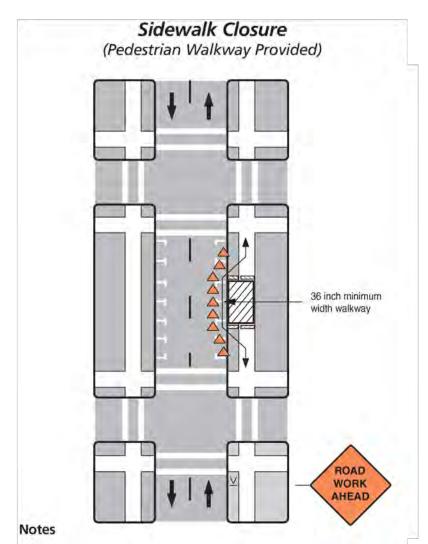

- 1. Additional advance warning may be necessary.
- 2. Only the traffic control devices related to pedestrians are shown. Other devices such as lane closure signs, ROAD NARROWS or LANE NARROWS signs may be needed to control traffic on the streets.
- 3. For nighttime closures, Type A flashing warning lights may be used on barricades supporting signs and closing walkways. Type C or Type D steady-burn lights may be used on channelizing devices separating the temporary walkway from vehicular traffic.
- 4. Where high speeds are likely, a barrier should separate the temporary walkway from vehicular traffic. Refer to Section 6D.01of Part 6 of the MUTCD for information on barriers.
- 5. Signs may be placed along a temporary walkway to guide pedestrians; for example, Keep Right or Keep Left signs.
- 6. Pedestrian walkways should be ADA accessible (i.e., ramps, surfaces).

metronet

3701 COMMUNICATIONS WAY EVANSVILLE IN 47715



1100 E. WOODFIELD ROAD, SUITE 500 SCHAUMBURG, ILLINOIS 60173 TEL: 847-908-8400 COA# 3620-11

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Α	06/03/25	ISSUED FOR REVIEW	ΒP	

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TASK NAME

CITY HALL

TASK DESCRIPTION

FIBER OPTIC CONDUIT **PLACEMENT**

LACROSSE, WI

SHEET SCALE

N.T.S.

SHEET TITLE

TRAFFIC CONTROL STANDARD DETAILS

GRID NUMBER

SHEET NUMBER

TCP-01



REVOCABLE OCCUPANCY / STREET PRIVILEGE PERMIT APPLICATIONFOR COMMUNICATIONS (FIBER OPTICS, TELEPHONE, CABLE, ETC.) City of La Crosse Engineering Department

Phone: 608-789-7505 Email: engineering@cityoflacrosse.org http://cityoflacrosse.org

Address:	Address:	City:	State:	Zip:
Application Preparer (if different from above)	Phone #	Email	Address	
Relationship with Owner:				
Certify that I have reviewed the Municipal Code and understand all that is related to this permit request. I further certify that I ave the full authority to make the foregoing application; the information in the application and the required submittals are omplete and correct; the Work or Use performed shall comply with all the laws of the State of Wisconsin, and all ordinances, uses, regulations, policies and special conditions of the City of La Crosse. The applicant agrees to perform the work covered by an approved permit with diligence and convenience to the public. See Sheet 2 of 2 for Additional Conditions. Disginature of Owner or designee: Frint Name and Title: Date: Please return this completed application along with required information and fees noted on checklist below to: City of La Crosse in the Board of Public Works agenda for consideration. Average completion time for validation 45 days. BELOW THIS LINE TO BE COMPLETED BY CITY STAFF ONLY Required items to be provided by Applicant: Beard of Public Works Scale Drawing of encroachments Complete Utility Locate by Digger's Hotline Required) Encroachment Type: Permit Number:				
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City Utility Potential Conflict Notification and Sign-Off	nitial Application Fee \$		┙	Permit Number:
I I	City Utility Potential Conflict Notific	cation and Sign-Off	╗╶┤╴├	
	All Fees are Non-Refundable & So	ubject to change by City Cou	ıncil	SHEET 1 OF 2



REVOCABLE OCCUPANCY / STREET PRIVILEGE PERMIT APPLICATION

City of La Crosse Engineering Department

Phone: 608-789-7505 Email: engineering@cityoflacrosse.org http://cityoflacrosse.org

STREET PRIVILEGE PERMIT CONDITIONS FOR COMMUNICATIONS INSTALLATIONS

- 1. The applicant shall be primarily liable for damages to person or property by reason of the granting of this street privilege permit.
- 2. The applicant shall obtain an excavation permit from the City of La Crosse Engineering Department prior to performing installation or any maintenance on the cable in the City right-of-way that requires excavation or disruption of pavement, sidewalk, curb and gutter, or other structure.
- The applicant agrees that tracer wires shall be used and final cable location within the street right-of-way shall be approved by the City Engineer. Cable shall be installed not less than 36 inches deep, unless otherwise approved by the City Engineer.
- 4. Applicant agrees to provide the City of La Crosse with final "as-built" plans when installation is complete.
- 5. Applicant agrees that any pavement, concrete or green space disturbed during drilling activities shall be restored to its prior condition.
- 6. Applicant agrees that said installation shall not interfere with the City's water, sanitary sewer, or storm sewer underground infrastructure that may be in the area.
- 7. Applicant further agrees that they will make arrangements with the public utility companies and the City of La Crosse to clear all public underground utilities prior to initiating such work, and if necessary, applicant will make arrangements with the City of La Crosse to ensure proper traffic control.
- 8. Applicant waives any and all rights to contest in any way or manner the validity of Sec. 66.0425 of the Wisconsin Statutes and the amount of compensation charged.
- 9. Applicant agrees to become a member of Diggers Hotline for marking / locating of utility.
- 10. The applicant for a permit to encroach on the public right-of-way shall procure and maintain for the duration of the permit a minimum liability and contractual liability policy in the amount of \$100,000.00 each person, \$300,000.00 each accident for bodily injury and \$100,000.00 for property damage. A certificate of such insurance shall be filed with the City Attorney as part of the application. The insurance shall name the City, its officials, employees and agents as additional insureds. The Board may approve greater insurance protection on a case-by-case basis.
- 11. Applicant further agrees to hold harmless the City for any damage to said cable while the City, its agents or contractors are conducting construction for maintenance activities in or upon such area in which said cable lies; provided, however, the City shall make a good faith effort to notify applicant of any maintenance or work in the area of the street privilege permit which may damage applicant's cable.
- 12. Applicant agrees to remove the cable and return the area to its original condition upon ten (10) days' notice by the Board of Public Works. The applicant further agrees that if it does not remove the cable within ten (10) days after receiving notice, the City is authorized to remove the same and applicant agrees to pay the City for all costs of such removal.
- 13. Applicant further agrees that the obligations and conditions of this street privilege permit shall be binding upon all heirs, successors and assigns of applicant.
- 14. The person(s) signing this Permit warrant that they have the authority to sign as, or on behalf of, the party for whom they are signing.

Sheet 2 of 2



City of La Crosse, Wisconsin

City Hall 400 La Crosse Street La Crosse, WI 54601

Text File

File Number: 25-0675

Agenda Date: 6/16/2025 Version: 2 Status: Agenda Ready

In Control: Board of Public Works File Type: General Item

TASK NAME: HAMILTON SCHOOL EXT

TASK DESCRIPTION: FIBER OPTIC CONDUIT PLACEMENT

SITE LOCATION: LACROSSE, WI

metronet 3701 COMMUNICATIONS WAY EVANSVILLE, IN, 47715



1100 E. WOODFIELD ROAD, SUITE 500 SCHAUMBURG, ILLINOIS 60173 TEL: 847-908-8400 COA# 3620-11 www.fullerton-us.com

	PROJECT INFORMATION			SITE LOCATION	ON MAP			
TASK NAME:	HAMILTON SCHOOL EXT	ZGP ZGP	S	and H	Resource Center 🗢		First Presby	REV DATE DESCRIPTION BY A 06/03/25 ISSUED FOR REVIEW BP
TASK DESCRIPTION:	FIBER OPTIC CONDUIT PLACEMENT		8#				Church Of L	A 00/03/23 ISSOED FOR REVIEW BI
SITE LOCATION:	LACROSSE, WI			9th St		- 1-	Main	
SITE TYPE:	UNDERGROUND FIBER-OPTIC CONSTRUCTION	s St O	9	Cass St 🙃	G	Cass St	8	I HEREBY CERTIFY THAT THESE DRAWINGS WERE PREPARED BY ME OR UNDER MY DIRECT
<u>JURISDICTION:</u> APN:	LACROSSE, WI				(O		0	PREPARED BY ME OR UNDER MY DIRECT SUPERVISION AND CONTROL, AND TO THE BEST OF MY KNOWLEDGE AND BELIEF COMPLY WITH THE REQUIREMENTS OF ALL APPLICABLE CODES
ZONING CLASSIFICATION: OCCUPANCY TYPE: CONSTRUCTION TYPE:		Li Cita		WORK AREA	the state of		3th St S	THE REQUIREMENTS OF ALL APPLICABLE CODES
APPLICANT: ADDRESS:	METRO FIBERNET, LLC 3701 COMMUNICATIONS WAY EVANSVILLE, IN, 47715			WORK AREA	Corner Estate on Cameron			
CONTACT: PHONE: EMAIL:	GLENN LEFÉBVRE (231) 357-0823 GLENN.LEFEBVRE@METRONET.COM	1 1 1 1 1 1 1 1 1 1 1 1 1 1 1 1 1 1 1	Cameron Ave	o o	944 Cameron Ave	Cameron Ave		
<u>NOTE:</u> DRAWING SO	CALES ARE FOR 11"x17" SHEETS UNLESS OTHERWISE NOTED	P D						
	PROJECT CONSULTANTS						65	
PROJECT MANAGER: ADDRESS:	FULLERTON ENGINEERING CONSULTANTS, LLC 1100 E. WOODFIELD ROAD, SUITE 500			Table 1				TASK NAME
CONTACT: PHONE: EMAIL:	MICHELLE KAMINSKI (616) 262-8400 MKAMINSKI@FULLERTON-US.COM	vision St a a	Division St	Division St	Division St		E-Dan .	HAMILTON SCHOOL EXT
ENGINEER: ADDRESS:	FULLERTON ENGINEERING CONSULTANTS, LLC 1100 E. WOODFIELD ROAD, SUITE 500 SCHAUMBURG, ILLINOIS 60173	7th St		518 10th St Recently viewed	th St.		3th St	TASK DESCRIPTION
EOR: PHONE: EMAIL:	DAN SMITH, P.E. 847-908-8521 DSMITH@FULLERTONENGINEERING.COM			0	Recovery Center			FIBER OPTIC CONDUIT PLACEMENT
POWER COMPANY: PHONE:			Ferry St	Ferry.St	oths	Ferry St	Ferry St	PROJECT AREA
TELEPHONE COMPANY: PHONE:					Charles Polzin D	DS:	35)	LACROSSE, WI Sheet scale
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THE SCOPE OF WORK CO	NSISTS OF:		Treacy House				Shear Delight Beauty Salon	SHEET TITLE
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		McDo	nald Terrace	Franciscan S Perpetual Ac	doration	65		SHEET NUMBER
ALL MATERIAL SHALL	BE INSTALLED BY THE CONTRACTOR, UNLESS STATED OTHERWISE.			nwy	Mayo Clinio Crosse Center F	or 🕕	NO SCALE	T-1

SHEET NUMBER	SHEET TITLE
T-1	TITLE SHEET
T-2	SHEET INDEX
T-3	LEGEND
GN-1	GENERAL NOTES
MAP-1	PLANSET
C-001	DESIGN LAYOUT
C-002	DESIGN LAYOUT
C-003	DESIGN LAYOUT
D-1	DETAILS
D-2	DETAILS
D-3	DETAILS
D-4	DETAILS
TCP-1	TRAFFIC CONTROL STANDARD



3701 COMMUNICATIONS WAY EVANSVILLE, IN, 47715



1100 E. WOODFIELD ROAD, SUITE 500 SCHAUMBURG, ILLINOIS 60173 TEL: 847-908-8400 COA# 3620-11 www.fullerton-us.com

REV	DATE	DE	DESCRIPTION		
Α	06/03/25	ISSUED	FOR	REVIEW	BP

I HEREBY CERTIFY THAT THESE DRAWINGS WERE PREPARED BY ME OR UNDER MY DIRECT SUPERVISION AND CONTROL, AND TO THE BEST OF MY KNOWLEDGE AND BELIEF COMPLY WITH THE REQUIREMENTS OF ALL APPLICABLE CODES.

TASK NAME

HAMILTON SCHOOL EXT

TASK DESCRIPTION

FIBER OPTIC CONDUIT PLACEMENT

PROJECT AREA

LACROSSE, WI

SHEET SCALE

N.T.S.

SHEET TITLE

SHEET INDEX

GRID NUMBER

SHEET NUMBER

LEGEND

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metronet
3701 COMMUNICATIONS WAY EVANSVILLE, IN, 47715
Fullertan

COMMUNICATIONS

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SNSN	EXISTING SUNESYS	SN	EXISTING SUNESYS MANHOLE
	EXISTING VERIZON	(VZ)	EXISTING VERIZON MANHOLE

DESIGN DEVELOP CONSTRUCT

1100 E. WOODFIELD ROAD, SUITE 500 SCHAUMBURG, ILLINOIS 60173 TEL: 847-908-8400 COA# 3620-11 www.fullerton-us.com

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SHEET SCALE

SHEET TITLE

N.T.S.

LEGEND

GRID NUMBER

SHEET NUMBER

	PROPOSED OPEN CUT TRENCH	В	PROPOSED B-UTILITY BOXES(17X30X18)		
	PROPOSED DIRECTIONAL BORE	ТВ	PROPOSED TERMINAL BOXES(13X24X15)		
	PROPOSED BORE PIT	DB	PROPOSED DROP BOXES(11X11X12)		
LHH	PROPOSED L-HANDHOLE(30X48X24)				
HH	PROPOSED M-HANDHOLE(24X36X18)				
	<u>SEWER</u>				
))	EXISTING SEWER MAIN	S	EXISTING SEWER MANHOLE		
	EXISTING SEWER MAIN (ABANDON)	(1)	EXISTING SEWER CATCH BASIN		
>>	EXISTING STORM SEWER MAIN		EXISTING SEWER INLET		
S	EXISTING STORM MANHOLE				
	WATER				
	EXISTING WATER MAIN		EXISTING WATER MANHOLE		
	EXISTING WATER MAIN (ABANDON)	⊗	EXISTING WATER VALVE		
* 50	EXISTING WATER SHUT OFF	•	EXISTING WATER METER		
F	EXISTING FIRE CISTERN MANHOLE	.	EXISTING FIRE HYDRANT		
Е	EXISTING WATER CAP	>	EXISTING WATER REDUCER		
	GAS				
GG	EXISTING GAS MAIN	\otimes	EXISTING GAS MANHOLE		
—+++-G-+++-G	EXISTING GAS MAIN (DEAD)	\otimes	EXISTING GAS VALVE		
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DEO/ELECTRIC					
EEE	EXISTING DEO/ELECTRIC	\$	EXISTING STREET LIGHT POLE		
SLC	EXISTING STREET LIGHT CONTROL BOX	ф	EXISTING TRAFFIC LIGHT POLE		
TLC	EXISTING TRAFFIC LIGHT CONTROL BOX	· Ø -	EXISTING DEO POLE		
	EXISTING STREET LIGHT HANDHOLE	E	EXISTING ELECTRIC MANHOLE		

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E

EXISTING ELECTRIC HANDHOLE

EXISTING RED LIGHT FLASH POLE

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C

EXISTING TRAFFIC LIGHT HANDHOLE

EXISTING RED LIGHT CAMERA POLE

PROPOSED

	<u>MISCELLANEOUS</u>					
xxx	EXISTING FENCE	②	EXISTING MISCELLANEOUS MANHOLE			
0-0-0-0	EXISTING CONSTRUCTION FENCE	G	EXISTING GARBAGE CAN			
	EXISTING GUARDRAIL		EXISTING PARK DISTRICT MANHOLE			
	EXISTING PROPERTY LINE/ R.O.W.	M	EXISTING MONITORING WELL			
d ——D	EXISTING BIKE RACK	F	EXISTING FIRE ALARM			
	EXISTING TREE	P	EXISTING STREET PARKING PAY BOX			
	EXISTING BUSH		EXISTING PEDESTAL			
- 0-	EXISTING STREET SIGN POST	M	EXISTING MAILBOX			
B	EXISTING POST/BOLLARD	N	EXISTING NEWSPAPER BOX			
¤	EXISTING GROUND LIGHT		EXISTING PHONE			
r-O+	EXISTING UTILITY POLE	S	EXISTING SPRINKLER CONTROL BOX			
Ω	EXISTING STANDPIPE	S	EXISTING SPRINKLER VALVE			
ADA	EXISTING ADA RAMP	H	EXISTING SUPPORT COLUMN			

- THE ENCLOSED DESIGN MAY IMPLY EXISTING UTILITIES. THE UTILITIES HAVE NOT BEEN FIELD VERIFIED FOR LOCATION. THEREFORE, ALL UTILITIES IMPLIED WITHIN THIS DOCUMENT ARE TO BE REFERRED TO AS A "REFERENCE TOOL". IT IS THE RESPONSIBILITY OF THE GENERAL CONTRACTOR AND/OR IT'S SUBCONTRACTOR TO VERIFY THESE UTILITIES USING ANY AND ALL METHODS AND INSTRUMENTS AVAILABLE IF/WHEN NECESSARY, FULLERTON CANNOT IN GOOD FAITH GUARANTEE UTILITY LOCATIONS. ANY AND ALL DOCUMENTATION ON EXISTING UTILITIES HAS BEEN IMPLIED UTILIZING INFORMATION RETRIEVAL PROCESSES FROM EACH JURISDICTION INVOLVED (STATE, COUNTY AND/OR MUNICIPALITY, TO INCLUDE OTHERS).
- 2. IT IS THE RESPONSIBILITY OF THE GENERAL CONTRACTOR TO ENSURE ALL CONDUITS ARE PLACED WITHIN THE GIVEN & DEDICATED SPACE LICENSED FOR THIS PARTICULAR CLIENT. FULLERTON ENGINEERING CONSULTANTS, INC. (FULLERTON) WAS NOT RETAINED FOR THE PURPOSE OF SUPPORTING A SURVEY OF THE AREA AND PROPERTY BOUNDARIES, THEREFORE FULLERTON CAN NOT AND WILL NOT SUPPORT THE ACCURACY OF ANY IMPLIED BOUNDARY (I.E. PUBLIC WAY, PRIVATE PROPERTY, EASEMENT ETC.) NOR IS IT TO BE ASSUMED THAT THE SALE OF PROPERTIES HAS NOT OCCURRED DURING & AFTER FULLERTON'S RESPONSIBILITIES FOR THIS PROJECT HAVE PAST. ALL BOUNDARIES, EASEMENTS, PROPERTY LINES, ETC. ARE TO BE USED AS A GUIDELINE OR REFERENCE AND SHOULD NOT BE TAKEN LITERALLY, IT IS THE CONTRACTOR'S RESPONSIBILITY TO HAVE ASSOCIATED BOUNDARIES SURVEY STAKED IF SO QUESTIONED. ALL ASPECTS OF BOUNDARIES IMPLIED HEREIN, HAVE BEEN DERIVED THROUGH AVAILABLE MEDIA SUCH AS BUT NOT LIMITED TO (SIDWELL, GOOGLE EARTH PRO, MUNICIPAL, STATE, COUNTY, GIS, AND OTHER RECORD TYPES). FULLERTON DOES NOT AGREE NOR DISAGREE WITH THE ABOVE-MENTIONED RECORDS AS THEY ARE USED JUST A REFERENCE TOOL
- ALL BURIED OBSTRUCTIONS KNOWN BY FULLERTON ARE SHOWN ON THE CONSTRUCTION DRAWINGS. ANY AND ALL OTHERS ENCOUNTERED DURING CONSTRUCTION ARE THE RESPONSIBILITY OF THE CONTRACTOR TO LOCATE AND PROTECT.
- CONTRACTOR IS RESPONSIBLE FOR LOCATING ALL UTILITIES 48 HOURS PRIOR TO CONSTRUCTION ACTIVITY
- SHORING MAY BE REQUIRED AND SHALL COMPLY TO O.S.H.A. STANDARDS.
- ALL BURIED CONDUIT/CABLE WILL BE PLACED AT 30-48" MINIMUM COVER UNLESS SPECIFIED OR OTHERWISE NOTED ON THE CONSTRUCTION DRAWINGS
- ANY AND ALL IMPROVEMENTS, IF DAMAGED, SHALL BE RESTORED TO ORIGINAL OR BETTER CONDITION. THIS INCLUDES BUT IS NOT LIMITED TO: ASPHALT, CONCRETE PAVEMENT, CURBS, GUTTERS, SIDEWALKS, DRAINAGE DITCHES, EMBANKMENTS, SHRUBS, TREES GRASS SOD ETC
- ALL FIBER INSTALLATIONS SHALL OBSERVE A MINIMUM DYNAMIC BEND RADIUS OF 20X THE CABLE DIAMETER FOR ALL OSP FIBER SHEATHS AND 15X THE CABLE DIAMETER FOR ALL ISP FIBER SHEATHS. ADDITIONALLY, ALL INSTALLATIONS SHALL OBSERVE A MINIMUM STATIC BEND RADIUS OF 15X THE CABLE DIAMETER FOR ALL OSP FIBER SHEATHS AND 10X THE CABLE DIAMETER FOR ALL ISP FIBER SHEATHS. IF THE MANUFACTURER'S SPECIFICATIONS FOR BEND RADIUS ARE GREATER. THEN THEY SHALL BE FOLLOWED.
- ALL NEW METALLIC AERIAL STRAND SHALL BE BONDED/GROUNDED (PREFERABLY TO THE POWER COMPANY NEUTRAL) PER LOCAL REQUIREMENTS. AT A MINIMUM, THE BONDING/GROUNDING PATTERN SHALL BE THE FIRST AND LAST POLE OF A RUN AND EVERY TENTH POLE IN THE RUN. SHOULD ONE OF THESE DESIGNATED POLES SUPPORT A POWER TRANSFORMER, THE POLES ON EITHER SIDE OF SAID POLE SHALL BE BONDED/GROUNDED AND THE PATTERN SHOULD CONTINUE EVERY TENTH POLE FROM THAT STARTING POINT.
- 10. ALL AERIAL FIBER OPTIC CABLES SHALL BE SECURELY LASHED TO AERIAL STRAND BY METHOD OF MECHANICAL LASHING CARRIAGE OR APPROVED EQUAL.
- 11. ALL FIBER OPTIC CABLES INSTALLED BELOW GRADE SHALL BE OF AN ARMORED VARIETY WITH METALLIC INNER SHEATH, OR BE PLACED WITH A METALLIC LOCATING WIRE TO FACILITATE FUTURE LOCATING SERVICES.
- 12. ALL CONDUIT OR DUCT CONSTRUCTION SHALL INCLUDE THE PLACEMENT OF PULLING TAPE OF SUFFICIENT SIZE AND GRADE TO FACILITATE THE INSTALLATION OF THE SPECIFIED FIBER TYPE THROUGH CONDUIT BEING UTILIZED (JETLINE USE TO BE APPROVED BY CLIENT)
- 13. ALL FUSION SPLICING SHALL BE COMPLETED BY A QUALIFIED FIBER SPLICER IN A CLEAN TEMPERATURE CONTROLLED TRUCK, TRAILER, OR SHELTER SPECIFICALLY TOOLED OR DESIGNED FOR THE PURPOSE OF FUSION SPLICING FIBER OPTIC CABLES IN A FIFI D ENVIRONMENT
- 14. ALL MECHANICAL SPLICES AND FACTORY ENDS SHALL BE KEPT CLEAN AND FREE FROM DUST, DIRT, OILS, AND SMEARS. CARE SHOULD BE TAKEN TO MATCH POLISH TYPES ON FACTORY ENDS.
- 15. CONTRACTOR SHALL BE RESPONSIBLE FOR ANY AND ALL CORRECTIONS TO WORK IDENTIFIED AS UNACCEPTABLE BY CLIENT, ENGINEER, OR INSPECTOR, DURING SITE INSPECTION ACTIVITIES AND/OR AS A RESULT OF TESTING, CONTRACTOR SHALL ALSO PROVIDE ALL AS-BUILT INFORMATION UPON COMPLETION OF INSPECTION.
- 16. CONTRACTOR SHALL KEEP THE SITE FREE FROM ACCUMULATING WASTE MATERIAL, DEBRIS, AND TRASH. AT THE COMPLETION OF THE WORK, CONTRACTOR SHALL REMOVE FROM THE SITE ALL REMAINING RUBBISH, IMPLEMENTS, TEMPORARY FACILITIES, AND SURPLUS MATERIALS. CONTRACTOR TO RETURN SITE TO PREVIOUS OR BETTER CONDITION.
- 17. DRAWINGS ARE INTENDED TO SHOW DESIGN INTENT. CONTRACTOR SHALL PROVIDE MATERIALS AND LABOR AS REQUIRED TO PRODUCE A COMPLETE AND FUNCTIONING SYSTEM WHILE MEETING ALL CODES AND SPECIFICATIONS. MODIFICATIONS MAY BE REQUIRED TO SUIT JOB DIMENSIONS OR CONDITIONS. SUCH MODIFICATIONS SHALL BE INCLUDED IN THE WORK. SAID DESIGN IS INTENDED TO AVOID DISRUPTION OF ANY HANDICAP RAMPS OR STRUCTURES AS DESCRIBED PER THE AMERICANS WITH DISABILITIES ACT OF 1990.

- 18. CONTRACTOR SHALL WORK WITH CLIENT TO IDENTIFY ALL CONTRACTOR SUPPLIED MATERIALS TO CONSTRUCT NETWORK PER SPECIFICATIONS.
- 19. THE CONTRACTOR SHALL PROVIDE ALL MATERIAL, EQUIPMENT, LABOR, INSTALLATION, RESTORATION, UTILITY RELOCATION CHARGES, JOB SITE DELIVERY COSTS AND INCIDENTALS TO COMPLETE THE DESCRIBED OR ILLUSTRATED WORK UNDER THIS CONTRACT.
- 20. ANY CHANGE-ORDER REQUEST MUST BE PRESENTED IN WRITING TO THE OWNER'S REPRESENTATIVE AND APPROVED PRIOR TO PROCEEDING WITH THE REQUESTED CHANGE.
- 21. THE ENGINEER WILL NOT BE RESPONSIBLE NOR ASSUME ANY LIABILITY FOR NEGLIGENT ACTS OR ERRORS OF OMISSIONS OF ANY CONTRACTOR, ANY SUBCONTRACTOR, OR ANY OF THE PERSONS (EXCEPT ENGINEER'S OWN EMPLOYEES) AT THE PROJECT SITE OR OTHERWISE PERFORMING ANY OF THE WORK OF THE PROJECT. ANY CONTRACTOR OR SUBCONTRACTOR, AS WELL AS THE ENGINEER, WILL BE RESPONSIBLE FOR HIS OWN SAFETY PROGRAM. NEITHER THE PROFESSIONAL ACTIVITIES OF THE ENGINEER, NOR THE PRESENCE OF THE ENGINEER OR HIS OR HER EMPLOYEES AND SUB-CONSULTANTS AT THE CONSTRUCTION SITE, SHALL RELIEVE ANY CONTRACTOR OF HIS OR HER OBLIGATIONS, DUTIES AND RESPONSIBILITIES INCLUDING, BUT NOT LIMITED TO, CONSTRUCTION MEANS, METHODS, SEQUENCE, TECHNIQUES OR PROCEDURES NECESSARY FOR PERFORMING, SUPERINTENDING OR COORDINATING ALL PORTIONS OF THE WORK OF CONSTRUCTION IN ACCORDANCE WITH THE CONTRACT DOCUMENTS AND ANY HEALTH OR SAFETY PRECAUTIONS REQUIRED BY ANY REGULATORY AGENCIES. THE ENGINEER AND HIS OR HER PERSONNEL HAVE NO AUTHORITY TO EXERCISE ANY CONTROL OVER ANY CONSTRUCTION CONTRACTOR OR OTHER ENTITY OR THEIR EMPLOYEES IN CONNECTION WITH ANY HEALTH OR SAFETY PRECAUTIONS.
- 22. ALL MATERIALS INSTALLED WITHIN THE LIMITS OF THIS PROJECT SHALL BE IN CONFORMANCE WITH STANDARD RECOMMENDATIONS OF THE NATIONAL ELECTRIC MANUFACTURER'S ASSOCIATION (NEMA) AND THE AMERICAN NATIONAL STANDARDS INSTITUTE (ANSI).
- 23. THE CONTRACTOR SHALL OBTAIN ALL PERMITS AND COMPLY WITH THE REQUIREMENTS OF ALL AGENCIES HAVING JURISDICTION OVER THE WORK AND SHALL COORDINATE HIS WORK WITH THE WORK PERFORMED BY OTHERS FOR THE PURPOSE OF INSTALLATION. THIS INCLUDES, BUT IS NOT LIMITED TO, ALL WORK WITH ALL PUBLIC AND PRIVATE UTILITIES AS WELL AS CITY AND STATE AGENCIES.
- 24. CONTRACTOR SHALL RECORD THE LOCATION AND ELEVATION OF ALL UTILITIES ENCOUNTERED, AND INSTALLATION OF NEW WORK, AS THE WORK PROGRESSES AND SHALL PREPARE RECORD DRAWINGS (RED-LINES) BASED ON HIS RECORDS. AS A PART OF THE RECORD DRAWINGS. CONTRACTOR SHALL ALSO PROVIDE HORIZONTAL AND VERTICAL CONFIGURATION OF CONDUITS WHERE MULTIPLE CONDUITS ARE INSTALLED. THESE RECORDS ARE TO BE SUPPLIED TO FULLERTON ENGINEERING AT COMPLETION OF WORK.
- 25. MAINTAIN MORE THAN 2'-0" VERTICAL CLEARANCE AND MORE THAN 4'-0" HORIZONTAL CLEARANCE BETWEEN EXISTING SEWER OR SEWER STRUCTURES AND UTILITY. IF CITY SEWER FACILITIES ARE DAMAGED DURING CONSTRUCTION, IT MUST BE REPORTED TO CITY ENGINEERING SECTION AND MUST BE REPAIRED BY A LICENSED DRAIN LAYER UNDER THE SUPERVISION OF THE MASON INSPECTOR.
- 26. NO STORAGE OF EQUIPMENT OR MATERIALS IN THE ROADWAY IS PERMITTED UNLESS THE CONTRACTOR OBTAINS WRITTEN PERMISSION FROM THE CITY, STATE, AND/OR GOVERNING BODY.
- 27. CONTRACTOR RESPONSIBLE FOR OBTAINING AND PROVIDING REVIEW AND DESIGN OF ANY AND ALL SHORING SYSTEMS PRIOR TO CONSTRUCTION.
- 28. THE ENGINEER SHALL BE NOTIFIED FOR DISPOSITION OF SITUATIONS WHERE THE CONDUIT CANNOT MAINTAIN SEPARATIONS
- 29. THE CONTRACTOR IS RESPONSIBLE FOR THE RESTORATION OF THE AREAS DISTURBED BY CONSTRUCTION ACTIVITIES. CONTRACTOR IS TO PAY ALL FEES AND OBTAIN ALL PERMITS FOR RESTORATION. CONTRACTOR IS TO RESTORE ALL DAMAGED STRUCTURES AND UTILITIES TO THE SATISFACTION OF THE FACILITY OWNER OR THE GOVERNING BODY. IN THE EVENT THAT DAMAGE OCCURS
- 30. USE EXTREME CAUTION NEAR ALL GAS FACILITIES DURING CONSTRUCTION AND RELATED EXCAVATION ACTIVITIES. HAND EXCAVATION IS REQUIRED TO VERIFY THE HORIZONTAL AND VERTICAL LOCATION OF GAS MAIN(S) PRIOR TO CROSSING AND WORKING WITHIN 3 FEET OF ALL GAS FACILITIES. A MINIMUM OF 3 FEET HORIZONTAL EDGE TO EDGE CLEARANCE IS REQUIRED FOR GAS MAINS WITH DIAMETERS OF 16 INCHES OR SMALLER, AND 5 FEET EDGE TO EDGE CLEARANCE FOR GAS MAINS WITH DIAMETERS 18 INCHES AND LARGER IN DIAMETER. THE USE OF CONCRETE, FLOW FILL, OR THE LIKE IS PROHIBITED WITHIN 24 INCHES OF ALL GAS FACILITIES, NOR SHALL IT ENCASE ANY GAS FACILITY. SAND IS TO BE USED AS A BUFFER BETWEEN FLOWABLE FILL AND ALL GAS FACILITIES, ANY DAMAGE TO GAS FACILITIES SHALL BE THE RESPONSIBILITY OF THE INSTALLING UTILITY AND THEIR CONTRACTORS.

3701 COMMUNICATIONS WAY **EVANSVILLE IN 47715**



LIOUE WOODFIELD ROAD SUITE 500 SCHAUMBURG, ILLINOIS 60173 TEL: 847-908-8400 COA# 3620-11

	REV	DATE	DE	BY		
ı	Α	06/03/25	ISSUED	FOR	REVIEW	BP
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HERERY CERTIFY THAT THESE DRAWINGS WER PREPARED BY ME OR UNDER MY DIRECT UPPERVISION AND CONTROL, AND TO THE BEST OF MY KNOWLEDGE AND BELIEF COMPLY WITH HE REQUIREMENTS OF ALL APPLICABLE CODES

TASK NAME

HAMILTON SCHOOL EXT

FIBER OPTIC CONDUIT **PLACEMENT**

LACROSSE, WI

SHEET SCALE

N.T.S.

SHEET TITLE

GENERAL NOTES

GRID NUMBER

SHEET NUMBER





3701 COMMUNICATIONS WAY EVANSVILLE, IN, 47715



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TASK N

HAMILTON SCHOOL EXT

TASK DESCRIPTION

FIBER OPTIC CONDUIT PLACEMENT

PROJECT ARE

LACROSSE, WI

SHEET SCALE

N.T.S.

SHEET TITLE

MAP


GRID NUMBER

SHEET NUMBER

MAP-1

PLANSET

11/x17' SCALE: NTS
24'x36' SCALE: NTS

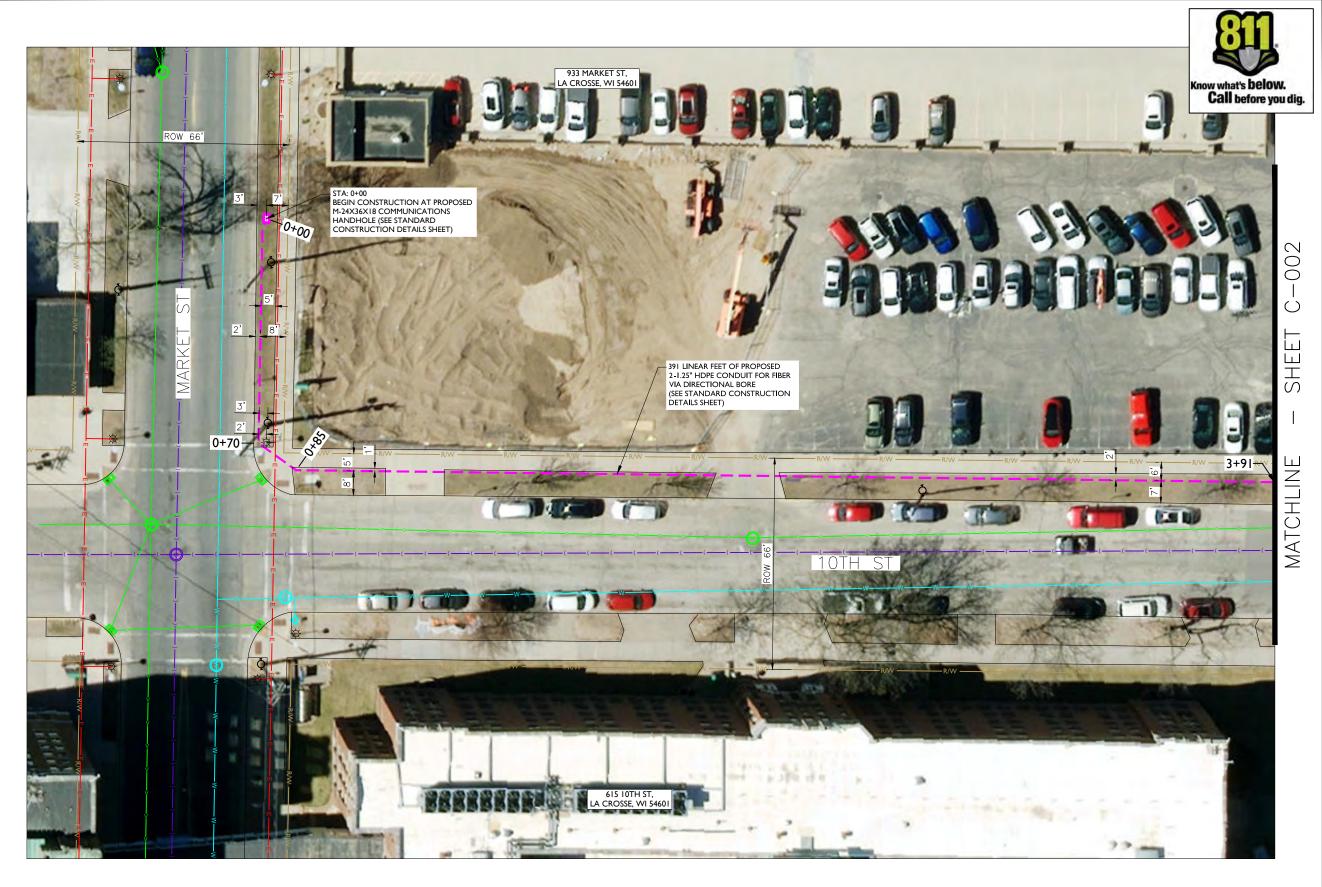

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HAMILTON SCHOOL EXT

TASK DESCRIPTION

FIBER OPTIC CONDUIT **PLACEMENT**

LACROSSE, WI

SHEET SCALE

1" = 30'-0"

SHEET TITLE

DESIGN LAYOUT

GRID NUMBER

SHEET NUMBER

C-001


PROPOSED CONDUIT SHALL AVOID EXISTING SEEPAGE BEDS BURY AT 24" MIN. UNDER SOFT SURFACE

BURY AT 36" MIN. UNDER HARD SURFACE MAINTAIN 1' FROM BACK OF SIDEWALK, WHEN APPLICABLE.

METRONET WILL MAINTAIN 5' CLEARANCE FROM EXISTING INLETS, MANHOLES, VALVES, AND FIRE HYDRANTS & 7.5' CLEARANCE FROM MANHOLES AND CATCH BASINS.

NOTE:

RIGHT-OF-WAY LINES SHOWN ARE INFORMATION PROVIDED IN GIS FILE OBTAINED FROM LA CROSSE COUNTY. THE INTENT OF THIS DRAWING IS THAT ALL PROPOSED CONDUIT IS TO BE PLACED WITHIN THE RIGHT-OF-WAY, AT THE BACK OF THE RIGHT-OF-WAY, OR WITHIN THE CITED EASEMENTS.

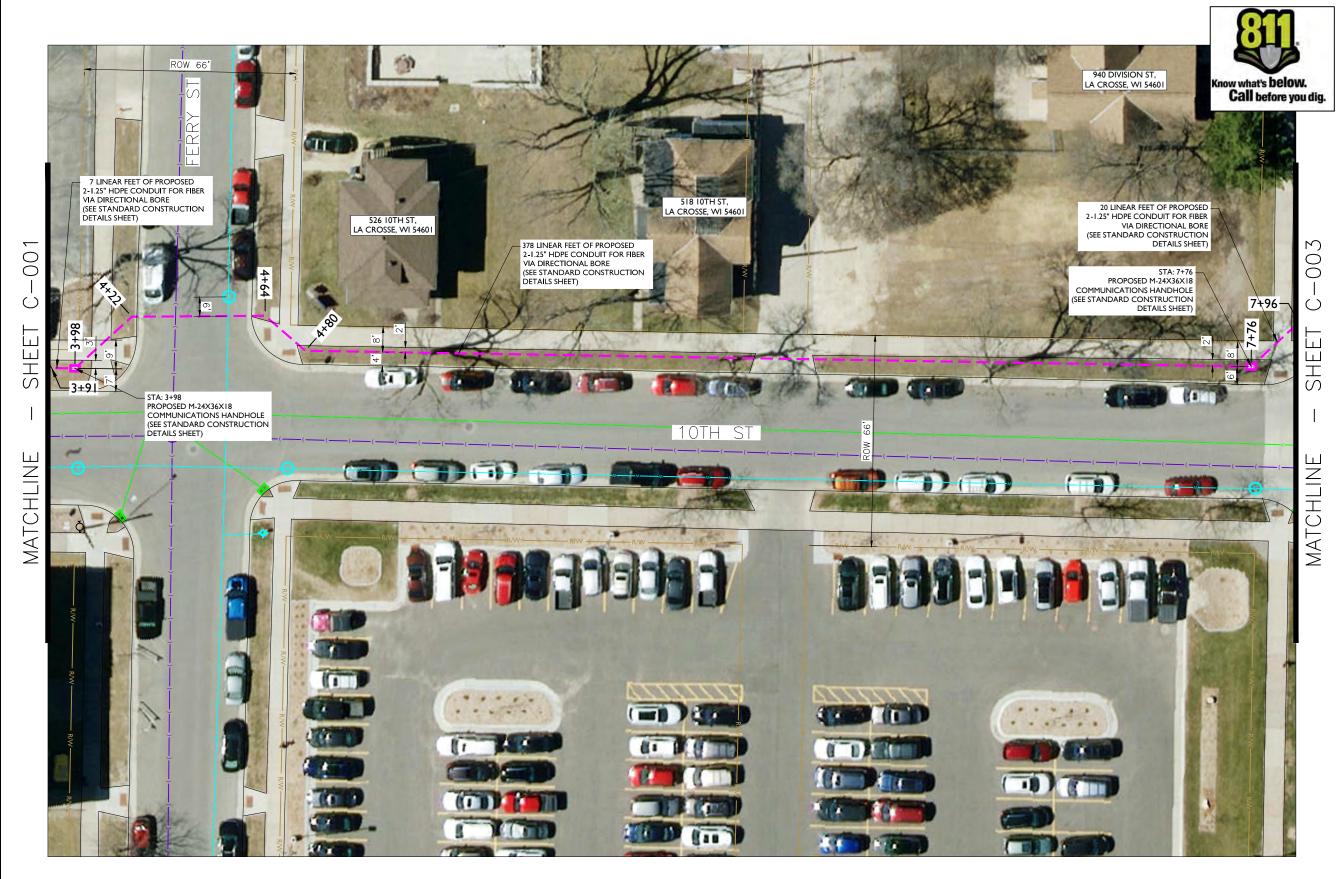

3701 COMMUNICATIONS WAY EVANSVILLE, IN, 47715

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1100 E. WOODFIELD ROAD, SUITE 500 SCHAUMBURG, ILLINOIS 60173 TEL: 847-908-8400 COA# 3620-11

REV	DATE	DESCRIPTION	BY
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TASK NAME

HAMILTON SCHOOL EXT

TASK DESCRIPTION

FIBER OPTIC CONDUIT **PLACEMENT**

LACROSSE, WI

SHEET SCALE

1" = 30'-0"

SHEET TITLE

DESIGN LAYOUT

GRID NUMBER

SHEET NUMBER

C-002

NOTE:

PROPOSED CONDUIT SHALL AVOID EXISTING SEEPAGE BEDS

BURY AT 24" MIN. UNDER SOFT SURFACE BURY AT 36" MIN. UNDER HARD SURFACE

MAINTAIN 1' FROM BACK OF SIDEWALK, WHEN APPLICABLE.

METRONET WILL MAINTAIN 5' CLEARANCE FROM EXISTING INLETS, MANHOLES, VALVES, AND FIRE HYDRANTS & 7.5' CLEARANCE FROM MANHOLES AND CATCH BASINS.

NOTE:

RIGHT-OF-WAY LINES SHOWN ARE INFORMATION PROVIDED IN GIS FILE OBTAINED FROM LA CROSSE COUNTY. THE INTENT OF THIS DRAWING IS THAT ALL PROPOSED CONDUIT IS TO BE PLACED WITHIN THE RIGHT-OF-WAY, AT THE BACK OF THE RIGHT-OF-WAY, OR WITHIN THE CITED EASEMENTS.



NOTE:

- PROPOSED CONDUIT SHALL AVOID EXISTING SEEPAGE BEDS BURY AT 24" MIN. UNDER SOFT SURFACE BURY AT 36" MIN. UNDER HARD SURFACE MAINTAIN 1' FROM BACK OF SIDEWALK, WHEN APPLICABLE.

METRONET WILL MAINTAIN 5' CLEARANCE FROM EXISTING INLETS, MANHOLES, VALVES, AND FIRE HYDRANTS & 7.5' CLEARANCE FROM MANHOLES AND CATCH BASINS.

NOTE:

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3701 COMMUNICATIONS WAY EVANSVILLE, IN, 47715



I 100 E. WOODFIELD ROAD, SUITE 500 SCHAUMBURG, ILLINOIS 60173 TEL: 847-908-8400 COA# 3620-11

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HAMILTON SCHOOL EXT

TASK DESCRIPTION

FIBER OPTIC CONDUIT **PLACEMENT**

LACROSSE, WI

SHEET SCALE

1" = 30'-0"

SHEET TITLE

DESIGN LAYOUT

GRID NUMBER

SHEET NUMBER

C-003



TYPICAL DETAIL DIRECTIONAL BORE CROSS SECTION (1) 1.25" CONDUIT AT 30"MIN -EXISTING GRADE 30" MIN COVER NOTE: DEPTH WILL VARY AND WILL BE ADJUSTED TO A GREATER DEPTH AS └─(1) 1.25" CONDUIT EXISTING UTILITIES ARE LOCATED AND DEPTHS ARE PROVIDED BY LOCATOR.


ADDITIONAL NOTES:

- 1. EXCEPT AS OTHERWISE NOTED, CONTRACTOR SHALL MAINTAIN A MINIMUM OF 24 INCHES OF SEPARATION FROM EXISTING UTILITIES.
- 2. CONTRACTOR SHALL POTHOLE EACH UTILITY TO DETERMINE SIZE. LOCATION, AND DEPTH PRIOR TO CROSSING.
- 3. CONTRACTOR IS CAUTIONED TO PROTECT SEWER MANHOLES, CATCH BASINS, LATERALS AND INLETS.
- 4. CONTRACTOR WILL PROVIDE BARRICADING TO INSURE CORRECT TRAFFIC CONTROL WHILE MAINTAINING VEHICULAR TRAFFIC AT ALL TIMES.
- 5. RESTORATION TO BE IN COMPLIANCE WITH APPLICABLE PERMITING AGENCIES.
- 6. BONDING AND GROUNDING PER NESC.

PUBLIC UTILITY NOTE:

CONTRACTOR SHALL NOTIFY ALL PUBLIC UTILITY COMPANIES (GAS, ELECTRIC, TELEPHONE, SEWER, WATER, ETC) PRIOR TO COMMENCING ANY CONSTRUCTION. THESE COMPANIES WILL LOCATE, ON THE GROUND, THE LOCATION OF ALL CONDUITS, DUCTS, UNDERGROUND PIPING,

ETC., ADJOINING & CROSSING PROPOSED CONSTRUCTION.

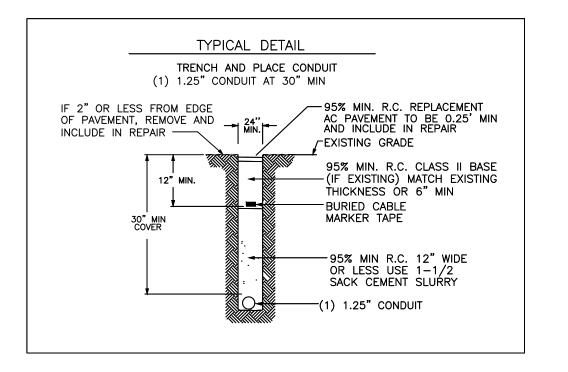

metronet 3701 COMMUNICATIONS WAY

EVANSVILLE, IN, 47715



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TASK NAME

HAMILTON SCHOOL EXT

TASK DESCRIPTION

FIBER OPTIC CONDUIT **PLACEMENT**

LACROSSE, WI

SHEET SCALE

N.T.S.


SHEET TITLE


DETAILS


GRID NUMBER

SHEET NUMBER

11'x17' SCALE: NTS TRENCH AND BORE TYPICAL DETAIL 24'x36' SCALE: NTS

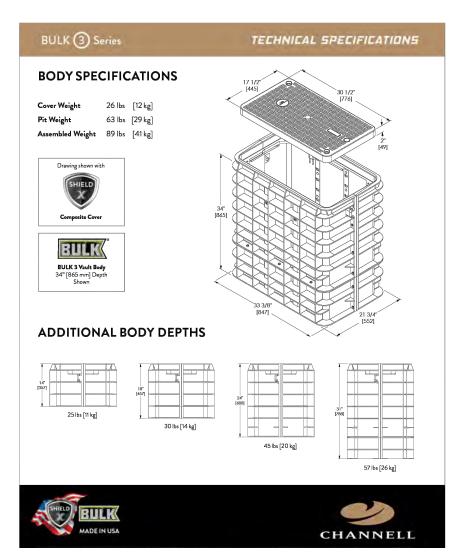

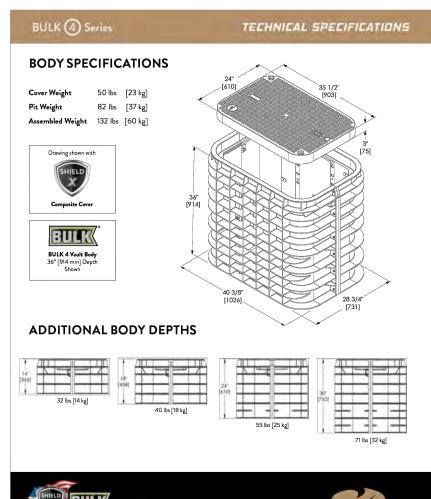

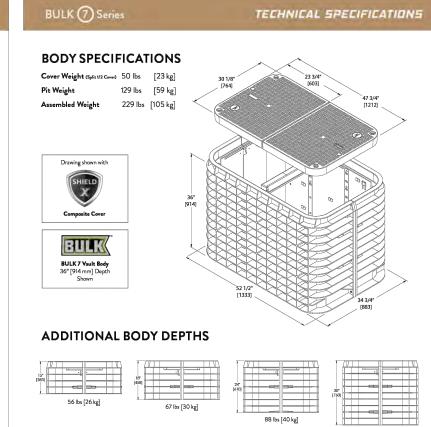



B-HANDHOLE (17X30X18) SCALE: N.T.S.

M-HANDHOLE (24X36X18) SCALE: N.T.Ś.

CHANNELL

LHH-HANDHOLE (30X48X24) SCALE: N.T.Ś.

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HAMILTON SCHOOL EXT

TASK DESCRIPTION

FIBER OPTIC CONDUIT **PLACEMENT**

LACROSSE, WI

SHEET SCALE

SHEET TITLE

N.T.S.

DETAILS

GRID NUMBER

SHEET NUMBER

11'x17' SCALE: NTS HANDHOLE DETAIL 24'x36' SCALE: NTS



DATA SHEET

SGLB-0 NEW SIGNATURE SERIES GRADE LEVEL BOX WITH SELFLOCK" PROTECTION





SELF_LOCK


The New Signature Series SGLB High Density Polyethylene (HDPE) grade level box line come standard with Logo Disk and the Patented SELFLOCK automatic locking mechanism.

FEATURES

- 13" (330mm) Depth
- No bolts to be lost, misplaced, or not installed back into the unit
- Captive bolt device, that opens with a ¼ turn
- Press/Push lid closed, and it will automatically lock in place (with an audible "click")
- Protects your investment, and ensures the needed protection for your network
- Eliminates the risk of lids floating off, being throw be lawnmowers (i.e. reduces potentially liability)


SIMPLE AND WORRY FREE PROTECTION



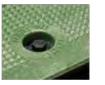



DIMENSIONS

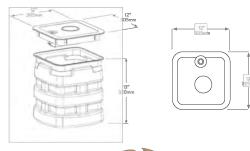



WORLDWIDE HEADQUARTERS: Channell Commercial Corporation, Rockwall, TX, United States • Tel 800.423.1863 • Fax 951.296.2322

CANUARA: Channell Canada, Inc., Mississauga, ON, Canada • Tel 905.565.1700 • Fax 905.565.8782

EURORY, MIDDILE EAST, APRIDA: Channell Ltd., Darford, United Kingdom • Tel 44.1322.312590 • Fax 44.1322.508490

AUSTRALA, SISI, PROFITE BIBL: Channell Py, Ltd., Seven Hilb, NSW, Australa • Tel 61.28894.411 • Fax 61.28814.8841

www.channell.com

DB-HANDHOLE (12X12X13)SCALE: N.T.Ś.

DATA SHEET



SGLB-2 SIGNATURE SERIES GRADE LEVEL BOX

SELF_LOCK

The Signature Series SGLB-2 High Density Polyethylene (HDPE) grade level box line comes standard with Customizable Logo Disk and the Patented SELFLOCK automatic locking mechanism.

FEATURES

HANDHOLE DETAIL

- Designed for Greenbelt/Pedestria
- No bolts to be lost, misplaced, or not installed back into the unit
- Press/Push lid closed, and it will automatically lock in place (with an audible "click")
- Secondary lock option
- Temporary drop port
- Protects your investment, and ensures the needed protection for your network
- Eliminates the risk of lids floating off, being thrown by lawnmowers (i.e. reduce

SIMPLE AND WORRY FREE PROTECTION










TB-HANDHOLE (15X24X18)SCALE: N.T.Ś.

DIMENSIONS

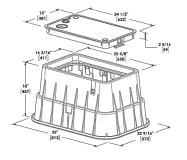



11'x17' SCALE: NTS 24'x36' SCALE: NTS

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TASK NAME

HAMILTON SCHOOL EXT

TASK DESCRIPTION

FIBER OPTIC CONDUIT **PLACEMENT**

LACROSSE, WI

N.T.S.

SHEET TITLE

DETAILS


GRID NUMBER


SHEET SCALE

SHEET NUMBER

PROJECT# 2024.0108.0000


- CALL FOR LOCATES AT LEAST 72 HOURS IN ADVANCE OF ANY CONSTRUCTION FOR MARKINGS.
- 2. FOR LABEL AND TAG INFORMATION SEE DRAWING OSP 16.
- 3. THE VAULT W/ BOTTOM ENTRY ELEVATION VIEW SHOWN BELOW ONLY INDICATES THE BACK FILL REQUIREMENTS NECESSARY FOR VAULTS PLACED IN SIDEWALKS, ETC. (WHERE THEY NEED TO COMPLY WITH ADA REQUIREMENTS). TO ENSURE COMPLIANCE WITH CURRENT ADA REQUIREMENTS, THE HEIGHT OF THE BACK FILL IS SHOWN HELD DOWN TO ALLOW CONCRETE TO FLOW DOWN AND AROUND THE LIFTING LUGS/BOLTS WHICH WILL SERVE AS DOWELS INTO THE FINISHED CONCRETE SLAB.

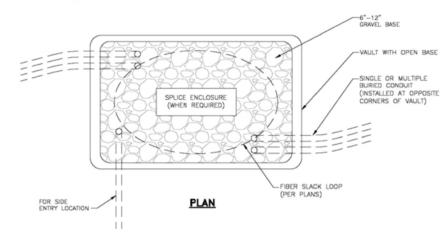

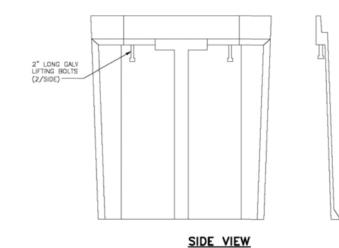

NOTE:

 ENCLOSURES, BOXES AND COVERS ARE REQUIRED TO MEET OR EXCEED ALL TESTS PROVISIONS OF THE MOST CURRENT ANSI/SCTE 77-2007 "SPECIFICATIONS FOR UNDERGROUND INTEGRITY" FOR TIER 15 OR BETTER.

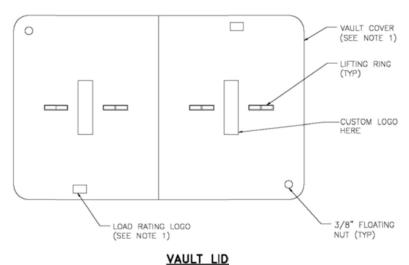

ADA REQUIREMENTS:

SURFACE LEVEL CRITERIA: NO HEIGHT DIFFERENTIALS WITH A LIP GREATER THAN 1/4 IN HEIGHT. EXCEPTIONS: A HEIGHT DIFFERENTIAL BETWEEN 1/4 AND 1/2 IS ACCEPTABLE IF IT IS BEVELED AT A 2:1 SLOPE, OR A HEIGHT DIFFERENTIAL GREATER THAN 1/2 IS ACCEPTABLE IF IT IS RAMPED WITH A SLOPE OF 8.33% (1V:12H) OR LESS.

UTILITY COVERS SHALL HAVE A SLIP RESISTANT TOP, AS MUCH AS POSSIBLE, AND MEET CHANGES IN LEVEL CRITERIA AS STATED ABOVE.

LIFT HOLES FOR UTILITY COVERS SHALL NOT HAVE AN OPENING GREATER THAN 1/2 PLUGGING OF HOLES GREATER THAN ½ WITH A MATERIAL APPROVED BY THE ENGINEER IS ACCEPTABLE AS LONG AS IT IS FLUSH WITH THE COVER SURFACE.

A LEVEL PEDESTRIAN ACCESS ROUTE (PAR) OR WALKWAY SHALL BE PROVIDED ACROSS COMMERCIAL AND RESIDENTIAL ENTRANCES, MEETING THE FOLLOWING CRITERIA:


- THE WALKWAY IS AT MINIMUM 3 WIDE.

- CROSS SLOPE OF WALKWAY IS 2% OR LESS.

- WALKWAY IS AT THE SAME GRADE AS THE ADJACENT ROADWAY.

- THE WALKWAY DOES NOT HAVE TO BE MARKED, BUT PROVIDES A STRAIGHT LINE BETWEEN THE ADJOINING SIDEWALKS OR RAMPS.

- THERE IS NOT AN ABRUPT TRANSITION FROM THE DRIVEWAY TO THE ROADWAY FOR VEHICLES, I.E., VEHICLES WILL NOT BOTTOM OUT WHEN DRIVING OVER THE TRANSITION.

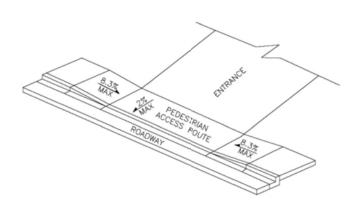

PEDESTRIAN ACCESS ROUTE

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TASK NAME

HAMILTON SCHOOL EXT

TASK DESCRIPTION

FIBER OPTIC CONDUIT **PLACEMENT**

PROJECT AREA

LACROSSE, WI

SHEET SCALE


N.T.S.

SHEET TITLE


DETAILS

GRID NUMBER

SHEET NUMBER

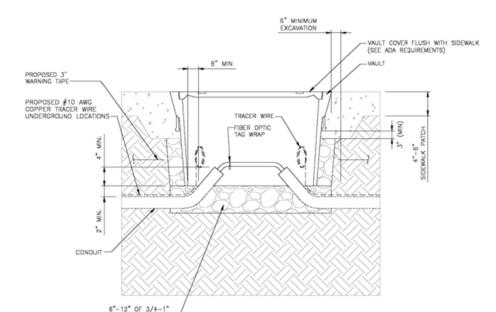


VAULT W/ BOTTOM ENTRY

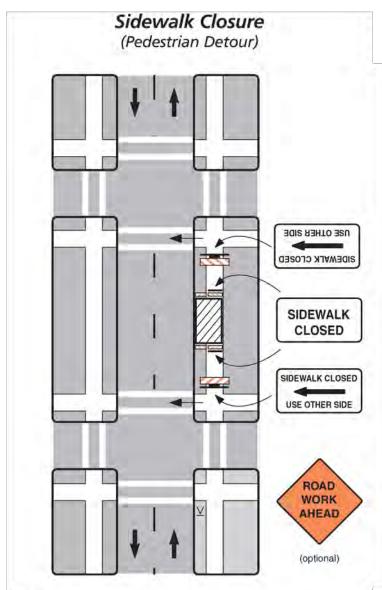

Notes

- 1. Additional advance warning may be necessary.
- Only the traffic control devices related to pedestrians are shown.Other devices may be needed to control traffic on the streets such as lane closure signs, ROAD NARROWS or LANE NARROWS signs.
- 3. For nighttime closures, Type A flashing warning lights may be used on barricades supporting signs and closing walkways.
- Audible devices should be considered to alert pedestrians with visual disabilities of closings and crosswalk changes.

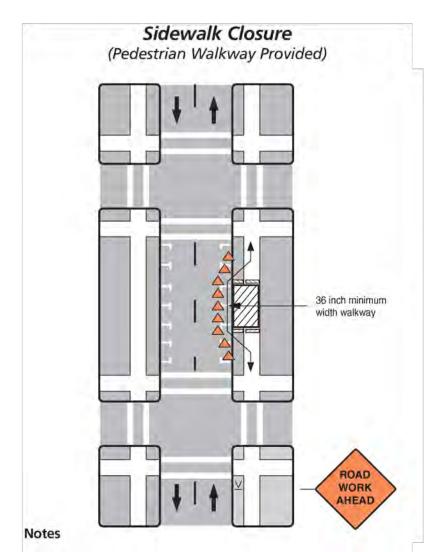

- 1. Additional advance warning may be necessary.
- Only the traffic control devices related to pedestrians are shown. Other devices such as lane closure signs, ROAD NARROWS or LANE NARROWS signs may be needed to control traffic on the streets.
- 3. For nighttime closures, Type A flashing warning lights may be used on barricades supporting signs and closing walkways. Type C or Type D steady-burn lights may be used on channelizing devices separating the temporary walkway from vehicular traffic.
- Where high speeds are likely, a barrier should separate the temporary walkway from vehicular traffic. Refer to Section 6D.01of Part 6 of the MUTCD for information on barriers.
- 5. Signs may be placed along a temporary walkway to guide pedestrians; for example, Keep Right or Keep Left signs.
- 6. Pedestrian walkways should be ADA accessible (i.e., ramps, surfaces).

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TASK NAME

HAMILTON SCHOOL EXT

TASK DESCRIPTION

FIBER OPTIC CONDUIT PLACEMENT

PROJECT ARE

LACROSSE, WI

SHEET SCALE

N.T.S.

SHEET TITLE

TRAFFIC CONTROL STANDARD DETAILS

GRID NUMBER

SHEET NUMBER

TCP-01

TASK NAME: HAMILTON SCHOOL EXT

TASK DESCRIPTION: FIBER OPTIC CONDUIT PLACEMENT

SITE LOCATION: LACROSSE, WI

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	PROJECT INFORMATION			SITE LOCATION	ON MAP			
TASK NAME:	HAMILTON SCHOOL EXT	45		and R	kesource Genter 🔝		First Presby	REV DATE DESCRIPTION BY A 06/03/25 ISSUED FOR REVIEW BP
TASK DESCRIPTION:	FIBER OPTIC CONDUIT PLACEMENT	in o	8th				Church Of L	B 06/11/25 REVISED GB
SITE LOCATION:	_ LACROSSE, WI			# 25				
SITE TYPE:	UNDERGROUND FIBER-OPTIC CONSTRUCTION	s St O	6	Cass St 🙃		Cass St		I HEREBY CERTIFY THAT THESE DRAWINGS WERE
<u>JURISDICTION:</u> APN:	LACROSSE, WI				5 B		9	PREPARED BY ME OR UNDER MY DIRECT
ZONING CLASSIFICATION: OCCUPANCY TYPE:	Ξ				StS		Tsts —	OF MY KNOWLEDGE AND BELIEF COMPLY WITH THE REQUIREMENTS OF ALL APPLICABLE CODES.
CONSTRUCTION TYPE:	- METRO EIDERNET II O			WORK AREA	Corner Estate 🔒 톂		13th	
APPLICANT: ADDRESS:	METRO FIBERNET, LLC 3701 COMMUNICATIONS WAY EVANSVILLE, IN, 47715		S	s — —	on Cameron			
CONTACT: PHONE:	TARAN WELCHLIN (608) 606–2043		- Calliel GII MAC	ž – O	944 Cameron Ave	Cameron Ave		
EMAIL:	TARAN.WELCHLIN@METRONET.COM CALES ARE FOR 11"x17" SHEETS UNLESS OTHERWISE NOTED		0		Recently viewed			
NOTE. DIVAMING SI	PROJECT CONSULTANTS							
PROJECT MANAGER: ADDRESS:	FULLERTON ENGINEERING CONSULTANTS, LLC 1100 E. WOODFIELD ROAD, SUITE 500						Madison St	TASK NAME
CONTACT: PHONE: EMAIL:	MICHELLE KAMINSKI (616) 262-8400 MKAMINSKI@FULLERTON-US.COM	rision St 😑 😉	Division St	Division St	Division St			HAMILTON SCHOOL EXT
ENGINEER: ADDRESS:	FULLERTON ENGINEERING CONSULTANTS, LLC 1100 E. WOODFIELD ROAD, SUITE 500 SCHAUMBURG, ILLINOIS 60173		in a	518 10th St Recently viewed	th st		3th Str S	TASK DESCRIPTION
EOR: PHONE: EMAIL:	DAN SMITH, P.E. 847-908-8521 DSMITH@FULLERTONENGINEERING.COM		0	0	Recovery Center			FIBER OPTIC CONDUIT PLACEMENT
POWER COMPANY: PHONE:			Ferry St	Ferry St	oth s	Ferry St	Ferry St	PROJECT AREA
TELEPHONE COMPANY:					Charles Polzin DD			LACROSSE, WI
PHONE:	000000000000000000000000000000000000000	ississippi		\$15	Oral Surgeon and.	S 35		SHEET SCALE N.T.S.
THE 000DE OF WORK OF	SCOPE OF WORK	alley Masonry		5			Shear Delight Beauty Salon	SHEET TITLE
THE SCOPE OF WORK CO		B Market St	ă	Market Ct	6 Marshad 8 4	0		TITLE SHEET
 1,992' OF 1.25" CONDUIT (4) M-HANDHOLE 24X36) 		Market St	Market St	Market St		Market St	Market St	
		Clare Apartmer	ts V	Franciscan S) -t Of			GRID NUMBER
		Maria Maria		Perpetual Ad	doration	35		CHEET MINDED
• ALL MATERIAL SHALL	BE INSTALLED BY THE CONTRACTOR, UNLESS STATED OTHERWISE.		Oonald Terrace Rose Terrace		Mayo Clinic Crosse Center Fo	La 🕕	NO SCALE	SHEET NUMBER T-1
- ALL WATERIAL SHALL	DE MOMELLO DI THE CONTINACION, UNLESS STATED CHIERWISE.		3		Grosse Genter 10		NO SCALE	1-1

SHEET NUMBER	SHEET TITLE
T-1	TITLE SHEET
T-2	SHEET INDEX
T-3	LEGEND
GN-1	GENERAL NOTES
MAP-1	PLANSET
C-001	DESIGN LAYOUT
C-002	DESIGN LAYOUT
C-003	DESIGN LAYOUT
D-1	DETAILS
D-2	DETAILS
D-3	DETAILS
D-4	DETAILS
TCP-1	TRAFFIC CONTROL STANDARD



3701 COMMUNICATIONS WAY EVANSVILLE, IN, 47715



1100 E. WOODFIELD ROAD, SUITE 500 SCHAUMBURG, ILLINOIS 60173 TEL: 847-908-8400 COA# 3620-11 www.fullerton-us.com

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TASK NAME

HAMILTON SCHOOL EXT

TASK DESCRIPTION

FIBER OPTIC CONDUIT PLACEMENT

PROJECT AREA

LACROSSE, WI

SHEET SCALE

N.T.S.

SHEET TITLE

SHEET INDEX

GRID NUMBER

SHEET NUMBER

	3701 COI	MMUNICATIONS WAY NSVILLE, IN, 47715	F
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×		AMILTON HOOL EXT	
	FIBER O	PTIC CONDU ACEMENT	ΙT
	L	ACROSSE, WI	
	SHEET SCALE	N.T.S.	
	SHEET TITLE	LEGEND	
	GRID NUMBER	3	

С	O	M	ΙV	IU	IN	110	C/	١Τ	10	N	S

—— ТТА ——— ТТА ———	EXISTING AT&T	(A)	EXISTING AT&T MANHOLE
————————————————————————————————————	EXISTING AT&T (ABANDON)		EXISTING ATAT MANITOLE
coco	EXISTING COMMUNICATIONS	<u>©</u>	EXISTING COMMUNICATIONS MANHOLI
	EXISTING MCI	MC	EXISTING MCI
SP SP	EXISTING SPRINT	(SP)	EXISTING SPRINT/NEXTEL MANHOLE
SN SN	EXISTING SUNESYS	(SN)	EXISTING SUNESYS MANHOLE
	EXISTING VERIZON	(VZ)	EXISTING VERIZON MANHOLE
-UF	EXISTING CITY FIBER		

MISCELLANEOUS

xxx	EXISTING FENCE	?	EXISTING MISCELLANEOUS MANHOLE
	EXISTING CONSTRUCTION FENCE	G	EXISTING GARBAGE CAN
	EXISTING GUARDRAIL	©	EXISTING PARK DISTRICT MANHOLE
	EXISTING PROPERTY LINE/ R.O.W.	M	EXISTING MONITORING WELL
←	EXISTING BIKE RACK	F	EXISTING FIRE ALARM
	EXISTING TREE	P	EXISTING STREET PARKING PAY BOX
	EXISTING BUSH		EXISTING PEDESTAL
- 0-	EXISTING STREET SIGN POST	M	EXISTING MAILBOX
®	EXISTING POST/BOLLARD	N	EXISTING NEWSPAPER BOX
¤	EXISTING GROUND LIGHT		EXISTING PHONE
\leftarrow	EXISTING UTILITY POLE	S	EXISTING SPRINKLER CONTROL BOX
Ω	EXISTING STANDPIPE	S	EXISTING SPRINKLER VALVE
ADA	EXISTING ADA RAMP	H	EXISTING SUPPORT COLUMN

PROPOSED

	PROPOSED OPEN CUT TRENCH	В	PROPOSED B-UTILITY BOXES(17X30X18)
	PROPOSED DIRECTIONAL BORE	TB	PROPOSED TERMINAL BOXES(13X24X15)
	PROPOSED BORE PIT	D8	PROPOSED DROP BOXES(11X11X12)
LHH	PROPOSED L-HANDHOLE(30X48X24)		

SEWER

	EXISTING SEWER MAIN	S
	EXISTING SEWER MAIN (ABANDON)	(1)
	EXISTING STORM SEWER MAIN	
S	EXISTING STORM MANHOLE	

PROPOSED M-HANDHOLE(24X36X18)

HH

S	EXISTING SEWER MANHOLE
(1)	EXISTING SEWER CATCH BASIN

EXISTING SEWER INLET

EXISTING STORM SEWER MAIN	
EXISTING STORM MANHOLE	

	WATER	<u>२</u>
EXISTING WATER MAIN		

——————————————————————————————————————	EXISTING WATER MAIN (ABANDON)
*So	EXISTING WATER SHUT OFF
F	EXISTING FIRE CISTERN MANHOLE
С	EXISTING WATER CAP

W	EXISTING WATER MANHOLE
©	EXISTING WATER VALVE
	EXISTING WATER METER
.	EXISTING FIRE HYDRANT

EXISTING WATER REDUCER

	EXISTING GAS MAIN	\otimes	EXISTING GAS MANHOLE
——————————————————————————————————————	EXISTING GAS MAIN (DEAD)	\otimes	EXISTING GAS VALVE
	EXISTING GAS CAP	\boxtimes	EXISTING GAS METER
\triangleright	EXISTING GAS REDUCER		

DEO/ELECTRIC

EEE	EXISTING DEO/ELECTRIC	- \$\docume{\phi}	EXISTING STREET LIGHT POLE
SLC	EXISTING STREET LIGHT CONTROL BOX	- \$\dag{\dag{\dag}}-	EXISTING TRAFFIC LIGHT POLE
TLC	EXISTING TRAFFIC LIGHT CONTROL BOX	\ \ \(\rightarrou\right\right\right\right\right\right\right\right\right\right	EXISTING DEO POLE
	EXISTING STREET LIGHT HANDHOLE	E	EXISTING ELECTRIC MANHOLE
T	EXISTING TRAFFIC LIGHT HANDHOLE	0	EXISTING ELECTRIC HANDHOLE
	EXISTING RED LIGHT CAMERA POLE	Ē	EXISTING RED LIGHT FLASH POLE

SHEET NUMBER

T-3

- 1. THE ENCLOSED DESIGN MAY IMPLY EXISTING UTILITIES. THE UTILITIES HAVE NOT BEEN FIELD VERIFIED FOR LOCATION. THEREFORE, ALL UTILITIES IMPLIED WITHIN THIS DOCUMENT ARE TO BE REFERRED TO AS A "REFERENCE TOOL". IT IS THE RESPONSIBILITY OF THE GENERAL CONTRACTOR AND/OR IT'S SUBCONTRACTOR TO VERIFY THESE UTILITIES USING ANY AND ALL METHODS AND INSTRUMENTS AVAILABLE IF/WHEN NECESSARY. FULLERTON CANNOT IN GOOD FAITH GUARANTEE UTILITY LOCATIONS. ANY AND ALL DOCUMENTATION ON EXISTING UTILITIES HAS BEEN IMPLIED UTILIZING INFORMATION RETRIEVAL PROCESSES FROM EACH JURISDICTION INVOLVED (STATE, COUNTY AND/OR MUNICIPALITY, TO INCLUDE OTHERS).
- 2. IT IS THE RESPONSIBILITY OF THE GENERAL CONTRACTOR TO ENSURE ALL CONDUITS ARE PLACED WITHIN THE GIVEN & DEDICATED SPACE LICENSED FOR THIS PARTICULAR CLIENT. FULLERTON ENGINEERING CONSULTANTS, INC. (FULLERTON) WAS NOT RETAINED FOR THE PURPOSE OF SUPPORTING A SURVEY OF THE AREA AND PROPERTY BOUNDARIES, THEREFORE FULLERTON CAN NOT AND WILL NOT SUPPORT THE ACCURACY OF ANY IMPLIED BOUNDARY (I.E. PUBLIC WAY, PRIVATE PROPERTY, EASEMENT ETC.) NOR IS IT TO BE ASSUMED THAT THE SALE OF PROPERTIES HAS NOT OCCURRED DURING & AFTER FULLERTON'S RESPONSIBILITIES FOR THIS PROJECT HAVE PAST. ALL BOUNDARIES, EASEMENTS, PROPERTY LINES, ETC. ARE TO BE USED AS A GUIDELINE OR REFERENCE AND SHOULD NOT BE TAKEN LITERALLY. IT IS THE CONTRACTOR'S RESPONSIBILITY TO HAVE ASSOCIATED BOUNDARIES SURVEY STAKED IF SO QUESTIONED. ALL ASPECTS OF BOUNDARIES IMPLIED HEREIN, HAVE BEEN DERIVED THROUGH AVAILABLE MEDIA SUCH AS BUT NOT LIMITED TO (SIDWELL, GOOGLE EARTH PRO. MUNICIPAL, STATE, COUNTY, GIS, AND OTHER RECORD TYPES). FULLERTON DOES NOT AGREE NOR DISAGREE WITH THE ABOVE-MENTIONED RECORDS AS THEY ARE USED JUST A REFERENCE TOOL.
- 3. ALL BURIED OBSTRUCTIONS KNOWN BY FULLERTON ARE SHOWN ON THE CONSTRUCTION DRAWINGS. ANY AND ALL OTHERS ENCOUNTERED DURING CONSTRUCTION ARE THE RESPONSIBILITY OF THE CONTRACTOR TO LOCATE AND PROTECT.
- 4. CONTRACTOR IS RESPONSIBLE FOR LOCATING ALL UTILITIES 48 HOURS PRIOR TO CONSTRUCTION ACTIVITY.
- SHORING MAY BE REQUIRED AND SHALL COMPLY TO O.S.H.A. STANDARDS.
- ALL BURIED CONDUIT/CABLE WILL BE PLACED AT 30-48" MINIMUM COVER UNLESS SPECIFIED OR OTHERWISE NOTED ON THE CONSTRUCTION DRAWINGS.
- 7. ANY AND ALL IMPROVEMENTS, IF DAMAGED, SHALL BE RESTORED TO ORIGINAL OR BETTER CONDITION. THIS INCLUDES BUT IS NOT LIMITED TO: ASPHALT, CONCRETE PAVEMENT, CURBS, GUTTERS, SIDEWALKS, DRAINAGE DITCHES, EMBANKMENTS, SHRUBS, TREES, GRASS SOD, ETC.
- 8. ALL FIBER INSTALLATIONS SHALL OBSERVE A MINIMUM DYNAMIC BEND RADIUS OF 20X THE CABLE DIAMETER FOR ALL OSP FIBER SHEATHS AND 15X THE CABLE DIAMETER FOR ALL ISP FIBER SHEATHS. ADDITIONALLY, ALL INSTALLATIONS SHALL OBSERVE A MINIMUM STATIC BEND RADIUS OF 15X THE CABLE DIAMETER FOR ALL OSP FIBER SHEATHS AND 10X THE CABLE DIAMETER FOR ALL ISP FIBER SHEATHS. IF THE MANUFACTURER'S SPECIFICATIONS FOR BEND RADIUS ARE GREATER, THEN THEY SHALL BE FOLLOWED.
- 9. ALL NEW METALLIC AERIAL STRAND SHALL BE BONDED/GROUNDED (PREFERABLY TO THE POWER COMPANY NEUTRAL) PER LOCAL REQUIREMENTS. AT A MINIMUM, THE BONDING/GROUNDING PATTERN SHALL BE THE FIRST AND LAST POLE OF A RUN AND EVERY TENTH POLE IN THE RUN. SHOULD ONE OF THESE DESIGNATED POLES SUPPORT A POWER TRANSFORMER, THE POLES ON EITHER SIDE OF SAID POLE SHALL BE BONDED/GROUNDED AND THE PATTERN SHOULD CONTINUE EVERY TENTH POLE FROM THAT STARTING POINT.
- 10. ALL AERIAL FIBER OPTIC CABLES SHALL BE SECURELY LASHED TO AERIAL STRAND BY METHOD OF MECHANICAL LASHING CARRIAGE OR APPROVED EQUAL.
- 11. ALL FIBER OPTIC CABLES INSTALLED BELOW GRADE SHALL BE OF AN ARMORED VARIETY WITH METALLIC INNER SHEATH, OR BE PLACED WITH A METALLIC LOCATING WIRE TO FACILITATE FUTURE LOCATING SERVICES.
- 12. ALL CONDUIT OR DUCT CONSTRUCTION SHALL INCLUDE THE PLACEMENT OF PULLING TAPE OF SUFFICIENT SIZE AND GRADE TO FACILITATE THE INSTALLATION OF THE SPECIFIED FIBER TYPE THROUGH CONDUIT BEING UTILIZED (JETLINE USE TO BE APPROVED BY CLIENT)
- 13. ALL FUSION SPLICING SHALL BE COMPLETED BY A QUALIFIED FIBER SPLICER IN A CLEAN TEMPERATURE CONTROLLED TRUCK, TRAILER, OR SHELTER SPECIFICALLY TOOLED OR DESIGNED FOR THE PURPOSE OF FUSION SPLICING FIBER OPTIC CABLES IN A FIFI D ENVIRONMENT
- 14. ALL MECHANICAL SPLICES AND FACTORY ENDS SHALL BE KEPT CLEAN AND FREE FROM DUST, DIRT, OILS, AND SMEARS. CARE SHOULD BE TAKEN TO MATCH POLISH TYPES ON FACTORY ENDS.
- 15. CONTRACTOR SHALL BE RESPONSIBLE FOR ANY AND ALL CORRECTIONS TO WORK IDENTIFIED AS UNACCEPTABLE BY CLIENT, ENGINEER, OR INSPECTOR, DURING SITE INSPECTION ACTIVITIES AND/OR AS A RESULT OF TESTING. CONTRACTOR SHALL ALSO PROVIDE ALL AS-BUILT INFORMATION UPON COMPLETION OF INSPECTION.
- 16. CONTRACTOR SHALL KEEP THE SITE FREE FROM ACCUMULATING WASTE MATERIAL, DEBRIS, AND TRASH. AT THE COMPLETION OF THE WORK, CONTRACTOR SHALL REMOVE FROM THE SITE ALL REMAINING RUBBISH, IMPLEMENTS, TEMPORARY FACILITIES, AND SURPLUS MATERIALS. CONTRACTOR TO RETURN SITE TO PREVIOUS OR BETTER CONDITION.
- 17. DRAWINGS ARE INTENDED TO SHOW DESIGN INTENT. CONTRACTOR SHALL PROVIDE MATERIALS AND LABOR AS REQUIRED TO PRODUCE A COMPLETE AND FUNCTIONING SYSTEM WHILE MEETING ALL CODES AND SPECIFICATIONS. MODIFICATIONS MAY BE REQUIRED TO SUIT JOB DIMENSIONS OR CONDITIONS. SUCH MODIFICATIONS SHALL BE INCLUDED IN THE WORK. SAID DESIGN IS INTENDED TO AVOID DISRUPTION OF ANY HANDICAP RAMPS OR STRUCTURES AS DESCRIBED PER THE AMERICANS WITH DISABILITIES ACT OF 1990.

- 18. CONTRACTOR SHALL WORK WITH CLIENT TO IDENTIFY ALL CONTRACTOR SUPPLIED MATERIALS TO CONSTRUCT NETWORK PER SPECIFICATIONS.
- 19. THE CONTRACTOR SHALL PROVIDE ALL MATERIAL, EQUIPMENT, LABOR, INSTALLATION, RESTORATION, UTILITY RELOCATION CHARGES, JOB SITE DELIVERY COSTS AND INCIDENTALS TO COMPLETE THE DESCRIBED OR ILLUSTRATED WORK UNDER THIS CONTRACT.
- 20. ANY CHANGE-ORDER REQUEST MUST BE PRESENTED IN WRITING TO THE OWNER'S REPRESENTATIVE AND APPROVED PRIOR TO PROCEEDING WITH THE REQUESTED CHANGE.
- 21. THE ENGINEER WILL NOT BE RESPONSIBLE NOR ASSUME ANY LIABILITY FOR NEGLIGENT ACTS OR ERRORS OF OMISSIONS OF ANY CONTRACTOR, ANY SUBCONTRACTOR, OR ANY OF THE PERSONS (EXCEPT ENGINEER'S OWN EMPLOYEES) AT THE PROJECT SITE OR OTHERWISE PERFORMING ANY OF THE WORK OF THE PROJECT. ANY CONTRACTOR OR SUBCONTRACTOR, AS WELL AS THE ENGINEER, WILL BE RESPONSIBLE FOR HIS OWN SAFETY PROGRAM. NEITHER THE PROFESSIONAL ACTIVITIES OF THE ENGINEER, NOR THE PRESENCE OF THE ENGINEER OR HIS OR HER EMPLOYEES AND SUB-CONSULTANTS AT THE CONSTRUCTION SITE, SHALL RELIEVE ANY CONTRACTOR OF HIS OR HER OBLIGATIONS, DUTIES AND RESPONSIBILITIES INCLUDING, BUT NOT LIMITED TO, CONSTRUCTION MEANS, METHODS, SEQUENCE, TECHNIQUES OR PROCEDURES NECESSARY FOR PERFORMING, SUPERINTENDING OR COORDINATING ALL PORTIONS OF THE WORK OF CONSTRUCTION IN ACCORDANCE WITH THE CONTRACT DOCUMENTS AND ANY HEALTH OR SAFETY PRECAUTIONS REQUIRED BY ANY REGULATORY AGENCIES. THE ENGINEER AND HIS OR HER PERSONNEL HAVE NO AUTHORITY TO EXERCISE ANY CONTROL OVER ANY CONSTRUCTION CONTRACTOR OR OTHER ENTITY OR THEIR EMPLOYEES IN CONNECTION WITH ANY HEALTH OR SAFETY PRECAUTIONS.
- 22. ALL MATERIALS INSTALLED WITHIN THE LIMITS OF THIS PROJECT SHALL BE IN CONFORMANCE WITH STANDARD RECOMMENDATIONS OF THE NATIONAL ELECTRIC MANUFACTURER'S ASSOCIATION (NEMA) AND THE AMERICAN NATIONAL STANDARDS INSTITUTE (ANSI).
- 23. THE CONTRACTOR SHALL OBTAIN ALL PERMITS AND COMPLY WITH THE REQUIREMENTS OF ALL AGENCIES HAVING JURISDICTION OVER THE WORK AND SHALL COORDINATE HIS WORK WITH THE WORK PERFORMED BY OTHERS FOR THE PURPOSE OF INSTALLATION. THIS INCLUDES, BUT IS NOT LIMITED TO, ALL WORK WITH ALL PUBLIC AND PRIVATE UTILITIES AS WELL AS CITY AND STATE AGENCIES.
- 24. CONTRACTOR SHALL RECORD THE LOCATION AND ELEVATION OF ALL UTILITIES ENCOUNTERED, AND INSTALLATION OF NEW WORK, AS THE WORK PROGRESSES AND SHALL PREPARE RECORD DRAWINGS (RED-LINES) BASED ON HIS RECORDS. AS A PART OF THE RECORD DRAWINGS, CONTRACTOR SHALL ALSO PROVIDE HORIZONTAL AND VERTICAL CONFIGURATION OF CONDUITS WHERE MULTIPLE CONDUITS ARE INSTALLED. THESE RECORDS ARE TO BE SUPPLIED TO FULLERTON ENGINEERING AT COMPLETION OF WORK.
- 25. MAINTAIN MORE THAN 2'-0" VERTICAL CLEARANCE AND MORE THAN 4'-0" HORIZONTAL CLEARANCE BETWEEN EXISTING SEWER OR SEWER STRUCTURES AND UTILITY. IF CITY SEWER FACILITIES ARE DAMAGED DURING CONSTRUCTION, IT MUST BE REPORTED TO CITY ENGINEERING SECTION AND MUST BE REPAIRED BY A LICENSED DRAIN LAYER UNDER THE SUPERVISION OF THE MASON INSPECTOR.
- 26. NO STORAGE OF EQUIPMENT OR MATERIALS IN THE ROADWAY IS PERMITTED UNLESS THE CONTRACTOR OBTAINS WRITTEN PERMISSION FROM THE CITY, STATE, AND/OR GOVERNING BODY.
- 27. CONTRACTOR RESPONSIBLE FOR OBTAINING AND PROVIDING REVIEW AND DESIGN OF ANY AND ALL SHORING SYSTEMS PRIOR TO CONSTRUCTION.
- 28. THE ENGINEER SHALL BE NOTIFIED FOR DISPOSITION OF SITUATIONS WHERE THE CONDUIT CANNOT MAINTAIN SEPARATIONS PER PLAN
- 29. THE CONTRACTOR IS RESPONSIBLE FOR THE RESTORATION OF THE AREAS DISTURBED BY CONSTRUCTION ACTIVITIES.

 CONTRACTOR IS TO PAY ALL FEES AND OBTAIN ALL PERMITS FOR RESTORATION. CONTRACTOR IS TO RESTORE ALL DAMAGED STRUCTURES AND UTILITIES TO THE SATISFACTION OF THE FACILITY OWNER OR THE GOVERNING BODY, IN THE EVENT THAT DAMAGE OCCURS
- 30. USE EXTREME CAUTION NEAR ALL GAS FACILITIES DURING CONSTRUCTION AND RELATED EXCAVATION ACTIVITIES, HAND EXCAVATION IS REQUIRED TO VERIFY THE HORIZONTAL AND VERTICAL LOCATION OF GAS MAIN(S) PRIOR TO CROSSING AND WORKING WITHIN 3 FEET OF ALL GAS FACILITIES. A MINIMUM OF 3 FEET HORIZONTAL EDGE TO EDGE CLEARANCE IS REQUIRED FOR GAS MAINS WITH DIAMETERS OF 16 INCHES OR SMALLER, AND 5 FEET EDGE TO EDGE CLEARANCE FOR GAS MAINS WITH DIAMETERS 18 INCHES AND LARGER IN DIAMETER. THE USE OF CONCRETE, FLOW FILL, OR THE LIKE IS PROHIBITED WITHIN 24 INCHES OF ALL GAS FACILITIES, NOR SHALL IT ENCASE ANY GAS FACILITY. SAND IS TO BE USED AS A BUFFER BETWEEN FLOWABLE FILL AND ALL GAS FACILITIES, ANY DAMAGE TO GAS FACILITIES SHALL BE THE RESPONSIBILITY OF THE INSTALLING UTILITY AND THEIR CONTRACTORS.

3701 COMMUNICATIONS WAY EVANSVILLE, IN. 47715



I 100 E. WOODFIELD ROAD, SUITE 500 SCHAUMBURG, ILLINOIS 60173 TEL: 847-908-8400 COA# 3620-11

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TASK NAME

HAMILTON SCHOOL EXT

SK DESCRIPTION

FIBER OPTIC CONDUIT
PLACEMENT

PROJECT AREA

LACROSSE, WI

SHEET SCALE

N.T.S.

SHEET TITLE

GENERAL NOTES

GRID NUMBER

SHEET NUMBER

GN-

_____ 4



3701 COMMUNICATIONS WAY EVANSVILLE, IN, 47715



1100 E. WOODFIELD ROAD, SUITE 500 SCHAUMBURG, ILLINOIS 60173 TEL: 847-908-8400 COA# 3620-11 www.fullerton-us.com

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HAMILTON SCHOOL EXT

TASK DESCRIPTION

FIBER OPTIC CONDUIT **PLACEMENT**

LACROSSE, WI

SHEET SCALE

N.T.S.

SHEET TITLE


MAP

GRID NUMBER

SHEET NUMBER

MAP-1

11'x17' SCALE: NTS **PLANSET** 24'x36' SCALE: NTS

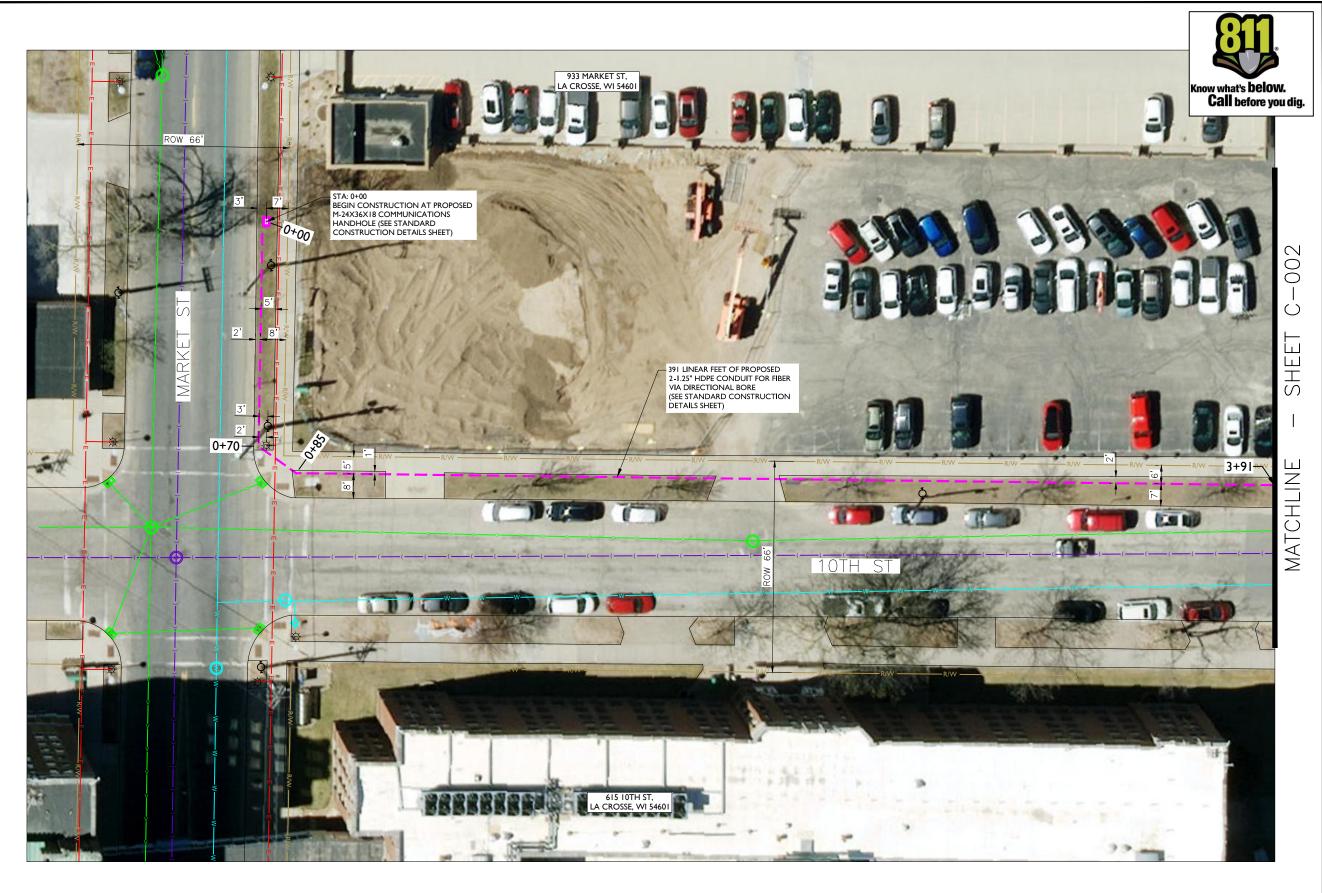

3701 COMMUNICATIONS WAY EVANSVILLE, IN, 47715

Fullerten DESIGN DEVELOP CONSTRUCT

1100 E. WOODFIELD ROAD, SUITE 500 SCHAUMBURG, ILLINOIS 60173 TEL: 847-908-8400 COA# 3620-11

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TASK NA

HAMILTON SCHOOL EXT

TASK DESCRIPTION

FIBER OPTIC CONDUIT PLACEMENT

PROJECT ARE

LACROSSE, WI

SHEET SCALE

1" = 30'-0"

SHEET TITLE

DESIGN LAYOUT

GRID NUMBER

SHEET NUMBER

C-001

NOTE:

PROPOSED CONDUIT SHALL AVOID EXISTING SEEPAGE BEDS

BURY AT 24" MIN. UNDER SOFT SURFACE

BURY AT 36" MIN. UNDER HARD SURFACE
MAINTAIN 1' FROM BACK OF SIDEWALK, WHEN APPLICABLE.

NOTE:


METRONET WILL MAINTAIN 5' CLEARANCE FROM EXISTING INLETS, MANHOLES, VALVES, AND FIRE HYDRANTS & 7.5' CLEARANCE FROM MANHOLES AND CATCH BASINS.

NOTE:

RIGHT-OF-WAY LINES SHOWN ARE INFORMATION PROVIDED IN GIS FILE OBTAINED FROM LA CROSSE COUNTY. THE INTENT OF THIS DRAWING IS THAT ALL PROPOSED CONDUIT IS TO BE PLACED WITHIN THE RIGHT-OF-WAY, AT THE BACK OF THE RIGHT-OF-WAY, OR WITHIN THE CITED EASEMENTS.

NOTE:

PRIOR TO CONSTRUCTION ALL CATCH BASIN AT THE INTERSECTION MUST BE PROPERLY LOCATED AND AVOIDED. METRONET TO STAY TOWARD THE BACK OF THE WALK UNTIL 20+ FEET PAST XCEL'S POLE TO CLEAR IT.

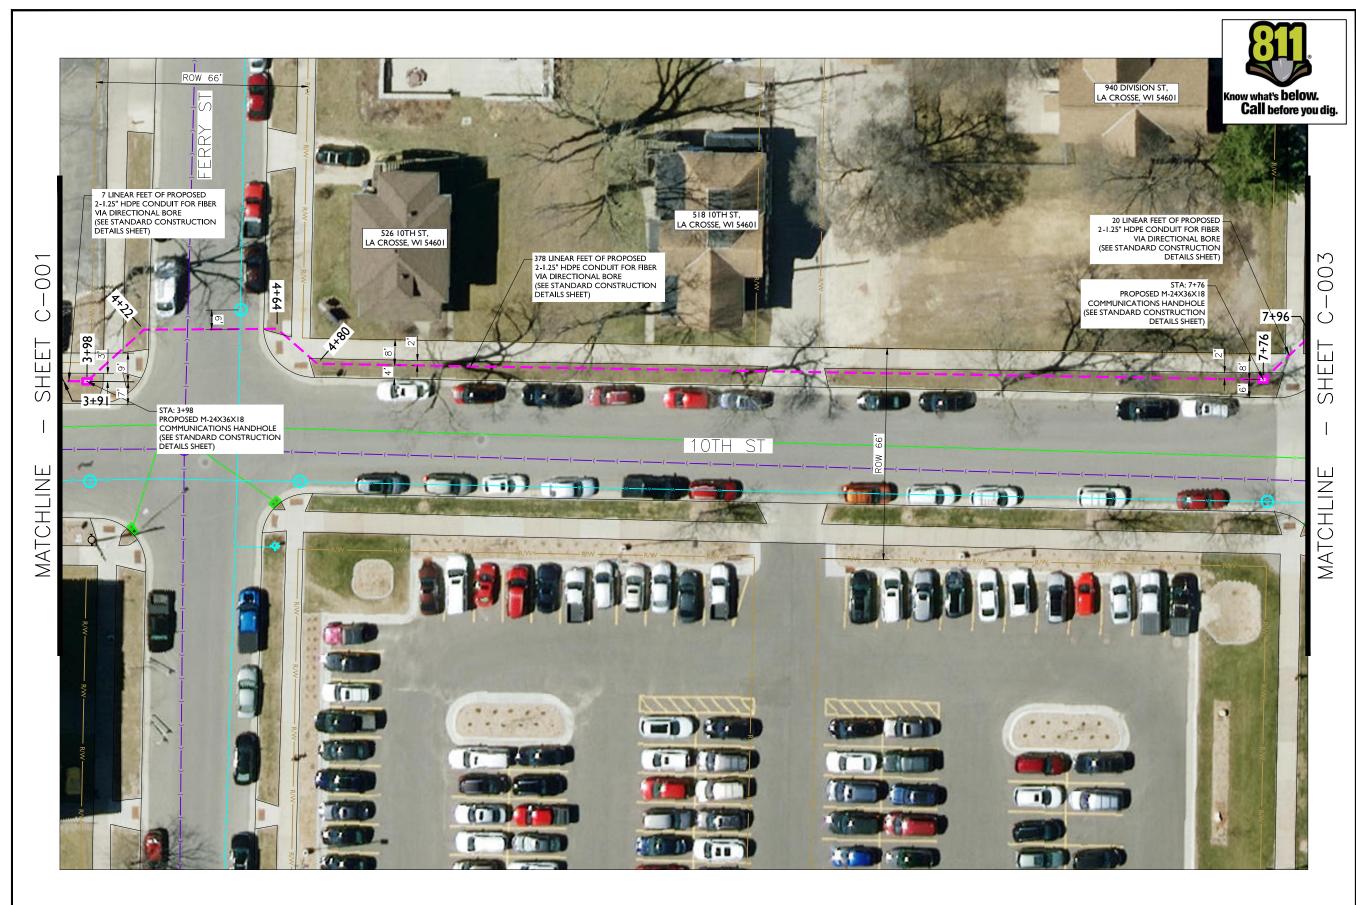

- NOTE:

 PROPOSED CONDUIT SHALL AVOID EXISTING SEEPAGE BEDS
- BURY AT 24" MIN. UNDER SOFT SURFACE
- BURY AT 36" MIN. UNDER HARD SURFACE
- MAINTAIN 1' FROM BACK OF SIDEWALK, WHEN APPLICABLE.

NOTE:

METRONET WILL MAINTAIN 5' CLEARANCE FROM EXISTING INLETS, MANHOLES, VALVES, AND FIRE HYDRANTS & 7.5' CLEARANCE FROM MANHOLES AND CATCH BASINS.

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NOTE:

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metronet

3701 COMMUNICATIONS WAY EVANSVILLE, IN, 47715



I 100 E. WOODFIELD ROAD, SUITE 500 SCHAUMBURG, ILLINOIS 60173 TEL: 847-908-8400 COA# 3620-11

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TASK NAME

HAMILTON SCHOOL EXT

TASK DESCRIPTION

FIBER OPTIC CONDUIT PLACEMENT

PROJECT ARE

LACROSSE, WI

SHEET SCALE

1" = 30'-0"

SHEET TITLE

DESIGN LAYOUT

GRID NUMBER

SHEET NUMBER

C-002

C-(



- PROPOSED CONDUIT SHALL AVOID EXISTING SEEPAGE BEDS BURY AT 24" MIN. UNDER SOFT SURFACE

- BURY AT 36" MIN. UNDER HARD SURFACE MAINTAIN 1' FROM BACK OF SIDEWALK, WHEN APPLICABLE.

METRONET WILL MAINTAIN 5' CLEARANCE FROM EXISTING INLETS, MANHOLES, VALVES, AND FIRE HYDRANTS & 7.5' CLEARANCE FROM MANHOLES AND CATCH BASINS.

NOTE:

RIGHT-OF-WAY LINES SHOWN ARE INFORMATION PROVIDED IN GIS FILE OBTAINED FROM LA CROSSE COUNTY. THE INTENT OF THIS DRAWING IS THAT ALL PROPOSED CONDUIT IS TO BE PLACED WITHIN THE RIGHT-OF-WAY, AT THE BACK OF THE RIGHT-OF-WAY, OR WITHIN THE CITED EASEMENTS.

NOTE:

PRIOR TO CONSTRUCTION ALL CATCH BASIN AT THE INTERSECTION MUST BE PROPERLY LOCATED AND AVOIDED. METRONET TO STAY TOWARD THE BACK OF THE WALK UNTIL 20+ FEET PAST XCEL'S POLE TO CLEAR IT.

metronet

3701 COMMUNICATIONS WAY EVANSVILLE, IN, 47715



I 100 E. WOODFIELD ROAD, SUITE 500 SCHAUMBURG, ILLINOIS 60173 TEL: 847-908-8400 COA# 3620-11

REV	DATE	DESCRIPTION	BY
Α	06/03/25	ISSUED FOR REVIEW	BP
В	06/11/25	REVISED	GB
		·	

I HEREBY CERTIFY THAT THESE DRAWINGS WERE PREPARED BY ME OR UNDER MY DIRECT SUPERVISION AND CONTROL, AND TO THE BEST OF MY KNOWLEDGE AND BELIEF COMPLY WITH THE REQUIREMENTS OF ALL APPLICABLE CODES.

HAMILTON SCHOOL EXT

TASK DESCRIPTION

FIBER OPTIC CONDUIT **PLACEMENT**

LACROSSE, WI

SHEET SCALE

1" = 30'-0"

SHEET TITLE

DESIGN LAYOUT

GRID NUMBER

C-003

SHEET NUMBER

TYPICAL DETAIL DIRECTIONAL BORE CROSS SECTION (1) 1.25" CONDUIT AT 30"MIN -EXISTING GRADE 30" MIN COVER NOTE: DEPTH WILL VARY AND WILL BE ADJUSTED TO A GREATER DEPTH AS └─(1) 1.25" CONDUIT EXISTING UTILITIES ARE LOCATED AND DEPTHS ARE PROVIDED BY LOCATOR.


ADDITIONAL NOTES:

- 1. EXCEPT AS OTHERWISE NOTED, CONTRACTOR SHALL MAINTAIN A MINIMUM OF 24 INCHES OF SEPARATION FROM EXISTING UTILITIES.
- 2. CONTRACTOR SHALL POTHOLE EACH UTILITY TO DETERMINE SIZE. LOCATION, AND DEPTH PRIOR TO CROSSING.
- 3. CONTRACTOR IS CAUTIONED TO PROTECT SEWER MANHOLES, CATCH BASINS, LATERALS AND INLETS.
- 4. CONTRACTOR WILL PROVIDE BARRICADING TO INSURE CORRECT TRAFFIC CONTROL WHILE MAINTAINING VEHICULAR TRAFFIC AT ALL TIMES.
- 5. RESTORATION TO BE IN COMPLIANCE WITH APPLICABLE PERMITING
- 6. BONDING AND GROUNDING PER NESC.

PUBLIC UTILITY NOTE:

CONTRACTOR SHALL NOTIFY ALL PUBLIC UTILITY COMPANIES (GAS, ELECTRIC, TELEPHONE, SEWER, WATER, ETC) PRIOR TO COMMENCING ANY CONSTRUCTION. THESE COMPANIES WILL LOCATE, ON THE GROUND, THE LOCATION OF ALL CONDUITS, DUCTS, UNDERGROUND PIPING,

ETC., ADJOINING & CROSSING PROPOSED CONSTRUCTION.

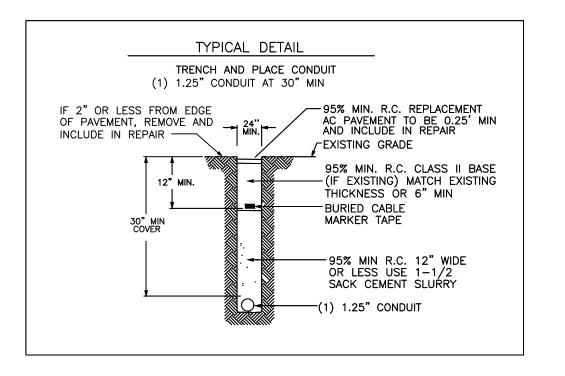

metronet

3701 COMMUNICATIONS WAY EVANSVILLE, IN, 47715



1100 E. WOODFIELD ROAD, SUITE 500 SCHAUMBURG, ILLINOIS 60173 TEL: 847-908-8400 COA# 3620-11

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TASK NAME

HAMILTON SCHOOL EXT

TASK DESCRIPTION

FIBER OPTIC CONDUIT **PLACEMENT**

LACROSSE, WI

SHEET SCALE

N.T.S.

DETAILS

SHEET TITLE


GRID NUMBER


SHEET NUMBER


11'x17' SCALE: NTS

24'x36' SCALE: NTS

TRENCH AND BORE TYPICAL DETAIL

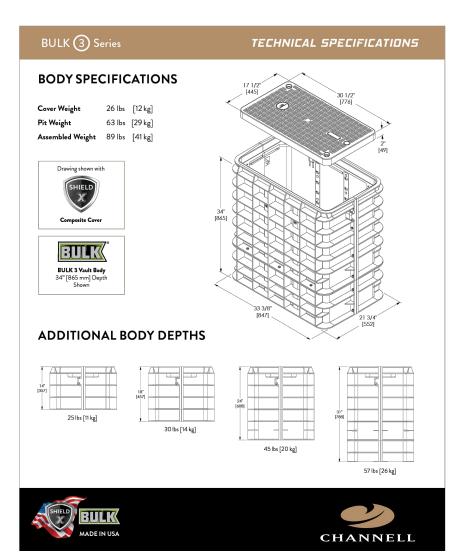

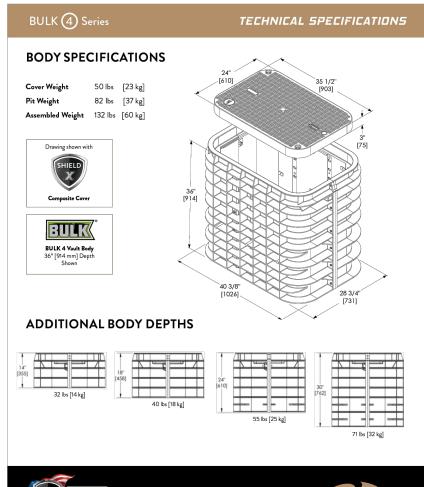

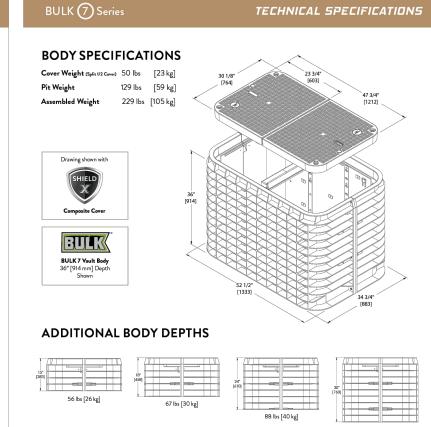



B-HANDHOLE (17X30X18) SCALE: N.T.S.

M-HANDHOLE (24X36X18) SCALE: N.T.Ś.

CHANNELL

LHH-HANDHOLE (30X48X24) SCALE: N.T.Ś.

metronet 3701 COMMUNICATIONS WAY EVANSVILLE, IN, 47715



1100 E. WOODFIELD ROAD, SUITE 500 SCHAUMBURG, ILLINOIS 60173 TEL: 847-908-8400 COA# 3620-11

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HAMILTON SCHOOL EXT

TASK DESCRIPTION

FIBER OPTIC CONDUIT **PLACEMENT**

LACROSSE, WI

SHEET SCALE

N.T.S.

SHEET TITLE

DETAILS

SHEET NUMBER

GRID NUMBER

11'x17' SCALE: NTS

24'x36' SCALE: NTS

HANDHOLE DETAIL



DATA SHEET

SGLB-0 NEW SIGNATURE SERIES GRADE LEVEL BOX WITH **SELFLOCK** PROTECTION





SELF_LOCK


The New Signature Series SGLB High Density Polyethylene (HDPE) grade level box line come standard with Logo Disk and the Patented SELFLOCK automatic locking mechanism.

FEATURES

- 13" (330mm) Depth
- No bolts to be lost, misplaced, or not installed back into the unit
- Captive bolt device, that opens with a ¼ turn
- Press/Push lid closed, and it will automatically lock in place (with an audible "click")
- Protects your investment, and ensures the needed protection for your network
- Eliminates the risk of lids floating off, being throw be lawnmowers (i.e. reduces potentially liability)


SIMPLE AND WORRY FREE PROTECTION



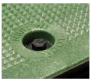



DIMENSIONS

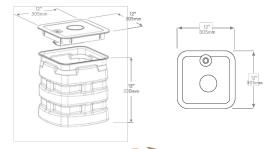



WORLDWIDE HEADQUARTERS: Channell Commercial Corporation, Rockwall, TX, United Shates • Tel 800.423.1863 • Fax 951.296.2322

CANADA: Channell Canada, Inc., Mississauga, ON, Canada • Tel 905.565.1700 • Fax 905.565.8282

EURDPG, INDIAL EAST, APRIGA: Channell Ltd., Dartford, United Kingdom • Tel 44.1322.312590 • Fax 44.1322.508490

AUSTRALIA, JSII, MORTIC Bills Channell Py, Ltd., Seven Hills, KSV, Australia • Tel 612.2884.4111 • Fax 612.88814.8841

www.channell.com

DB-HANDHOLE (12X12X13)SCALE: N.T.Ś.

DATA SHEET

SGLB-2 SIGNATURE SERIES GRADE LEVEL BOX



SELF_LOCK

The Signature Series SGLB-2 High Density Polyethylene (HDPE) grade level box line comes standard with Customizable Logo Disk and the Patented SELFLOCK automatic locking mechanism.

FEATURES

HANDHOLE DETAIL

- Designed for Greenbelt/Pedestrial
- No bolts to be lost, misplaced, or not installed back into the unit Press/Push lid closed, and it will
- automatically lock in place (with an audible "click")
- Secondary lock option
- Temporary drop port
- Protects your investment, and ensures the needed protection for your network
- Eliminates the risk of lids floating off, being thrown by lawnmowers (i.e. reduc

SIMPLE AND WORRY FREE PROTECTION











DIMENSIONS



TB-HANDHOLE (15X24X18)SCALE: N.T.Ś.

11'x17' SCALE: NTS 24'x36' SCALE: NTS

metronet

3701 COMMUNICATIONS WAY EVANSVILLE, IN, 47715



1100 E. WOODFIELD ROAD, SUITE 500 SCHAUMBURG, ILLINOIS 60173 TEL: 847-908-8400 COA# 3620-11

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TASK NAME

HAMILTON SCHOOL EXT

TASK DESCRIPTION

FIBER OPTIC CONDUIT **PLACEMENT**

SHEET SCALE

SHEET TITLE

LACROSSE, WI

N.T.S.

DETAILS

GRID NUMBER

SHEET NUMBER

NOTES:


- 1. CALL FOR LOCATES AT LEAST 72 HOURS IN ADVANCE OF ANY CONSTRUCTION FOR MARKINGS.
- 2. FOR LABEL AND TAG INFORMATION SEE DRAWING OSP 16.
- 3. THE VAULT W/ BOTTOM ENTRY ELEVATION WIEW SHOWN BELOW DNLY INDICATES THE BACK FILL REQUIREMENTS INCCESSARY FOR VAULTS PLACED IN SIDEWALKS, ETC. (WHERE THEY NEED TO COMPLY WITH ADA REQUIREMENTS), TO ENSURE COMPLIANCE WITH CURRENT ADA REQUIREMENTS, THE HEIGHT OF THE BACK FILL IS SHOWN HELD DOWN TO ALLOW CONCRETE TO FLOW DOWN AND AROUND THE LIFTING LUCS/BOLTS WHICH WILL SERVE AS DOWELS INTO THE FINISHED CONCRETE SLAB,

6" MIN.

TRACER WIRE

FIBER OPTIC TAG WRAP


VAULT W/ BOTTOM ENTRY

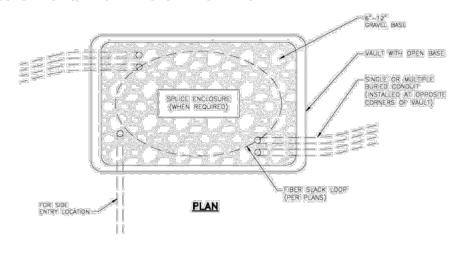

6" MINIMUM EXCAVATION

VAULT COVER FLUSH WITH SIDEWALK (SEE ADA REQUIREMENTS)


- VAULT

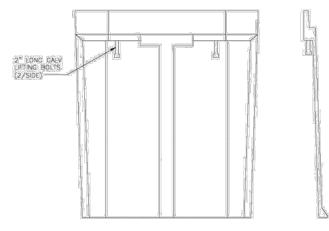

SIDE VIEW

NOTE:

1. ENCLOSURES, BOXES AND COVERS ARE REQUIRED TO MEET OR EXCEED ALL TESTS PROVISIONS OF THE MOST CURRENT ANSI/SCIE 77=2007 "SPECIFICATIONS FOR UNDERGROUND INTEGRITY" FOR THER 15 OR BETTER.

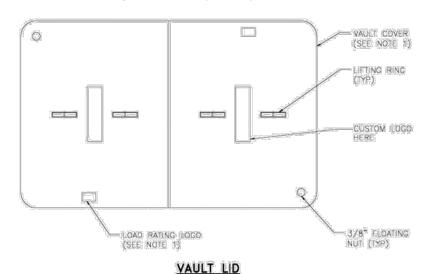

ADA REQUIREMENTS:

SURFACE LEVEL CRITERIA. NO HEIGHT DIFFERENTIALS WITH A UP GREATER THAN IX IN HEIGHT, EXCEPTIONS: A HEIGHT DIFFERENTIAL BETWEEN X AND X IS ACCEPTABLE IF IT IS BEVELED AT A Z:1 SLOPE, OR A HEIGHT DIFFERENTIAL GREATER THAN IS IS ACCEPTABLE IF IT IS RAMPED WITH A SLOPE OF 8.53% (1V.12H) OR LESS.

UTILITY COVERS SHALL HAVE A SUP RESISTANT TOP, AS MUCH AS POSSIBLE, AND MEET CHANGES IN LEVEL CRITERIA AS STATED ABOVE.

WET HOLES FOR UTILITY COVERS SHALL NOT HAVE AN OPENING GREATER THAN \overline{k} . Plugging of holes greater than \overline{k} with a material approved by the engineer is acceptable as long as it is flush with the cover surface.

A LEVEL PEDESTRIAN ACCESS ROUTE (PAR) OR WALKWAY SHALL BE PROVIDED ACROSS COMMERCIAL AND RESIDENTIAL ENTRANCES, MEETING THE FOLLOWING CRITERIA:


IF HE WALKWAY IS AT MINIMUM 3 WIDE

CROSS SLOPE OF WALKWAY IS 2% OR LESS.

WALKWAY IS AT THE SAME CRADE AS THE ADJACENT ROADWAY.

THE WALKWAY DOES NOT HAVE TO BE MARKED, BUT PROVIDES A STRAIGHT LINE BETWEEN THE ADJOINING SIDEWALKS OR RAMPS.

THERE IS NOT AN ABRUPT TRANSITION FROM THE DRIVEWAY TO THE ROADWAY FOR VEHICLES, I.E., VEHICLES WILL NOT BOILTOM OUT WHEN DRIVING OVER THE TRANSITION.

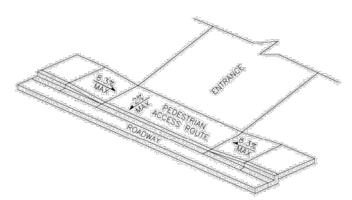

PEDESTRIAN ACCESS ROUTE

lmetronet

3701 COMMUNICATIONS WAY FVANSVILLE IN 47715



1100 E. WOODFIELD ROAD, SUITE 500 SCHAUMBURG, ILLINOIS 60173 TEL: 847-908-8400 COA# 3620-11 www.fullerton-us.com

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TASK NAME

HAMILTON SCHOOL EXT

TASK DESCRIPTION

FIBER OPTIC CONDUIT **PLACEMENT**

PROJECT AREA

LACROSSE, WI

SHEET SCALE

N.T.S.

SHEET TITLE

DETAILS

GRID NUMBER

SHEET NUMBER



REVOCABLE OCCUPANCY / STREET PRIVILEGE PERMIT APPLICATIONFOR COMMUNICATIONS (FIBER OPTICS, TELEPHONE, CABLE, ETC.) City of La Crosse Engineering Department

Phone: 608-789-7505 Email: engineering@cityoflacrosse.org http://cityoflacrosse.org

Address:	Διρ
Relationship with Owner:	
Relationship with Owner:	
Encroachment Addresses (List by Street and 100 blocks): Certify that I have reviewed the Municipal Code and understand all that is related to this permit request. I further certify that I have the full authority to make the foregoing application; the information in the application and the required submittals are complete and correct; the Work or Use performed shall comply with all the laws of the State of Wisconsin, and all ordinances, rules, regulations, policies and special conditions of the City of La Crosse. The applicant agrees to perform the work covered by an approved permit with diligence and convenience to the public. See Sheet 2 of 2 for Additional Conditions. Signature of Owner or designee:	
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Initial Application Fee \$ Permit Number:	Encroachment Type:
Permit Number:	
City Utility Potential Conflict Notification and Sign-Off	
	Permit Number:
All Fees are Non-Refundable & Subject to change by City Council	-



REVOCABLE OCCUPANCY / STREET PRIVILEGE PERMIT APPLICATION

City of La Crosse Engineering Department

Phone: 608-789-7505 Email: engineering@cityoflacrosse.org http://cityoflacrosse.org

STREET PRIVILEGE PERMIT CONDITIONS FOR COMMUNICATIONS INSTALLATIONS

- 1. The applicant shall be primarily liable for damages to person or property by reason of the granting of this street privilege permit.
- 2. The applicant shall obtain an excavation permit from the City of La Crosse Engineering Department prior to performing installation or any maintenance on the cable in the City right-of-way that requires excavation or disruption of pavement, sidewalk, curb and gutter, or other structure.
- The applicant agrees that tracer wires shall be used and final cable location within the street right-of-way shall be approved by the City Engineer. Cable shall be installed not less than 36 inches deep, unless otherwise approved by the City Engineer.
- 4. Applicant agrees to provide the City of La Crosse with final "as-built" plans when installation is complete.
- 5. Applicant agrees that any pavement, concrete or green space disturbed during drilling activities shall be restored to its prior condition.
- 6. Applicant agrees that said installation shall not interfere with the City's water, sanitary sewer, or storm sewer underground infrastructure that may be in the area.
- 7. Applicant further agrees that they will make arrangements with the public utility companies and the City of La Crosse to clear all public underground utilities prior to initiating such work, and if necessary, applicant will make arrangements with the City of La Crosse to ensure proper traffic control.
- 8. Applicant waives any and all rights to contest in any way or manner the validity of Sec. 66.0425 of the Wisconsin Statutes and the amount of compensation charged.
- 9. Applicant agrees to become a member of Diggers Hotline for marking / locating of utility.
- 10. The applicant for a permit to encroach on the public right-of-way shall procure and maintain for the duration of the permit a minimum liability and contractual liability policy in the amount of \$100,000.00 each person, \$300,000.00 each accident for bodily injury and \$100,000.00 for property damage. A certificate of such insurance shall be filed with the City Attorney as part of the application. The insurance shall name the City, its officials, employees and agents as additional insureds. The Board may approve greater insurance protection on a case-by-case basis.
- 11. Applicant further agrees to hold harmless the City for any damage to said cable while the City, its agents or contractors are conducting construction for maintenance activities in or upon such area in which said cable lies; provided, however, the City shall make a good faith effort to notify applicant of any maintenance or work in the area of the street privilege permit which may damage applicant's cable.
- 12. Applicant agrees to remove the cable and return the area to its original condition upon ten (10) days' notice by the Board of Public Works. The applicant further agrees that if it does not remove the cable within ten (10) days after receiving notice, the City is authorized to remove the same and applicant agrees to pay the City for all costs of such removal.
- 13. Applicant further agrees that the obligations and conditions of this street privilege permit shall be binding upon all heirs, successors and assigns of applicant.
- 14. The person(s) signing this Permit warrant that they have the authority to sign as, or on behalf of, the party for whom they are signing.

Sheet 2 of 2



City of La Crosse, Wisconsin

City Hall 400 La Crosse Street La Crosse, WI 54601

Text File

File Number: 25-0676

Agenda Date: 6/16/2025 Version: 1 Status: Agenda Ready

In Control: Board of Public Works File Type: General Item





FOR COMMUNICATIONS (FIBER OPTICS, TELEPHONE, CABLE, ETC.) City of La Crosso Engineering Department

Address:	nit request. I further certify that I d the required submittals are if Wisconsin, and all ordinances, les to perform the work covered by additional Conditions. Date: Decklist below to: City of La Crosse notice of when your request will be ation 45 days.
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	Board of Public Works
le Drawing of encroachments	Approval Date:
y Utilities, Lighting and Signals must be shown on	
posed Communications Plan)	Encroachment Type:
tificate of Insurance (City as additional Insured)	
al Application Fee \$	Permit Number:
y Utility Potential Conflict Notification and Sign-Off	



REVOCABLE OCCUPANCY / STREET PRIVILEGE PERMIT APPLICATION

City of La Crosse Engineering Department

Phone: 608-789-7505 Email: engineering@cityoflacrosse.org http://cityoflacrosse.org

STREET PRIVILEGE PERMIT CONDITIONS FOR COMMUNICATIONS INSTALLATIONS

- 1. The applicant shall be primarily liable for damages to person or property by reason of the granting of this street privilege permit.
- 2. The applicant shall obtain an excavation permit from the City of La Crosse Engineering Department prior to performing installation or any maintenance on the cable in the City right-of-way that requires excavation or disruption of pavement, sidewalk, curb and gutter, or other structure.
- The applicant agrees that tracer wires shall be used and final cable location within the street right-of-way shall be approved by the City Engineer. Cable shall be installed not less than 36 inches deep, unless otherwise approved by the City Engineer.
- 4. Applicant agrees to provide the City of La Crosse with final "as-built" plans when installation is complete.
- 5. Applicant agrees that any pavement, concrete or green space disturbed during drilling activities shall be restored to its prior condition.
- 6. Applicant agrees that said installation shall not interfere with the City's water, sanitary sewer, or storm sewer underground infrastructure that may be in the area.
- 7. Applicant further agrees that they will make arrangements with the public utility companies and the City of La Crosse to clear all public underground utilities prior to initiating such work, and if necessary, applicant will make arrangements with the City of La Crosse to ensure proper traffic control.
- 8. Applicant waives any and all rights to contest in any way or manner the validity of Sec. 66.0425 of the Wisconsin Statutes and the amount of compensation charged.
- 9. Applicant agrees to become a member of Diggers Hotline for marking / locating of utility.
- 10. The applicant for a permit to encroach on the public right-of-way shall procure and maintain for the duration of the permit a minimum liability and contractual liability policy in the amount of \$100,000.00 each person, \$300,000.00 each accident for bodily injury and \$100,000.00 for property damage. A certificate of such insurance shall be filed with the City Attorney as part of the application. The insurance shall name the City, its officials, employees and agents as additional insureds. The Board may approve greater insurance protection on a case-by-case basis.
- 11. Applicant further agrees to hold harmless the City for any damage to said cable while the City, its agents or contractors are conducting construction for maintenance activities in or upon such area in which said cable lies; provided, however, the City shall make a good faith effort to notify applicant of any maintenance or work in the area of the street privilege permit which may damage applicant's cable.
- 12. Applicant agrees to remove the cable and return the area to its original condition upon ten (10) days' notice by the Board of Public Works. The applicant further agrees that if it does not remove the cable within ten (10) days after receiving notice, the City is authorized to remove the same and applicant agrees to pay the City for all costs of such removal.
- 13. Applicant further agrees that the obligations and conditions of this street privilege permit shall be binding upon all heirs, successors and assigns of applicant.
- 14. The person(s) signing this Permit warrant that they have the authority to sign as, or on behalf of, the party for whom they are signing.

Sheet 2 of 2



City of La Crosse, Wisconsin

City Hall 400 La Crosse Street La Crosse, WI 54601

Text File

File Number: 25-0677

Agenda Date: 6/16/2025 Version: 1 Status: Agenda Ready

In Control: Board of Public Works File Type: General Item



REVOCABLE OCCUPANCY / STREET PRIVILEGE PERMIT APPLICATIONFOR COMMUNICATIONS (FIBER OPTICS, TELEPHONE, CABLE, ETC.) City of La Crosse Engineering Department

Phone: 608-789-7505 Email: engineering@cityoflacrosse.org http://cityoflacrosse.org

Encroachment Owner: Brightspeed of Wisconsin, LLC				
Address: 1120 South Tryon St #700 City: Charlotte	State: <u>NC </u>			
Phone # <u>980-376-1808</u> Email Address	s holly.tindall@brightspeed.com			
Application Preparer (if different from above)CNS Net	works, LLC			
Relationship with Owner: Consulting Firm				
Phone # <u>762-246-7989</u> Email Address	s bbruneau@congruex.com			
Description of Proposed Encroachment:				
Brightspeed proposes to bore and place 2,188 ft of (1)-2" cor	nduit; Place eight (8) 17"x30"x18" HH.			
Encroachment Addresses (List by Street and 100 blocks):				
2525 Shelby Rd				
I certify that I have reviewed the Municipal Code and understand all that is relahave the full authority to make the foregoing application; the information in the complete and correct; the Work or Use performed shall comply with all the law rules, regulations, policies and special conditions of the City of La Crosse. The an approved permit with diligence and convenience to the public. See Shee	application and the required submittals are s of the State of Wisconsin, and all ordinances, applicant agrees to perform the work covered by			
Oiment and Common and a single Brittany Bruneau	D-4 00/00/000E			
Signature of Owner or designee: Brittany Bruneau - Permit Specialist Date: 06/02/2025 Print Name and Title: Brittany Bruneau - Permit Specialist				
Print Name and Title. Drittarry Druneau - Permit Specialist				
Please return this completed application along with required information and fe Engineering Department, 400 La Crosse Street, La Crosse, WI 54601. You will on the Board of Public Works agenda for consideration. Average completion	I then be given notice of when your request will be			
BELOW THIS LINE TO BE COMPLETED B	Y CITY STAFF ONLY			
Required items to be provided by Applicant:	Board of Public Works			
Required items to be provided by Applicant.				
L	Approval Date:			
Scale Drawing of encroachments				
(City Utilities, Lighting and Signals must be shown on				
Proposed Communications Plan)	Encroachment Type:			
	J			
Certificate of Insurance (City as additional Insured)				
Initial Application Fee \$	Permit Number:			
City Utility Potential Conflict Notification and Sign-Off				
All Fees are Non-Refundable & Subject to change by City Council	SHEET 1 OF 2			



REVOCABLE OCCUPANCY / STREET PRIVILEGE PERMIT APPLICATION

City of La Crosse Engineering Department

Phone: 608-789-7505 Email: engineering@cityoflacrosse.org http://cityoflacrosse.org


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Sheet 2 of 2

BRIGHTSPEED LA CROSSE

2525 SHELBY RD. EAST AVE. S & SHELBY RD. CITY OF LA CROSSE, WI



TRAFFIC CONTROL PLAN

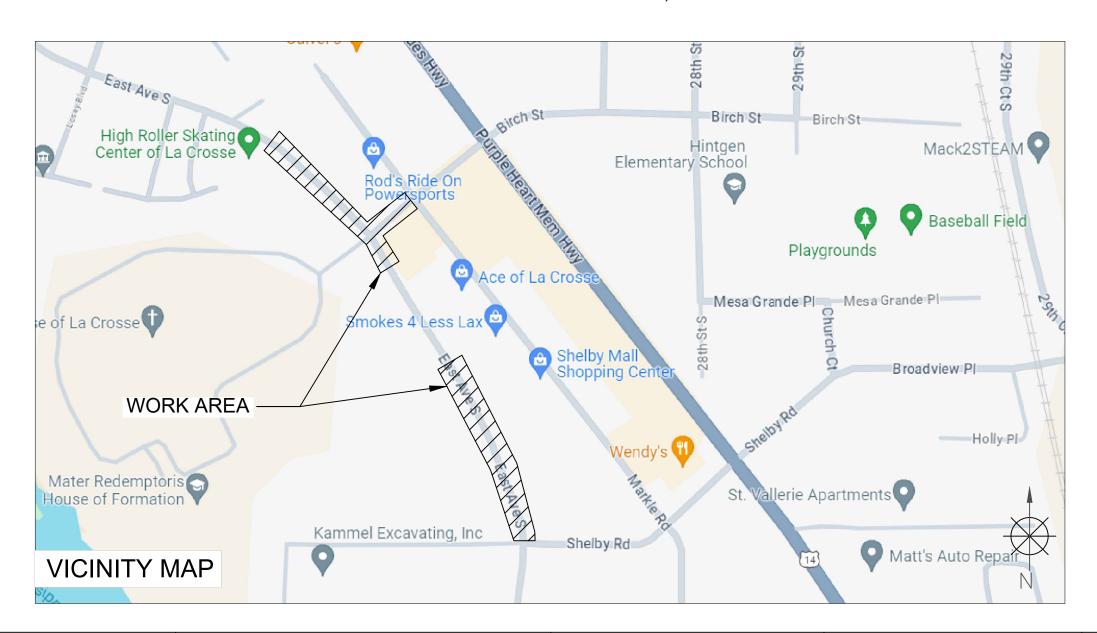	SCOPE OF WORK	SHEET INDEX		
-	HH & RISER PLACEMENT BORING	SHEET	DESCRIPTION	
		KEYMAP	VICINITY MAP & SCOPE OF WORK	
		TC-1 TO TC-6	TRAFFIC CONTROL PLAN	

PERMITTING AGENCY CITY OF LA CROSSE


PROPOSED PATH FOOTAGE
UG PATH = 2.188'



◯ X CHC
A CONGRUEX° COMPANY
9095 Rio San Diego Dr. Ste 165
San Diego, CA 92108-1694
(949)250-0004 /FAX (949)250-0006
REVISIONS

BRIGHTSPEED

			REVISIONS	
	DATE	BY	DESCRIPTION	REV.
1.00014/11/0	05/24/24	S.M.	INITIAL DESIGN	0
LCRSWIXB				
KEYMAP				
N.T.S.				

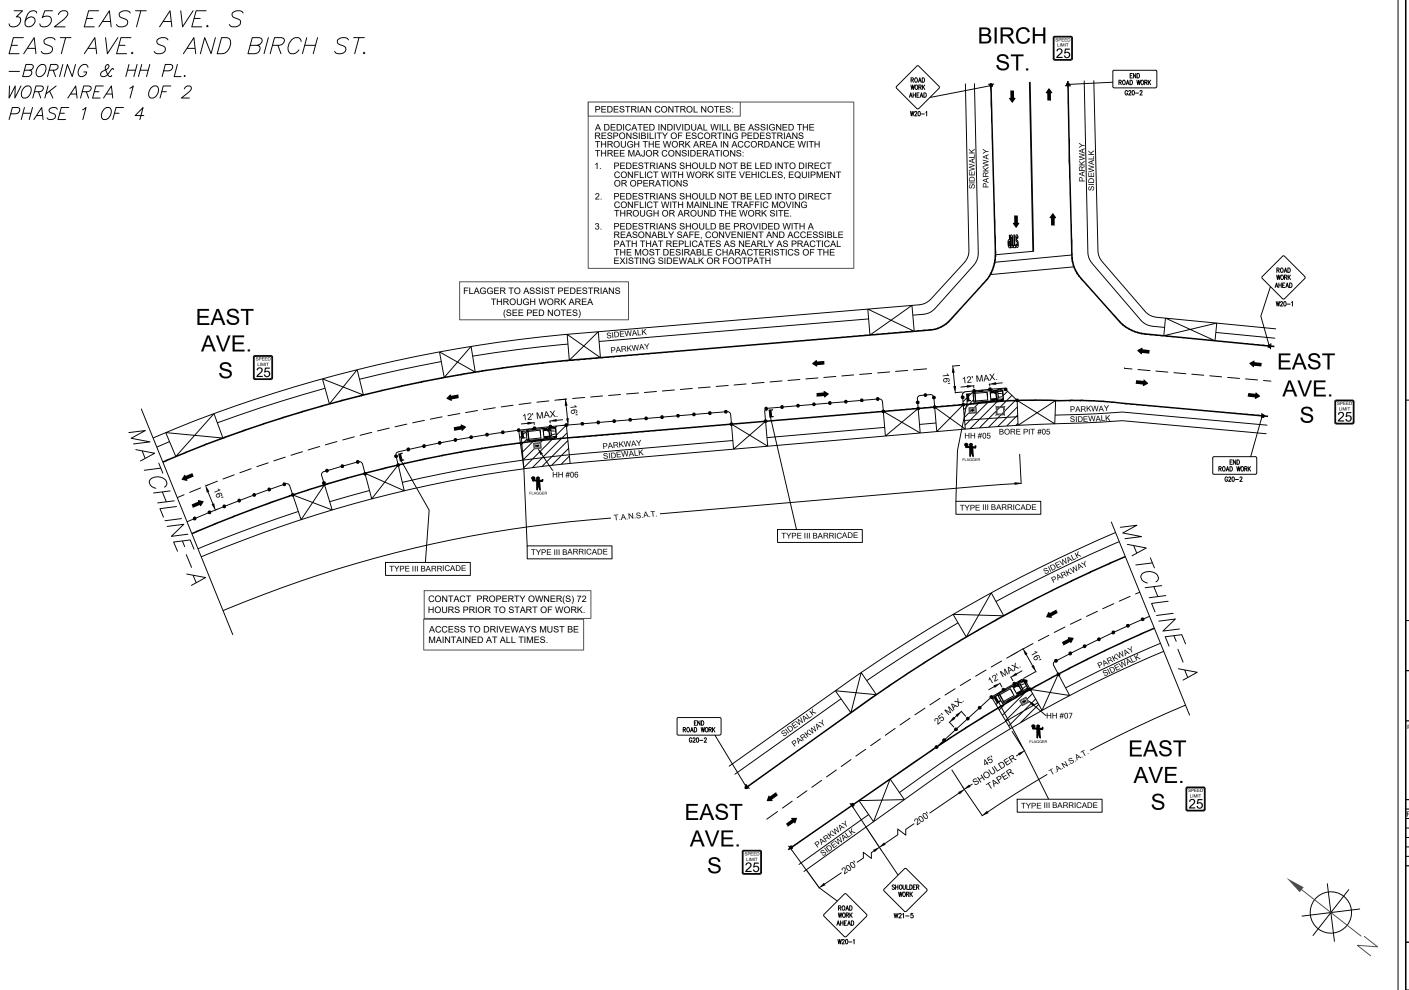

PORTABLE FLASHING BEACON (P.F.B.)

TYPE III BARRICADE W/SIGN

TYPE II BARRICADE W/SIGN

CHANNELIZING DEVICE

TRAFFIC CONE WITH CLIP ON SIGN

TYPE I W/ SIGN

EXISTING SIGN

SIGNALIZED INTERSECTION

₹ FLASHING ARROW BOARD

→ HIGH LEVEL WARNING DEVICE

(FLAGTREE)

FLAGGER

TANSAT TO

TOW AWAY NO STOPPING ANY TIME

E.

WORK ZONE (ACTIVITY AREA) LIMITS

EXISTING DRIVEWAY

DIRECTION OF TRAFFIC (NOT PAVEMENT MARKING)

CALL 811 BEFORE YOU DIG. WISCONSIN TOLL FREE 800-242-8511

BRIGHTSPEED

LANS PREPARED BY:

XCHC

A CONGRUEX' COMPANY 9095 Rio San Diego Dr. Ste 165 San Diego, CA 92108-1694 (949) 250-0004 /FAX (949)250-0006

REV.	DESCRIPTION	BY	DATE
0	INITIAL DESIGN	S.M.	05/24/2


BRIGHTSPEED

CONFIDENTIAL AND PROPRIETARY

LCRSWIXB

TC-1 OF TC-6

SCALE: 1": 60'

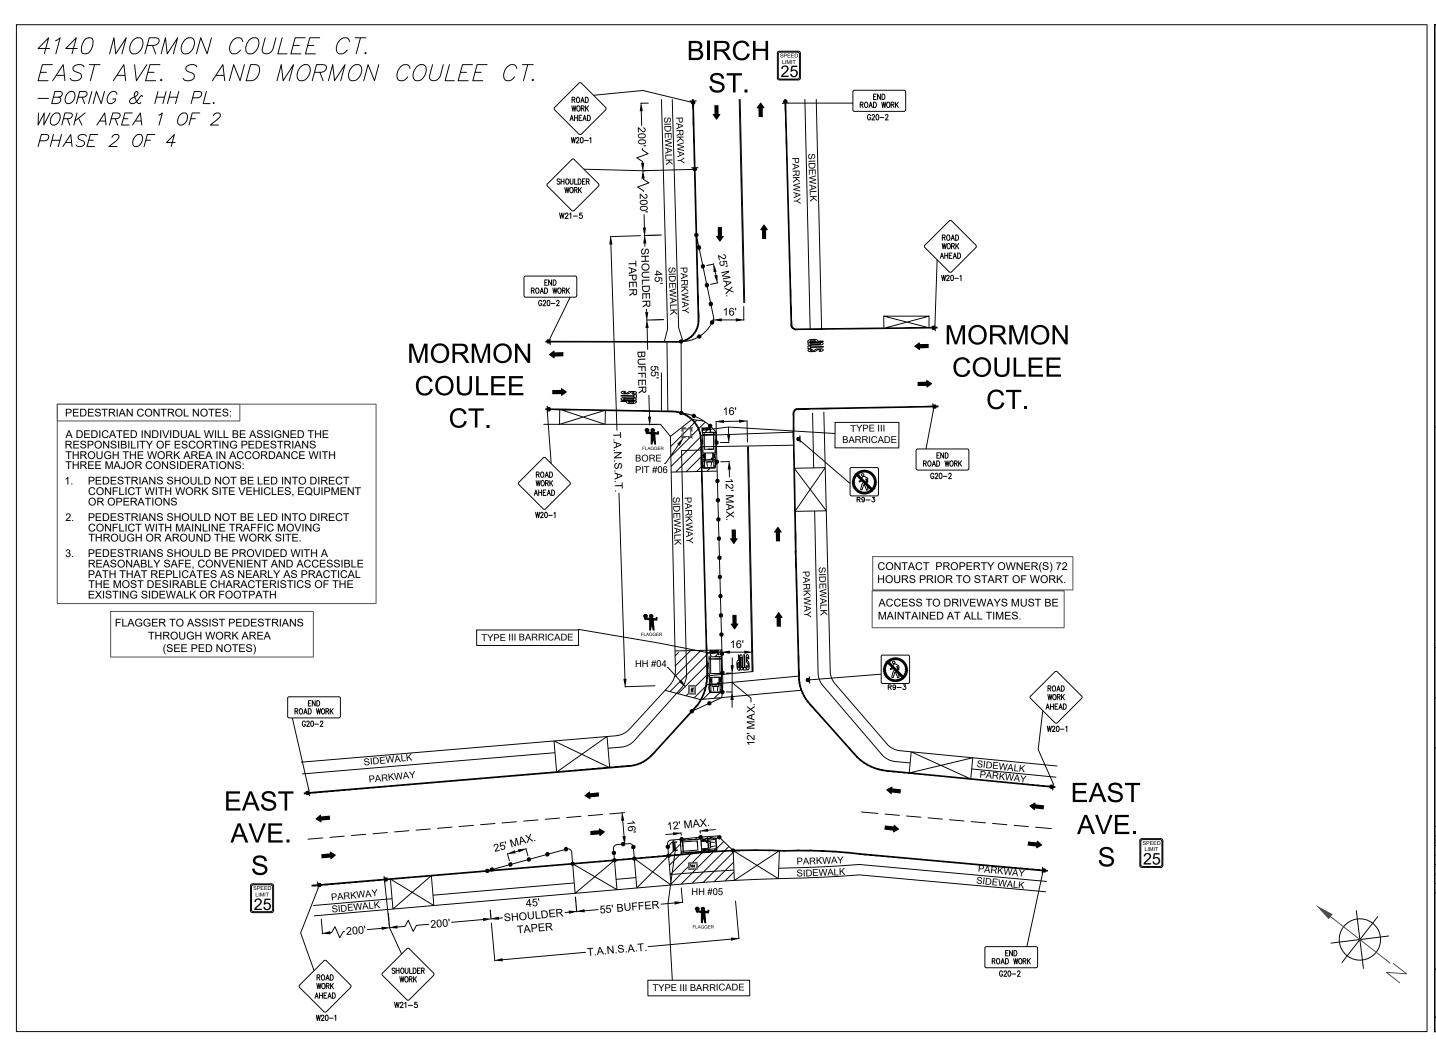

PORTABLE FLASHING BEACON (P.F.B.)

TYPE III BARRICADE W/SIGN

CHANNELIZING DEVICE

TRAFFIC CONE WITH CLIP ON SIGN

TYPE I W/ SIGN

EXISTING SIGN

SIGNALIZED INTERSECTION

0.0.....

FLASHING ARROW BOARD

Y HIGH LEVEL WARNING DEVICE (FLAGTREE)

FLAGGER

TANSAT

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EXISTING DRIVEWAY

WORK ZONE
(ACTIVITY AREA) LIMITS

DIRECTION OF TRAFFIC (NOT PAVEMENT MARKING)

CALL 811 BEFORE YOU DIG. WISCONSIN TOLL FREE 800-242-8511

BRIGHTSPEED

PLANS PREPARED B

XCHC

A CONGRUEX COMPANY 9095 Rio San Diego Dr. Ste 165 San Diego, CA 92108-1694 (949)250-0004 FAX (949)250-0006

	INEVISIONS					
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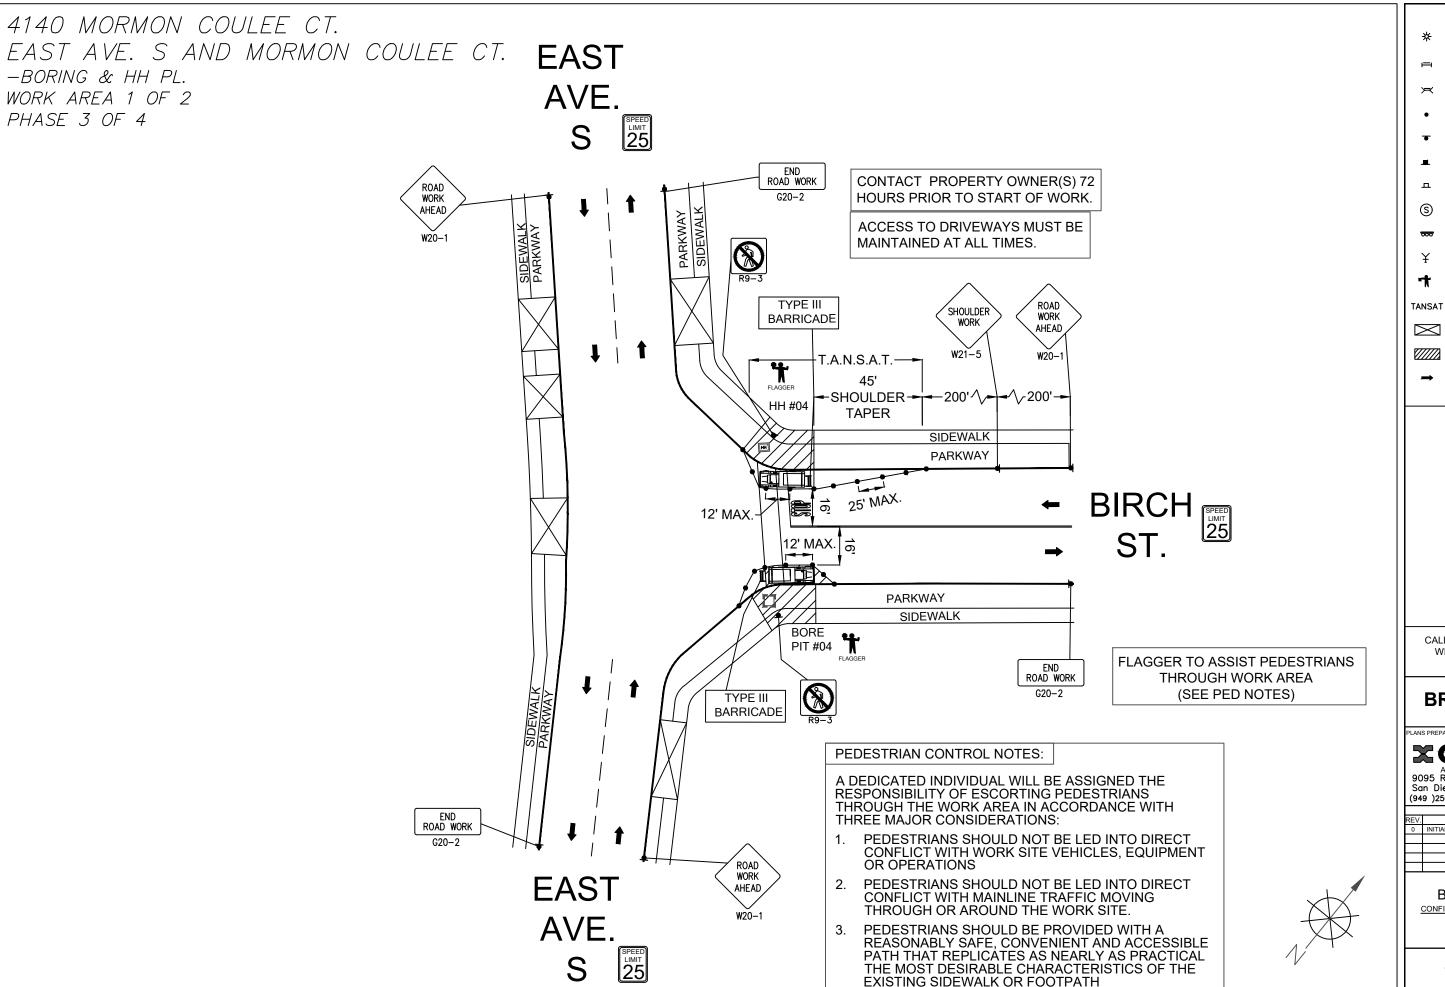
BRIGHTSPEED

CONFIDENTIAL AND PROPRIETARY

LCRSWIXB

TC-2 OF TC-6

SCALE: 1": 50'



PORTABLE FLASHING BEACON (P.F.B.)

TYPE III BARRICADE W/SIGN

TYPE II BARRICADE W/SIGN

CHANNELIZING DEVICE

TRAFFIC CONE WITH CLIP ON SIGN

TYPE I W/ SIGN

EXISTING SIGN

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EXISTING DRIVEWAY WORK ZONE (ACTIVITY AREA) LIMITS

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BRIGHTSPEED

XCHC

A CONGRUEX COMPANY 9095 Rio San Diego Dr. Ste 165 San Diego, CA 92108-1694 (949)250-0004 FAX (949)250-0006

REVISIONS				
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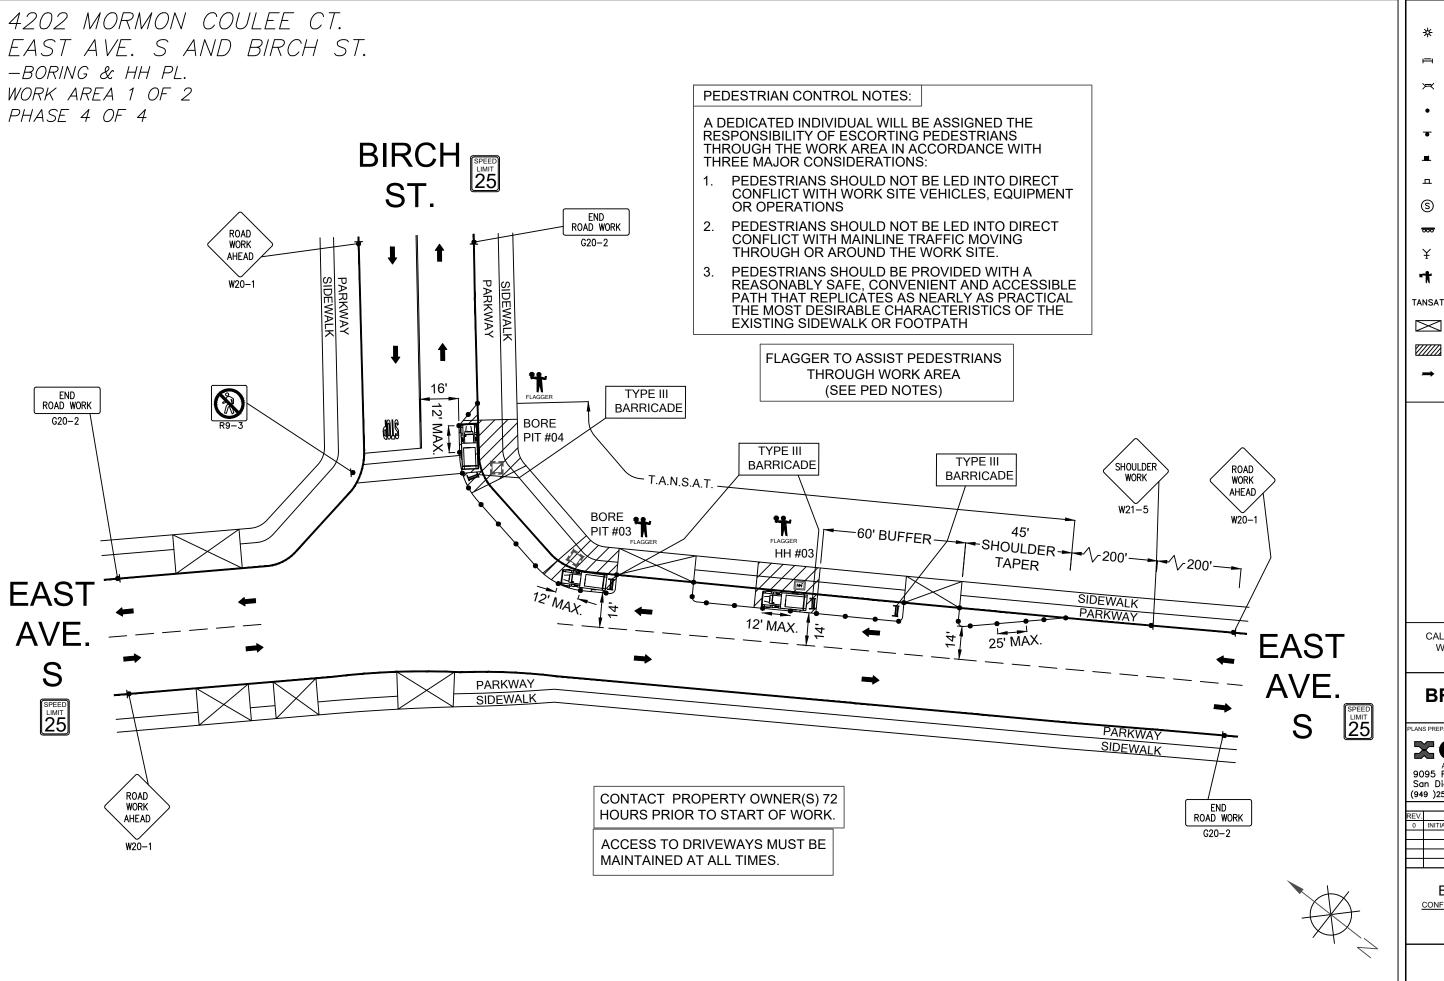
BRIGHTSPEED

CONFIDENTIAL AND PROPRIETARY

LCRSWIXB

TC-3 OF TC-6

SCALE: 1": 40'



PORTABLE FLASHING BEACON (P.F.B.)

TYPE III BARRICADE W/SIGN

TYPE II BARRICADE W/SIGN

CHANNELIZING DEVICE

TRAFFIC CONE WITH CLIP ON SIGN

TYPE I W/ SIGN

EXISTING SIGN

SIGNALIZED INTERSECTION

FLASHING ARROW BOARD

HIGH LEVEL WARNING DEVICE (FLAGTREE)

FLAGGER

TANSAT

TOW AWAY NO STOPPING ANY TIME

WORK ZONE (ACTIVITY AREA) LIMITS

EXISTING DRIVEWAY

DIRECTION OF TRAFFIC (NOT PAVEMENT MARKING)

CALL 811 BEFORE YOU DIG. WISCONSIN TOLL FREE 800-242-8511

BRIGHTSPEED

≅CHC

A CONGRUEX COMPANY 9095 Rio San Diego Dr. Ste 165 San Diego, CA 92108-1694 (949)250-0004 FAX (949)250-0006

	REVISIONS					
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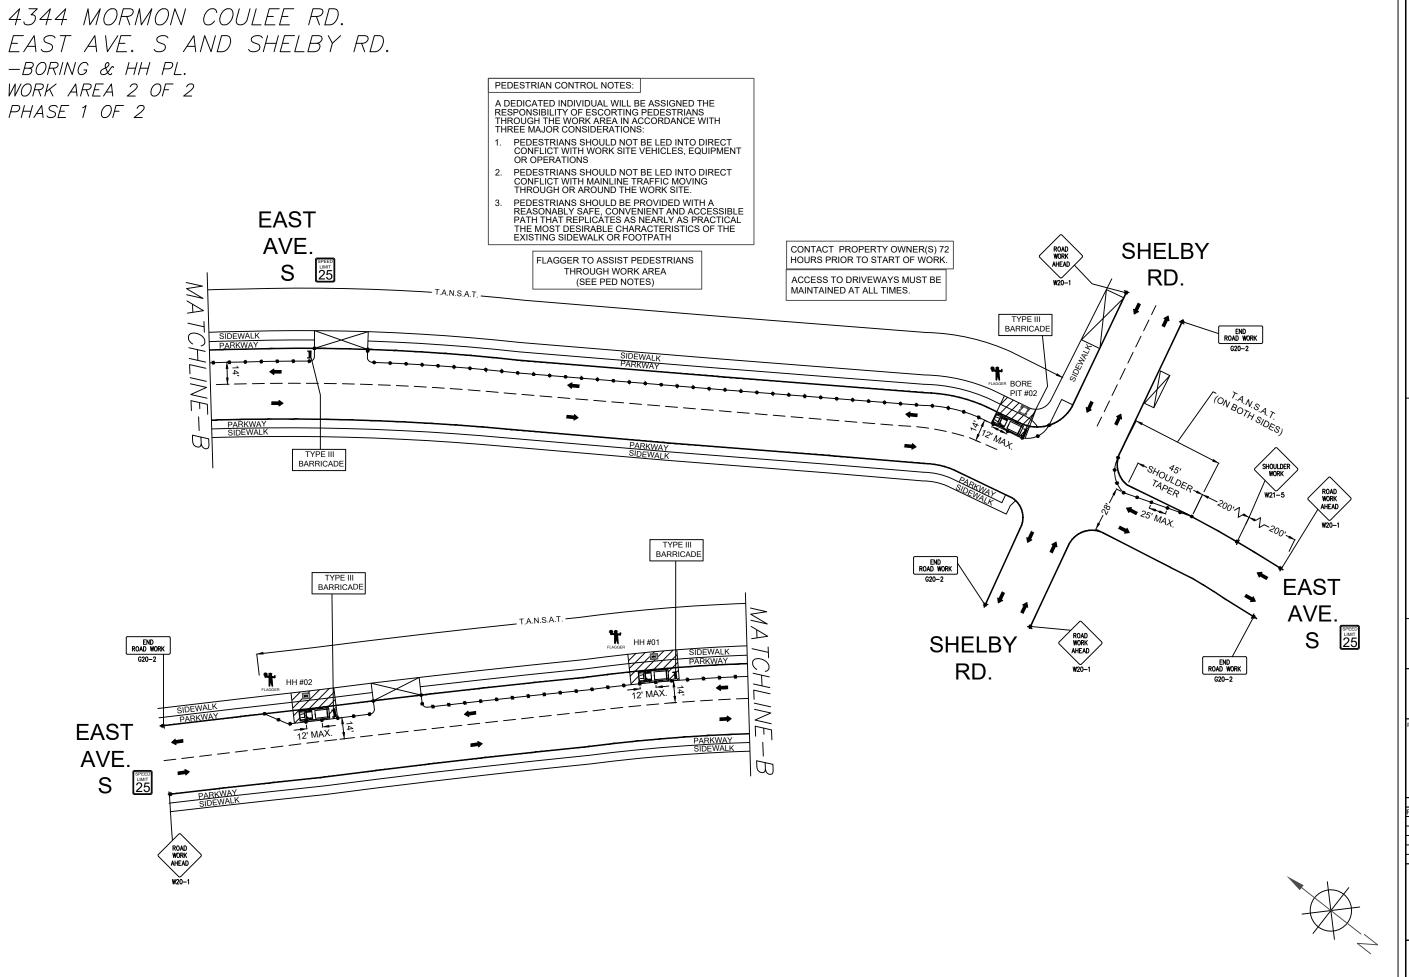
BRIGHTSPEED

CONFIDENTIAL AND PROPRIETARY

LCRSWIXB

TC-4 OF TC-6

SCALE: 1": 40'



PORTABLE FLASHING BEACON (P.F.B.)

TYPE III BARRICADE W/SIGN

TYPE II BARRICADE W/SIGN

CHANNELIZING DEVICE

TRAFFIC CONE WITH CLIP ON SIGN

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EXISTING SIGN

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> <

EXISTING DRIVEWAY WORK ZONE (ACTIVITY AREA) LIMITS

DIRECTION OF TRAFFIC (NOT PAVEMENT MARKING)

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BRIGHTSPEED

LANS PREPARED BY:

XCHC

A CONGRUEX COMPANY 9095 Rio San Diego Dr. Ste 165 San Diego, CA 92108-1694 (949)250-0004 FAX (949)250-0006

	REVISIONS		
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BRIGHTSPEED


CONFIDENTIAL AND PROPRIETARY


LCRSWIXB

TC-5 OF TC-6

SCALE: 1": 60'

4344 MORMON COULEE CT.
EAST AVE. S AND SHELBY RD.
-BORING & RISER PL.
WORK AREA 2 OF 2
PHASE 2 OF 2

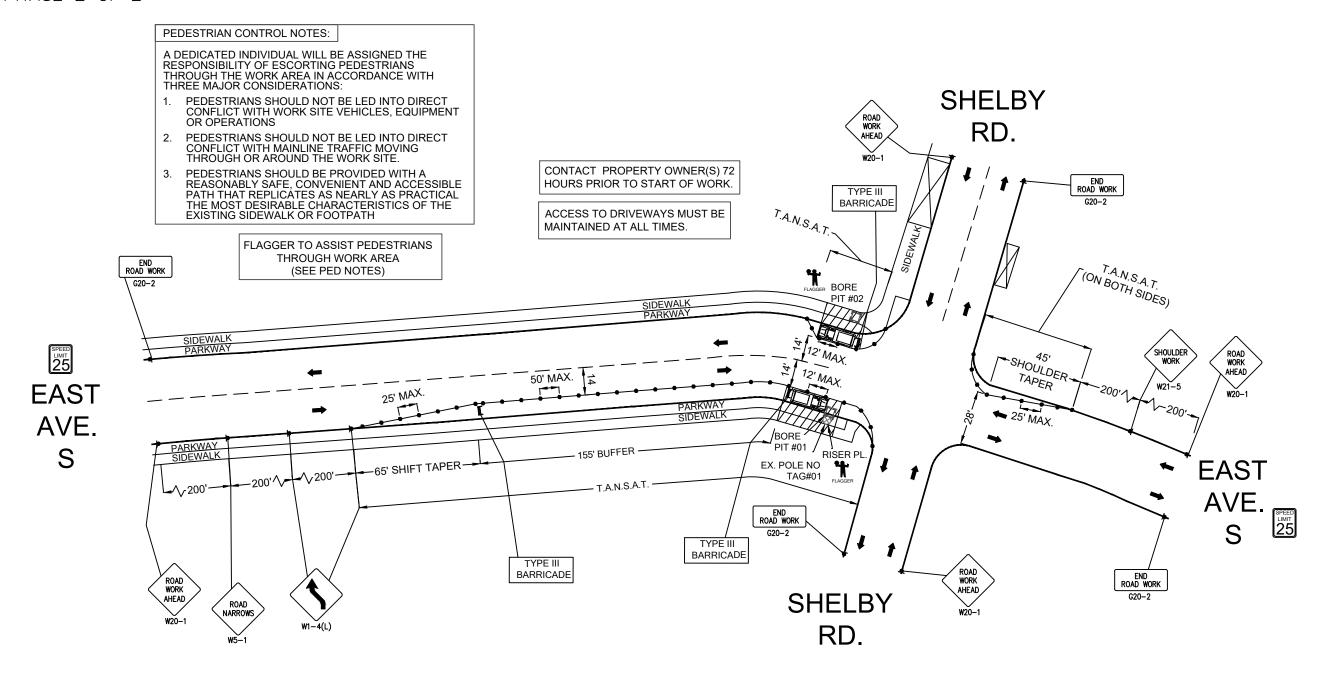

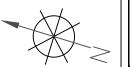

LEGEND

PORTABLE FLASHING BEACON (P.F.B.)

TYPE III BARRICADE W/SIGN

TYPE II BARRICADE W/SIGN

CHANNELIZING DEVICE

TRAFFIC CONE WITH CLIP ON SIGN

■L TYPE I W/ SIGN

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0.0.....

FLASHING ARROW BOARD

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BRIGHTSPEED

LANS PREPARED BY:

≅CHC

A CONGRUEX' COMPANY 9095 Rio San Diego Dr. Ste 165 San Diego, CA 92108-1694 (949) 250-0004 /FAX (949)250-0006

	REVISIONS		
REV.	DESCRIPTION	BY	DATE
0	INITIAL DESIGN	S.M.	05/24/24

BRIGHTSPEED
CONFIDENTIAL AND PROPRIETARY

1.000/4/1/0

LCRSWIXB

TC-6 OF TC-6

SCALE: 1": 50'

BRIGHTSPEED LA CROSSE


LCRSWIXB 2525 SHELBY RD, LA CROSSE, WI 54601, USA CONDUIT LAYOUT

Sheet List Table			
Sheet Number Sheet Title			
01	COVER SHEET		
02	GENERAL NOTES		
03	LEGENDS		
04	TYPICAL		
05-08	FIBER LAYOUTS		

Material List Table				
ITEM	QUANTITY			
FEEDER FIBER	00			
JUMPER	00			
17"X30"X18" HH	08			
12"X24"X18" HH	00			
24"X36"X24" HH	00			
2" CONDUIT	2,188'			
NEW STRAND	00			
ANCHOR	00			

BLM I	BLM INFO				
SECTION	S16				
MUNICIPALITY	LA CROSSE				
TOWNSHIP	T15N				
COUNTY	LA CROSSE				
RANGE	R7W				

N	DATE	DESCRIPTION	
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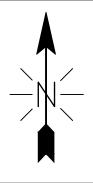


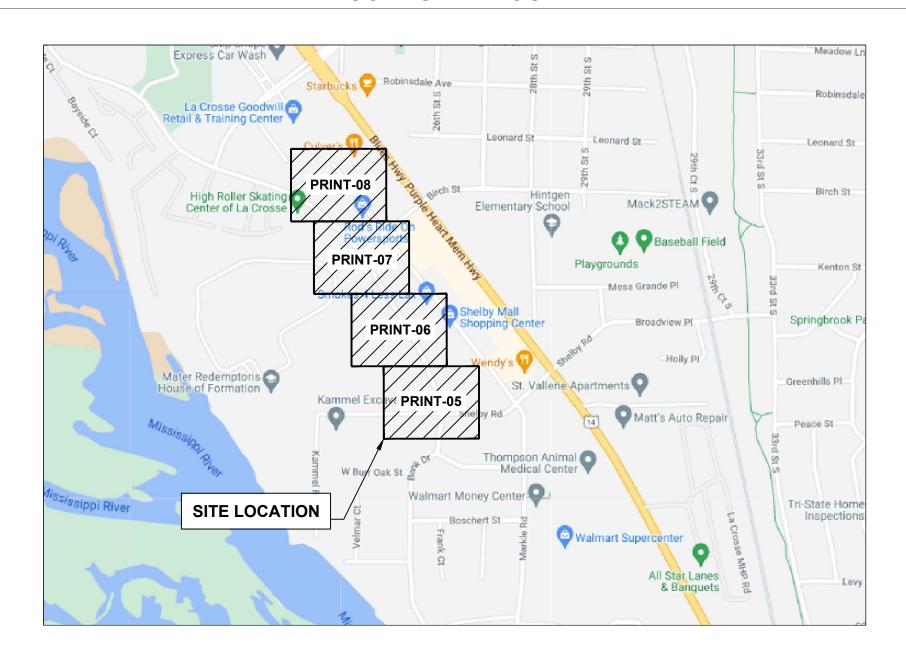GENERAL ABBREVIATIONS

R/W	RIGHT OF WAY
S/W	SIDEWALK
C/L	CENTER LINE
CSW	CONCRETE SIDEWALK
DWY	DRIVEWAY
FOC	FACE OF CURB
BOC	BACK OF CURB
EOC	EDGE OF CURB
EOP	EDGE OF PAVEMENT
ETW	ETW LINE
HH	HANDHOLE
MH	MANHOLE
N.T.S.	NOT TO SCALE
CONC	CONCRETE
PED	PEDESTAL (UTILITY)
PVC	POLYVINYL CHLORIDE
P/L	PROPERTY LINE
RR	RAILROAD
SL	STREET LIGHT
W-BLDG	WALL TO BUILDING
W-P	WALL TO POLE
W-W	WALL TO WALL
U/E	UTILITY EASEMENT
SD	STORM DRAIN
TS	TRAFFIC SIGNAL

PERMITTING AGENCY CITY OF LA CROSSE

LINEAR PATH FOOTAGE UNDERGROUND PATH - 2,188 FT







🔆 brightspeed

LCRSWIXB

COVER SHEET



GENERAL NOTES



PLAN SHEET DISCLAIMER:

- 1. EVERY REASONABLE EFFORT HAS BEEN MADE TO ASSURE THE ACCURACY OF THESE PLANS AND ASSOCIATED DATA.
- 2. IN AN EFFORT TO INCREASE THE CLARITY AND LEGIBILITY OF THE PLANS, EXISTING UNDERGROUND UTILITIES WILL NOT BE SHOWN UNLESS THERE IS PROPOSED WORK THAT WILL REQUIRE EXCAVATION OR ANY OTHER EARTH DISTURBING ACTIVITY. IF PROPOSED WORK WILL REQUIRE THIS TYPE OF ACTIVITY. EXISTING UNDERGROUND UTILITIES WILL BE PROPERLY INVESTIGATED AND REPRESENTED ON THE PLAN SHEET OF THE RESPECTIVE WORK LOCATION

UTILITIES

- 1. THE IDENTITY AND LOCATION OF EXISTING UNDERGROUND UTILITIES LOCATED IN AND AROUND THE CONSTRUCTION AREA HAVE BEEN SHOWN AND LABELED ON THE PLANS BY USING INFORMATION PROVIDED BY THE RESPECTIVE UTILITY OWNERS.
- 2. SUPPORT AND PROTECTION OF ALL UTILITIES AND APPURTENANCES SHALL BE THE RESPONSIBILITY OF THE CONTRACTOR. COSTS FOR THE REPAIR AND RESTORATION OF EXISTING UTILITIES DAMAGED BY THE CONTRACTOR SHALL BE THE RESPONSIBILITY OF THE CONTRACTOR.
- 3. CALL 811 BEFORE YOU DIG. AT LEAST 48 HOURS PRIOR TO EXCAVATION.

WORK LIMITS

1. THE WORK LIMITS SHOWN ON THESE PLANS ARE FOR PHYSICAL CONSTRUCTION ONLY. THE INSTALLATION AND OPERATION OF ALL TEMPORARY TRAFFIC CONTROL AND TEMPORARY TRAFFIC CONTROL DEVICES REQUIRED BY THESE PLANS SHALL BE PROVIDED BY THE CONTRACTOR WHETHER INSIDE OR OUTSIDE OF THESE WORK LIMITS.

MAINTAIN DRAINAGE

1. THE CONTRACTOR AT HIS OWN EXPENSE, SHALL MAINTAIN THE FLOW IN ALL SEWERS, DRAINS, FIELD TILES, AND WATERCOURSES ENCOUNTERED IN AND AROUND THE PROJECT SITE. IF SUCH WATERCOURSES OR DRAINS ARE DISTURBED OR DESTROYED DURING THE EXECUTION OF THE PROJECT. THEY SHALL BE RESTORED BY THE CONTRACTOR AT HIS OWN EXPENSE TO A CONDITION SATISFACTORY TO THE ENGINEER.

SECURING EXCAVATIONS & TRENCHES FOR NON-WORKING HOURS

I. EXCAVATIONS AND TRENCHES OVER 24-INCHES DEEP SHALL BE SECURELY PLATED OR BACKFILLED DURING NON-WORKING HOURS.

EXCAVATION OF ROADWAY AND RIGHT-OF-WAY AREAS

- 1. ANY CONTRACTOR PERFORMING EXCAVATION, INCLUDING BUT NOT LIMITED TO DISTURBING THE EARTH WTH POWERED OR NON-POWERED EQUIPMENT, DRILLING AND/OR BORING, SHALL CAUSE NOTICE TO BE GIVEN BY CALLING 811 AT LEAST 48 HOURS BUT NOT MORE THAN 10 WORKING DAYS BEFORE EXCAVATING.
- 2. THE EXCAVATOR SHALL PROTECT AND PRESERVE THE MARKINGS UNTIL THOSE MARKINGS ARE NO LONGER NEEDED. IF AN EXCAVATION WILL COVER A LARGE AREA AND/OR PROGRESS FROM ONE AREA TO THE NEXT OVER A PERIOD OF TIME. THE EXCAVATOR SHALL COORDINATE THE MARKING OF APPROXIMATE LOCATIONS OF CITY OWNED FACILITIES WITH THE ACTUAL EXCAVATION.
- 3. THE CONTRACTOR IS RESPONSIBLE FOR LOCATING ALL CUSTOMER OWNED SERVICE LINES/LATERALS. THE CONTRACTOR SHALL FIELD VERIFY THE HORIZONTAL AND VERTICAL LOCATION OF ANY CITY OR CUSTOMER OWNED MAIN OR SERVICE LINE/LATERALS THAT MAY BE AFFECTED BY THE PROPOSED CONSTRUCTION ACTIVITIES. FIELD VERIFICATION SHALL TAKE PLACE PRIOR TO ANY ACTIVITY THAT MAY JEOPARDIZE THE INTEGRITY OF THE FACILITY AND AT A LOCATION NEAREST THE POINT OF POSSIBLE CONFLICT.
- 4. ANY DAMAGES TO CITY OR CUSTOMER OWNED FACILITIES SHOULD FIRST BE REPORTED TO THE UTILITY OWNER THEN IMMEDIATELY NOTIFY THE PROJECT ENGINEER.

AERIAL CONSTRUCTION:

- 1. CONTRACTOR TO VERIFY ALL BONDING AND GROUNDING COMPLES WITH NESC GUIDELINES.
- 2. CONSTRUCTION TO VERIFY ALL REQUIRED MAKE READY WORK IS COMPLETE BEFORE PLACING ON UTILITY POLES.

SAFETY NOTE:

- 1. CHECK IN WITH CONSTRUCTION SUPERVISOR WHEN ARRIVING ON-SITE.
- 2. HEAVY CONSTRUCTION EQUIPMENT IN USE. BEWARE OF SURROUNDINGS.
- 3. FOLLOW CONGRUEX SAFETY POLICIES AND GUIDELINES AT ALL TIMES WHILE WORKING.
- 4. CONSTRUCTION ZONE/ HARD HAT, SAFETY GLASSES, REFLECTIVE VEST/SHIRT, SAFETY TOE BOOTS REQUIRED WORK SAFELY



LEGENDS SHEET



DEC CABINET ☐ ELECTRIC TRANSFORMER ☐ CAS METER ☐ CALVEST ☐ CONTENTS AND INCIDENT ☐ ELECTRIC METER ☐ GAS VALVE ☐ CALVEST ☐ CALVEST ☐ CONTENTS AND INCIDENT ☐ ELECTRIC METER ☐ GAS VALVE ☐ CALVEST ☐ CALVEST ☐ CONTENTS AND INCIDENT ☐ ELECTRIC MANIFOLE ☐ GAS VALVE ☐ CALVEST ☐ CALVES		EXISTING EQUIPMENTS LEGE	NDS		LONGWIND
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	AERIAL STRAND				
ANCHOR & DOWN GUY					
		ANCHOR & DOWN GUY			




TYPICALS SHEET

EX. POLE




MINIMUM STANDARDS FOR DIRECTIONAL BORING STREET CROSSINGS

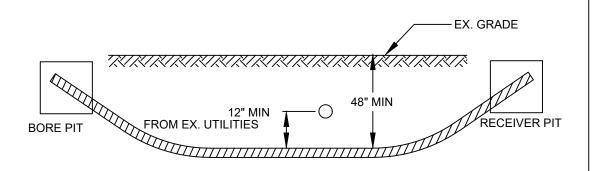

- PLACE END MARKER WITH UTILITY OWNER'S NAME DESCRIBING CONDUIT
- BORE PIT TO BE BACKFILLED AND COMPACTED IN 12" LIFTS WITH MATERIAL REMOVED
- FLOW OF DITCH MUST BE MAINTAINED AT ALL TIMES
- PROTECT ROOTS AT ALL TREE LOCATIONS, SHIFT BORE TRENCH IF NECESSARY

TYPICAL BORE DETAILS 1


MINIMUM STANDARDS FOR DIRECTIONAL BORING UNDER SIDEWALKS & WITHIN ROW (EXCLUDING STREET CROSSINGS)

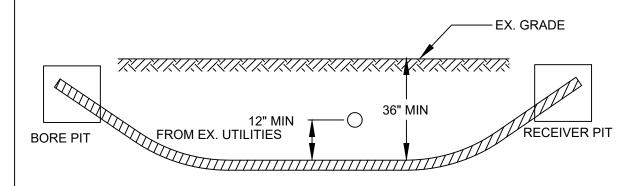


- PLACE END MARKER WITH UTILITY OWNER'S NAME DESCRIBING CONDUIT
- BORE PIT TO BE BACKFILLED AND COMPACTED IN 12" LIFTS WITH MATERIAL REMOVED
- FLOW OF DITCH MUST BE MAINTAINED AT ALL TIMES
- PROTECT ROOTS AT ALL TREE LOCATIONS, SHIFT BORE TRENCH IF NECESSARY

TYPICAL BORE DETAILS 2




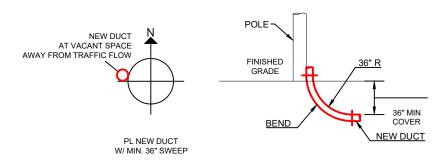




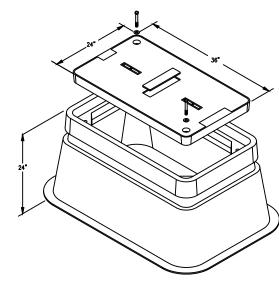

24"x36"x24"

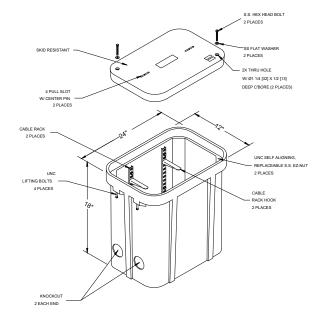



12"x24"x18"

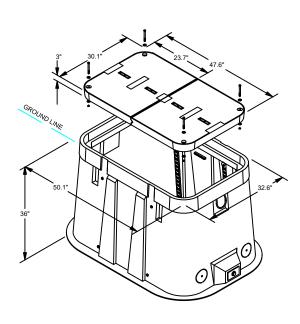



30"x48"x36"

17"x30"x18"_

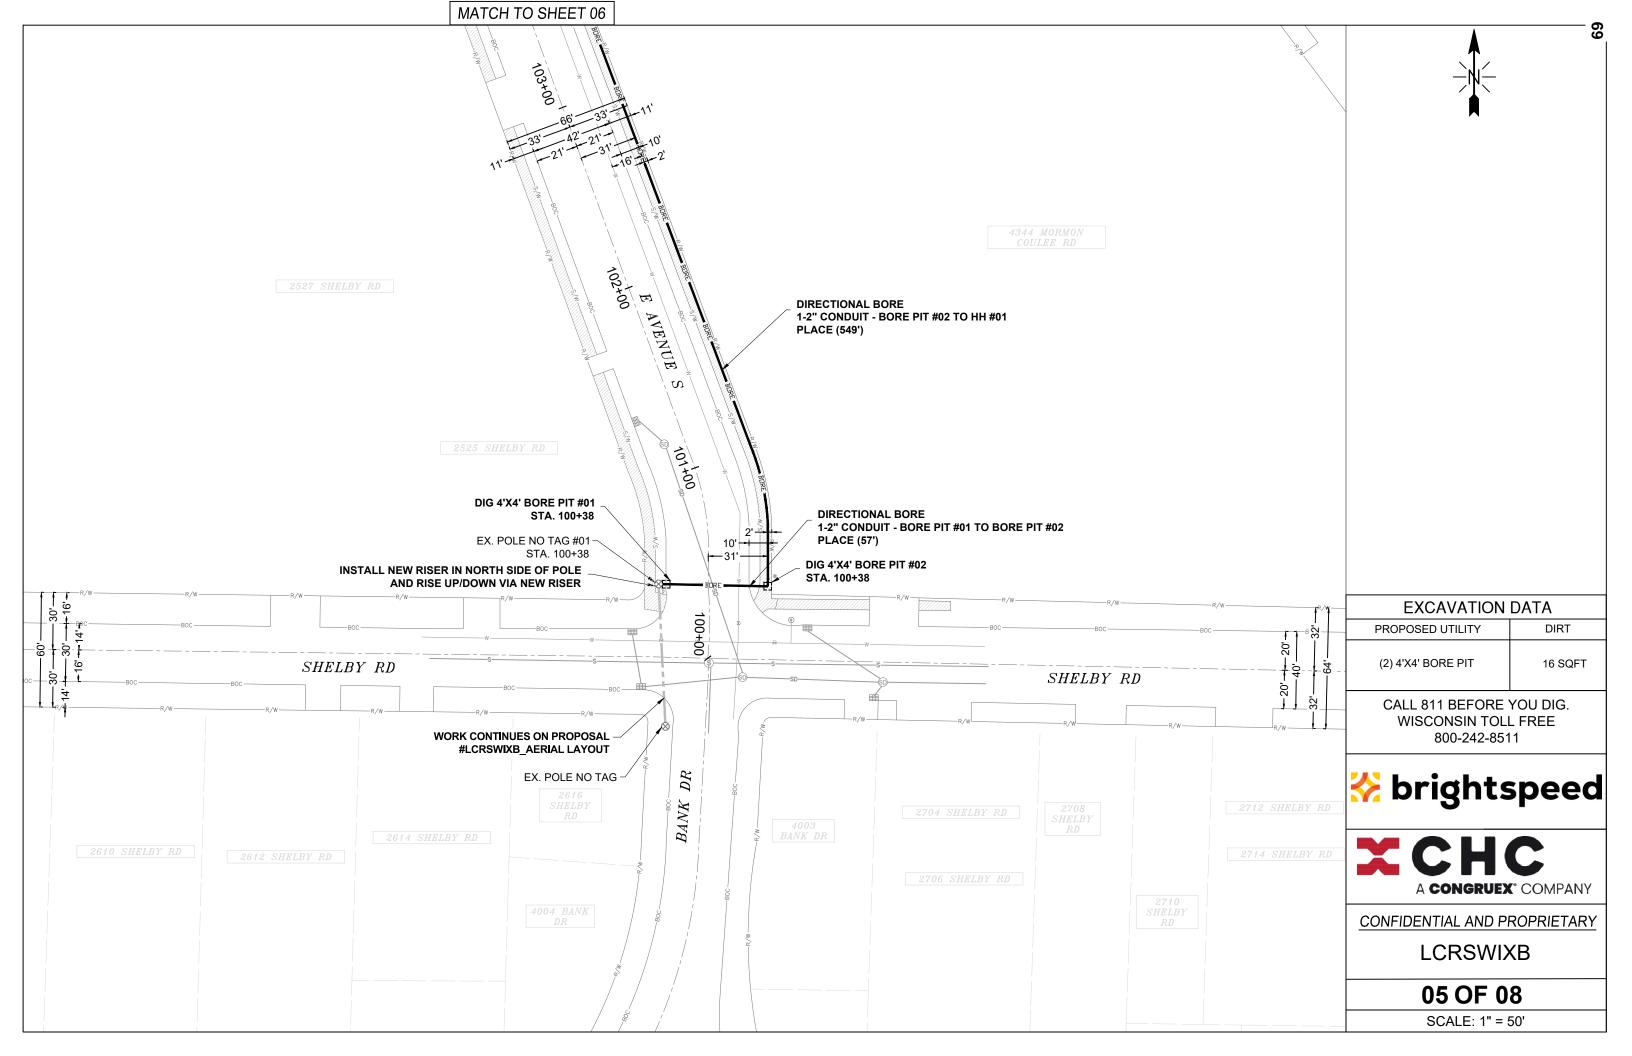

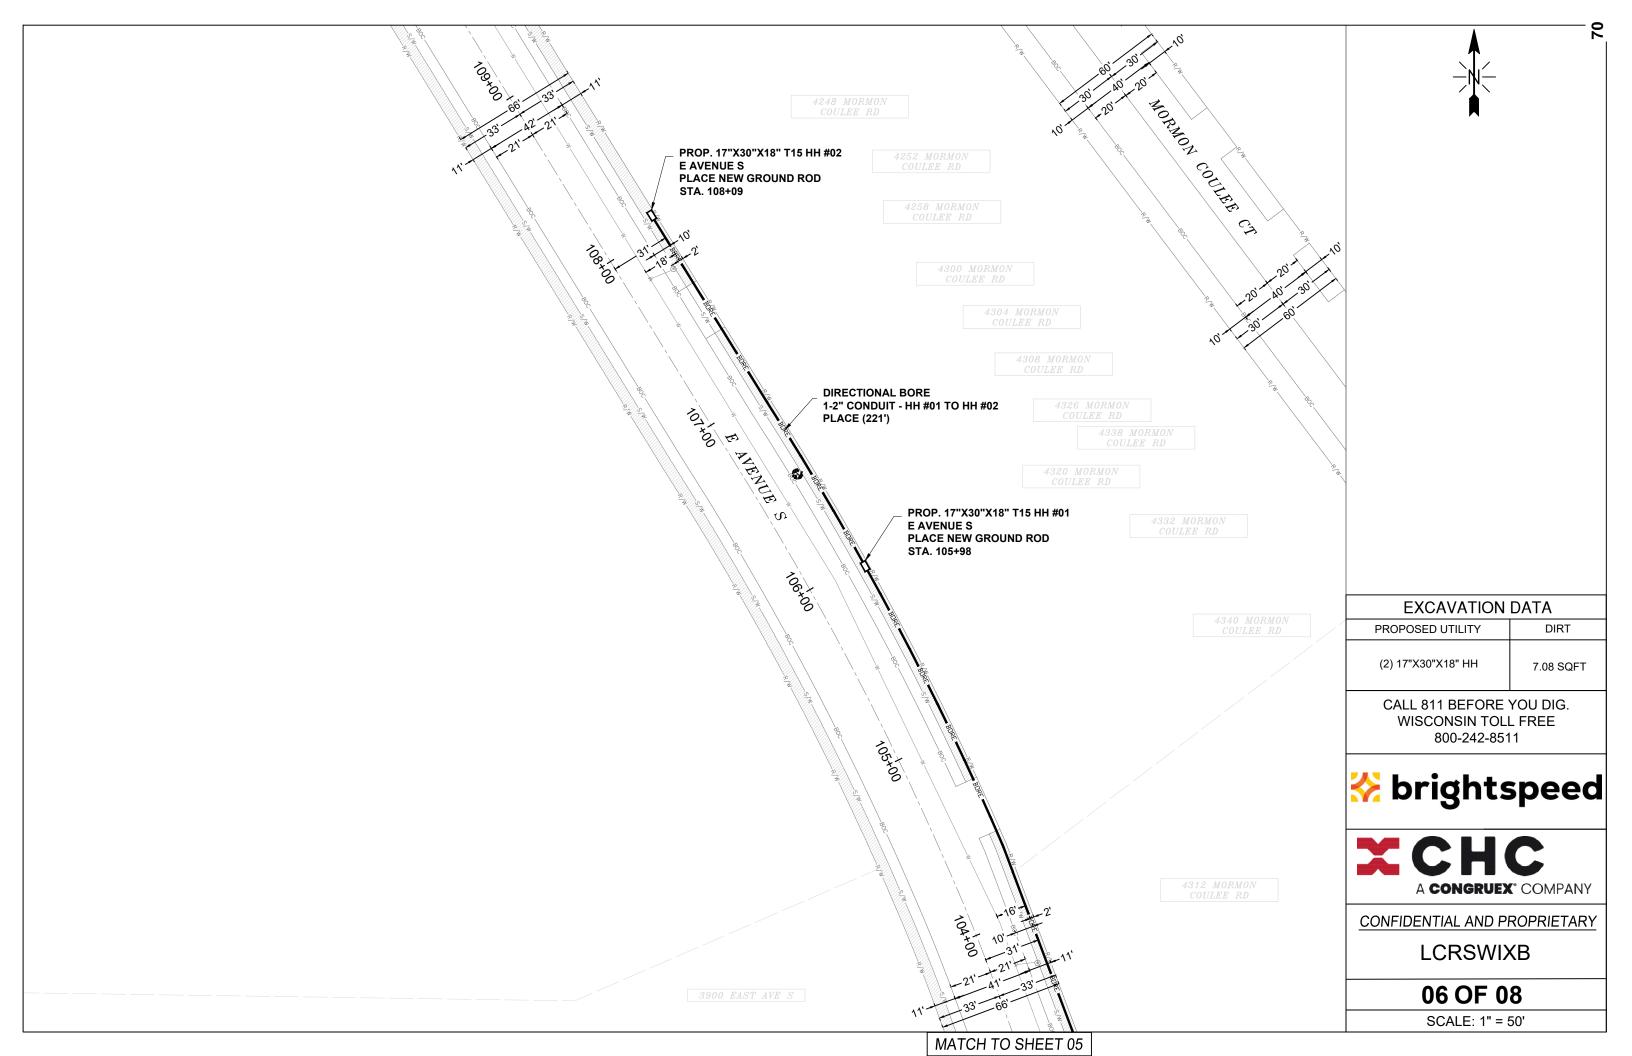

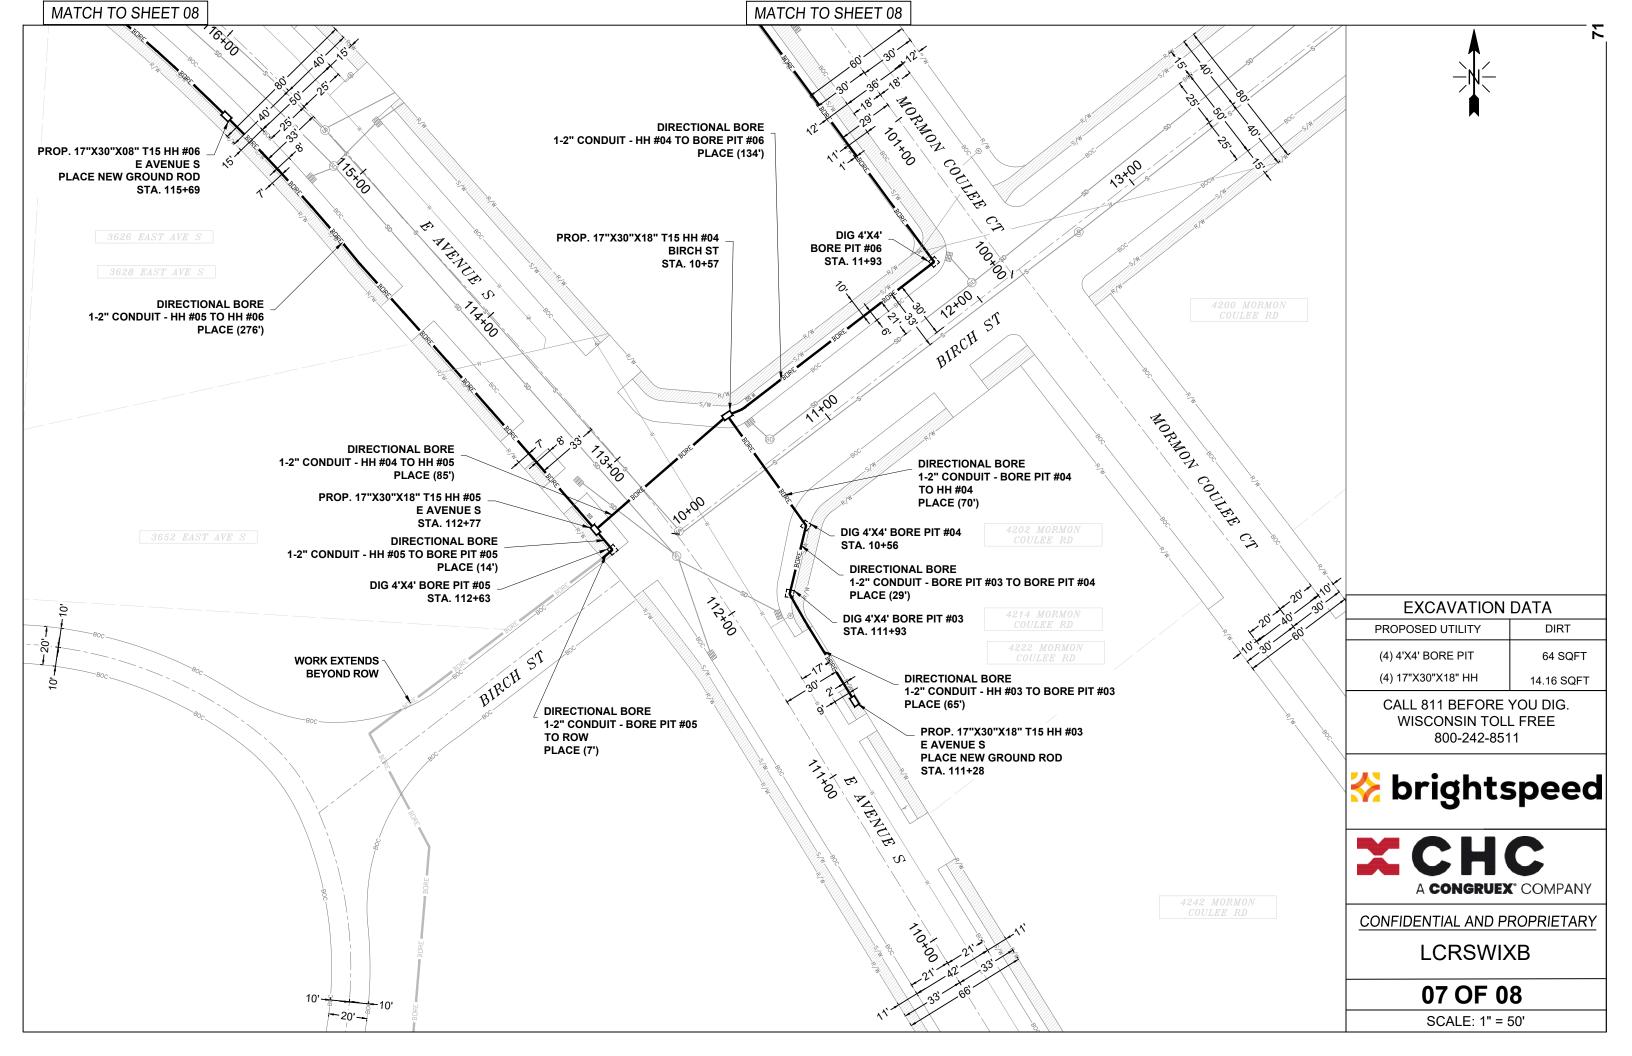

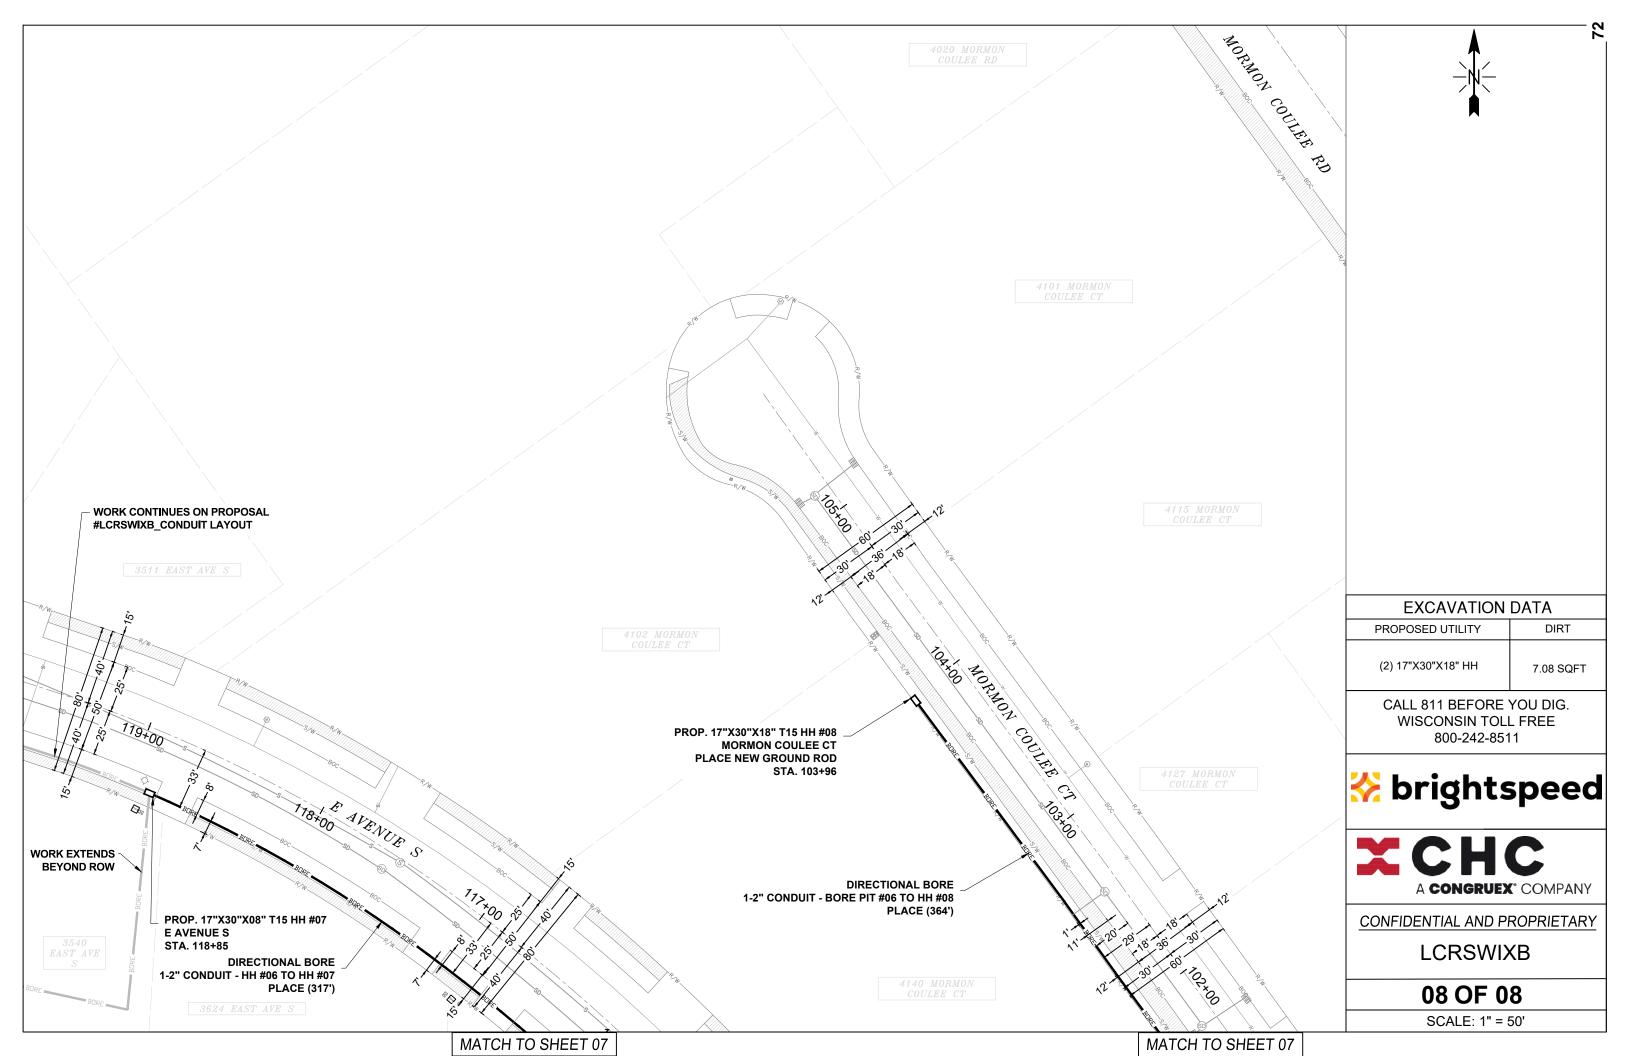



City of La Crosse, Wisconsin

City Hall 400 La Crosse Street La Crosse, WI 54601

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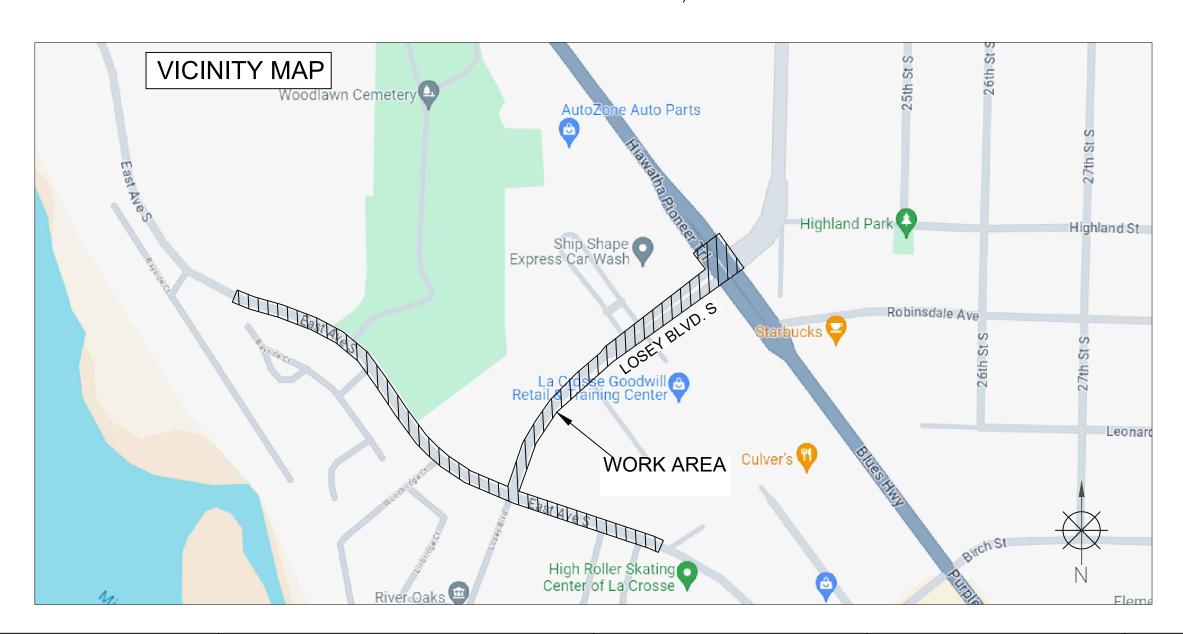
File Number: 25-0678

Agenda Date: 6/16/2025 Version: 1 Status: Agenda Ready

In Control: Board of Public Works File Type: General Item

BRIGHTSPEED LA CROSSE

3910 MORMON COULEE RD.
MORMON COULEE RD. & LOSEY BLVD. S
LA CROSSE CITY, WI



TRAFFIC CONTROL PLAN

	SCOPE OF WORK		SHEET INDEX
-	BORING HH & GROUND ROD PLACEMENT	SHEET	DESCRIPTION
	THE GROOM RODE ENGLINE	KEYMAP	VICINITY MAP & SCOPE OF WORK
		TC-1 TO TC-6	TRAFFIC CONTROL PLAN

PERMITTING AGENCY CITY OF LA CROSSE


PROPOSED PATH FOOTAGE
UG PATH = 2.957'



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REV.	DESCRIPTION	BY	DATE		
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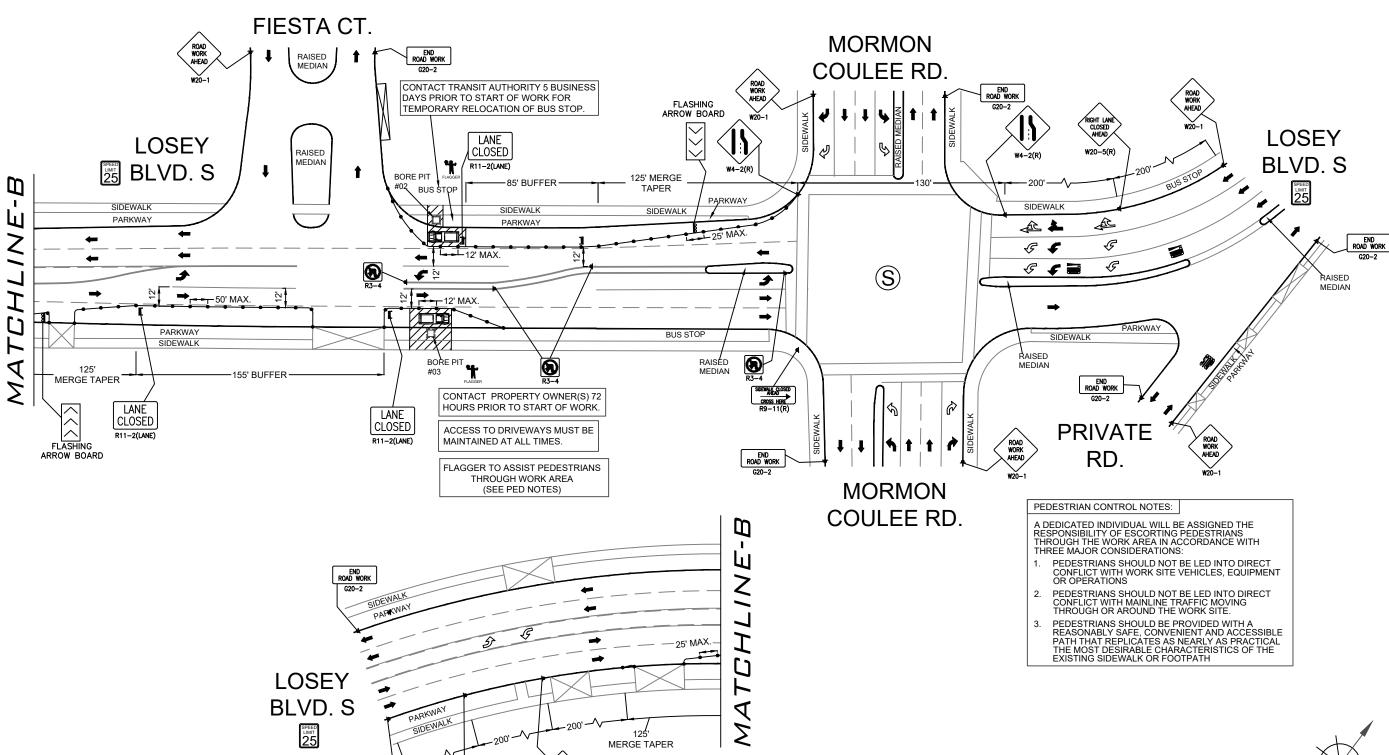
BRIGHTSPEED

	KEYMAP N.T.S.
6/24	LCRSWIXB
ATE	

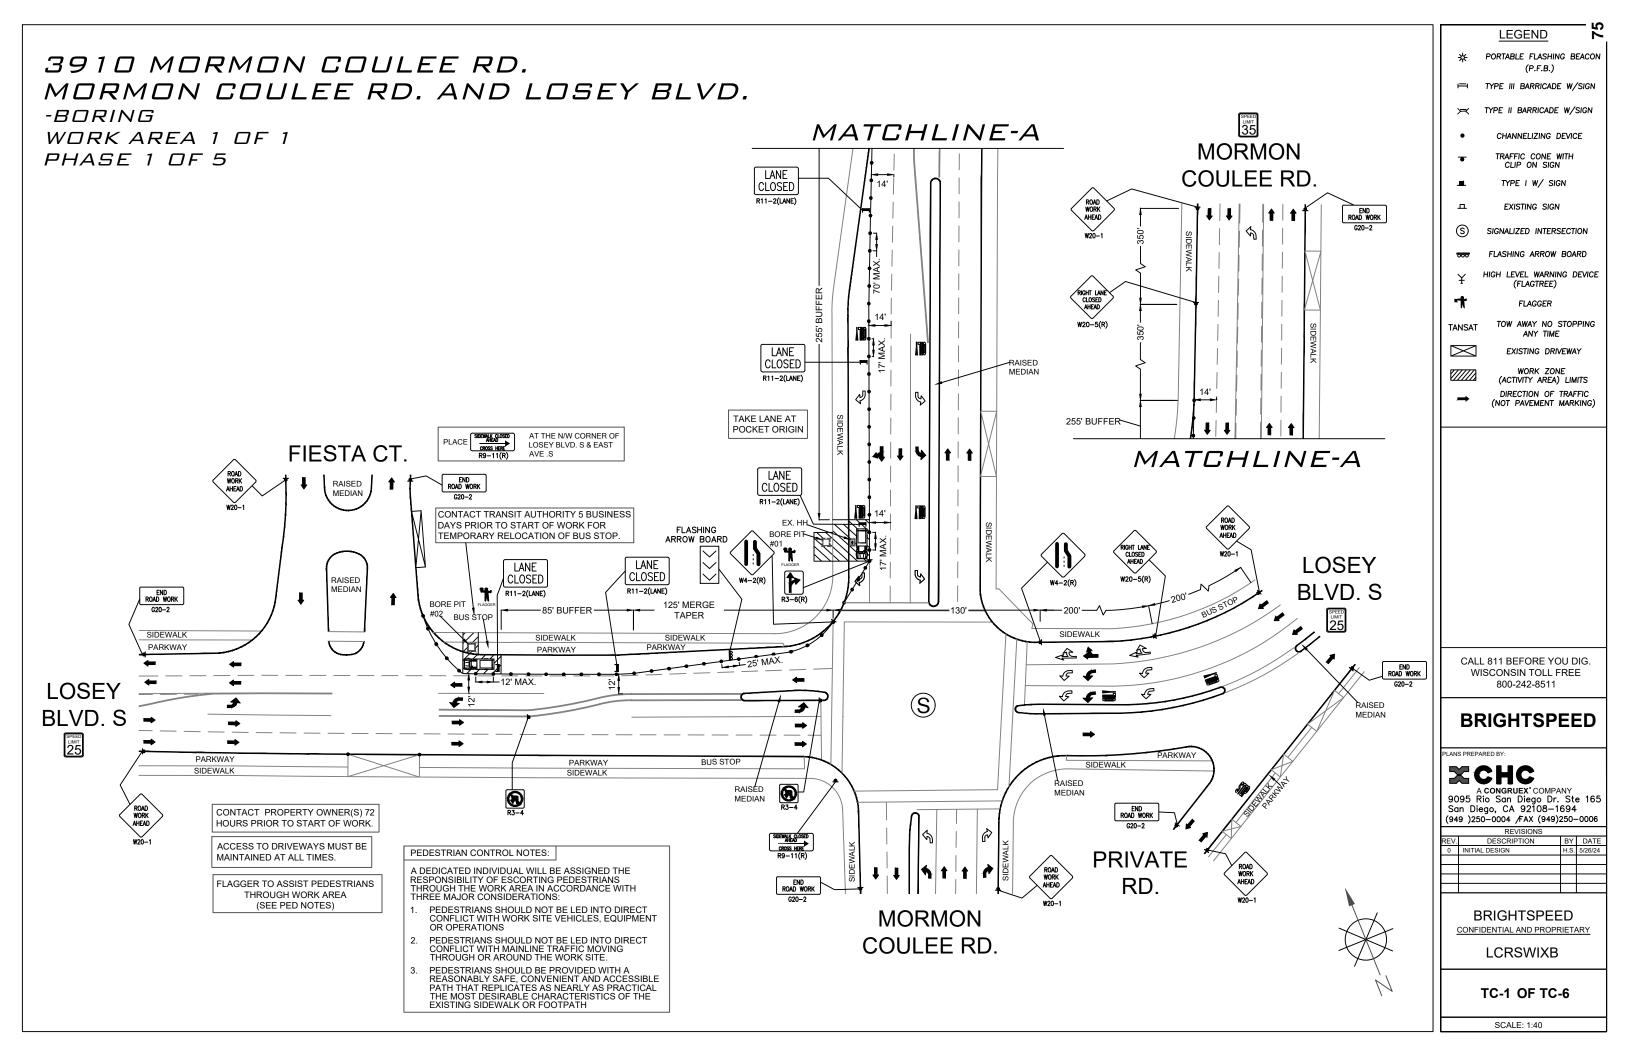

3837 MORMON COULEE RD. MORMON COULEE RD. AND LOSEY BLVD.

-BORING WORK AREA 1 OF 1 PHASE 2 OF 5





LEGEND

PORTABLE FLASHING BEACON (P.F.B.)

> TYPE II BARRICADE W/SIGN

CHANNELIZING DEVICE

TRAFFIC CONE WITH

TYPE I W/ SIGN

EXISTING SIGN

) SIGNALIZED INTERSECTION

FLASHING ARROW BOARD

¥ HIGH LEVEL WARNING DEVICE (FLAGTREE)

FLAGGER

AT TOW AWAY NO STOPPING ANY TIME

EXISTING DRIVEWAY

WORK ZONE
(ACTIVITY AREA) LIMITS

DIRECTION OF TRAFFIC (NOT PAVEMENT MARKING)

CALL 811 BEFORE YOU DIG. WISCONSIN TOLL FREE 800-242-8511

BRIGHTSPEED

LANS PREPARED BY:

XCHC

A CONGRUEX' COMPANY 9095 Rio San Diego Dr. Ste 165 San Diego, CA 92108-1694 (949) 250-0004 /FAX (949)250-0006


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BRIGHTSPEED

CONFIDENTIAL AND PROPRIETARY

LCRSWIXB

TC-2 OF TC-6

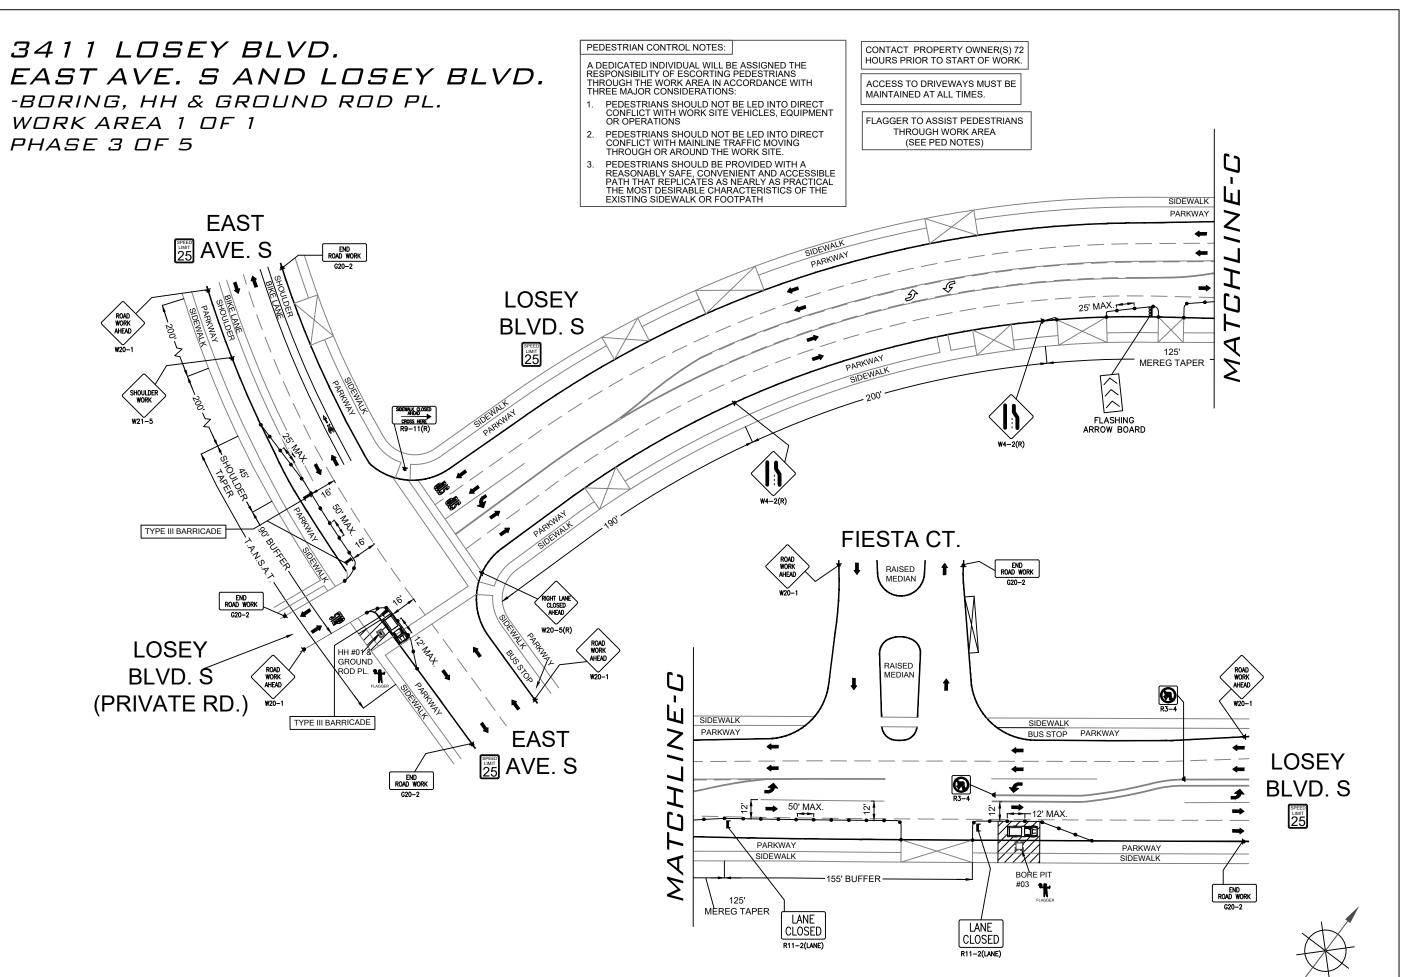

LEGEND

- PORTABLE FLASHING BEACON (P.F.B.)
- TYPE III BARRICADE W/SIGN
- TYPE II BARRICADE W/SIGN
- CHANNELIZING DEVICE
- TRAFFIC CONE WITH CLIP ON SIGN
- TYPE I W/ SIGN
- L EXISTING SIGN
- S SIGNALIZED INTERSECTION
- ₹ FLASHING ARROW BOARD
- Y HIGH LEVEL WARNING DEVICE (FLAGTREE)
 - FLAGGER

TANSAT

TOW AWAY NO STOPPING ANY TIME

EXISTING DRIVEWAY

WORK ZONE (ACTIVITY AREA) LIMITS

DIRECTION OF TRAFFIC (NOT PAVEMENT MARKING)

CALL 811 BEFORE YOU DIG. WISCONSIN TOLL FREE 800-242-8511

BRIGHTSPEED

PLANS PREPARED BY:

XCHC


A CONGRUEX COMPANY 9095 Rio San Diego Dr. Ste 165 San Diego, CA 92108-1694 (949)250-0004 /FAX (949)250-0006

	REVISIONS		
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0	INITIAL DESIGN	H.S.	5/26/2

BRIGHTSPEED CONFIDENTIAL AND PROPRIETARY

LCRSWIXB

TC-3 OF TC-6

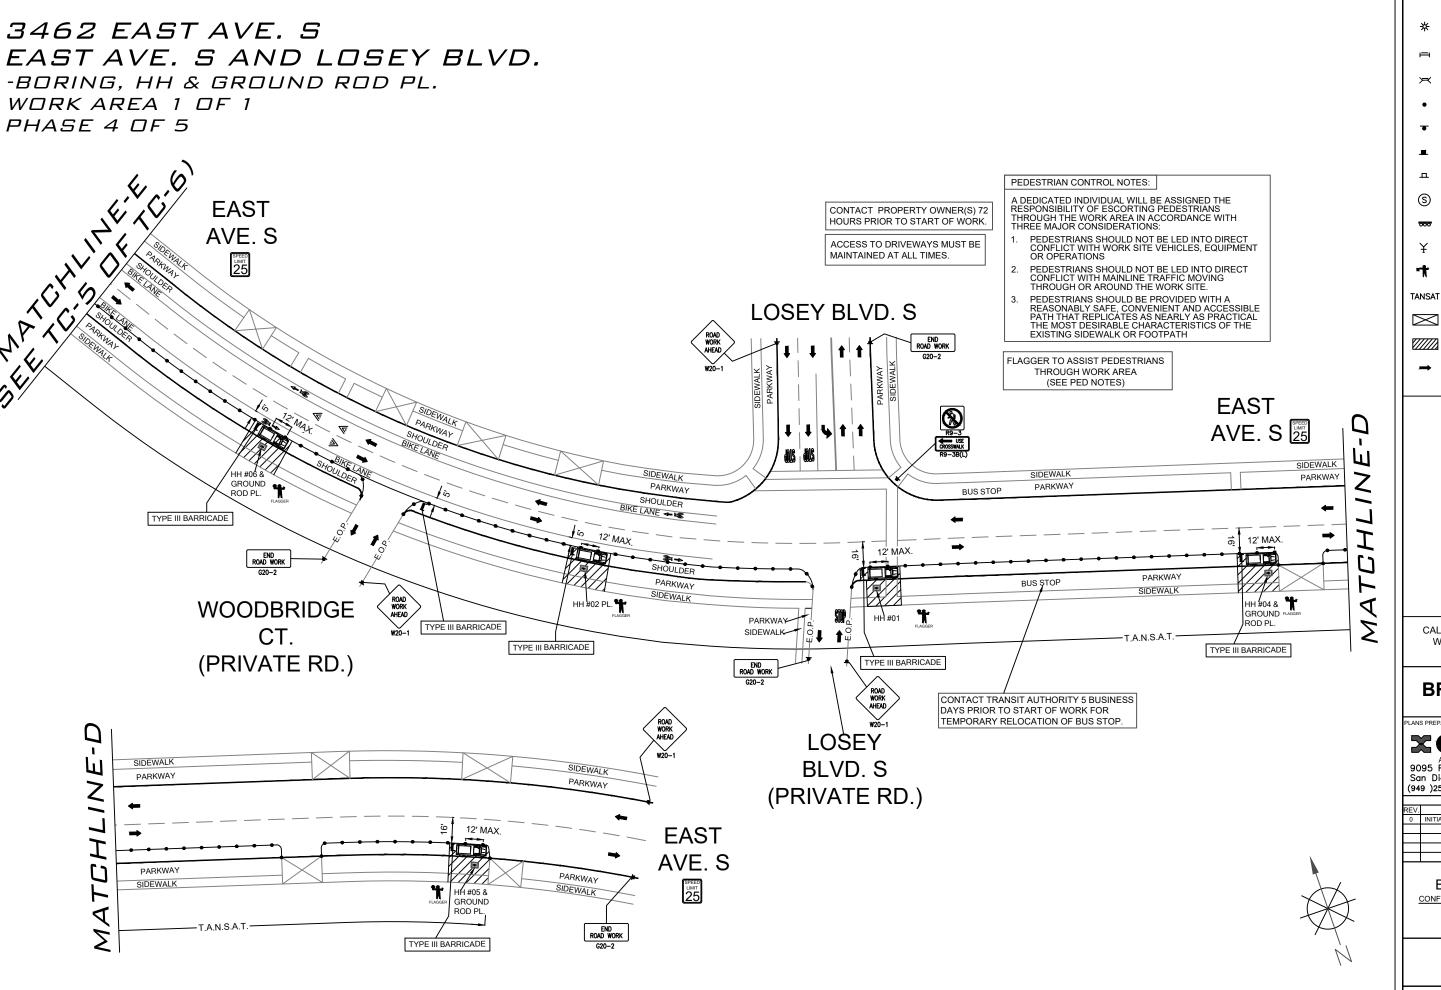

LEGEND

PORTABLE FLASHING BEACON (P.F.B.)

TYPE III BARRICADE W/SIGN

TYPE II BARRICADE W/SIGN

CHANNELIZING DEVICE

TRAFFIC CONE WITH CLIP ON SIGN

TYPE I W/ SIGN

EXISTING SIGN

SIGNALIZED INTERSECTION

FLASHING ARROW BOARD

HIGH LEVEL WARNING DEVICE

FLAGGER

TOW AWAY NO STOPPING ANY TIME EXISTING DRIVEWAY

(FLAGTREE)

WORK ZONE (ACTIVITY AREA) LIMITS

DIRECTION OF TRAFFIC (NOT PAVEMENT MARKING)

CALL 811 BEFORE YOU DIG. WISCONSIN TOLL FREE 800-242-8511

BRIGHTSPEED



A CONGRUEX COMPANY 9095 Rio San Diego Dr. Ste 165 San Diego, CA 92108-1694 (949)250-0004 FAX (949)250-0006

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BRIGHTSPEED


CONFIDENTIAL AND PROPRIETARY

LCRSWIXB

TC-4 OF TC-6

3462 EAST AVE. S EAST AVE. S AND LOSEY BLVD. -BORING, HH & GROUND ROD PL.

WORK AREA 1 OF 1 PHASE 4 OF 5

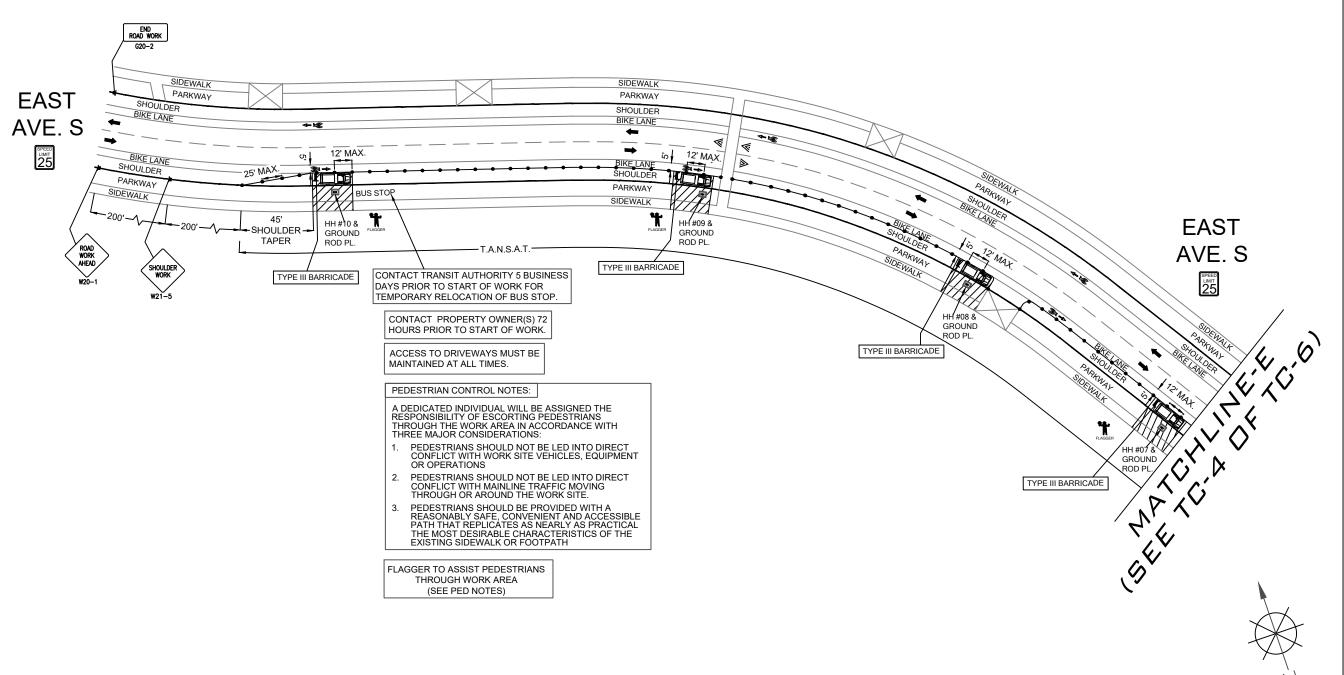

LEGEND

PORTABLE FLASHING BEACON (P.F.B.)

TYPE III BARRICADE W/SIGN

TIPE II BARRICADE W/SIG

CHANNELIZING DEVICE

TRAFFIC CONE WITH CLIP ON SIGN

TYPE I W/ SIGN

EXISTING SIGN

) SIGNALIZED INTERSECTION

₹ FLASHING ARROW BOARD

Y HIGH LEVEL WARNING DEVICE (FLAGTREE)

FLAGGER

TANSAT

д

TOW AWAY NO STOPPING
ANY TIME

EXISTING DRIVEWAY

WORK ZONE (ACTIVITY AREA) LIMITS

DIRECTION OF TRAFFIC (NOT PAVEMENT MARKING)

CALL 811 BEFORE YOU DIG. WISCONSIN TOLL FREE 800-242-8511

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A CONGRUEX COMPANY 9095 Rio San Diego Dr. Ste 165 San Diego, CA 92108-1694 (949) 250-0004 /FAX (949)250-0006

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	REV.	DESCRIPTION	BY	DATE
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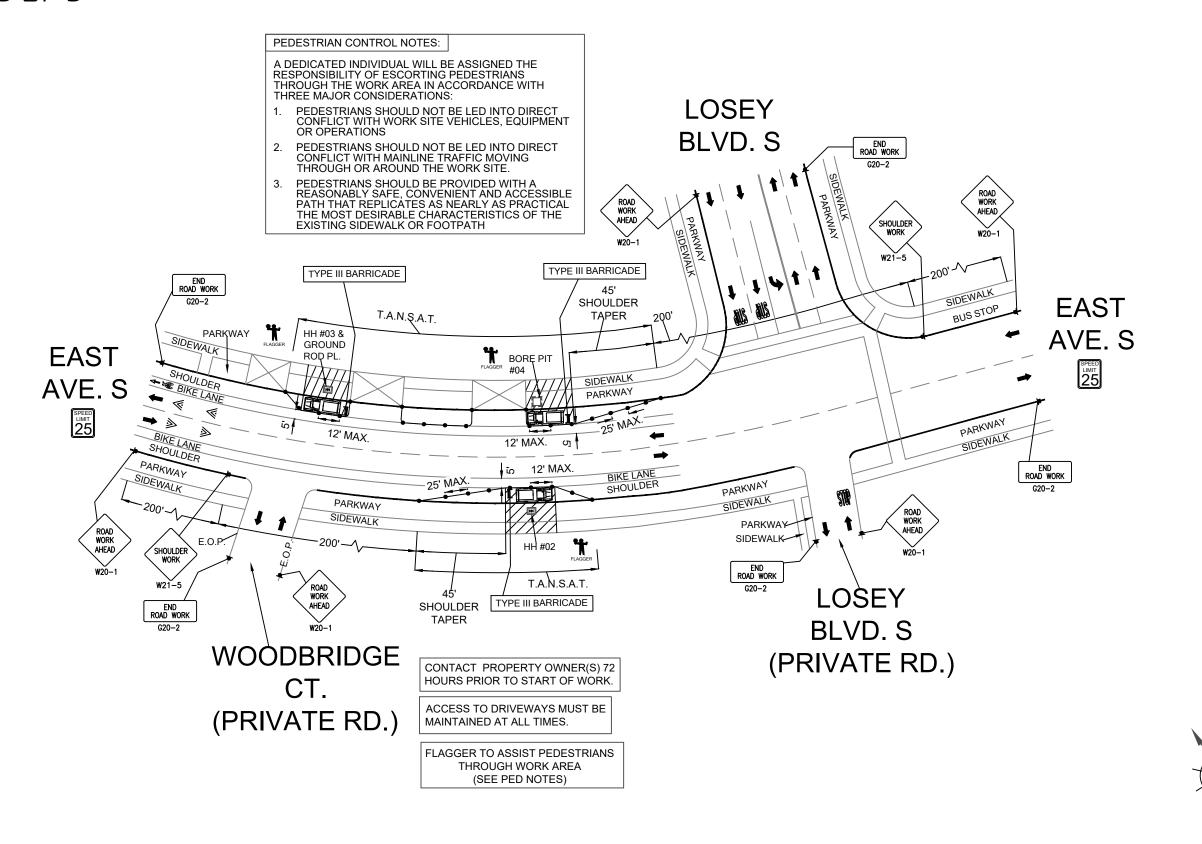
BRIGHTSPEED CONFIDENTIAL AND PROPRIETARY

LCRSWIXB

TC-5 OF TC-6

3462 LOSEY BLVD. S EAST AVE. S AND LOSEY BLVD. -BORING, HH & GROUND ROD PL.

WORK AREA 1 OF 1 PHASE 5 OF 5



LEGEND

PORTABLE FLASHING BEACON (P.F.B.)

TYPE III BARRICADE W/SIGN

> TYPE II BARRICADE W/SIGN

CHANNELIZING DEVICE

TRAFFIC CONE WITH

■L TYPE I W/ SIGN

EXISTING SIGN

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FLAGGER

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TOW AWAY NO STOPPING
ANY TIME
EXISTING DRIVEWAY

WORK ZONE (ACTIVITY AREA) LIMITS

DIRECTION OF TRAFFIC (NOT PAVEMENT MARKING)

CALL 811 BEFORE YOU DIG. WISCONSIN TOLL FREE 800-242-8511

BRIGHTSPEED

LANS PREPARED B



9095 Rio San Diego Dr. Ste 165 San Diego, CA 92108-1694 (949)250-0004 /FAX (949)250-0006

	REVISIONS		
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CONFIDENTIAL AND PROPRIETARY

LCRSWIXB

TC-6 OF TC-6



REVOCABLE OCCUPANCY / STREET PRIVILEGE PERMIT APPLICATIONFOR COMMUNICATIONS (FIBER OPTICS, TELEPHONE, CABLE, ETC.) City of La Crosse Engineering Department

Phone: 608-789-7505 Email: engineering@cityoflacrosse.org http://cityoflacrosse.org

Encroachment Owner: Brightspeed of Wisconsin, LLC			
Address: 1120 South Tryon St #700 City: Charlotte State: NC Zip: 28203			
Phone # (913) 547-5570 Email Address Bryan.Williams@brightspeed.com			
CNIC Nativersity LLC			
Application Preparer (if different from above) <u>CNS Netw</u> Relationship with Owner: Consulting Firm	OIKS, LLC		
•	obruneau@congruex.com		
Description of Proposed Encroachment:			
Brightspeed proposes to bore and place 2,957 ft of (1)-2" corone (1) 36"x48"x30" HH, and two (2) 24"x36"x24" HH.	nduit; Place seven (7) 17"x30"x18" HH		
Encroachment Addresses (List by Street and 100 blocks):			
3910 Mormon Coulee Rd			
I certify that I have reviewed the Municipal Code and understand all that is relate			
have the full authority to make the foregoing application; the information in the ap complete and correct; the Work or Use performed shall comply with all the laws o			
rules, regulations, policies and special conditions of the City of La Crosse. The a	· · · · · · · · · · · · · · · · · · ·		
an approved permit with diligence and convenience to the public. See Sheet	2 of 2 for Additional Conditions.		
Signature of Owner or designee: Brittany Bruneau Date: 05/23/2025			
Print Name and Title: Brittany Bruneau - Permit Specialist.			
Please return this completed application along with required information and fee			
Engineering Department, 400 La Crosse Street, La Crosse, WI 54601. You will to on the Board of Public Works agenda for consideration. Average completion ti			
on the Board of Public Works agenda for consideration. Average completion to	ine for validation 45 days.		
BELOW THIS LINE TO BE COMPLETED BY	CITY STAFF ONLY		
DELOW THIS EIGHT TO BE COME EFFED BY			
Required items to be provided by Applicant:	Board of Public Works		
	Approval Date:		
Scale Drawing of encroachments			
(City Utilities, Lighting and Signals must be shown on			
Proposed Communications Plan)	Engraphment Type:		
	Encroachment Type:		
Certificate of Insurance (City as additional Insured)			
			
Initial Application Fee \$	Permit Number:		
City I Hillity Detential Conflict Notification and City Off			
City Utility Potential Conflict Notification and Sign-Off			
All Fees are Non-Refundable & Subject to change by City Council	SHEET 4 OF 2		
All Fees are Non-Refundable & Subject to change by City Council	SHEET 1 OF 2		



REVOCABLE OCCUPANCY / STREET PRIVILEGE PERMIT APPLICATION

City of La Crosse Engineering Department

Phone: 608-789-7505 Email: engineering@cityoflacrosse.org http://cityoflacrosse.org

STREET PRIVILEGE PERMIT CONDITIONS FOR COMMUNICATIONS INSTALLATIONS

- 1. The applicant shall be primarily liable for damages to person or property by reason of the granting of this street privilege permit.
- 2. The applicant shall obtain an excavation permit from the City of La Crosse Engineering Department prior to performing installation or any maintenance on the cable in the City right-of-way that requires excavation or disruption of pavement, sidewalk, curb and gutter, or other structure.
- The applicant agrees that tracer wires shall be used and final cable location within the street right-of-way shall be approved by the City Engineer. Cable shall be installed not less than 36 inches deep, unless otherwise approved by the City Engineer.
- 4. Applicant agrees to provide the City of La Crosse with final "as-built" plans when installation is complete.
- 5. Applicant agrees that any pavement, concrete or green space disturbed during drilling activities shall be restored to its prior condition.
- 6. Applicant agrees that said installation shall not interfere with the City's water, sanitary sewer, or storm sewer underground infrastructure that may be in the area.
- 7. Applicant further agrees that they will make arrangements with the public utility companies and the City of La Crosse to clear all public underground utilities prior to initiating such work, and if necessary, applicant will make arrangements with the City of La Crosse to ensure proper traffic control.
- 8. Applicant waives any and all rights to contest in any way or manner the validity of Sec. 66.0425 of the Wisconsin Statutes and the amount of compensation charged.
- 9. Applicant agrees to become a member of Diggers Hotline for marking / locating of utility.
- 10. The applicant for a permit to encroach on the public right-of-way shall procure and maintain for the duration of the permit a minimum liability and contractual liability policy in the amount of \$100,000.00 each person, \$300,000.00 each accident for bodily injury and \$100,000.00 for property damage. A certificate of such insurance shall be filed with the City Attorney as part of the application. The insurance shall name the City, its officials, employees and agents as additional insureds. The Board may approve greater insurance protection on a case-by-case basis.
- 11. Applicant further agrees to hold harmless the City for any damage to said cable while the City, its agents or contractors are conducting construction for maintenance activities in or upon such area in which said cable lies; provided, however, the City shall make a good faith effort to notify applicant of any maintenance or work in the area of the street privilege permit which may damage applicant's cable.
- 12. Applicant agrees to remove the cable and return the area to its original condition upon ten (10) days' notice by the Board of Public Works. The applicant further agrees that if it does not remove the cable within ten (10) days after receiving notice, the City is authorized to remove the same and applicant agrees to pay the City for all costs of such removal.
- 13. Applicant further agrees that the obligations and conditions of this street privilege permit shall be binding upon all heirs, successors and assigns of applicant.
- 14. The person(s) signing this Permit warrant that they have the authority to sign as, or on behalf of, the party for whom they are signing.

Sheet 2 of 2

BRIGHTSPEED LA CROSSE


LCRSWIXB 3910 MORMON COULEE RD, LA CROSSE, WI 54601, USA CONDUIT LAYOUT

Sheet List Table		
Sheet Number	Sheet Title	
01	COVER SHEET	
02	GENERAL NOTES	
03	LEGENDS	
04	TYPICALS	
05-08	FIBER LAYOUTS	

Material List Table		
ITEM	QUANTITY	
FEEDER FIBER	00	
JUMPER	00	
17X30X18 HH	09	
36X48X30 HH	01	
24X36X24 HH	02	
2" CONDUIT	2,936'	
NEW STRAND	00	
ANCHOR	00	

BLM INFO				
	SE	CTION	S16	
MUNICIPALITY		PALITY	LA CROSSE	
TOWNSHIP		/NSHIP	T15N	
COUNTY		YTNUC	LA CROSSE	
	F	RANGE	R07W	
REVISION	DATE		DESCRIPTION	

REVISION	DATE	DESCRIPTION
01	05/30/2025	CLEARANCE NOTE REQUIRED, BORE PATH NEEDS
		TO BE SHIFTED

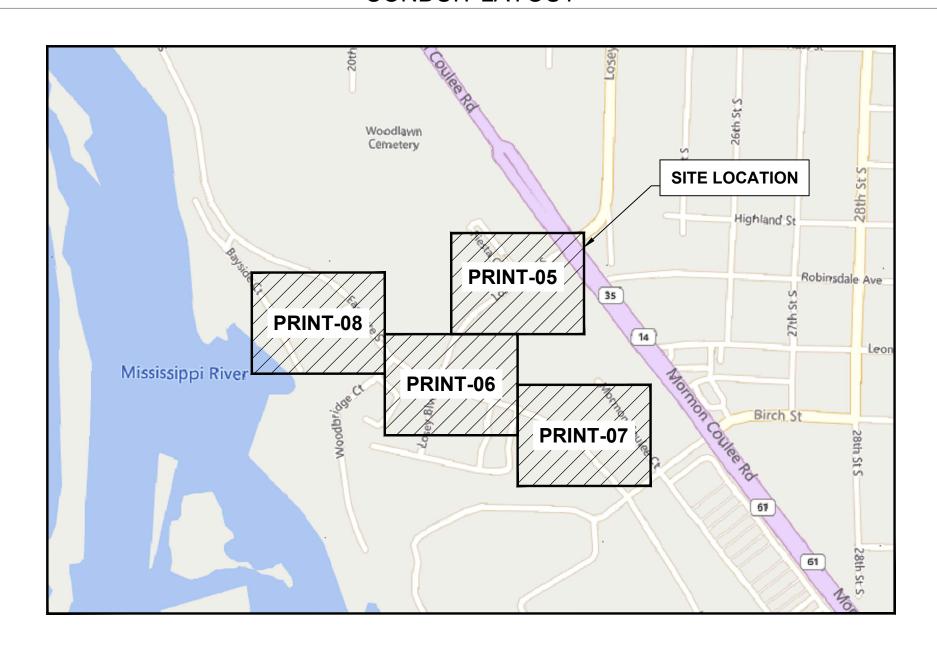


GENERAL ABBREVIATIONS

RIGHT OF WAY SIDEWALK S/W **CENTER LINE** C/L CONCRETE SIDEWALK CSW DWY **DRIVEWAY** FOC FACE OF CURB BOC BACK OF CURB EOC EDGE OF CURB EOP EDGE OF PAVEMENT ETW ETW LINE **HANDHOLE** МН MANHOLE NOT TO SCALE N.T.S. CONCRETE CONC PED PEDESTAL (UTILITY) POLYVINYL CHLORIDE PVC P/L PROPERTY LINE RAILROAD RR STREET LIGHT W-BLDG WALL TO BUILDING W-P WALL TO POLE W-W WALL TO WALL U/E UTILITY EASEMENT SD STORM DRAIN TS TRAFFIC SIGNAL

PERMITTING AGENCY
CITY OF LA CROSSE

PROPOSED LINEAR PATH FOOTAGE
UG PATH - 2,936 FT

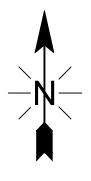







LCRSWIXB

COVER SHEET



GENERAL NOTES



PLAN SHEET DISCLAIMER:

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- 2. IN AN EFFORT TO INCREASE THE CLARITY AND LEGIBILITY OF THE PLANS, EXISTING UNDERGROUND UTILITIES WILL NOT BE SHOWN UNLESS THERE IS PROPOSED WORK THAT WILL REQUIRE EXCAVATION OR ANY OTHER EARTH DISTURBING ACTIVITY. IF PROPOSED WORK WILL REQUIRE THIS TYPE OF ACTIVITY. EXISTING UNDERGROUND UTILITIES WILL BE PROPERLY INVESTIGATED AND REPRESENTED ON THE PLAN SHEET OF THE RESPECTIVE WORK LOCATION

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WORK LIMITS

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MAINTAIN DRAINAGE

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AERIAL CONSTRUCTION:

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- 3. FOLLOW CONGRUEX SAFETY POLICIES AND GUIDELINES AT ALL TIMES WHILE WORKING.
- 4. CONSTRUCTION ZONE/ HARD HAT, SAFETY GLASSES, REFLECTIVE VEST/SHIRT, SAFETY TOE BOOTS REQUIRED WORK SAFELY



LEGENDS SHEET




LCRSWIXB EXISTING EQUIPMENTS LEGENDS GAS METER CABINET ELECTRIC TRANSFORMER R/W CULVERT CENTER LINE GAS VALVE E ELECTRIC METER EXISTING PED C/L MONUMENT (S) SEWER MANHOLE EXISTING FLOWERPOT E ELECTRIC VAULT/HANDHOLE ANCHOR & DOWN GUY PROPERTY LINE UNKNOWN MANHOLE EXISTING HANDHOLE ELECTRIC MANHOLE TELEPHONE CABINET WATER METER V EXISTING VAULT WATER VALVE TELEPHONE MANHOLE STREETLIGHT TRAFFIC SIGNAL FIRE HYDRANT POWER PED POLE WATER WATER MANHOLE CATV PED CABLE MARKER STORM DRAIN CATCH BASIN CATV VAULT/HANDHOLE STREET SIGN - UTILITY EASEMENT STORM DRAIN MANHOLE TREE VERTICAL GROUND SIDEWALK ■ ELECTRIC PEDESTAL/CABINET TRANSFORMER PROPOSED EQUIPMENTS LEGENDS 12"X24"X18" HANDHOLE 17"X30"X18" HANDHOLE 24"X36"X24" HANDHOLE -- AERIAL STRAND 36"X48"X30" HANDHOLE ANCHOR & DOWN GUY



TYPICALS SHEET




MINIMUM STANDARDS FOR DIRECTIONAL BORING STREET CROSSINGS

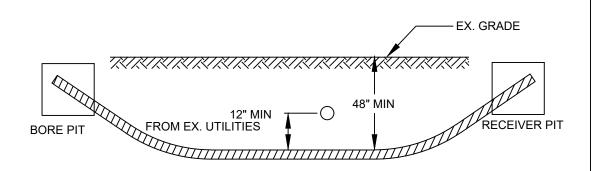

- PLACE END MARKER WITH UTILITY OWNER'S NAME DESCRIBING CONDUIT
- BORE PIT TO BE BACKFILLED AND COMPACTED IN 12" LIFTS WITH MATERIAL REMOVED
- FLOW OF DITCH MUST BE MAINTAINED AT ALL TIMES
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TYPICAL BORE DETAILS 1

MINIMUM STANDARDS FOR DIRECTIONAL BORING
UNDER SIDEWALKS & WITHIN ROW (EXCLUDING STREET CROSSINGS)

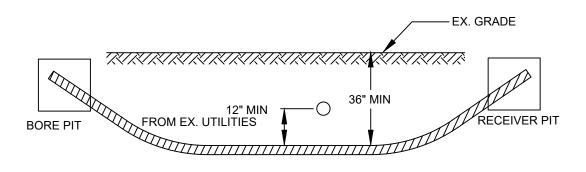


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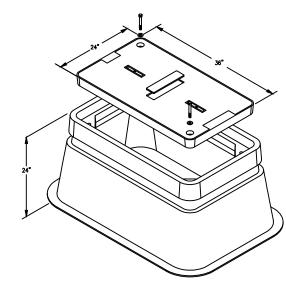
PLAN VIEW

EX. POLE


ELEVATION

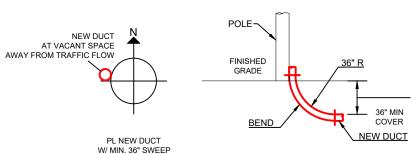


<u>RISER DETAILS</u>






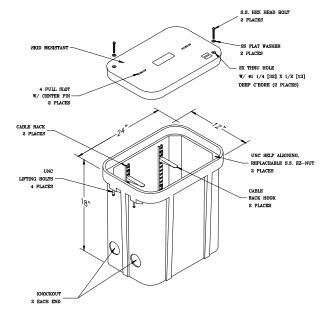


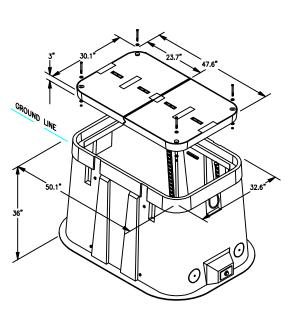







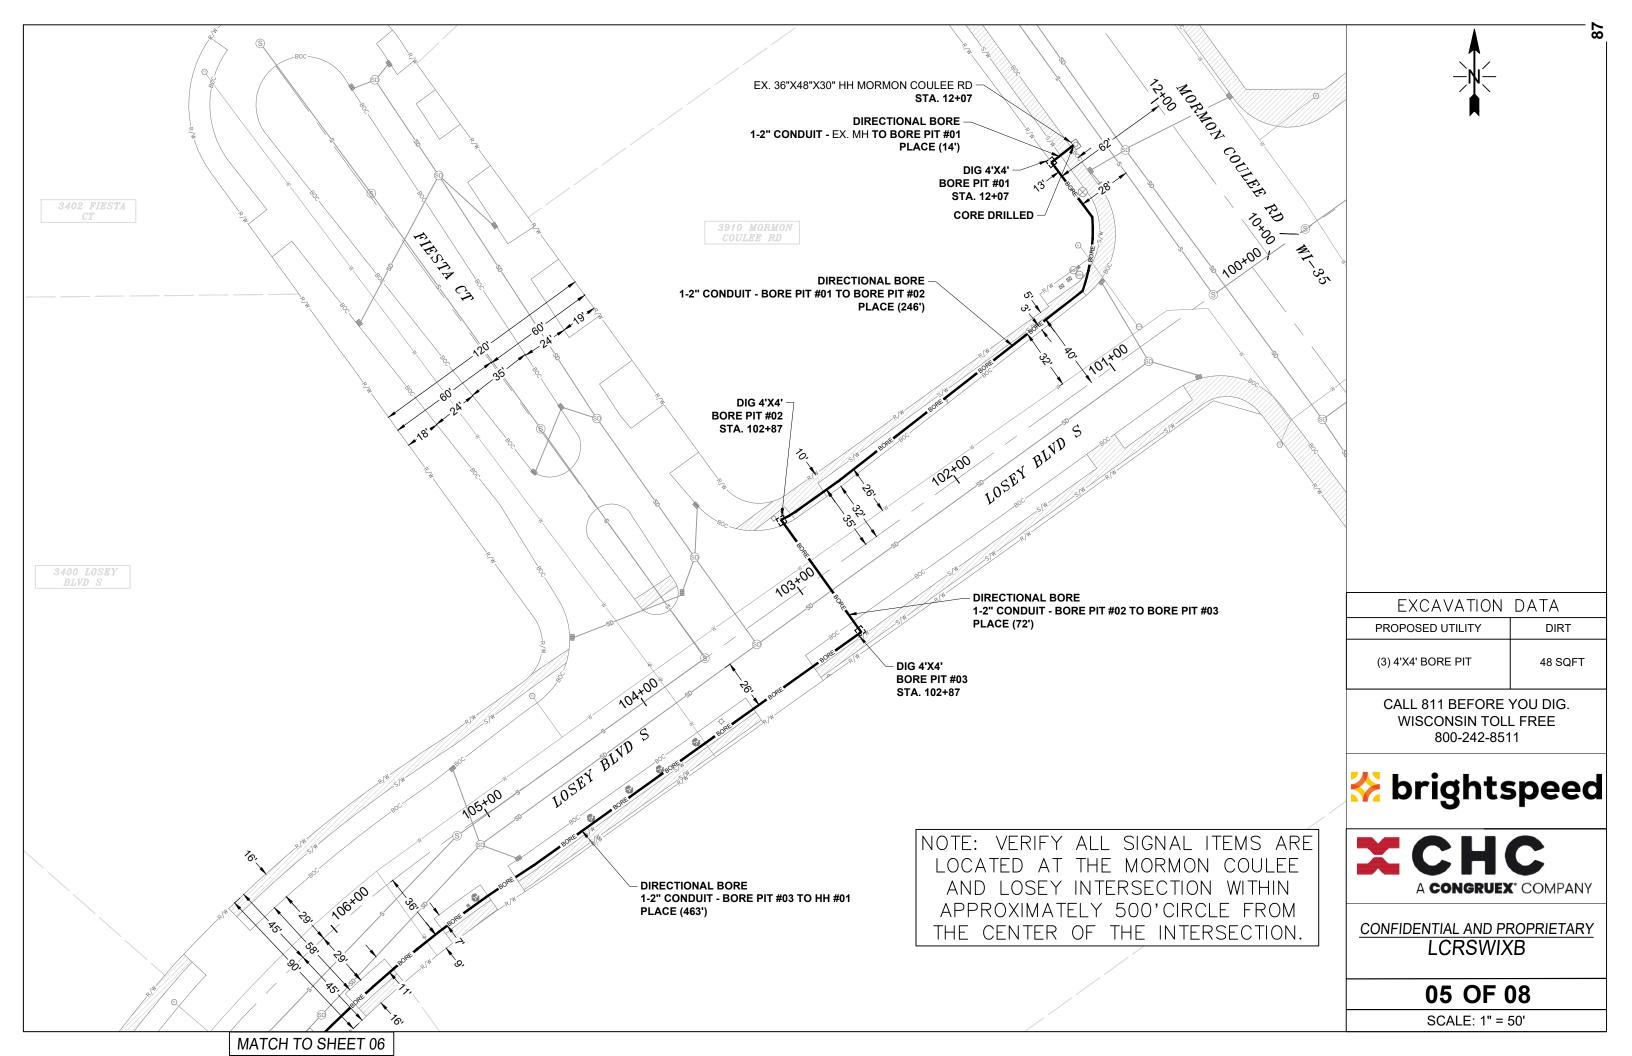

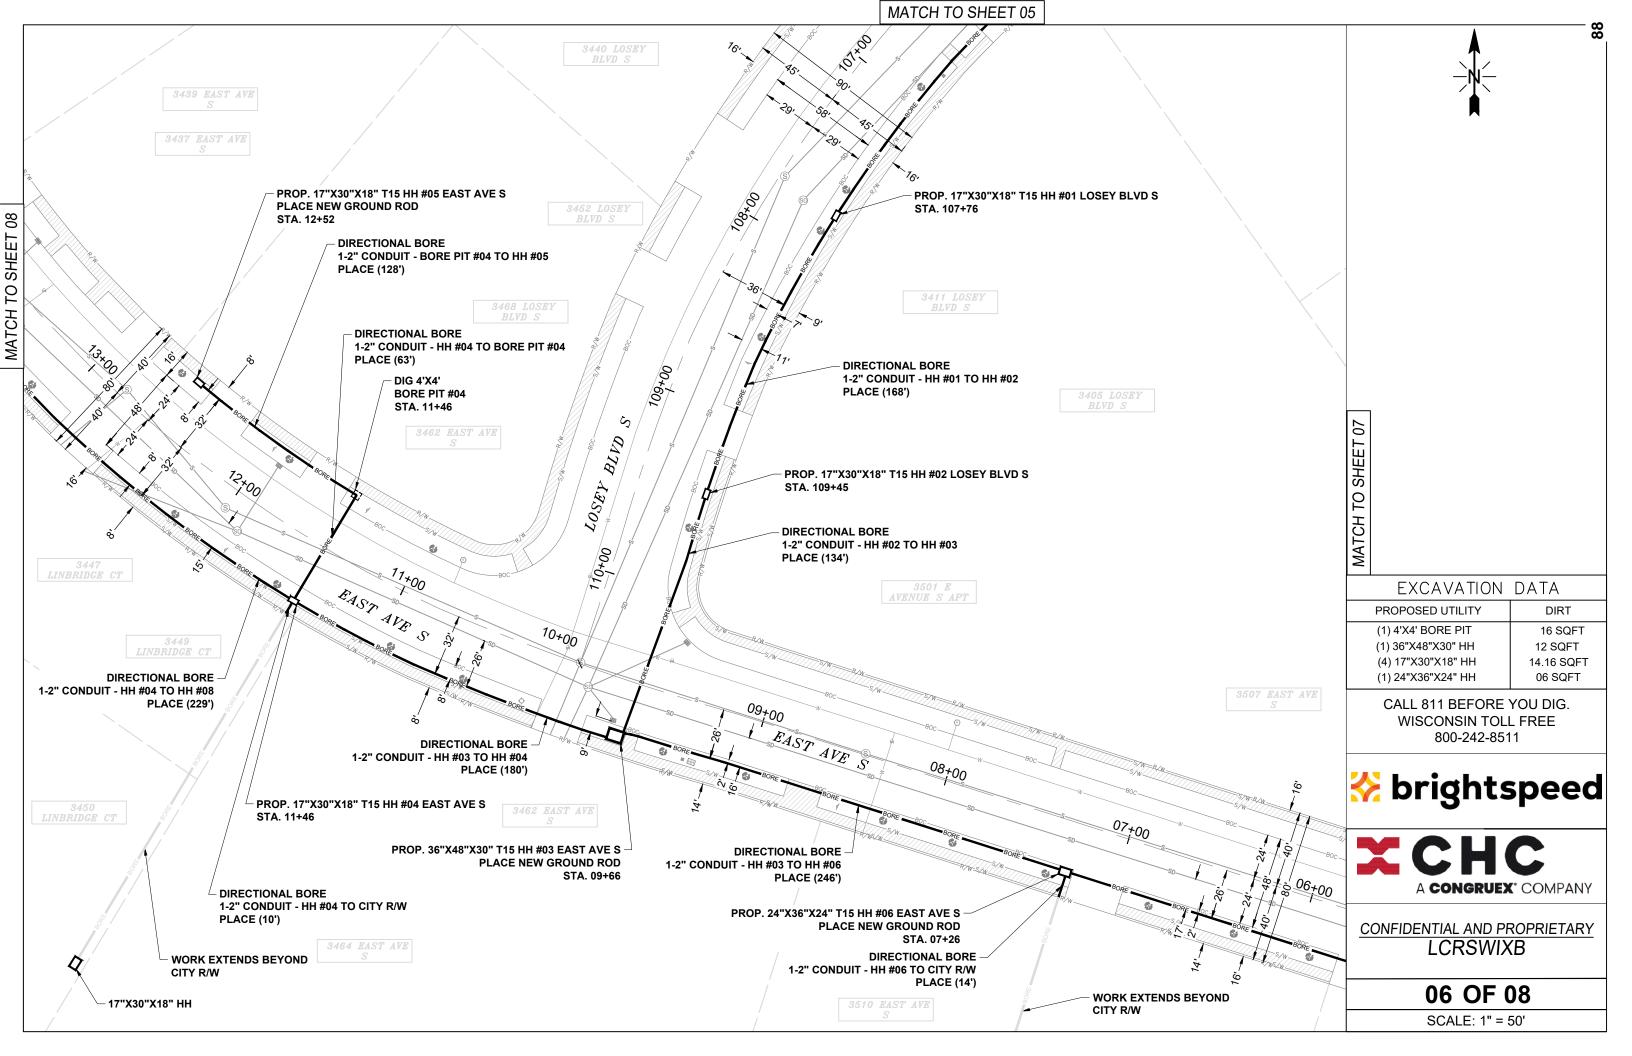

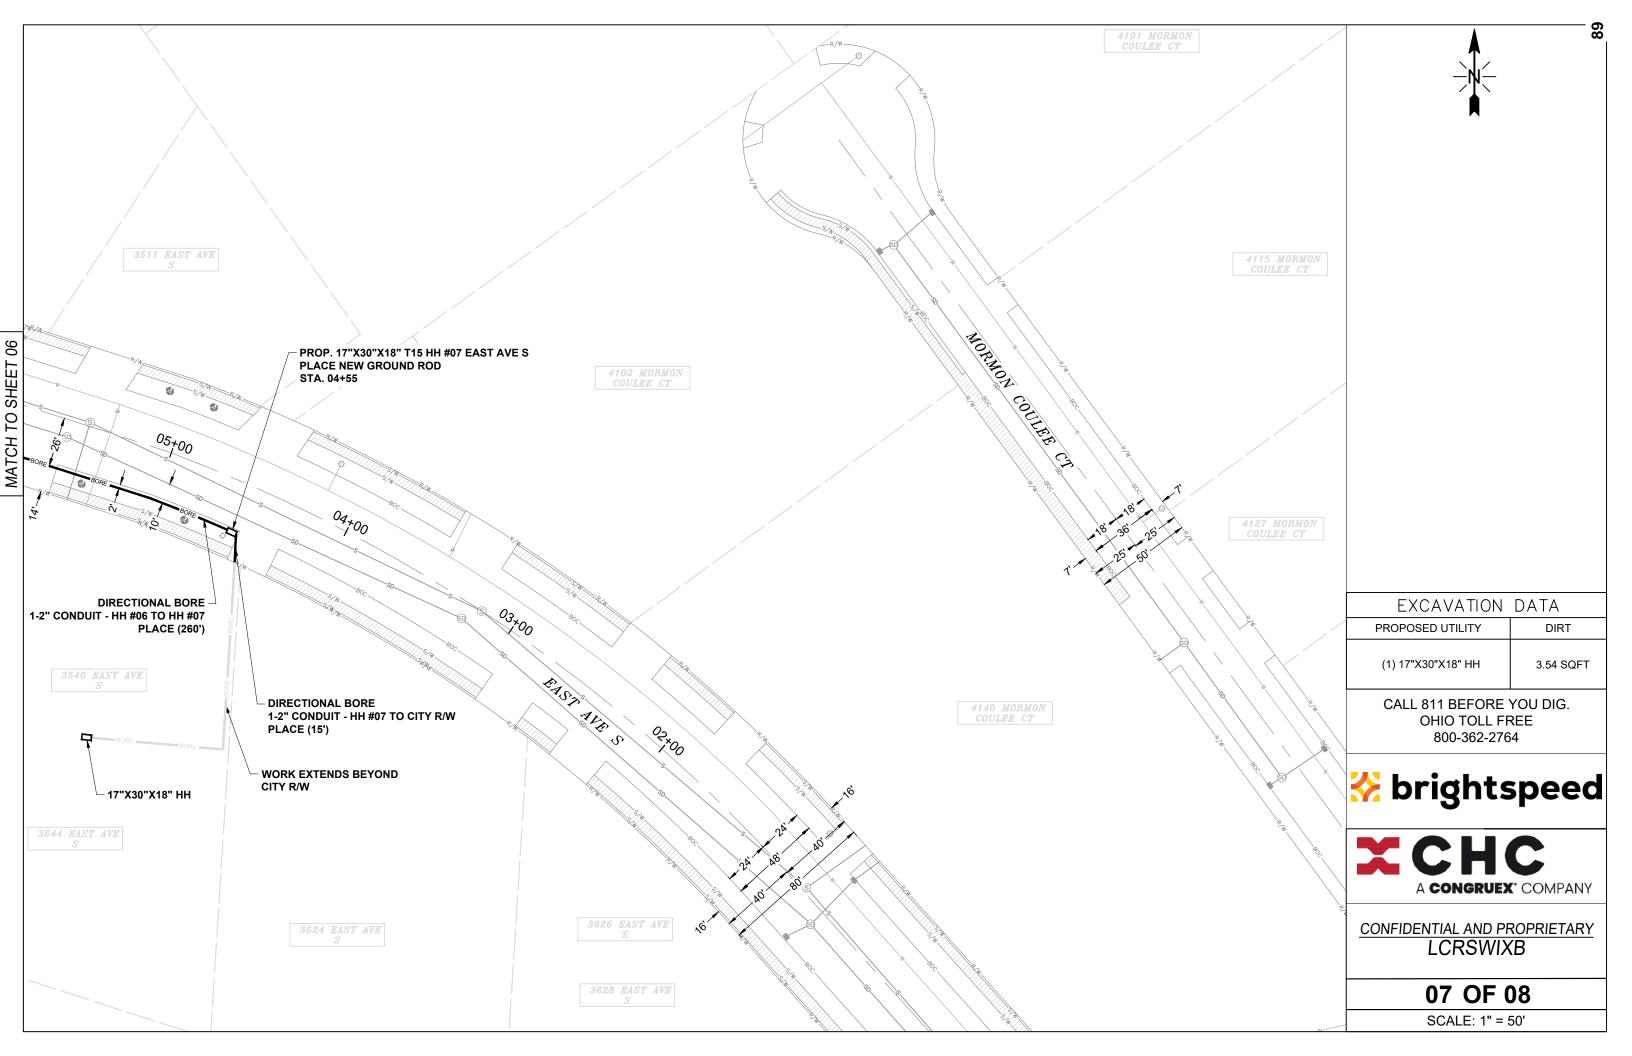

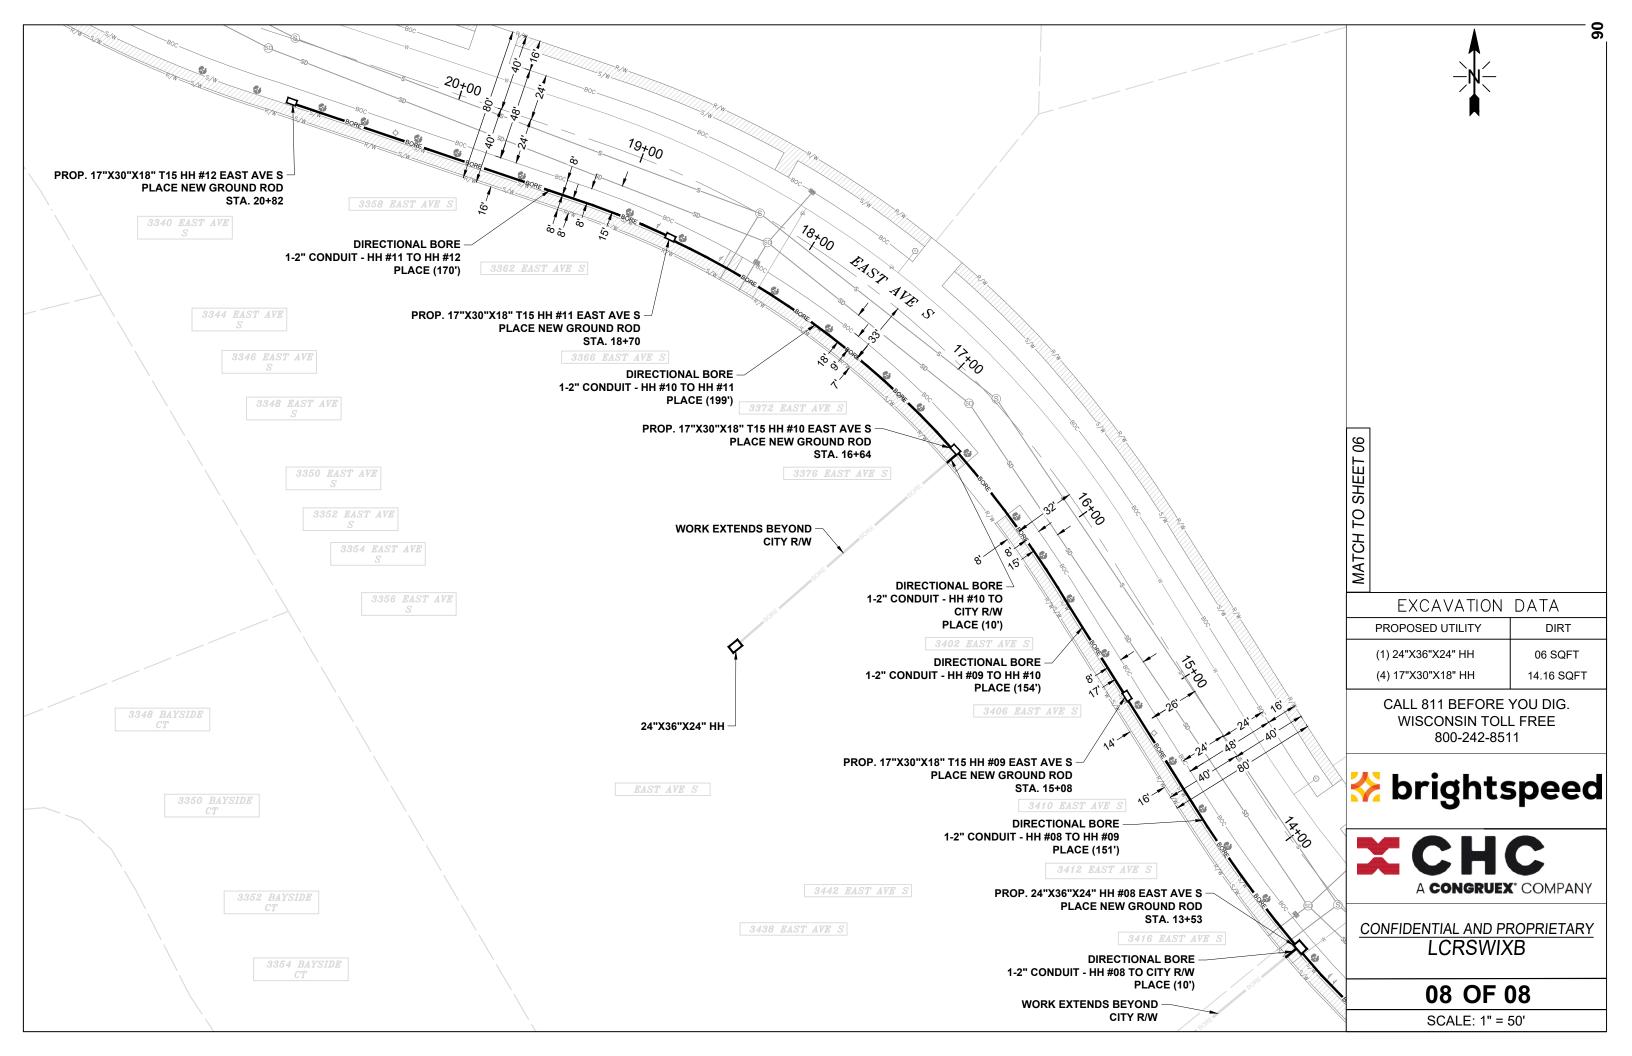

BRIGHTSPEED LA CROSSE


LCRSWIXB 3910 MORMON COULEE RD, LA CROSSE, WI 54601, USA CONDUIT LAYOUT

Sheet List Table			
Sheet Number	Sheet Title		
01	COVER SHEET		
02	GENERAL NOTES		
03	LEGENDS		
04	TYPICALS		
05-08	FIBER LAYOUTS		

Material List Table				
ITEM	QUANTITY			
FEEDER FIBER	00			
JUMPER	00			
17X30X18 HH	07			
36X48X30 HH	01			
24X36X24 HH	02			
2" CONDUIT	2,957'			
NEW STRAND	00			
ANCHOR	00			

BLM INFO					
SECTION		CTION	S16		
MUNICIPALITY		PALITY	LA CROSSE		
TOWNSHIP		/NSHIP	T15N		
COUNTY		YTNUC	LA CROSSE		
RANGE		RANGE	R07W		
REVISION	DATE		DESCRIPTION		

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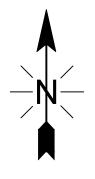

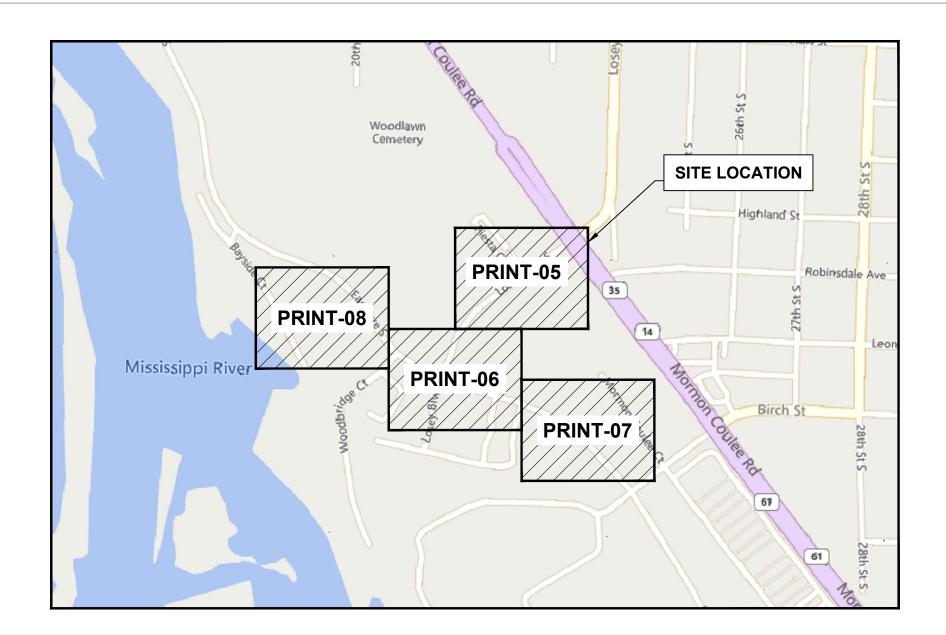
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LEGENDS SHEET




EXISTING EQUIPMEN	TS LEGENDS		
	PWR ELECTRIC TRANSFORM	MER G GAS METER	CULVERT
	E ELECTRIC METER	₩ GAS VALVE	C/L MONUMENT
FP EXISTING FLOWERP		OHOLE SEWER MANHOLE	> ANCHOR & DOWN
HH EXISTING HANDHOL	E	(MH) UNKNOWN MANHOLE	
□ TELEPHONE CABINE	T V EXISTING VAULT	W WATER METER	
TELEPHONE MANH(₩ WATER VALVE	
_	Y	⟨H⟩ FIRE HYDRANT	
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			BASIN
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·	-	<u> </u>	
FROFOSED EQUIFINE	IN 13 LEGENDS		
□ 12"X24"X18" HAI	NDHOLE		
☐ 17"X30"X18" HA	NDHOLE		
24"X36"X24" HAI	NDHOLE		
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ANCHOR & DOV	VN GUY		
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TYPICALS SHEET




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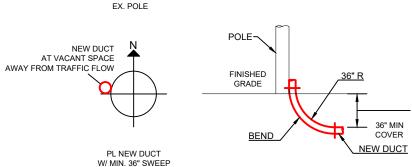
MINIMUM STANDARDS FOR DIRECTIONAL BORING
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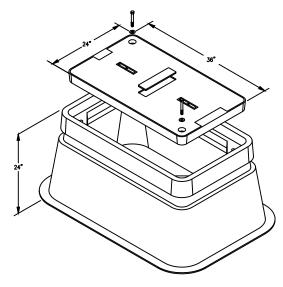
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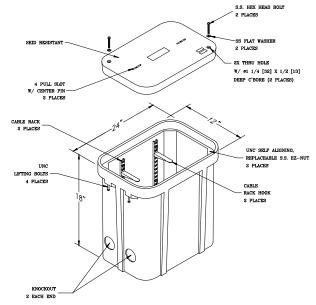
ELEVATION




<u>RISER DETAILS</u>

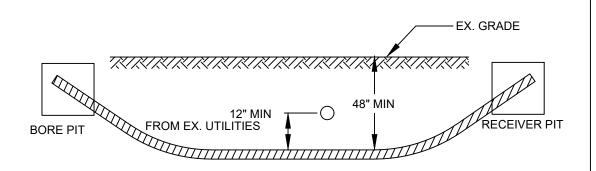



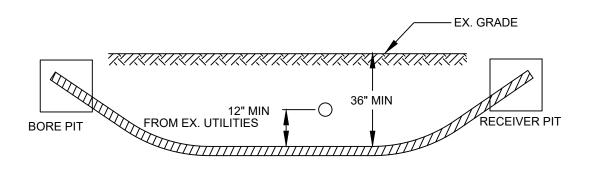





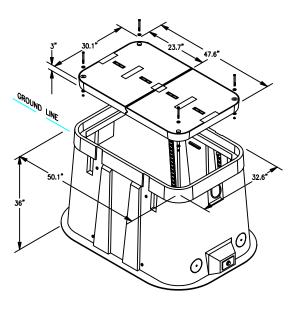





17"x30"x18"

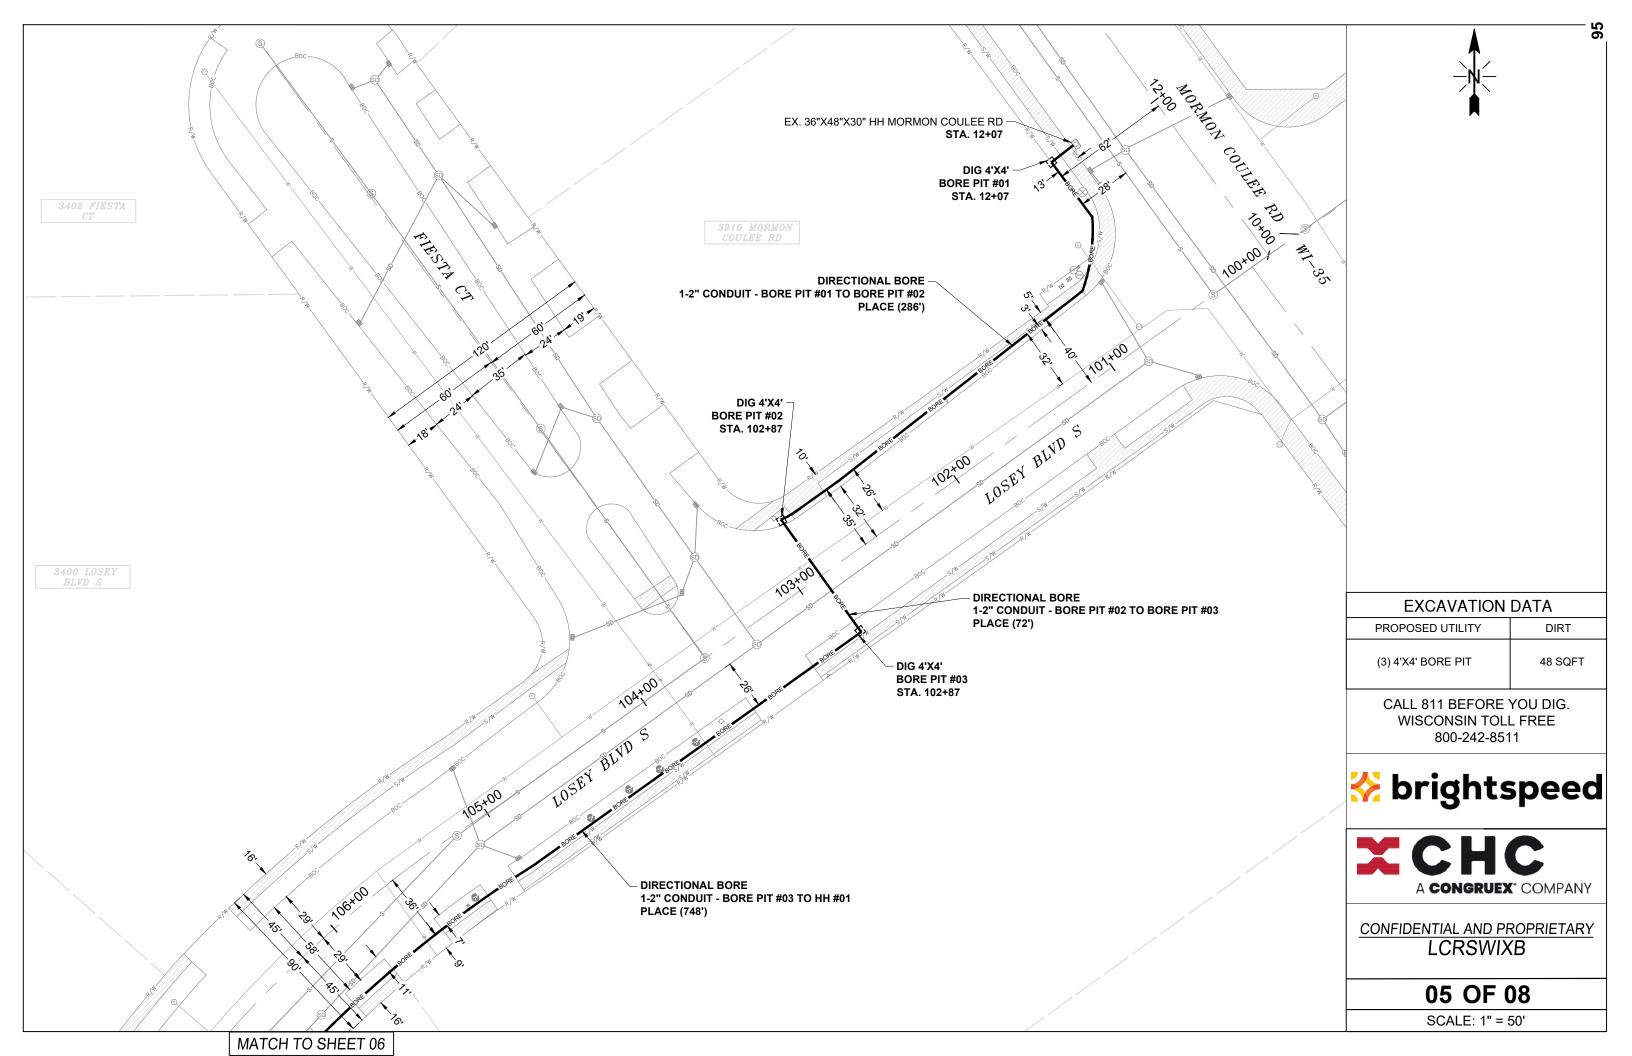

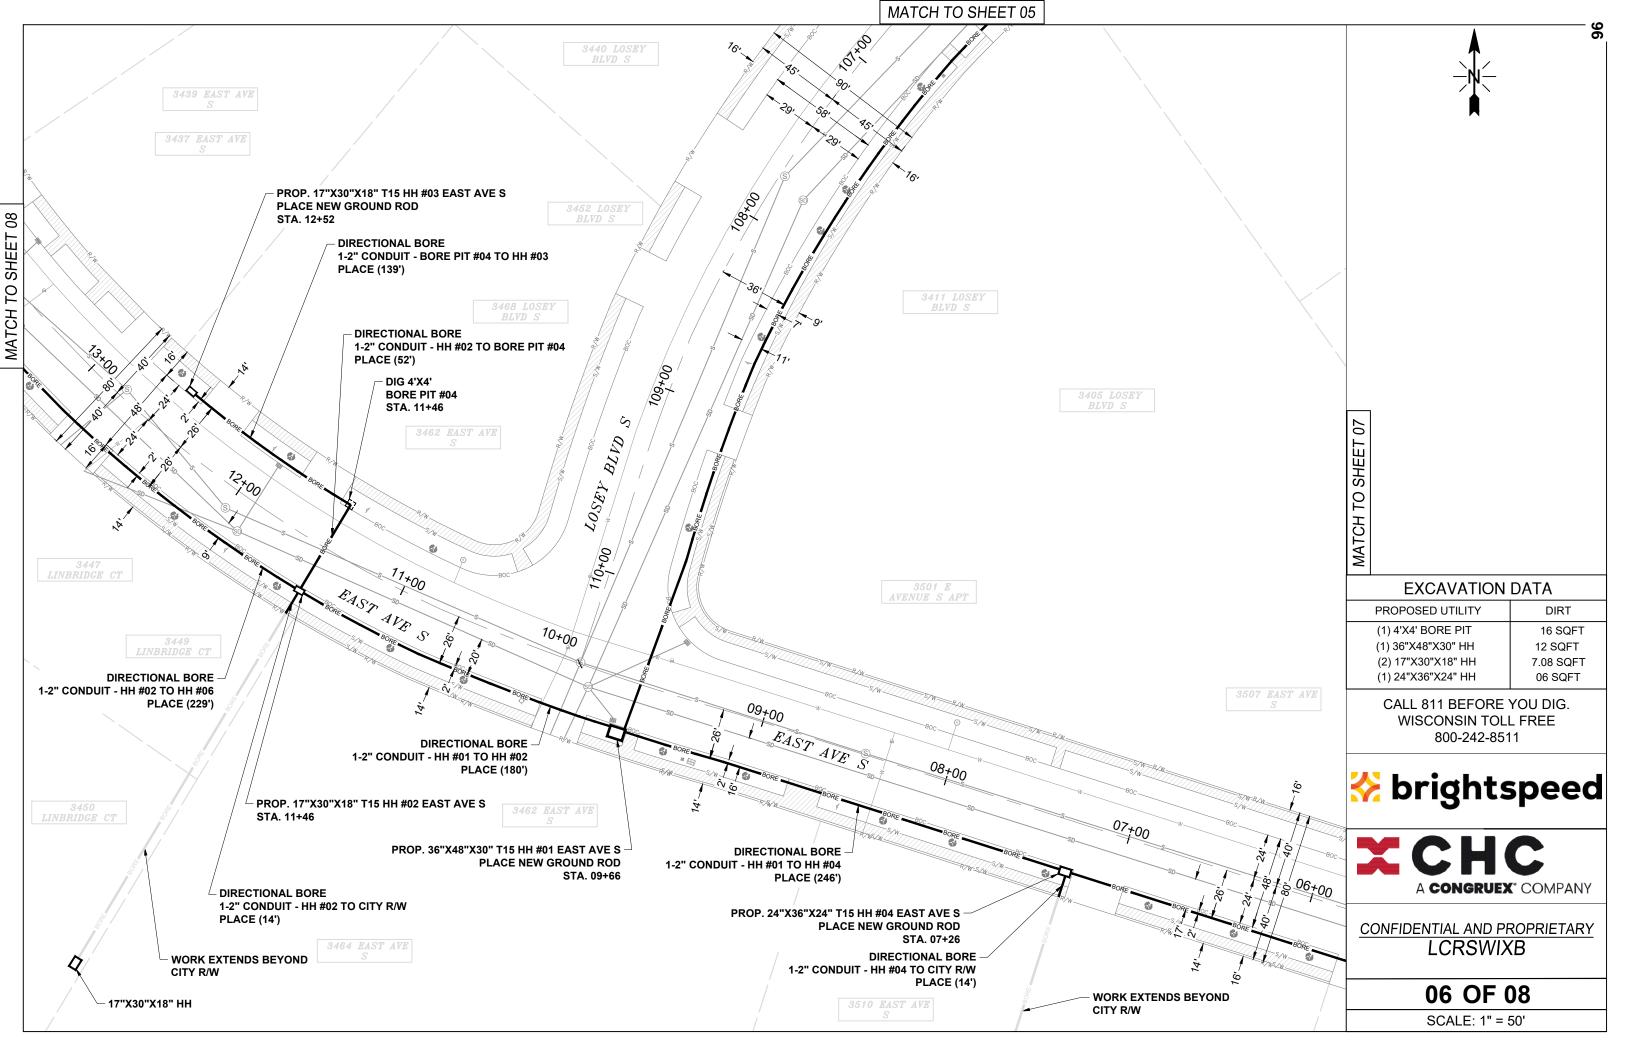

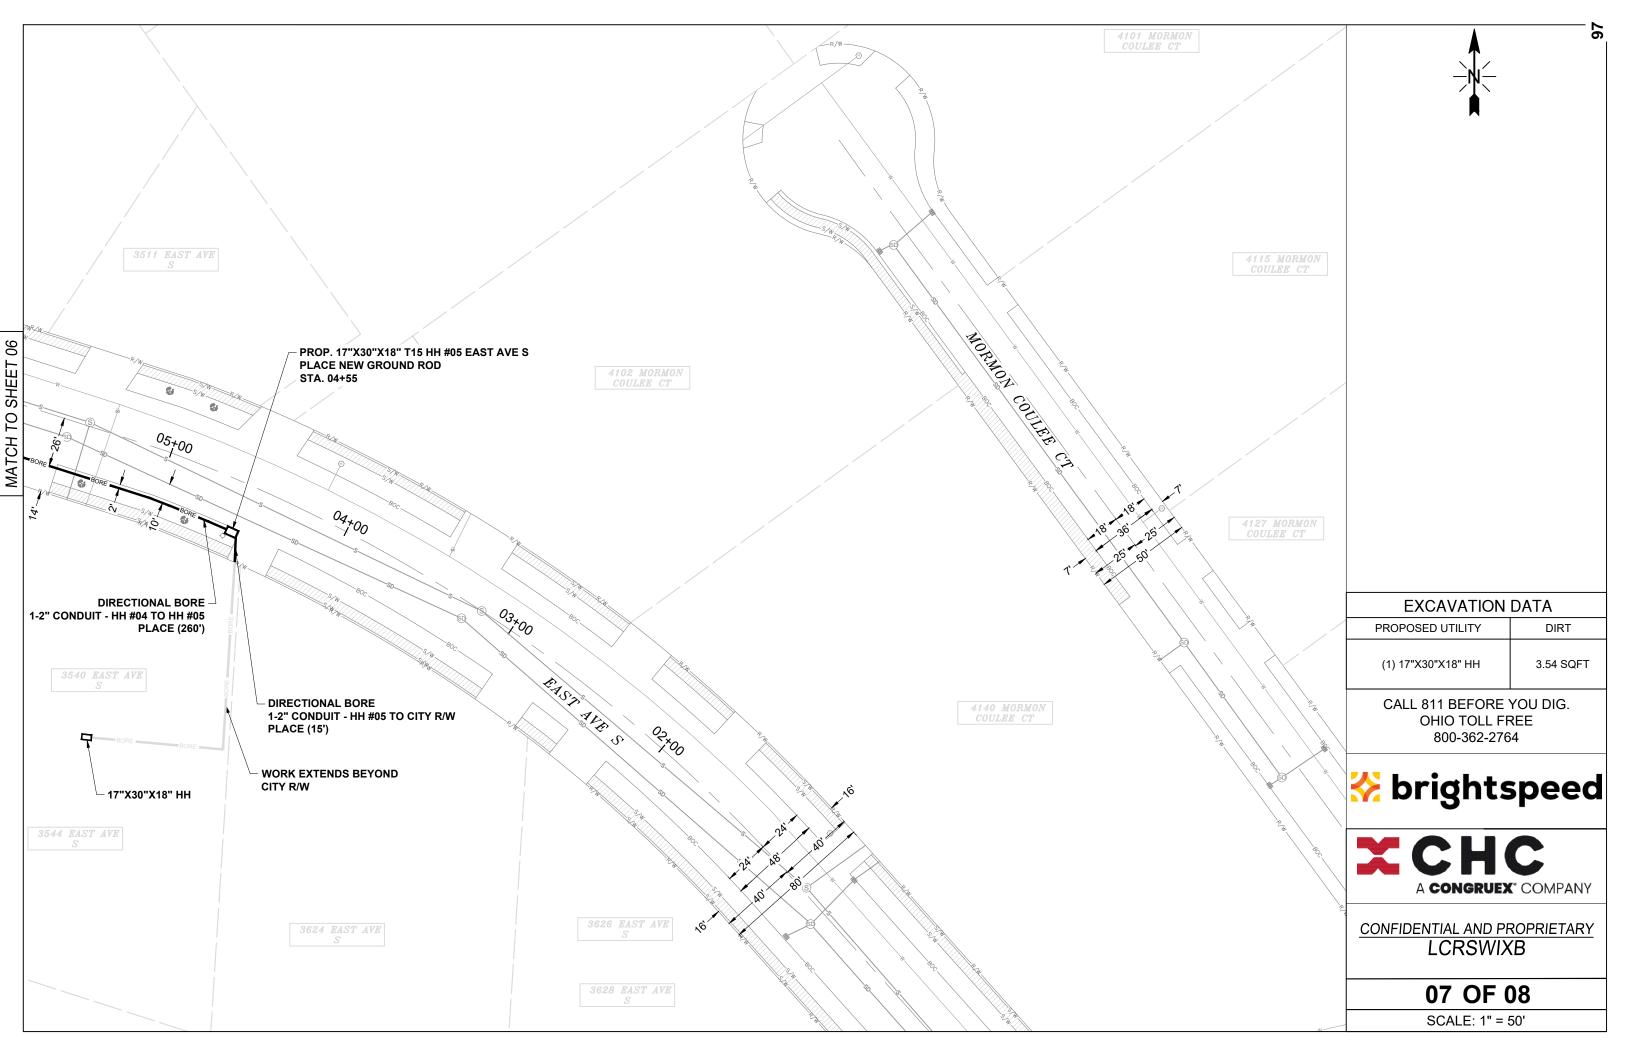

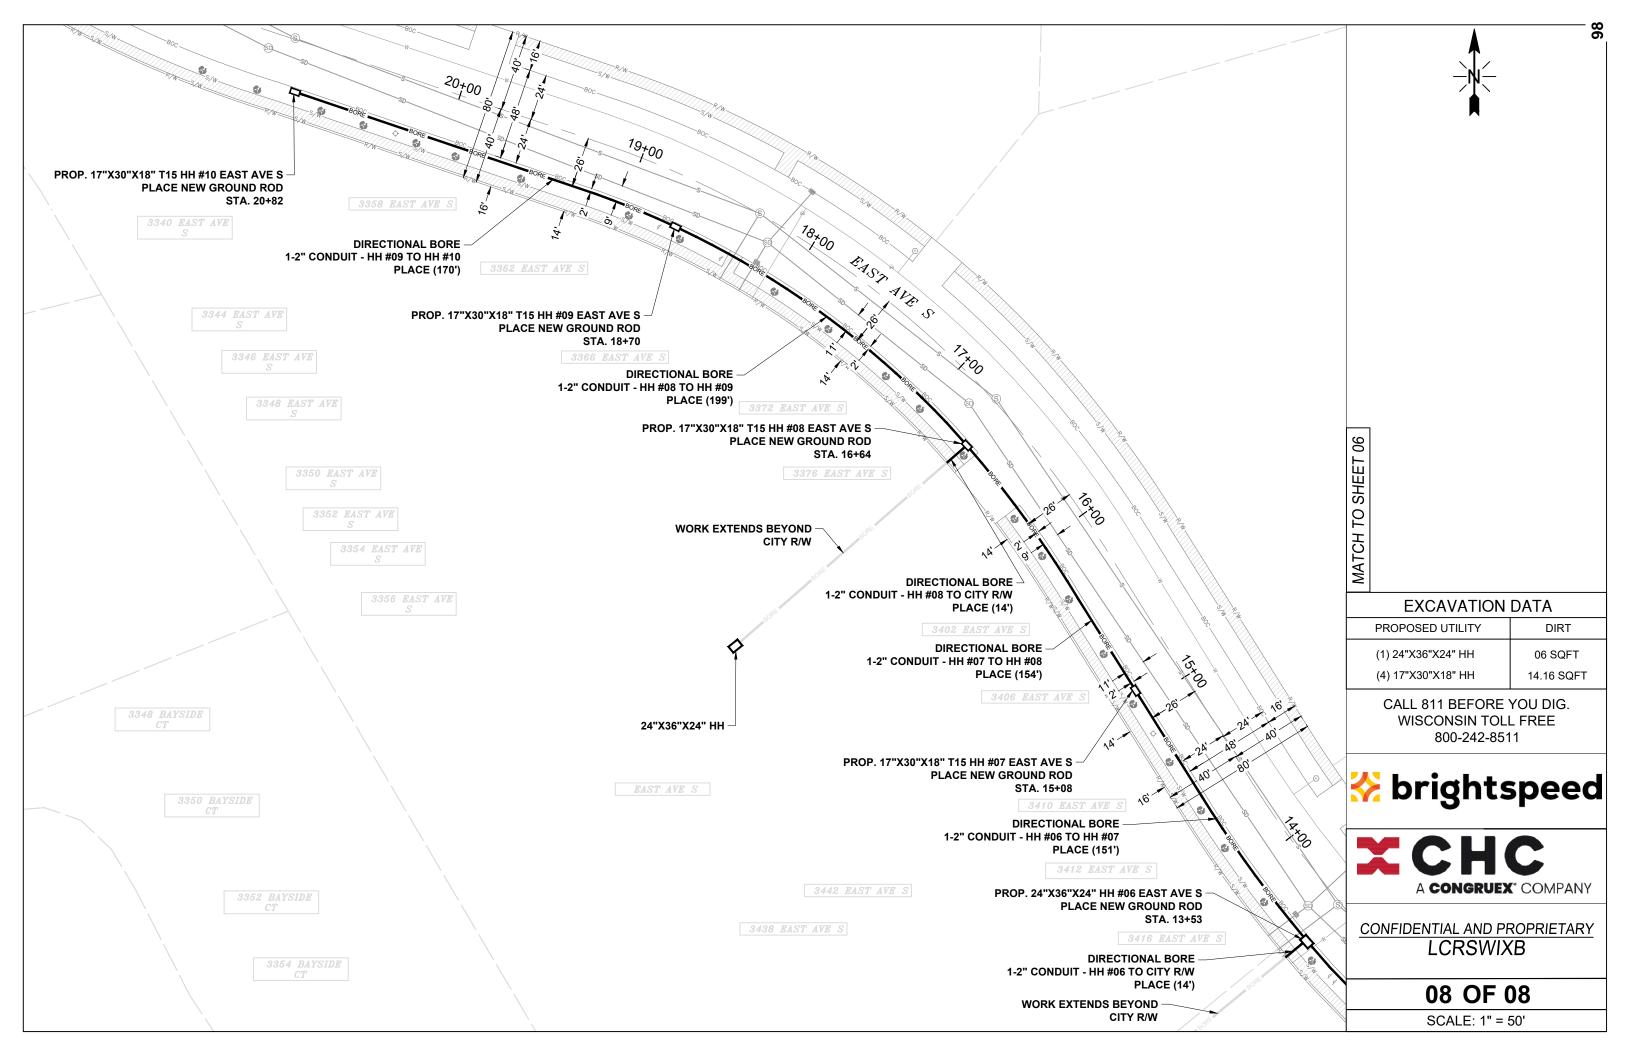



City of La Crosse, Wisconsin

City Hall 400 La Crosse Street La Crosse, WI 54601

Text File

File Number: 25-0679

Agenda Date: 6/16/2025 Version: 1 Status: Agenda Ready

In Control: Board of Public Works File Type: General Item



REVOCABLE OCCUPANCY / STREET PRIVILEGE PERMIT APPLICATION FOR GAS / ELECTRIC UTILITIES

City of La Crosse Engineering Department

Phone: 608-789-7505 Email: engineering@cityoflacrosse.org http://cityoflacrosse.org

City Utility Potential Conflict Notification and Sigr	n-Off			
nitial Application Fee \$	_			Permit Number:
Certificate of Insurance (City as additional Insure	d)		-	
City Utilities, Lighting and Signals must be show Proposed Communications Plan)	11 011			Encroachment Type:
Scale Drawing of encroachments City Utilities Lighting and Signals must be show	n on			
			I	Approval Date:
Required items to be provided by Applica	ant:			Board of Public Works
BELOW THIS LINE TO	RE COMPLETE	BY	CITY STAF	TONLY
Please return this completed application along with re Engineering Department, 400 La Crosse Street, La Cronthe Board of Public Works agenda for consideration	rosse, WI 54601. You on. Average comple t	ı will tl	hen be given r me for valida	notice of when your request will be tion 45 days.
·				
Signature of Owner or designee: <u>Kyle Patta</u> Print Name and Title: <u>Kyle Patterson - Des</u>				Date: 5/15/25
complete and correct; the Work or Use performed sha ules, regulations, policies and special conditions of the an approved permit with diligence and convenience to	all comply with all the ne City of La Crosse. on the public. See St	laws of	of the State of pplicant agree 2 of 2 for Ac	Wisconsin, and all ordinances, s to perform the work covered by Iditional Conditions.
certify that I have reviewed the Municipal Code and unave the full authority to make the foregoing application			•	
-1101 Gao. 1110 1110 1110 1110 1110 1110 1110 11	ck of Caledonia St -	City	oi La Crosse	
Encroachment Addresses: 300 & 200 Bloo	de of Colodonia Ct	City	of La Crassa	
Description of Proposed Encroachment:	Renew existing ga Caledonia St from			•
Phone # <u>303-788-9146</u>		ess _	kyle.patters	on@xcelenergy.com
Application Preparer (if different from Relationship with Owner: Contract Em	above)			
	=:a , taa.	C33 _		
Phone # 303-788-9146	Fmail Addr	220	kyle.patters	Zip: 54602 on@xcelenergy.com

STREET PRIVILEGE PERMIT CONDITIONS FOR GAS / ELECTRIC UTILITY INSTALLATIONS

- The applicant shall be primarily liable for damages to person or property by reason of the granting of this street privilege permit.
- 2. The applicant shall obtain an excavation permit from the City of La Crosse Engineering Department prior to performing installation or any maintenance on the Utility in the City right-of-way that requires excavation or disruption of surface, pavement, sidewalk, curb and gutter, or other structure.
- 3. Applicant agrees to provide the City of La Crosse with final "as-built" plans when installation is complete.
- Applicant agrees that any pavement, concrete or green space disturbed during drilling activities shall be restored to its prior condition.
- 5. Applicant agrees that said installation shall not interfere with the City's water, sanitary sewer, or storm sewer underground infrastructure that may be in the area.
- 6. Applicant further agrees that they will make arrangements with the public utility companies and the City of La Crosse to clear all public underground utilities prior to initiating such work, and if necessary, applicant will make arrangements with the City of La Crosse to ensure proper traffic control.
- Applicant waives any and all rights to contest in any way or manner the validity of Sec. 66.0425 of the Wisconsin Statutes and the amount of compensation charged.
- 8. Applicant agrees to become a member of Diggers Hotline for marking / locating of utility.
- 9. The applicant for a permit to encroach on the public right-of-way shall procure and maintain for the duration of the permit a minimum liability and contractual liability policy in the amount of \$100,000.00 each person, \$300,000.00 each accident for bodily injury and \$100,000.00 for property damage. A certificate of such insurance shall be filed with the City Engineer as part of the application. The insurance shall name the City, its officials, employees and agents as additional insureds. The Board may approve greater insurance protection on a case-by-case basis.
- 10. Applicant further agrees to hold harmless the City for any damage to said Utility while the City, its agents or contractors are conducting construction for maintenance activities in or upon such area in which said utility lies; provided, however, the City shall make a good faith effort to notify applicant of any maintenance or work in the area of the street privilege permit which may damage applicant's utility.
- 11. Applicant agrees to remove the utility and return the area to its original condition upon ten (10) days' notice by the Board of Public Works. The applicant further agrees that if it does not remove the utility within ten (10) days after receiving notice, the City is authorized to remove the same and applicant agrees to pay the City for all costs of such removal.
- 12. Applicant further agrees that the obligations and conditions of this street privilege permit shall be binding upon all heirs, successors and assigns of applicant.
- 13. The person(s) signing this Permit warrant that they have the authority to sign as, or on behalf of, the party for whom they are signing.

