



GENERAL NOTES:


- SEE ID SHEETS FOR FLOOR AND WALL FINISH LAYOUTS.
- SEE ID SHEETS FOR INTERIOR ELEVATION LOCATIONS.
- LOOSE FURNISHINGS EXCEPT AS NOTED SHALL BE PROVIDED AND INSTALLED BY THE OWNER.
- VERIFY EXACT SIZE AND LOCATION OF ALL MECHANICAL / PLUMB AND ELEC. OPENINGS - GENERAL CONTRACTOR SHALL BE RESPONSIBLE FOR FINISH AT ALL VISIBLE AREAS. ALL OPENING SHALL BE SEALED AFTER UTILITY INSTALLATION.
- PAINT ALL EXPOSED STEEL LINTELS.
- SEE STRUCTURAL FOR SLAB CONTROL JOINTS.
- REFER TO OVERALL PLANS FOR FIRE RATING LOCATIONS AND ACCESSIBILITY ROUTES.
- EXTEND ALL WALLS TO DECK UNLESS NOTED OTHERWISE. SEE A500 FOR TOP OF WALL DETAILS.
- UNLESS NOTED OTHERWISE RESTROOM FLOORS SHALL BE SLOPED A MIN. 1/16" : 12" TO FLOOR DRAINS - TO "CENTER", IF NO FLOOR DRAINS.
- FIXED EQUIPMENT IS SHOWN ON THIS PLAN FOR COORDINATION. SEE SHEETS A130-A133 FOR ALL EQUIPMENT NOTES.
- SEE A500 FOR TYPICAL HEAD FLASHING AND THROUGH-WALL FLASHING ISOMETRIC DETAILS.
- COORDINATE ATTIC SPRINKLERS WITH FIRE PROTECTION CONTRACTOR

LEGEND:

- (A) SYMBOL INDICATES WALL TYPE - SEE SHEET A600 FOR WALL TYPE DETAILS.
- (A) SYMBOL INDICATES WINDOW TYPE. SEE SHEET A600 FOR WINDOW FRAME ELEVATIONS.
- (A) SYMBOL INDICATES CONSTRUCTION NOTE THIS SHEET
- 1 HOUR WALL

KEY NOTES PLAN

- CONCRETE STOOP- SEE STRUCTURAL.
- CONCRETE PATIO.
- CEILING FAN ABOVE.
- ELECTRIC FIREPLACE.
- LINE OF BEAM ABOVE.
- EXPOSED TRUSSES.
- HOSE BIB- SEE PLUMBING.
- FIRE RISER CONNECTION.
- FOLDING PANEL PARTITION.
- CONCRETE PAD FOR MECHANICAL UNITS.
- Plan
- Plan

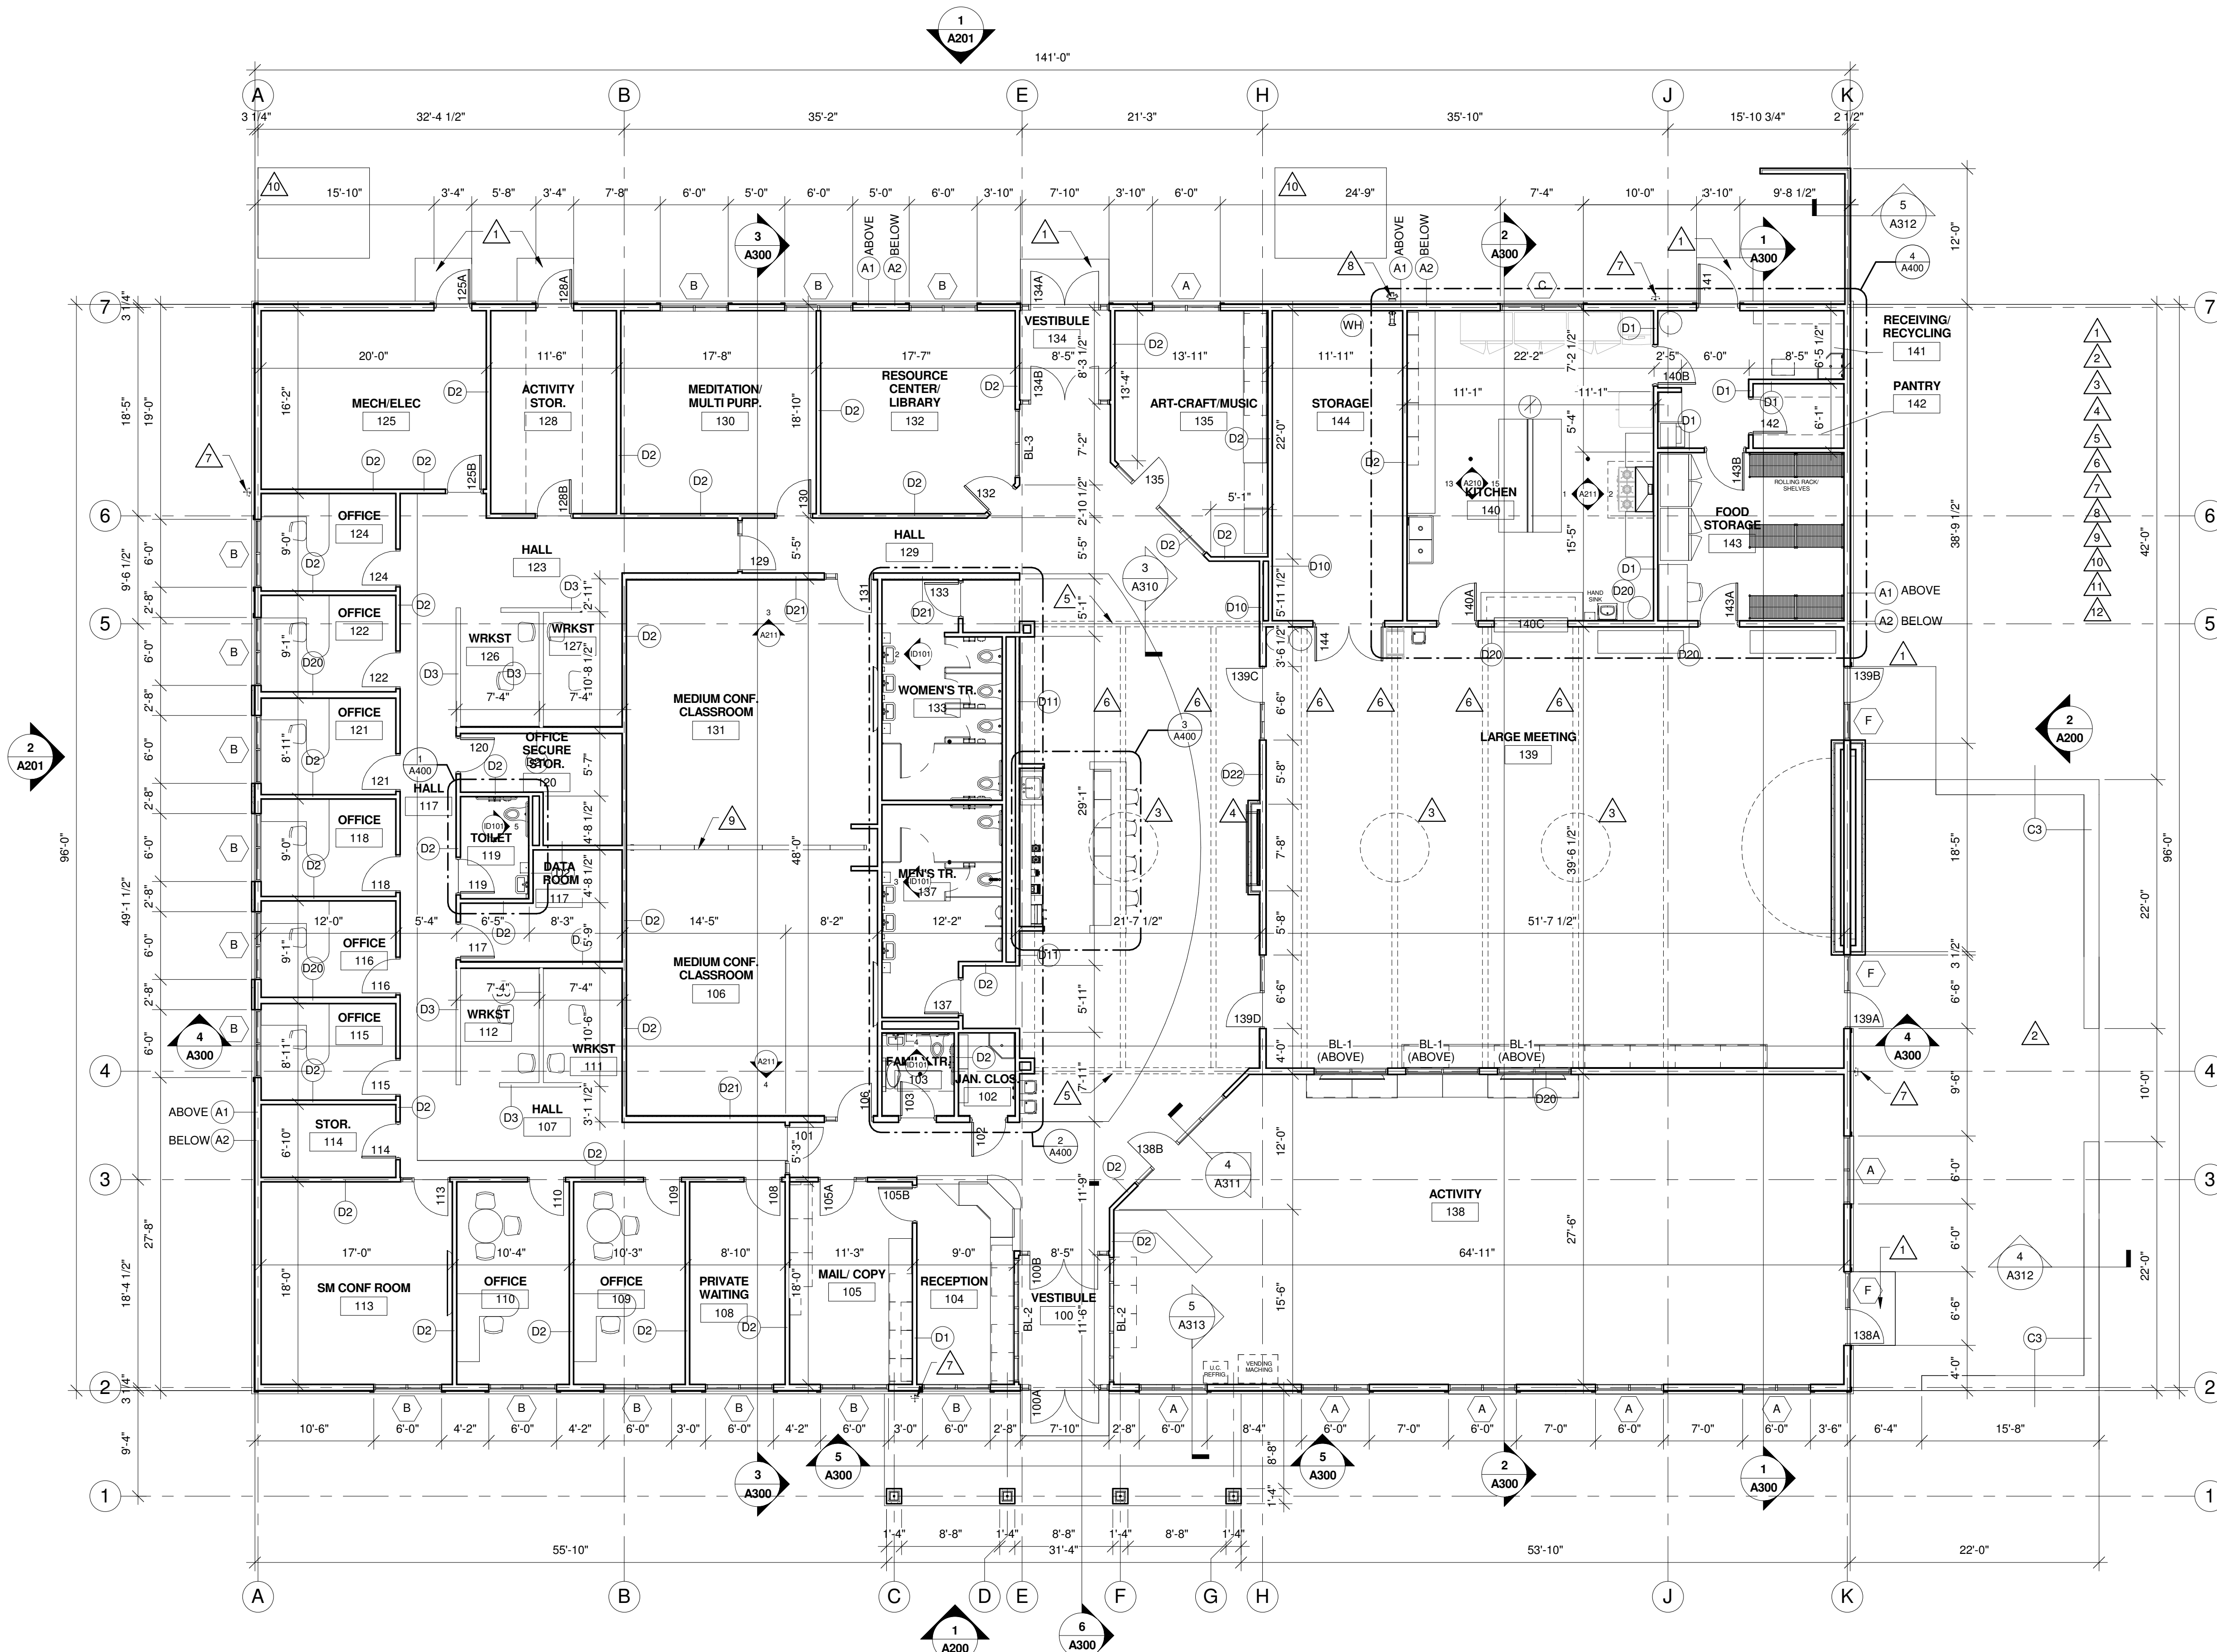

1 FLOOR PLAN
1/8" = 1'-0"

**COULEE COUNCIL ON
ADDITIONS
COULEE RECOVERY
CENTER
921 FERRY STREET - LA CROSSE,
WISCONSIN 54601**

Project Title:
Project Location:
Sheet Title:

HSR Project Number:
HSR #

Project Date:
Issue Date

Drawn By:
HSR

Key Plan:

REVIEW
**NOT FOR
CONSTRUCTION**

Revisions:

No.	Description	Date

Graphic Scale:
0 2 4 8 12'

Last Update:
8/29/2017 2:50:19 PM

A100



Consultant:

**COULLEE COUNCIL ON
ADDITIONS
COULLEE RECOVERY
CENTER**
921 FERRY STREET - LA CROSSE,
WISCONSIN 54601

Project Title:
Project Location:
Sheet Title:

HSR Project Number:
HSR #

Project Date:
Issue Date

Drawn By:
HSR

Key Plan:


**REVIEW
NOT FOR
CONSTRUCTION**

Revisions:		
No.	Description	Date

Graphic Scale:
VARIES

Last Update:
8/29/2017 2:50:25 PM

A200

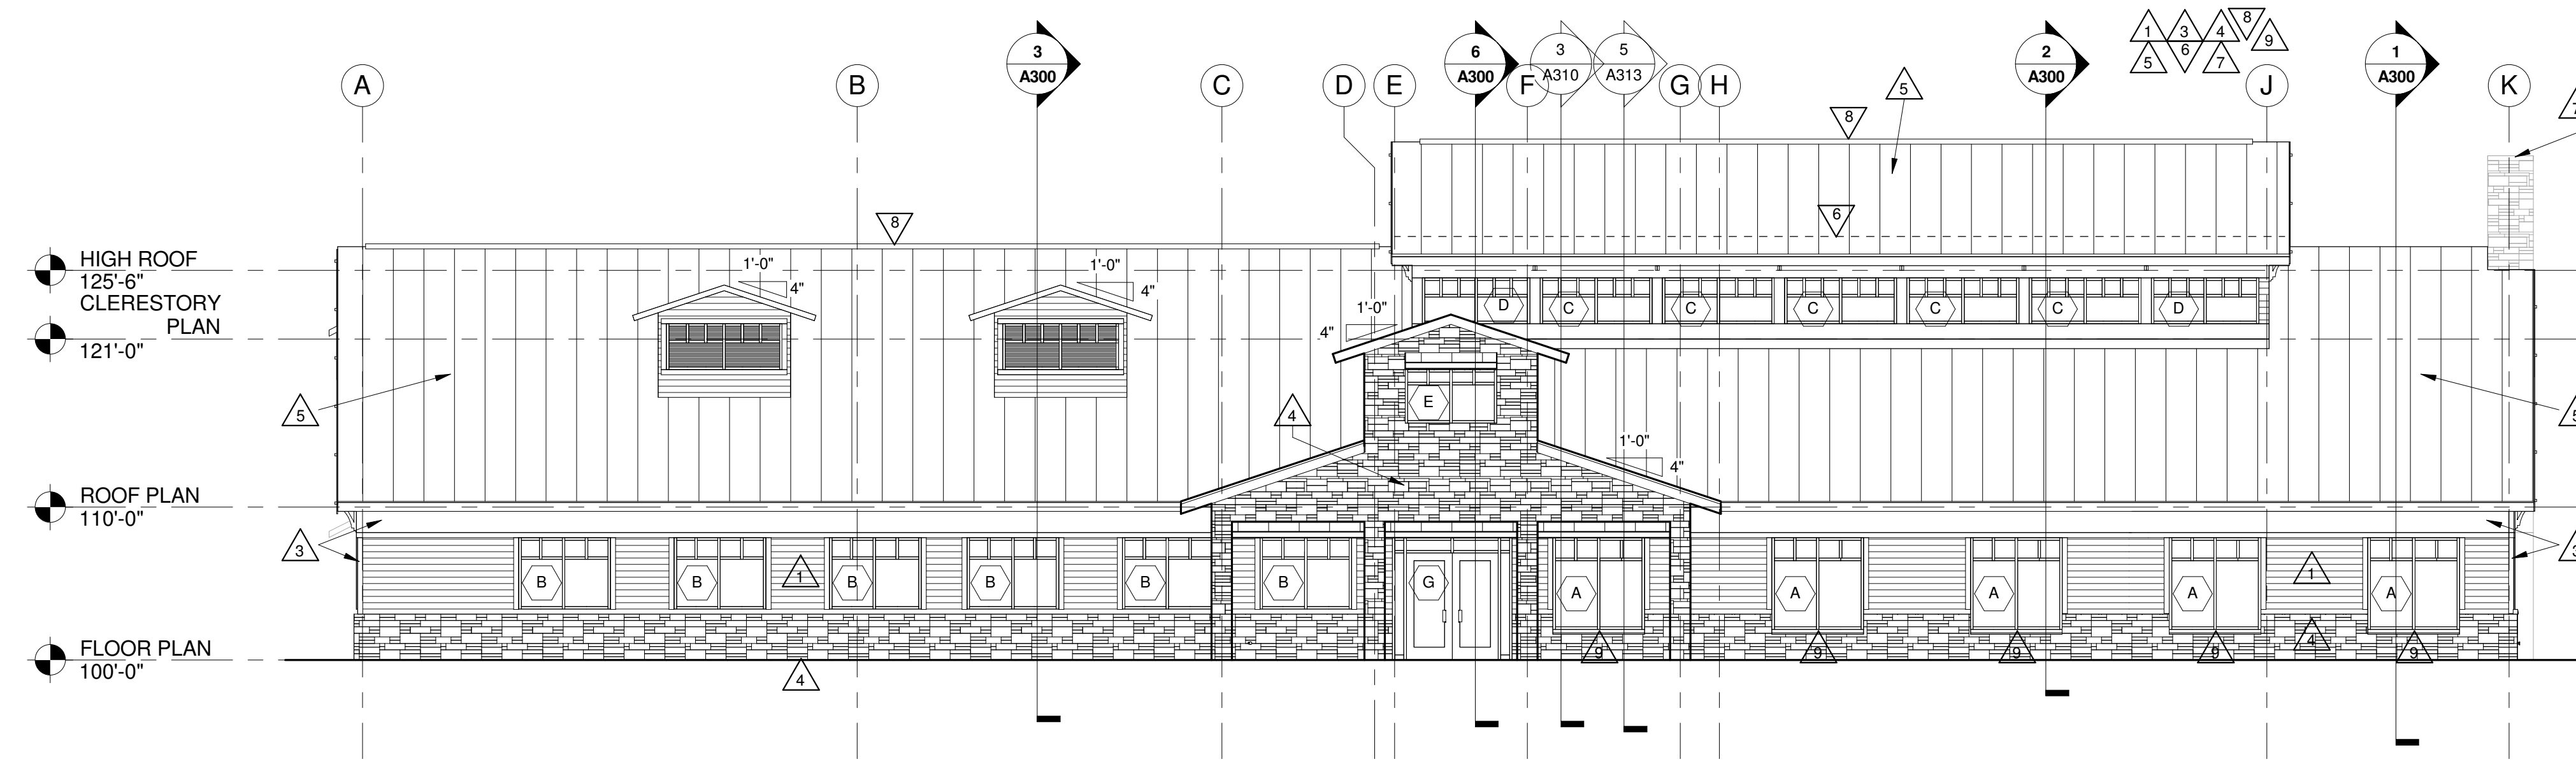


1 SOUTH ELEVATION
1/8" = 1'-0"

- GENERAL NOTES:**
- A SEE DETAILS A510 FOR CONTROL JOINT (CJ) AND BRICK CONTROL JOINT (BCJ) INFORMATION.
 - B BRICK COURSING: RUNNING BOND TYPICAL.
 - C SEE SPECIFICATION FOR MATERIAL TYPE.
- LEGEND:**
- 1 KEYNOTE TAG
 - WINDOW TAG. SEE SHEET A600 FOR FRAME ELEVATIONS
 - CJ THROUGH WALL CONTROL JOINT - SEE DETAILS A510
 - BCJ BRICK VENEER CONTROL JOINT - SEE DETAILS A510
 - MANUFACTURED STONE
 - COMPOSITE LAP SIDING
 - STANDING SEAM METAL ROOF

KEY NOTES ELEVATION

1	PREFINISHED COMPOSITE WOOD LAP SIDING.
2	PREFINISHED COMPOSITE SHAKE SIDING
3	PREFINISHED COMPOSITE WOOD TRIM.
4	MANUFACTURED STONE VENEER
5	STANDING SEAM METAL ROOF - SEE ROOF PLAN FOR ADD'L INFORMATION
6	SNOW BARS - SEE ROOF PLAN.
7	PREFINISHED METAL CAP - SEE ROOF PLAN.
8	RIDGE VENT
9	MANUFACTURED STONE VENEER SILL
10	PREFINISHED METAL CAP FLASHING @ TOP OF WALL
11	ALUMINUM FRAME AWNINGS

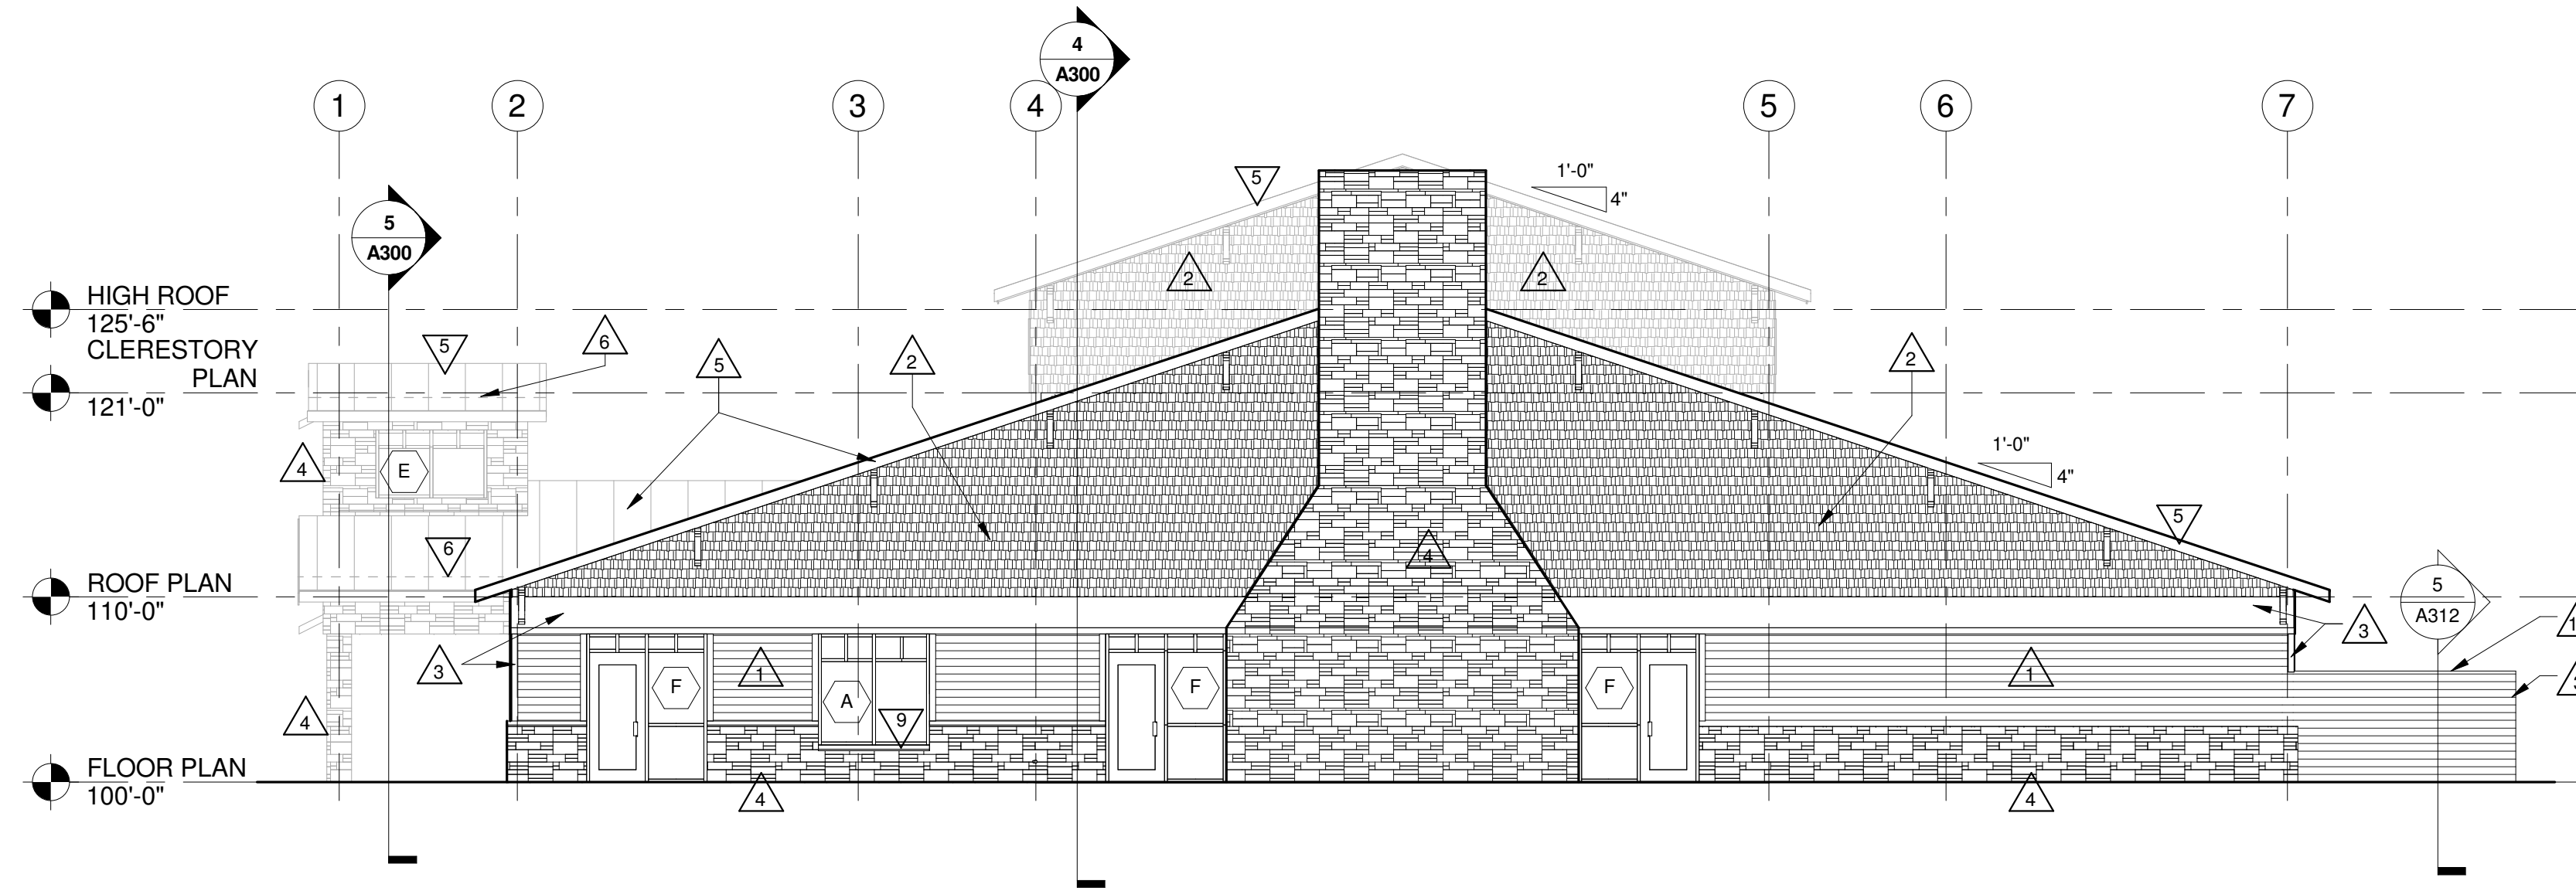

2 EAST ELEVATION
1/8" = 1'-0"



**REVIEW
NOT FOR
CONSTRUCTION**

Revisions:

No.	Description	Date

Graphic Scale:
VARIES

Last Update:
8/29/2017 2:50:28 PM

A201

GENERAL NOTES:

A SEE DETAILS A510 FOR CONTROL JOINT (CJ) AND BRICK CONTROL JOINT (BCJ) INFORMATION.

B BRICK COURSING: RUNNING BOND TYPICAL.

C SEE SPECIFICATION FOR MATERIAL TYPE.

LEGEND:

△ KEYNOTE TAG

○ WINDOW TAG, SEE SHEET A600 FOR FRAME ELEVATIONS

CJ THROUGH WALL CONTROL JOINT - SEE DETAILS A510

BCJ BRICK VENEER CONTROL JOINT - SEE DETAILS A510

MANUFACTURED STONE

COMPOSITE LAP SIDING

STANDING SEAM METAL ROOF

KEY NOTES ELEVATION

1	PREFINISHED COMPOSITE WOOD LAP SIDING.
2	PREFINISHED COMPOSITE SHAKE SIDING
3	PREFINISHED COMPOSITE WOOD TRIM.
4	MANUFACTURED STONE VENEER
5	STANDING SEAM METAL ROOF - SEE ROOF PLAN FOR ADDL. INFORMATION
6	SNOW BARS - SEE ROOF PLAN.
7	PREFINISHED METAL CAP - SEE ROOF PLAN.
8	RIDGE VENT
9	MANUFACTURED STONE VENEER SILL
10	PREFINISHED METAL CAP FLASHING @ TOP OF WALL
11	ALUMINUM FRAME AWNINGS

