

48' - 0 1/2"

UNIT MATRIX						
	1 BEDROOM	2 BEDROOM	3 BEDROOM	TOTAL UNITS		
3RD FLOOR		6	2	8		
2ND FLOOR			2	0		
1ST FLOOR	2		2	4		
TOTAL	1	4	4	12		
GARAGE STALLS: 14 STALLS						

UNIT MATRIX						
	1 BEDROOM	2 BEDROOM	3 BEDROOM	TOTAL UNITS		
3RD FLOOR		6	2	8		
2ND FLOOR		O I	2	0		
1ST FLOOR	2		2	4		
TOTAL	1	4	4	12		
GARAGE STALLS: 14 STALLS						

19' - 9 1/2" 38' - 8 1/4"	137-T
+	SECOND FLOOR PLAN  1/8" = 1'-0"

32' - 0"

32' - 0"

48' - 0 1/2"

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1 FIRST FLOOR PLAN
1/8" = 1'-0"

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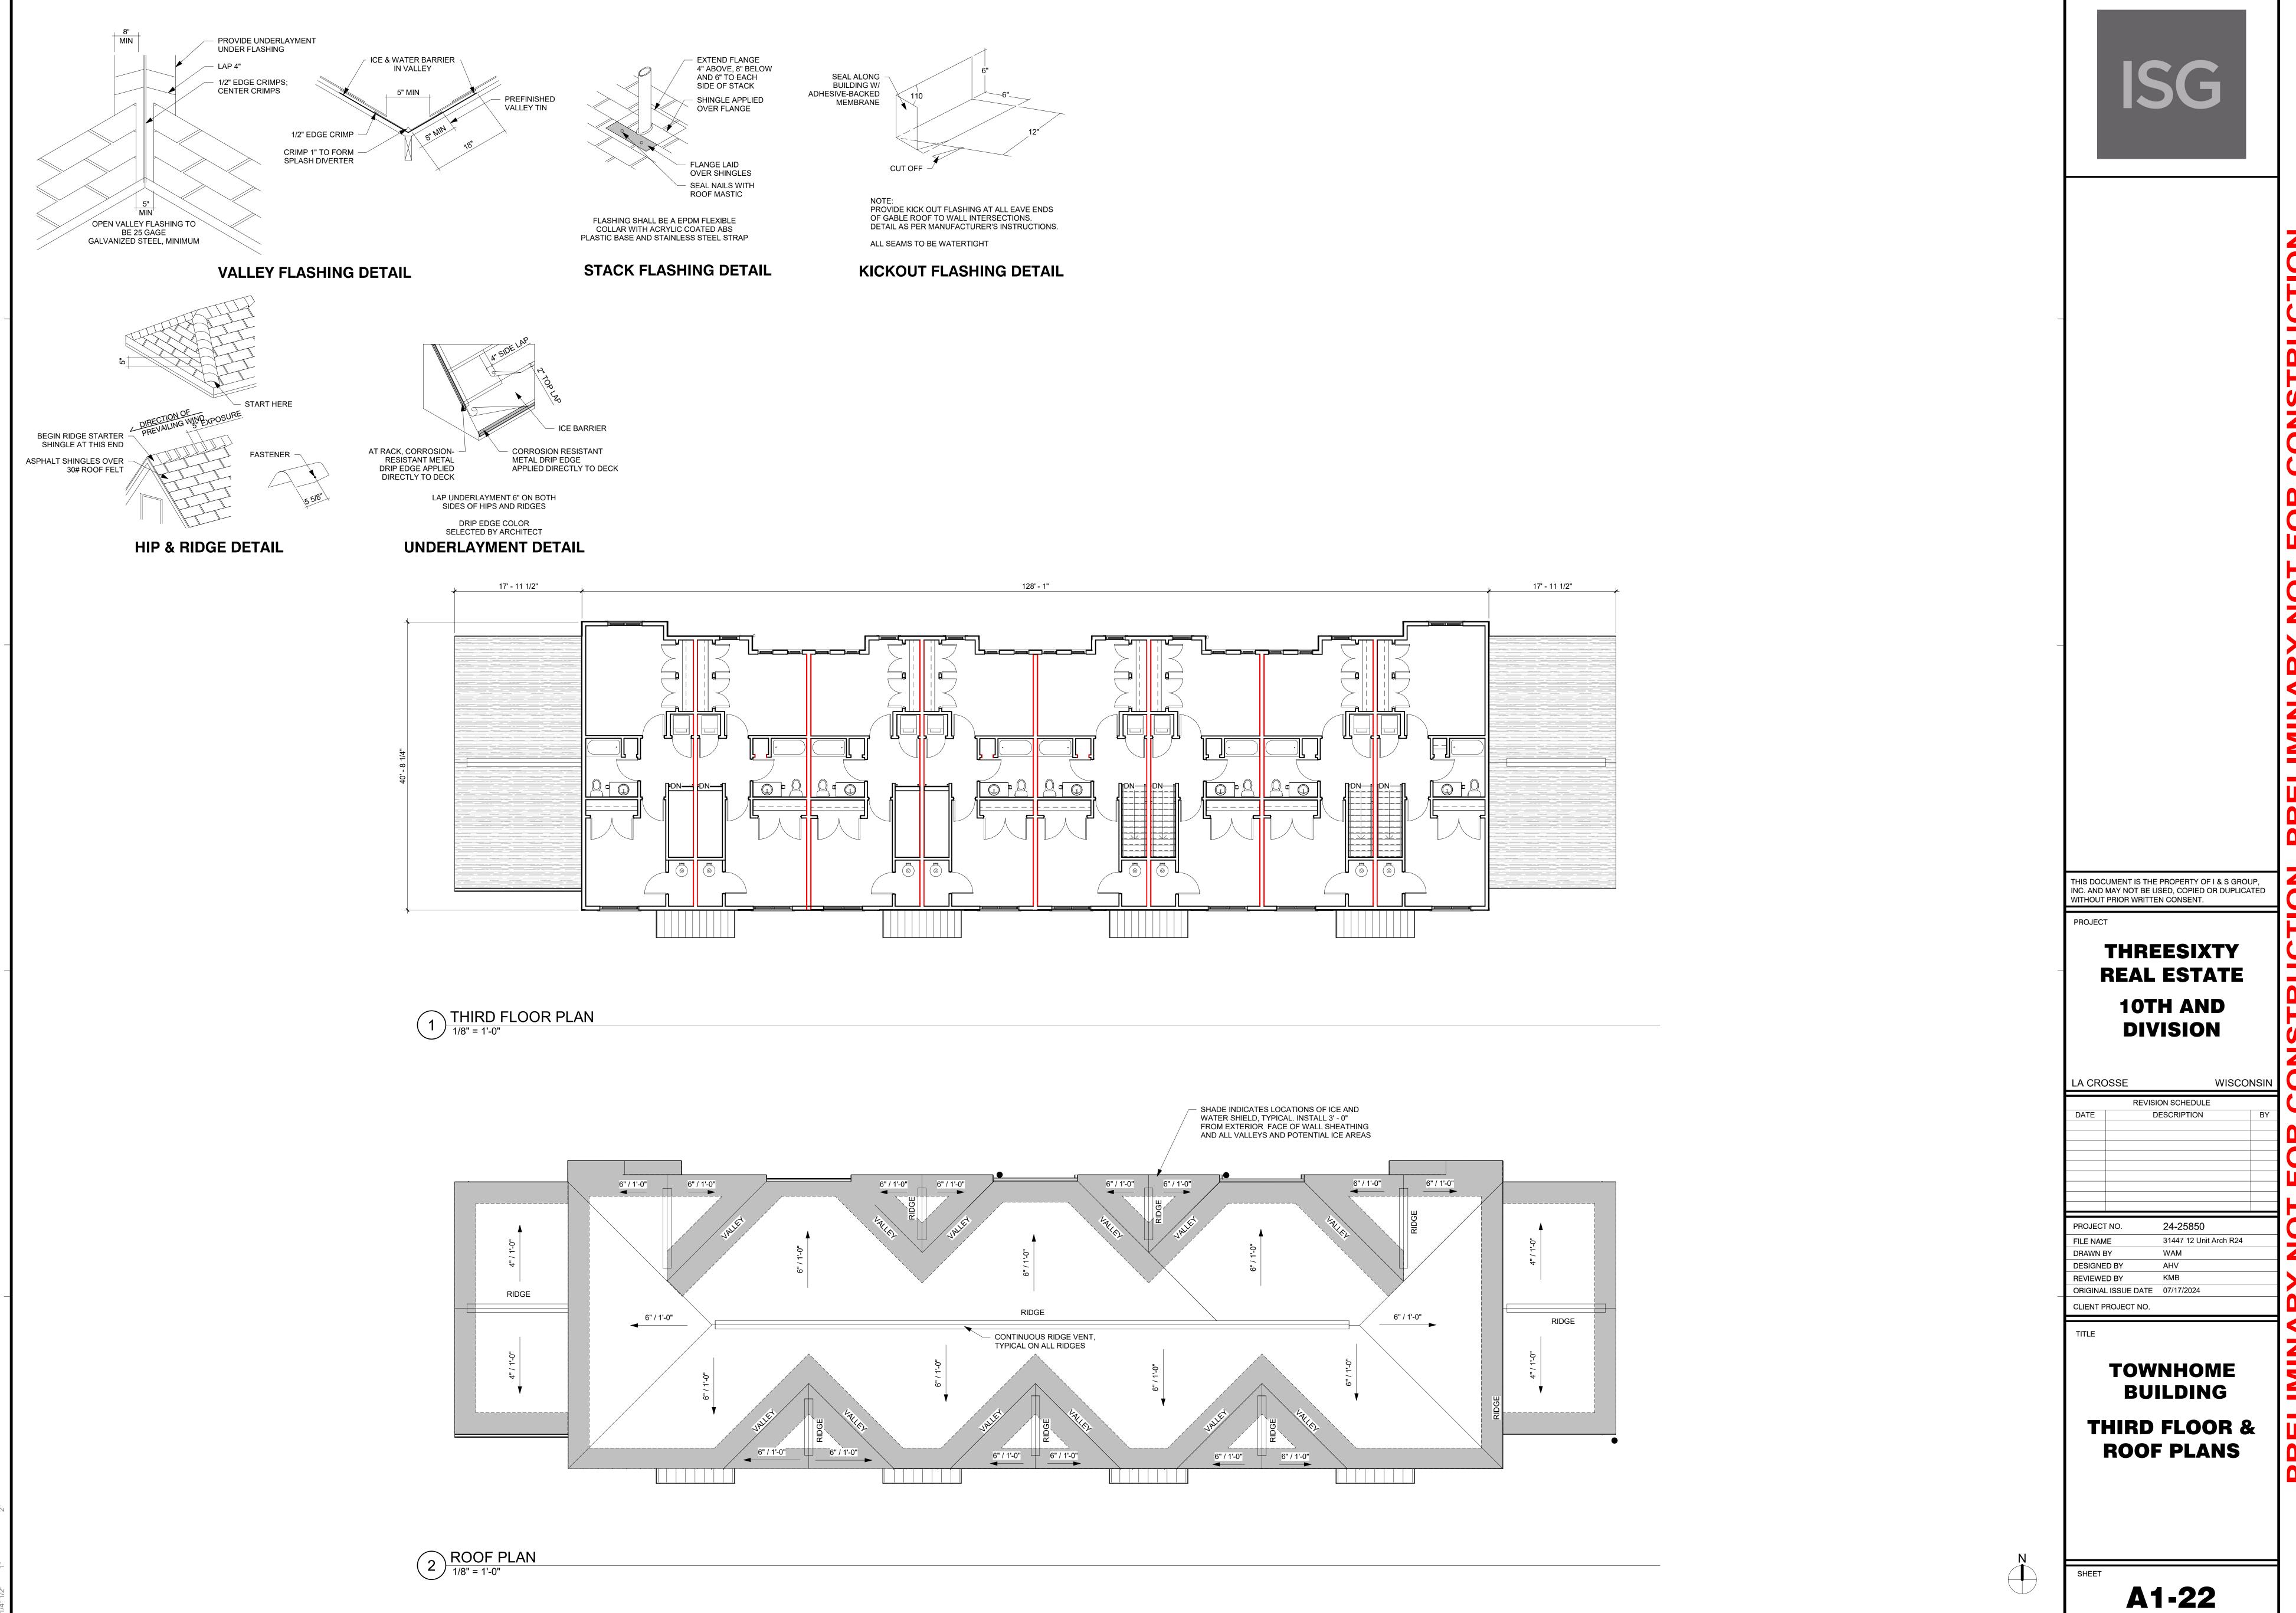
**THREESIXTY REAL ESTATE 10TH AND** 

**DIVISION** 

REVISI	ON SCHEDULE			
	ESCRIPTION	BY		
PROJECT NO.	24-25850			
FILE NAME	31447 12 Unit Arch R24			
DRAWN BY	WAM			
DESIGNED BY	AHV			
REVIEWED BY	KMB			
ORIGINAL ISSUE DATE	07/17/2024			
CLIENT PROJECT NO.				

**TOWNHOME** BUILDING FIRST & SECOND
FLOOR PLANS,
DOOR SCHEDULE,
DOOR, WINDOW AND FRAME **TYPES** 

**A1-21** 



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	SHEET NOTES
1	ADDLV ALL CIDING DED MANUEACTUDEDIC DECOMMENDATIONS
	APPLY ALL SIDING PER MANUFACTURER'S RECOMMENDATIONS.
2.	PROVIDE TREATED WOOD BLOCKING AND/OR VINYL TRIM AS
	NECESSARY AT EXTERIOR LIGHT FIXTURES AND OTHER
	NECESSARY MECHANICAL, ELECTRICAL OR PLUMBING
	PENETRATIONS.
3.	ALL FASCIAS AND SOFFITS TO BE PREFINISHED ALUMINUM.
1	STANDING SEAM METAL DOGE OVED ENTRANCES

4. STANDING SEAM METAL ROOF OVER ENTRANCES.5. PROVIDE CONTINUOUS SOFFIT AND SHINGLE - OVER RIDGE VENTS THROUGHOUT.

THROUGH-WALL FLASHING TO BE LOCATED ABOVE GRADE. 7. SEALANT COLORS TO MATCH ADJACENT FINISHED SURFACES. 8. ATTIC VENTING REQUIREMENTS: A. 22.27 SQ FT OF VENTING PROVIDED AT EAVE. B. 50% OF VENTING PROVIDED AT RIDGE. C. 50% OF TOTAL VENTING PROVIDED.

9. ALL EXTERIOR WINDOW AND DOOR TRIM TO BE EF-9 UNLESS LOCATED WITHIN BRICK VENEER. 10. PROVIDE 2" INSIDE CORNERS AT ALL SIDING LOCATIONS, COLOR TO MATCH ADJACENT SIDING.

MATCH PROJECTED SURFACES.

11. AT WALL PROJECTIONS, RETURN ALL FINISHES, FINISHES TO

	I	_		_		
MARK	MATERIAL TYPE	MANUFACTURER	SERIES	SIZE	COLOR	COMMENTS
EF-1	TEXTURED FIBERGLASS SHINGLES					
EF-2	BOARD & BATTEN SIDING	LP SMARTSIDE			TBD	
EF-3	LAP SIDING	LP SMARTSIDE				
EF-5	PREFINISHED METAL GUARDRAIL					REFER TO STRUCTURAL NOTES FOR RAILING DESIGN LOADS
EF-6	ROOF EDGE FASCIA	ROLLEX		1X8	TBD	
EF-7	TRIM			1X6	TBD	
EF-8	TEXTURED PLANK	LP SMARTSIDE			TBD	
EF-9	TRIM	LP SMARTSIDE		1X4	TBD	
EF-14	ALUMINUM SOFFIT	ROLLEX	FULLY VENTED SOFFIT AT EAVES, SOLID SOFFIT AT RAKES	16"	TBD	CLEAR AREA : 12.96 SQ IN PER LINEAL FOOT
EF-15	SNOW BAR	-	-	-	-	
EF-16	ACCENT BRACKET				TBD	
EF-18	RIDGE VENT	COR-A-VENT	V-600 RIDGE VENT			CLEAR AREA : 20 SQ IN PER LINEA FOOT
EF-19	ROOF VENT	COR-A-VENT	ROOF-2-WALL VENT			




	2'-0"  EF-16  EF-16  EF-6  EF-6
ROOF BEARING	EF-6 TIYP  FF-2 FF-2 FF-2 FF-2 FF-2 FF-2 FF-2 FF-
THIRD FLOOR	
SECOND FLOOR 109' - 2 1/2"	
ENTRY 102' - 11" FIRST FLOOR	

## **NORTH ELEVATION**

1/8" = 1'-0" TOTAL FACADE AREA = 4,115 SF TOTAL FENESTATION PROVIDED = 1150 SF



**SOUTH ELEVATION** 1/8" = 1'-0"

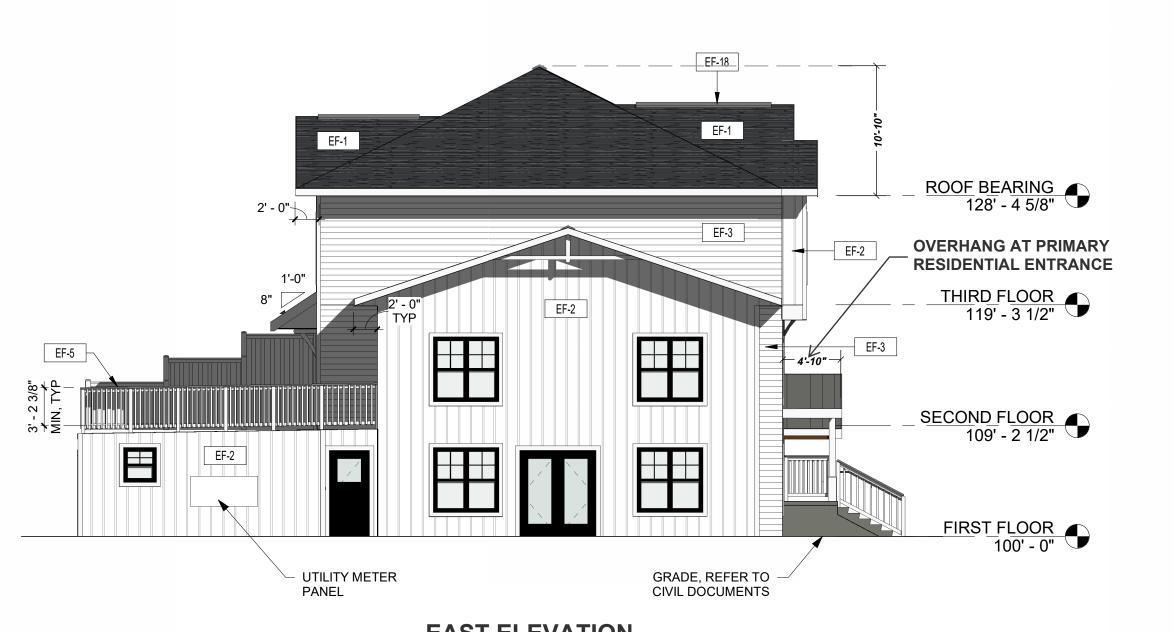

**EAST ELEVATION** 1/8" = 1'-0" TOTAL FACADE AREA = 830 SF TOTAL FENESTATION REQUIRED = 830(.2) = 166 SF TOTAL FENESTATION PROVIDED = 258 SF



**WEST ELEVATION** 1/8" = 1'-0"

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**THREESIXTY REAL ESTATE** 

> **10TH AND DIVISION**

	LA CRO	OSSE	WISCONSIN				
		RE	EVISION SCHEDULE				
	DATE		DE	SCRIPTION		BY	
	PROJECT	ΓNO.		24-25850			
	FILE NAM	1E		31447 12 Unit	Arch R24		
	DRAWN E	3Y		WAM			
	DESIGNE	D BY		AHV			
	REVIEWE	D BY		KMB			
_	ORIGINA	L ISSUE DA	ATE	07/17/2024			
	CLIENT P	ROJECT N	Ο.				
	TITLE						


**TOWNHOME** 

**EXTERIOR ELEVATIONS** 

**BUILDING** 


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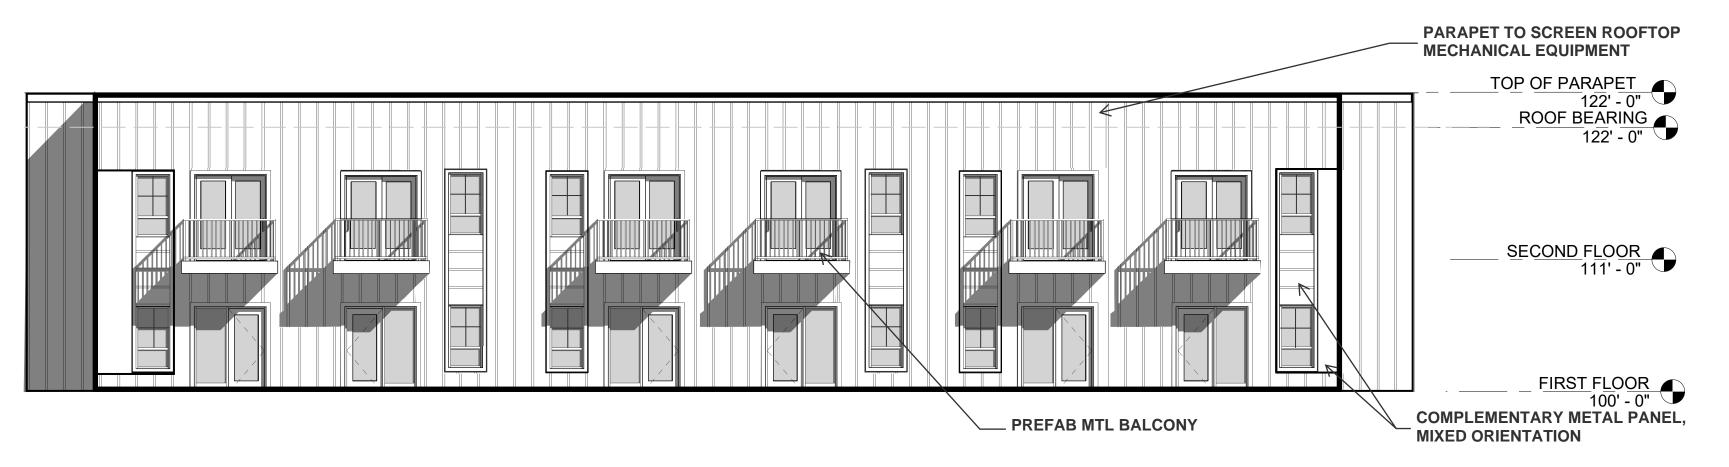
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SECOND FLOOR PLAN

1/8" = 1'-0"

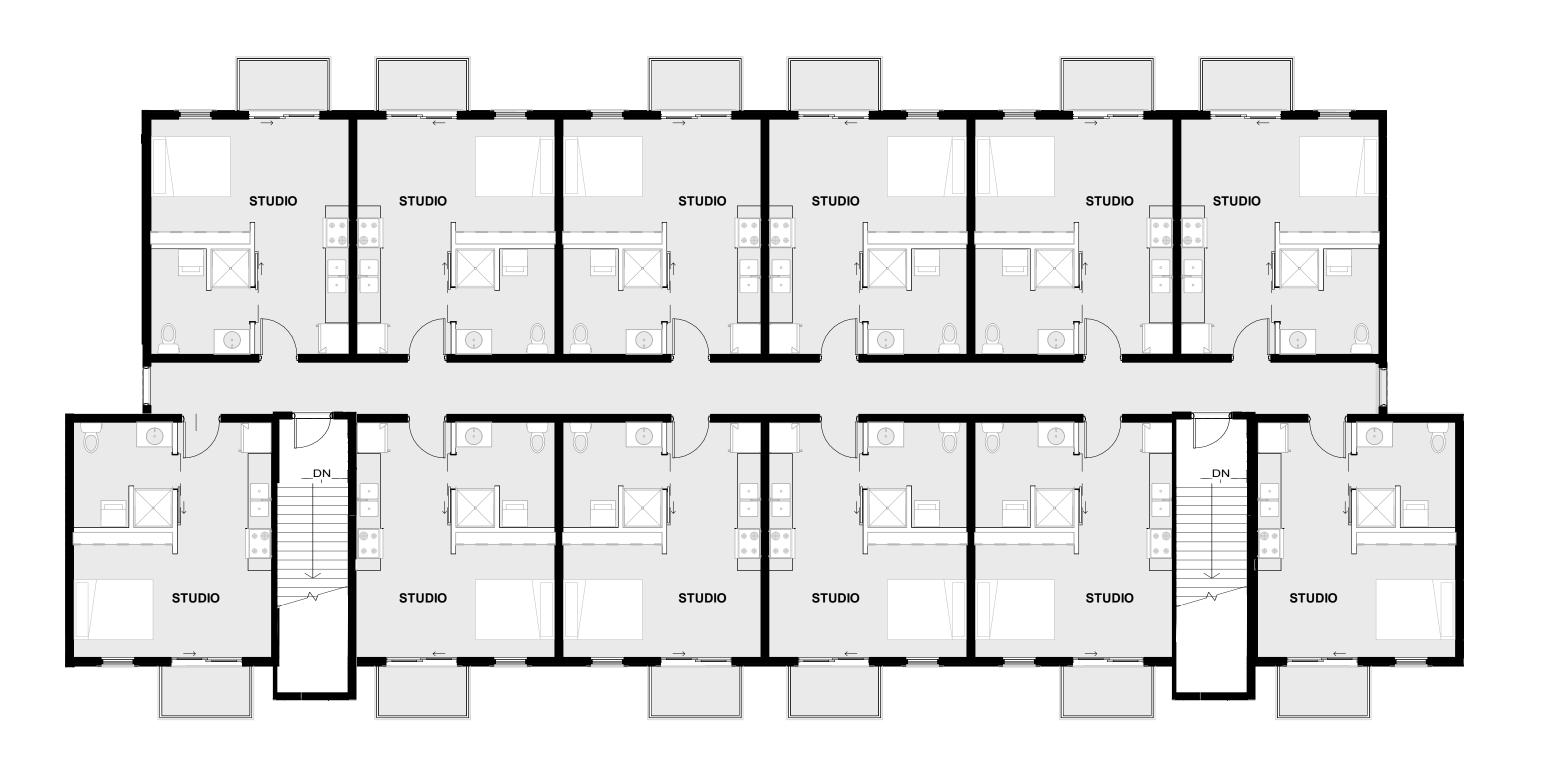




## **EAST ELEVATION**

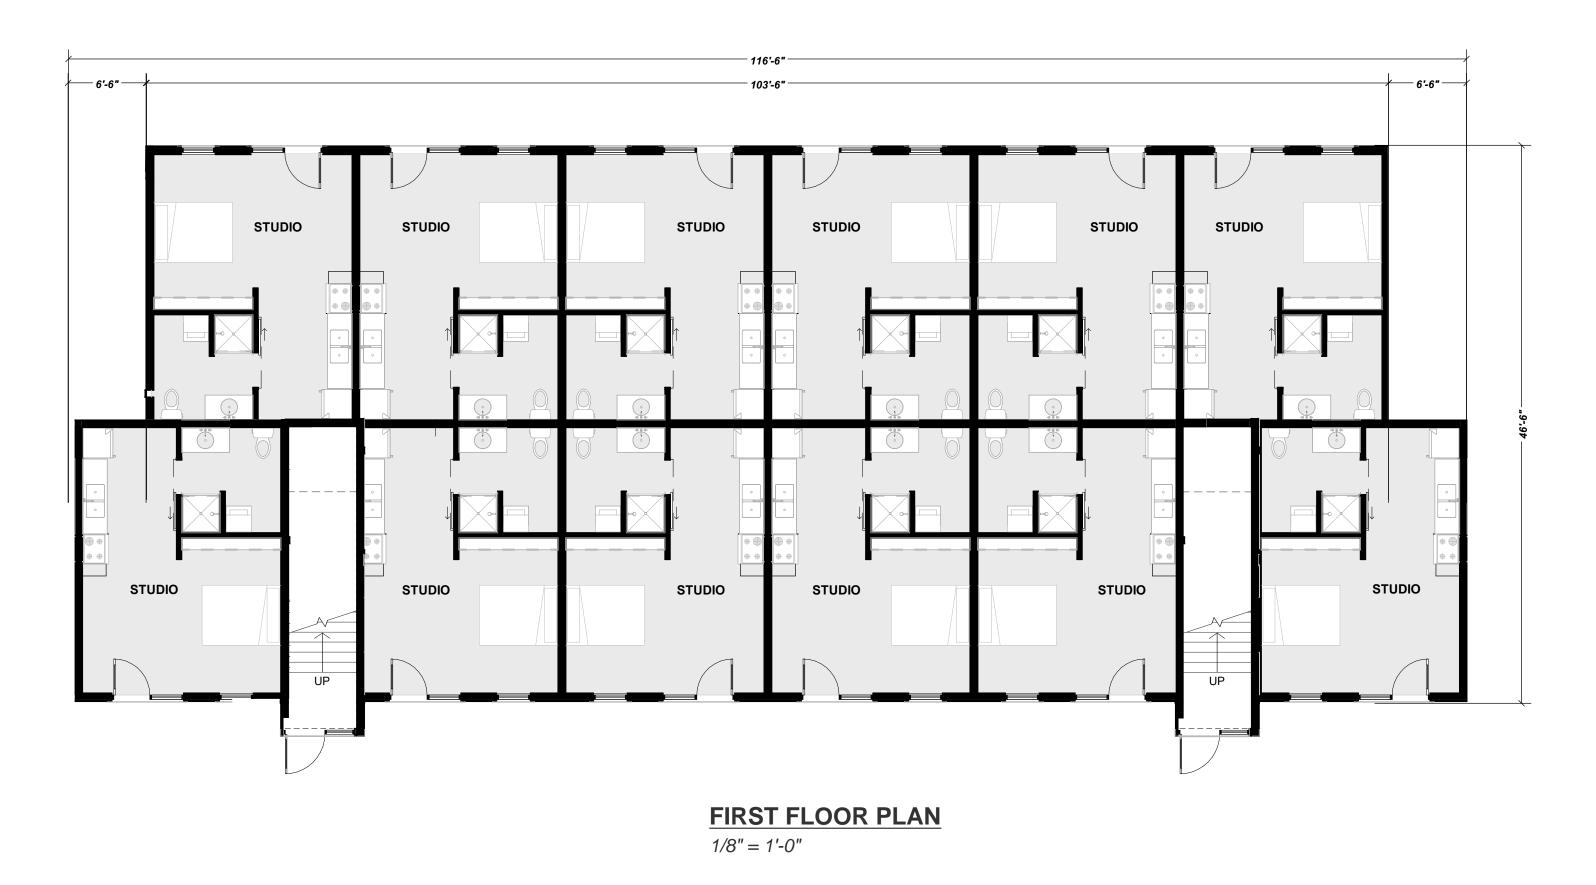1/8" = 1'-0"

TOTAL ELEVATION AREA = 2,550 SF TOTAL FENESTATION REQUIRED = 2,550(.2) = 510 SF TOTAL FENESTATION PROVIDED = 840 SF

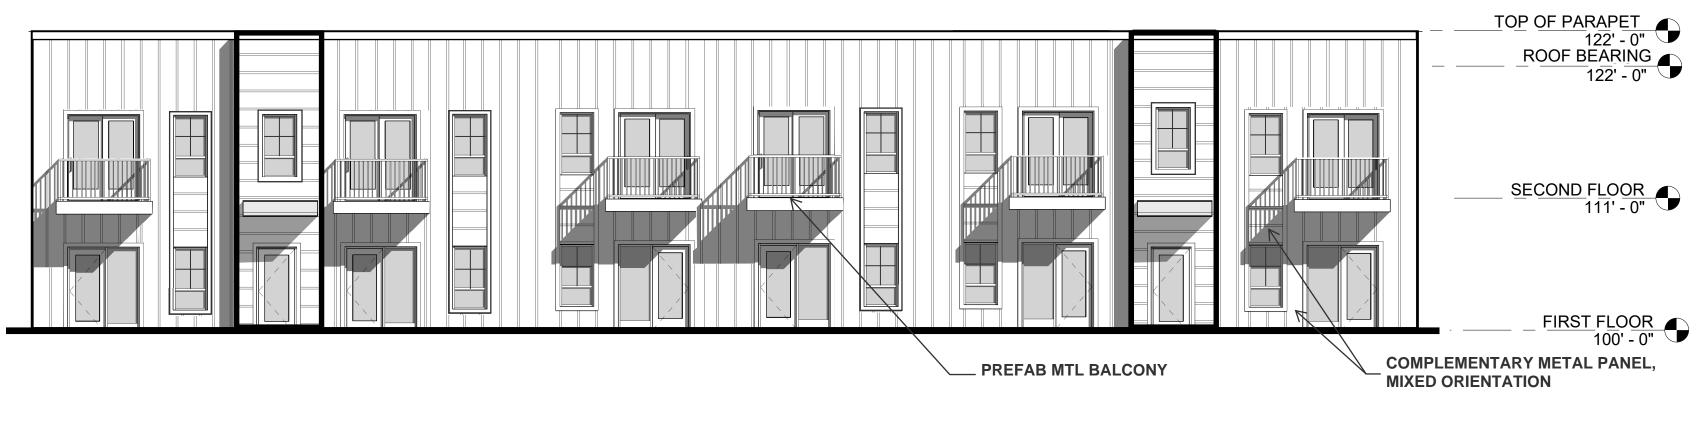

**WEST ELEVATION**1/8" = 1'-0"





## **SOUTH ELEVATION**

1/8" = 1'-0"

TOTAL ELEVATION AREA = 1,130 SF TOTAL FENESTATION REQUIRED = 1,130(.2) = 226 SF TOTAL FENESTATION PROVIDED = 240 SF





PRECEDENT IMAGERY





UNIT MIX					
<u>APARTMENTS</u>	STUDIO	<u>TOTAL</u>			
1ST FLOOR	12	12			
2ND FLOOR	12	12			
TOTAL	24	24			
PERCENTAGE	100%	100%			

## OTUBIO BUIL BING EL GOD BUANO EVTEBIOD EL EVATIONO

