



1 VIEW FROM SOUTH-EAST



3D VIEWS

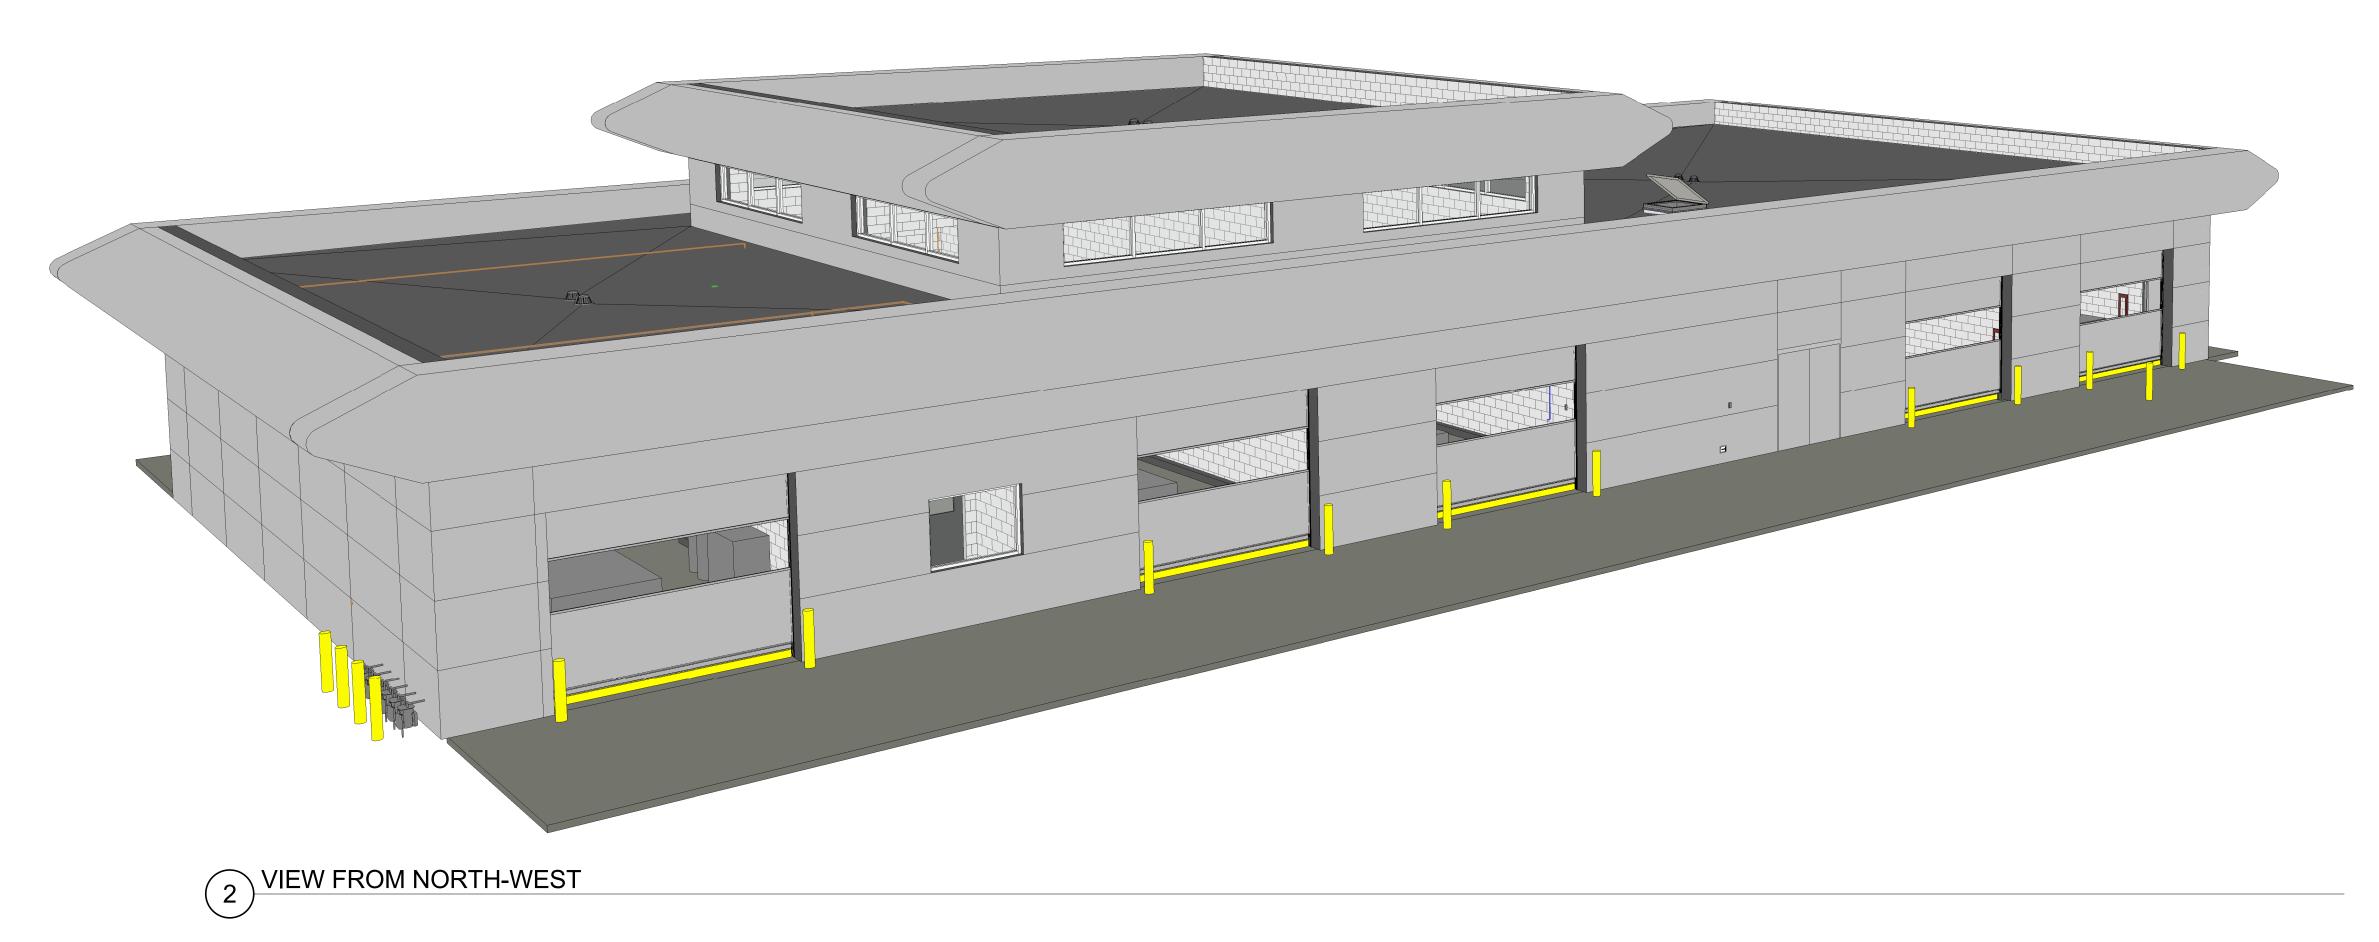


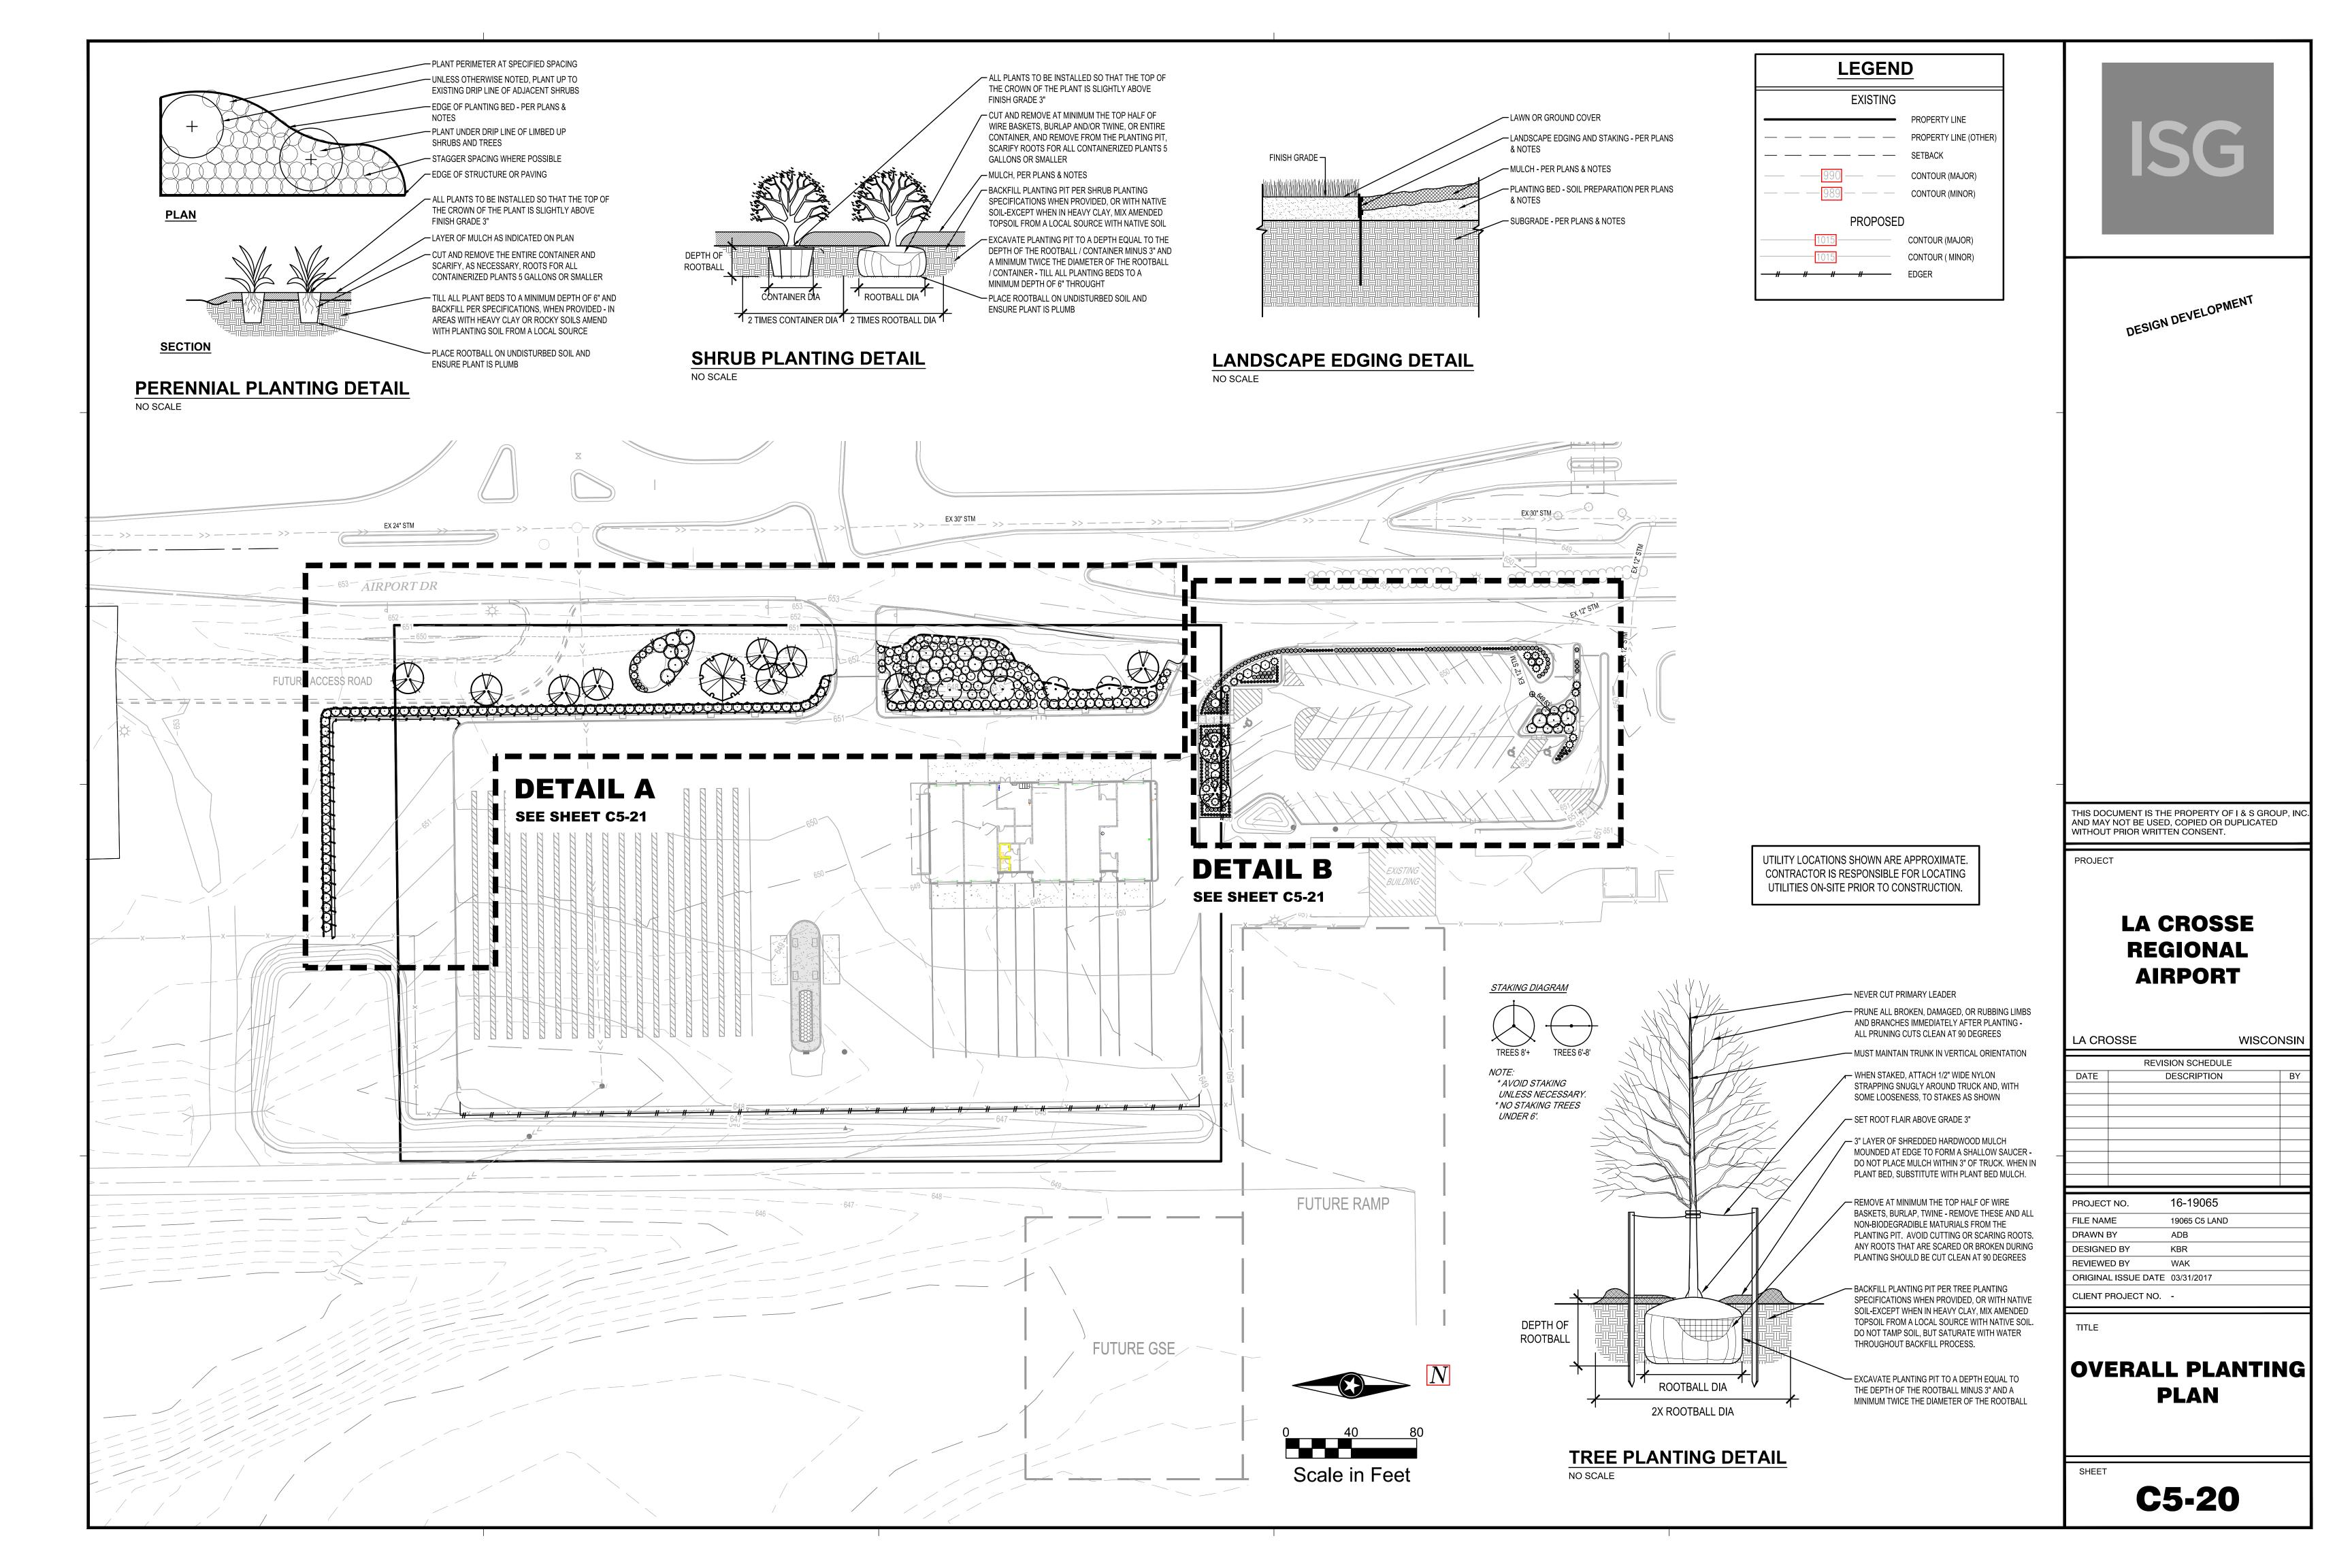

INTERIOR PARTITION KEY NOTES:


NOT ALL KEY NOTES APPLY TO PROJECT. VERIFY WITH SPECIFIC WALL TYPE.

- 1. INCLUDE FIBERGLASS SOUND INSULATION.
- 2. PROVIDE FIRE-RATED SEALANT AT WALL BASE, TOP AND AROUND ALL PENETRATIONS.
- 3. REFER TO 2009 IBC TABLE 721.3.2 FOR CALCULATED FIRE-RESISTANCE RATING.
- 4. SPECIAL 8" BLOCK WITH 1.75" MIN. FACE SHELL THICKNESS.
- REFER TO MANUFACTURER'S SPECIFICATIONS FOR STANDARD CONNECTION DETAILS, SPECIFIC R-VALUE AND ADDITIONAL INFORMATION.
- 6. REFER TO SPECIFICATIONS FOR SPECIFIC WALL PANEL FACE FINISH AND PROFILE.
- 7. INCLUDE ACOUSTIC SEALANT AT WALL BASE AND TOP TERMINATION, BOTH SIDES OF WALL.

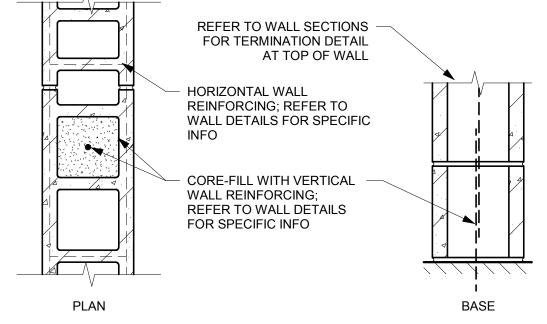

	WALL TYPE	BLOCK SIZE (NOMINAL WIDTH AND HEIGHT)	CALCULATED FIRE RATING	REINFORCING	COMMENTS
Ī	(M4)	4x8		REFER TO WALL DETAILS FOR SPECIFIC INFO	
	(M6)	6x8			
	(M8)	8x8			

2 WALL TYPE M (INTERIOR NON-RATED MASONRY)
1 1/2" = 1'-0"

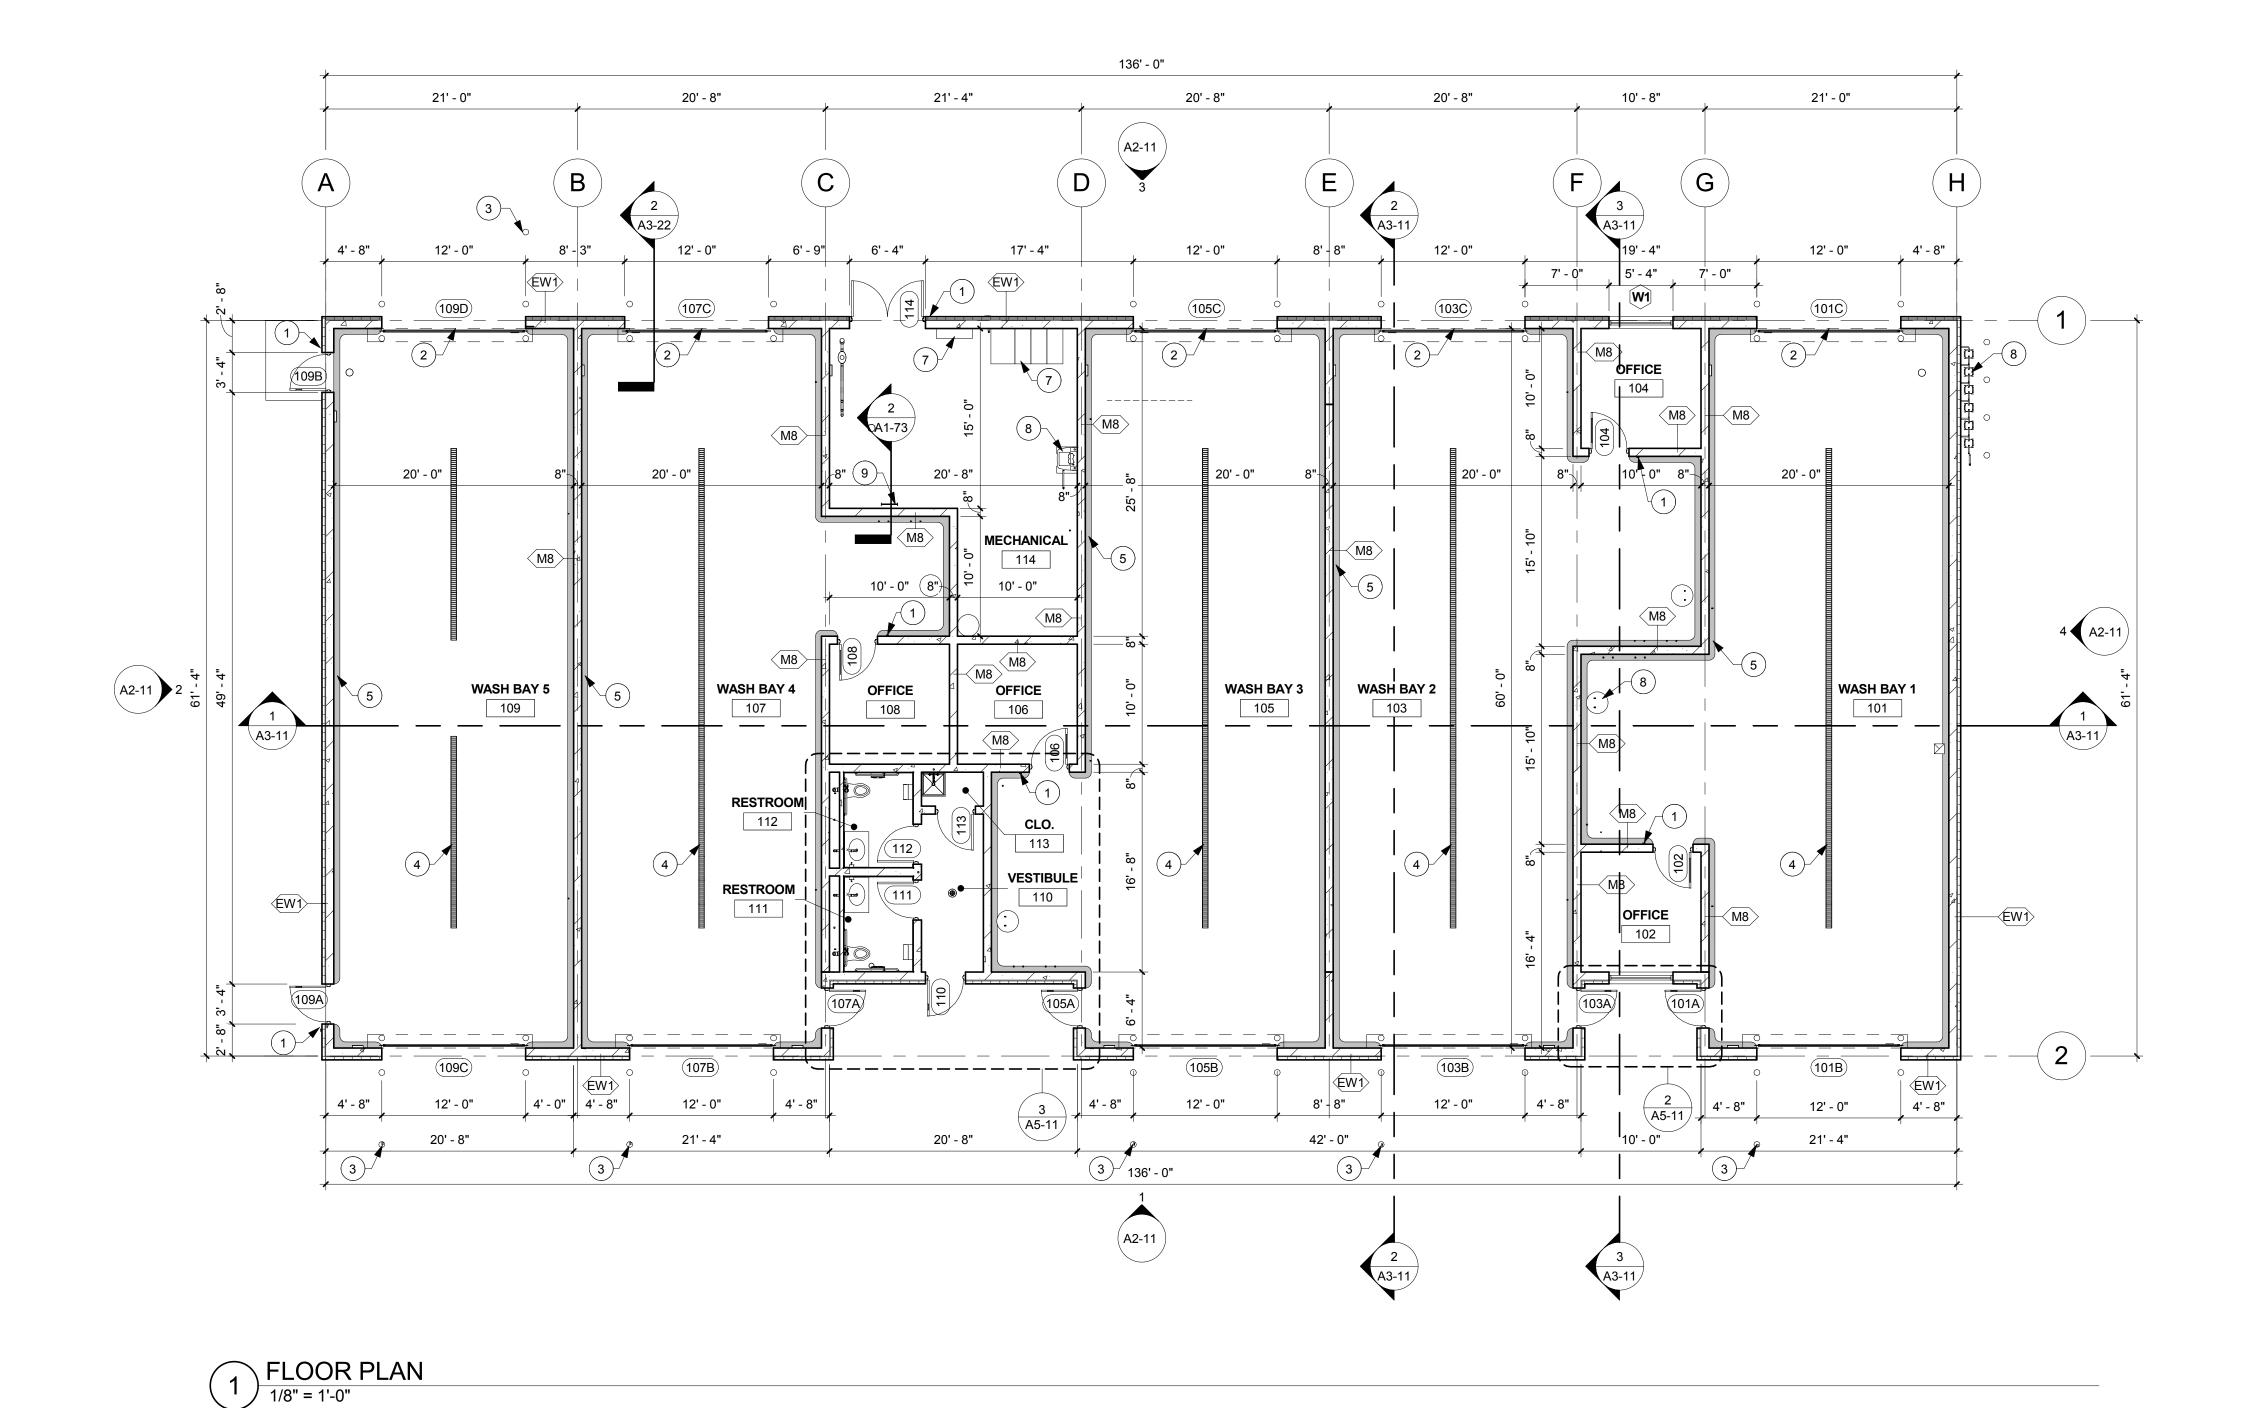

SHEET NOTES

- ALL INTERIOR PARTITION WALLS SHALL BE WALL TYPE M8, UNLESS OTHERWISE NOTED.
- PITCH ALL CONCRETE STOOPS 1/4" PER FOOT AWAY FROM BUILDING.
- DIMENSIONS ARE FROM FACE OF MASONRY/ CONCRETE AND FACE OF GYPSUM BD. TO FACE OF GYPSUM BD. FOR

STUD WALL, UNLESS NOTED OTHERWISE.

- REFER TO G1-21 FOR RATED WALL LOCATIONS. HOUSEKEEPING AND EQUIPMENT PADS BY GENERAL CONTRACTOR. REFER TO FIRE PROTECTION, PLUMBING, HVAC & ELECTRICAL DOCUMENTS FOR LOCATIONS.
- REFER TO STRUCTURAL DOCUMENTS FOR MASONRY WALL BRACING DETAILS. PROVIDE LINTELS AS SHOWN IN STRUCTURAL DRAWINGS ON NON-LOAD BEARING WALL LINTEL SCHEDULE AT ALL
- ALL PIPING, CONDUITS AND RELATED MECHANICAL AND ELECTRICAL ITEMS SHALL BE CONCEALED WITHIN GYPSUM BOARD FURRING AS REQUIRED IN FINISHED AREAS WHETHER SHOWN ON DRAWINGS OR NOT,

NON-BEARING WALL OPENINGS, INCLUDING DUCT

UNLESS NOTED OTHERWISE. PROVIDE BULLNOSE CORNERS AT VERTICAL CORNERS UNLESS OTHERWISE INDICATED. PROVIDE SQUARE EDGE CMU AT VERTICAL CORNERS WHERE CMU IS SCHEDULED TO RECEIVE CERAMIC TILE.

KEYNOTE LEGEND

- 1 KEYLESS ACCESS POINT, REFER TO ELECTRICAL
- DOCUMENTS. 2 CAR ACTIVATED MOTION SENSOR ABOVE OVERHEAD DOOR, REFER TO ELECTRICAL DOCUMENTS.
- 3 KEYLESS ACCESS POINT MOUNTED ON BOLLARD, REFER TO ELECTRICAL DOCUMENTS.
- 4 TRENCH DRAIN SHOWN FOR REFERENCE ONLY, REFER TO MECHANICAL DOCUMENTS.
- 5 ALTERNATE BID CONCRETE CURB AT WASH BAY WALLS 7 ELECTRICAL EQUIPMENT, REFER TO ELECTRICAL
- DOCUMENTS. 8 MECHANICAL EQUIPMENT, REFER TO MECHANICAL DOCUMENTS.
- 9 ROOF ACCESS LADDER.



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LA CROSSE **REGIONAL AIRPORT**

CAR RENTAL FACILITY

LA CROSSE

WISCONSIN

REVISION SCHEDULE					
DATE	DESCRIPTION	BY			


PROJECT NO.	19065
FILE NAME	19065 Arch R-17.rvt
DRAWN BY	RRW
DESIGNED BY	KMB
REVIEWED BY	KMB
ORIGINAL ISSUE DATE	03/31/2017
CLIENT PROJECT NO.	


FLOOR PLAN

 \bigcirc N


A1-21


SHEET NUMBER A1

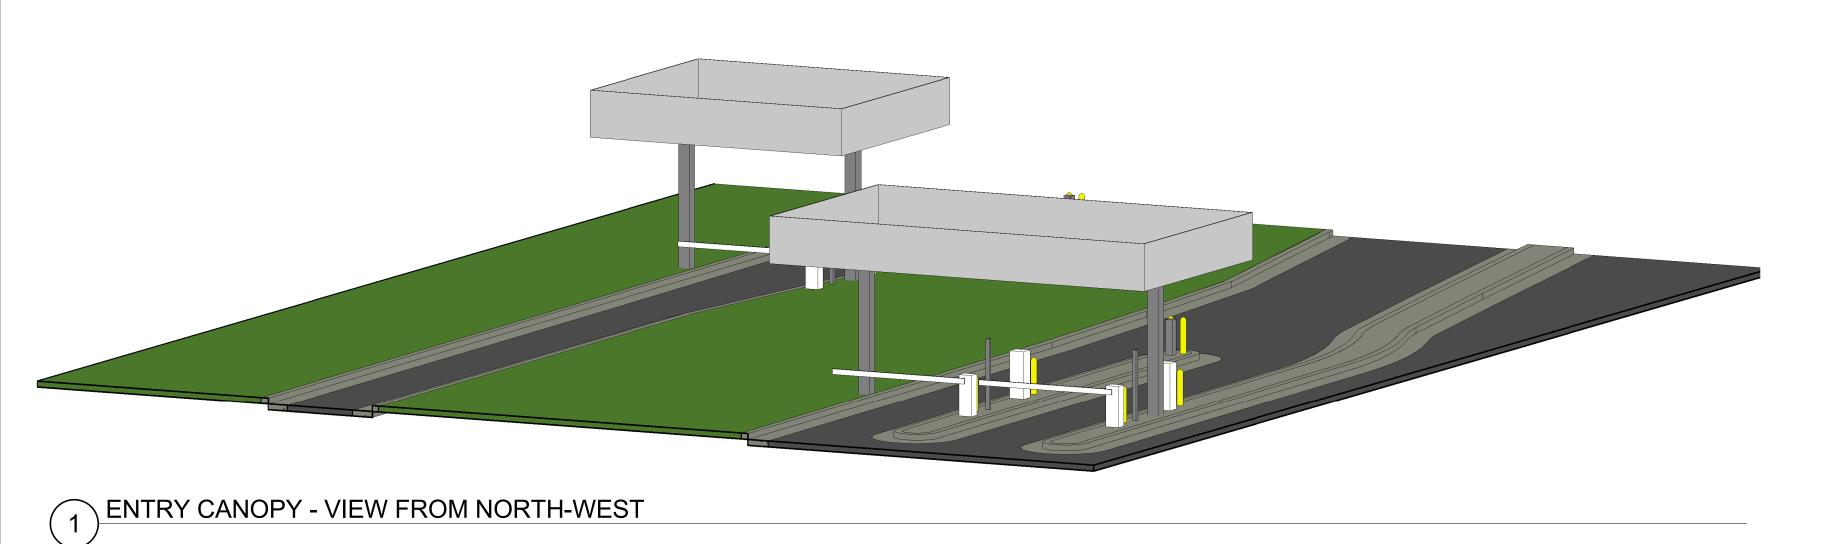

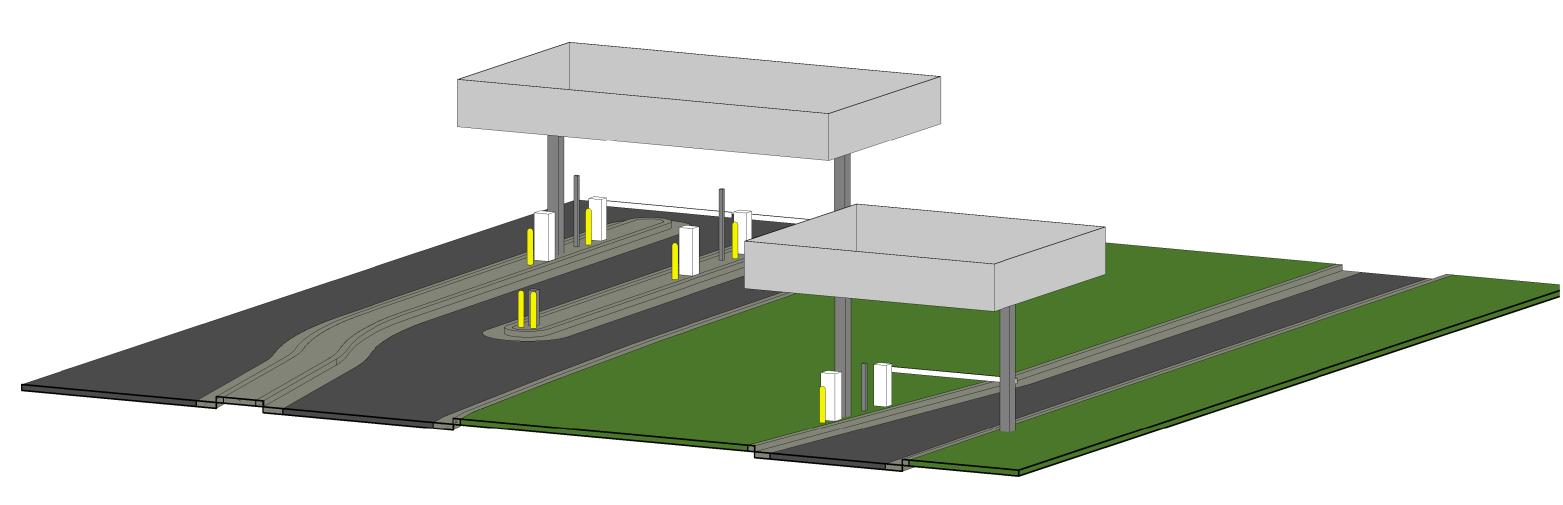


(4) ENTRY CANOPY - VIEW FROM SOUTH-EAST

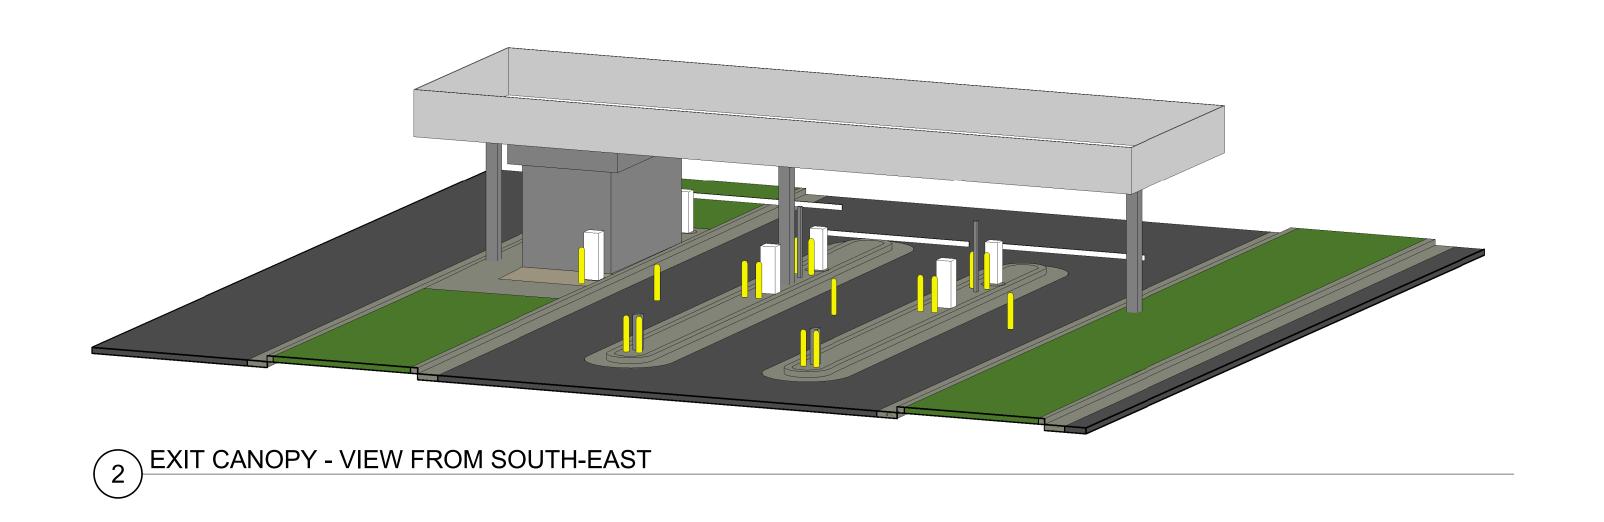


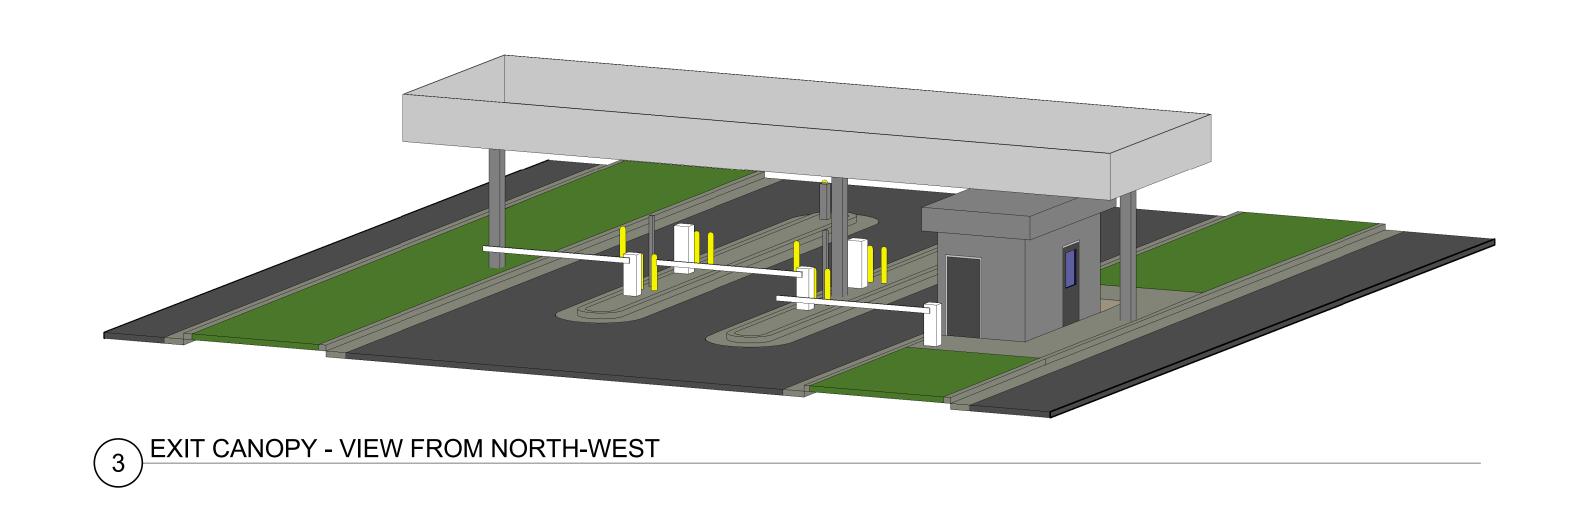

3D VIEWS



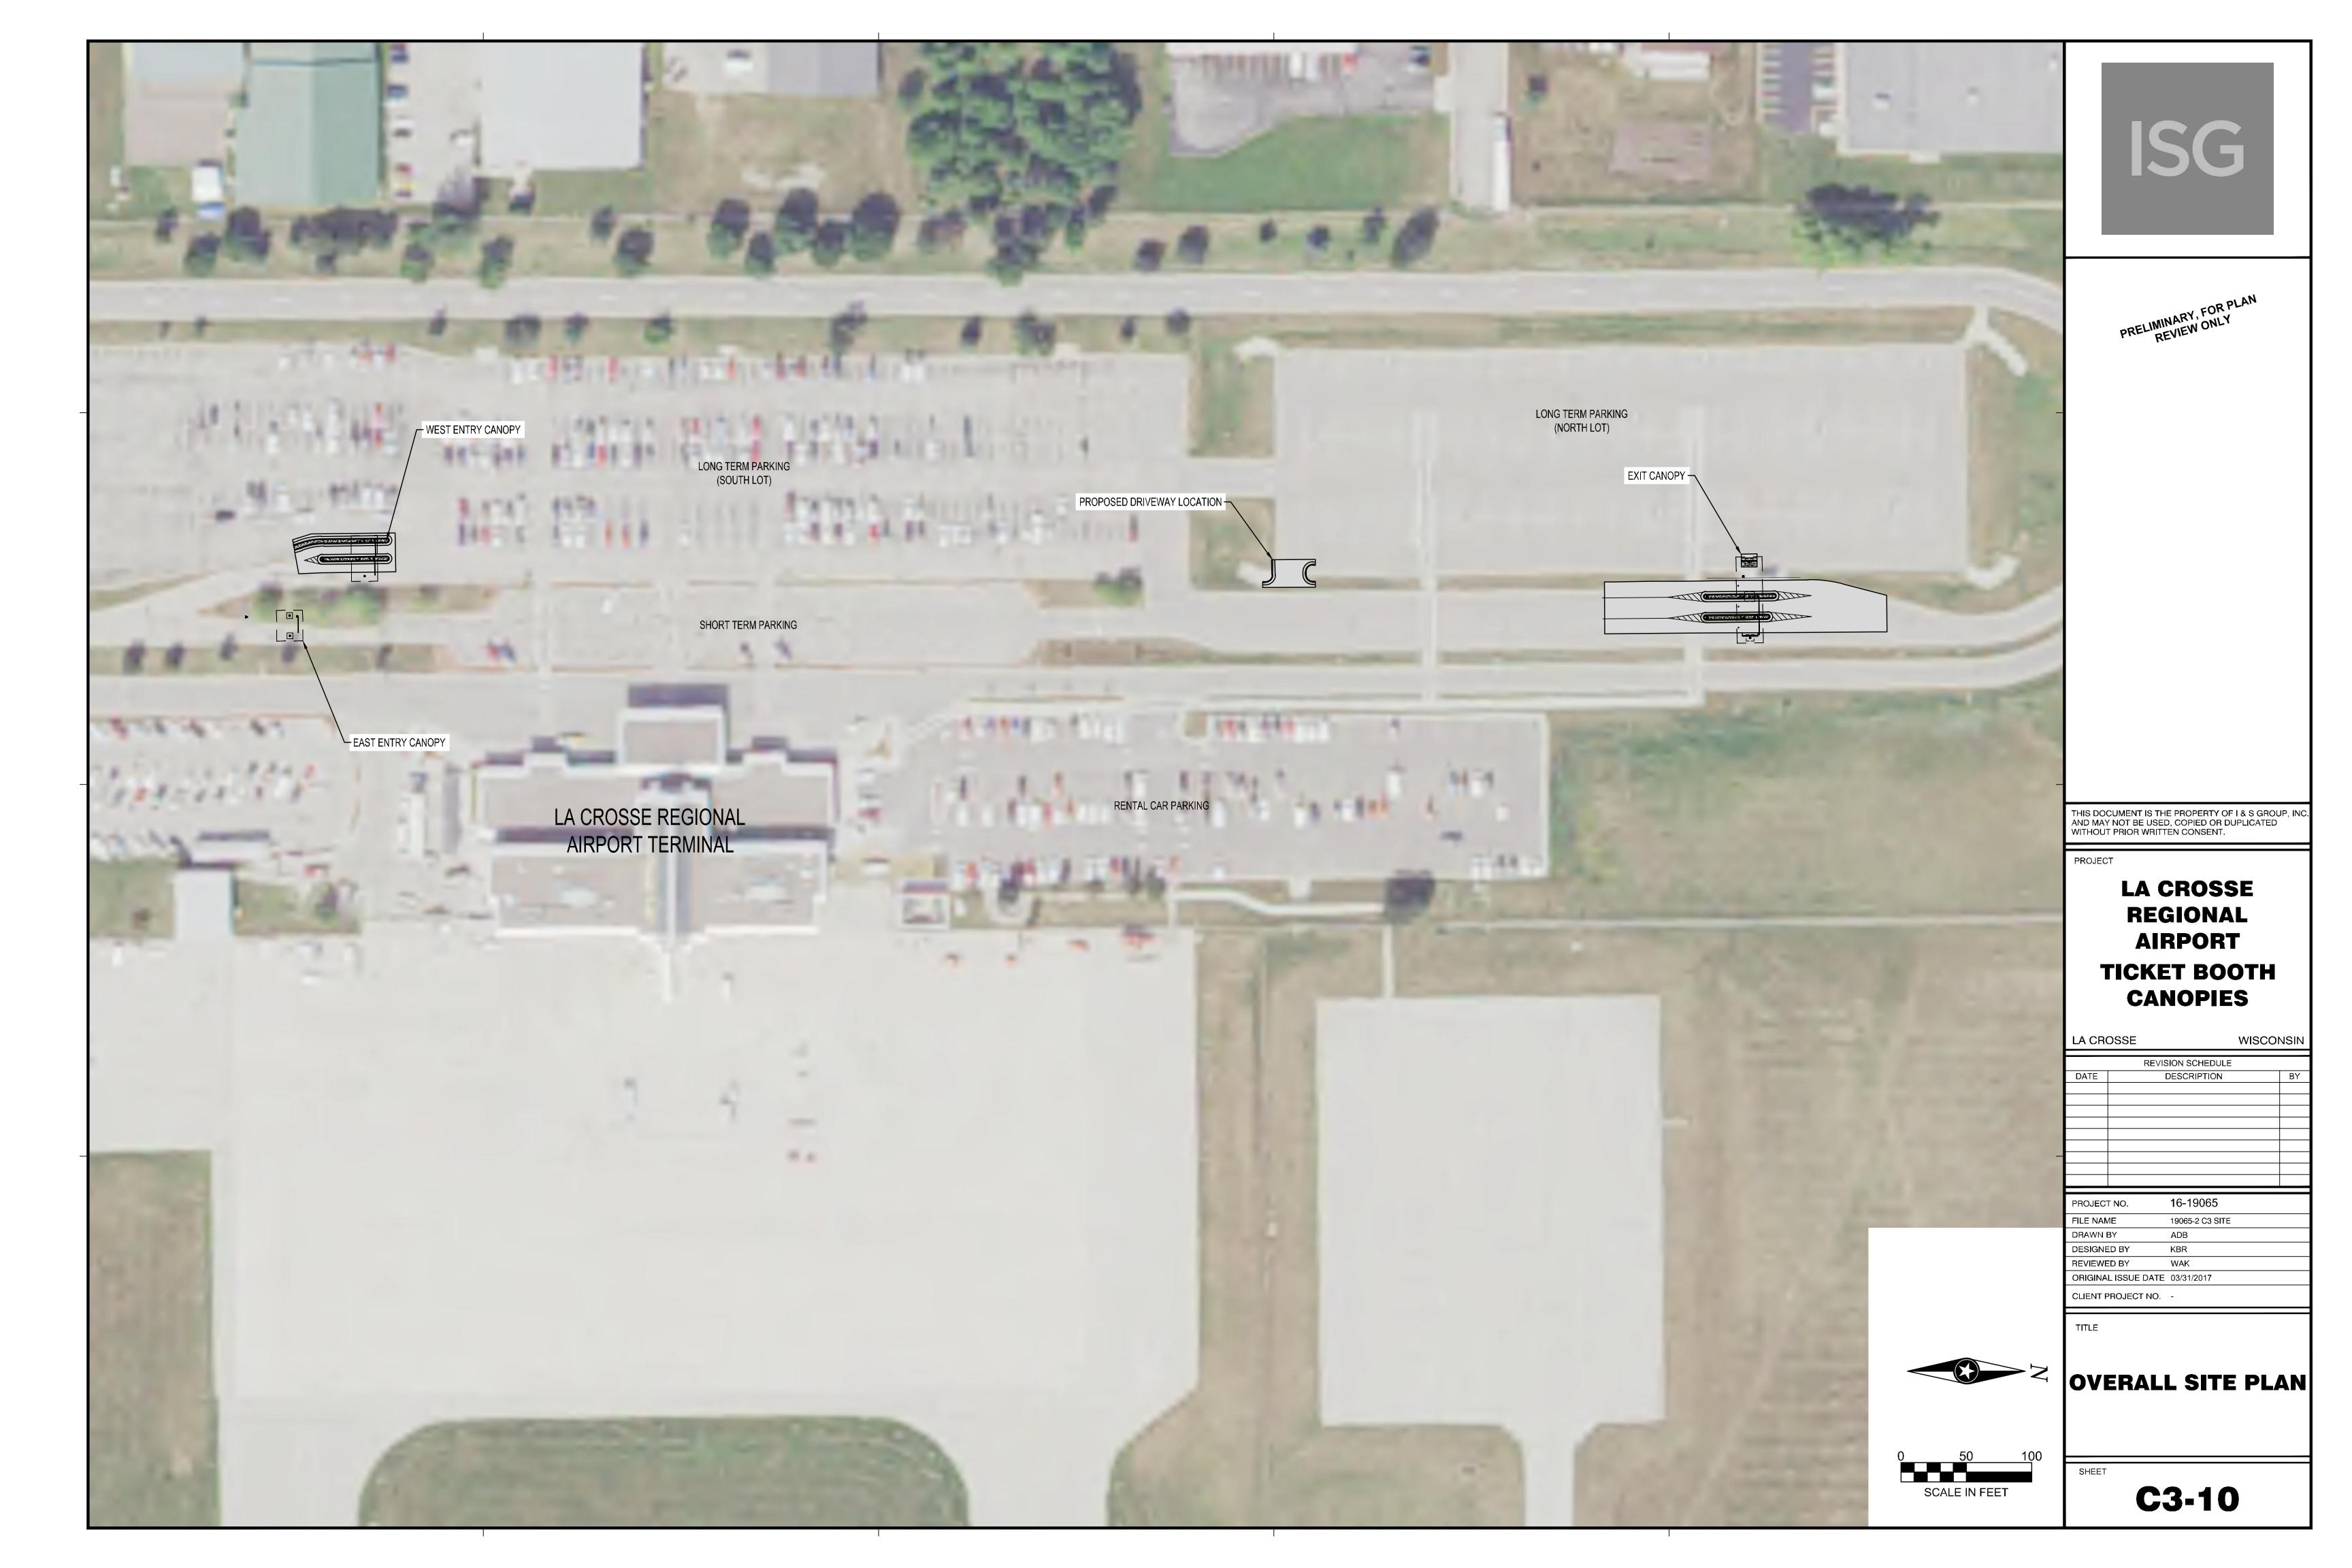

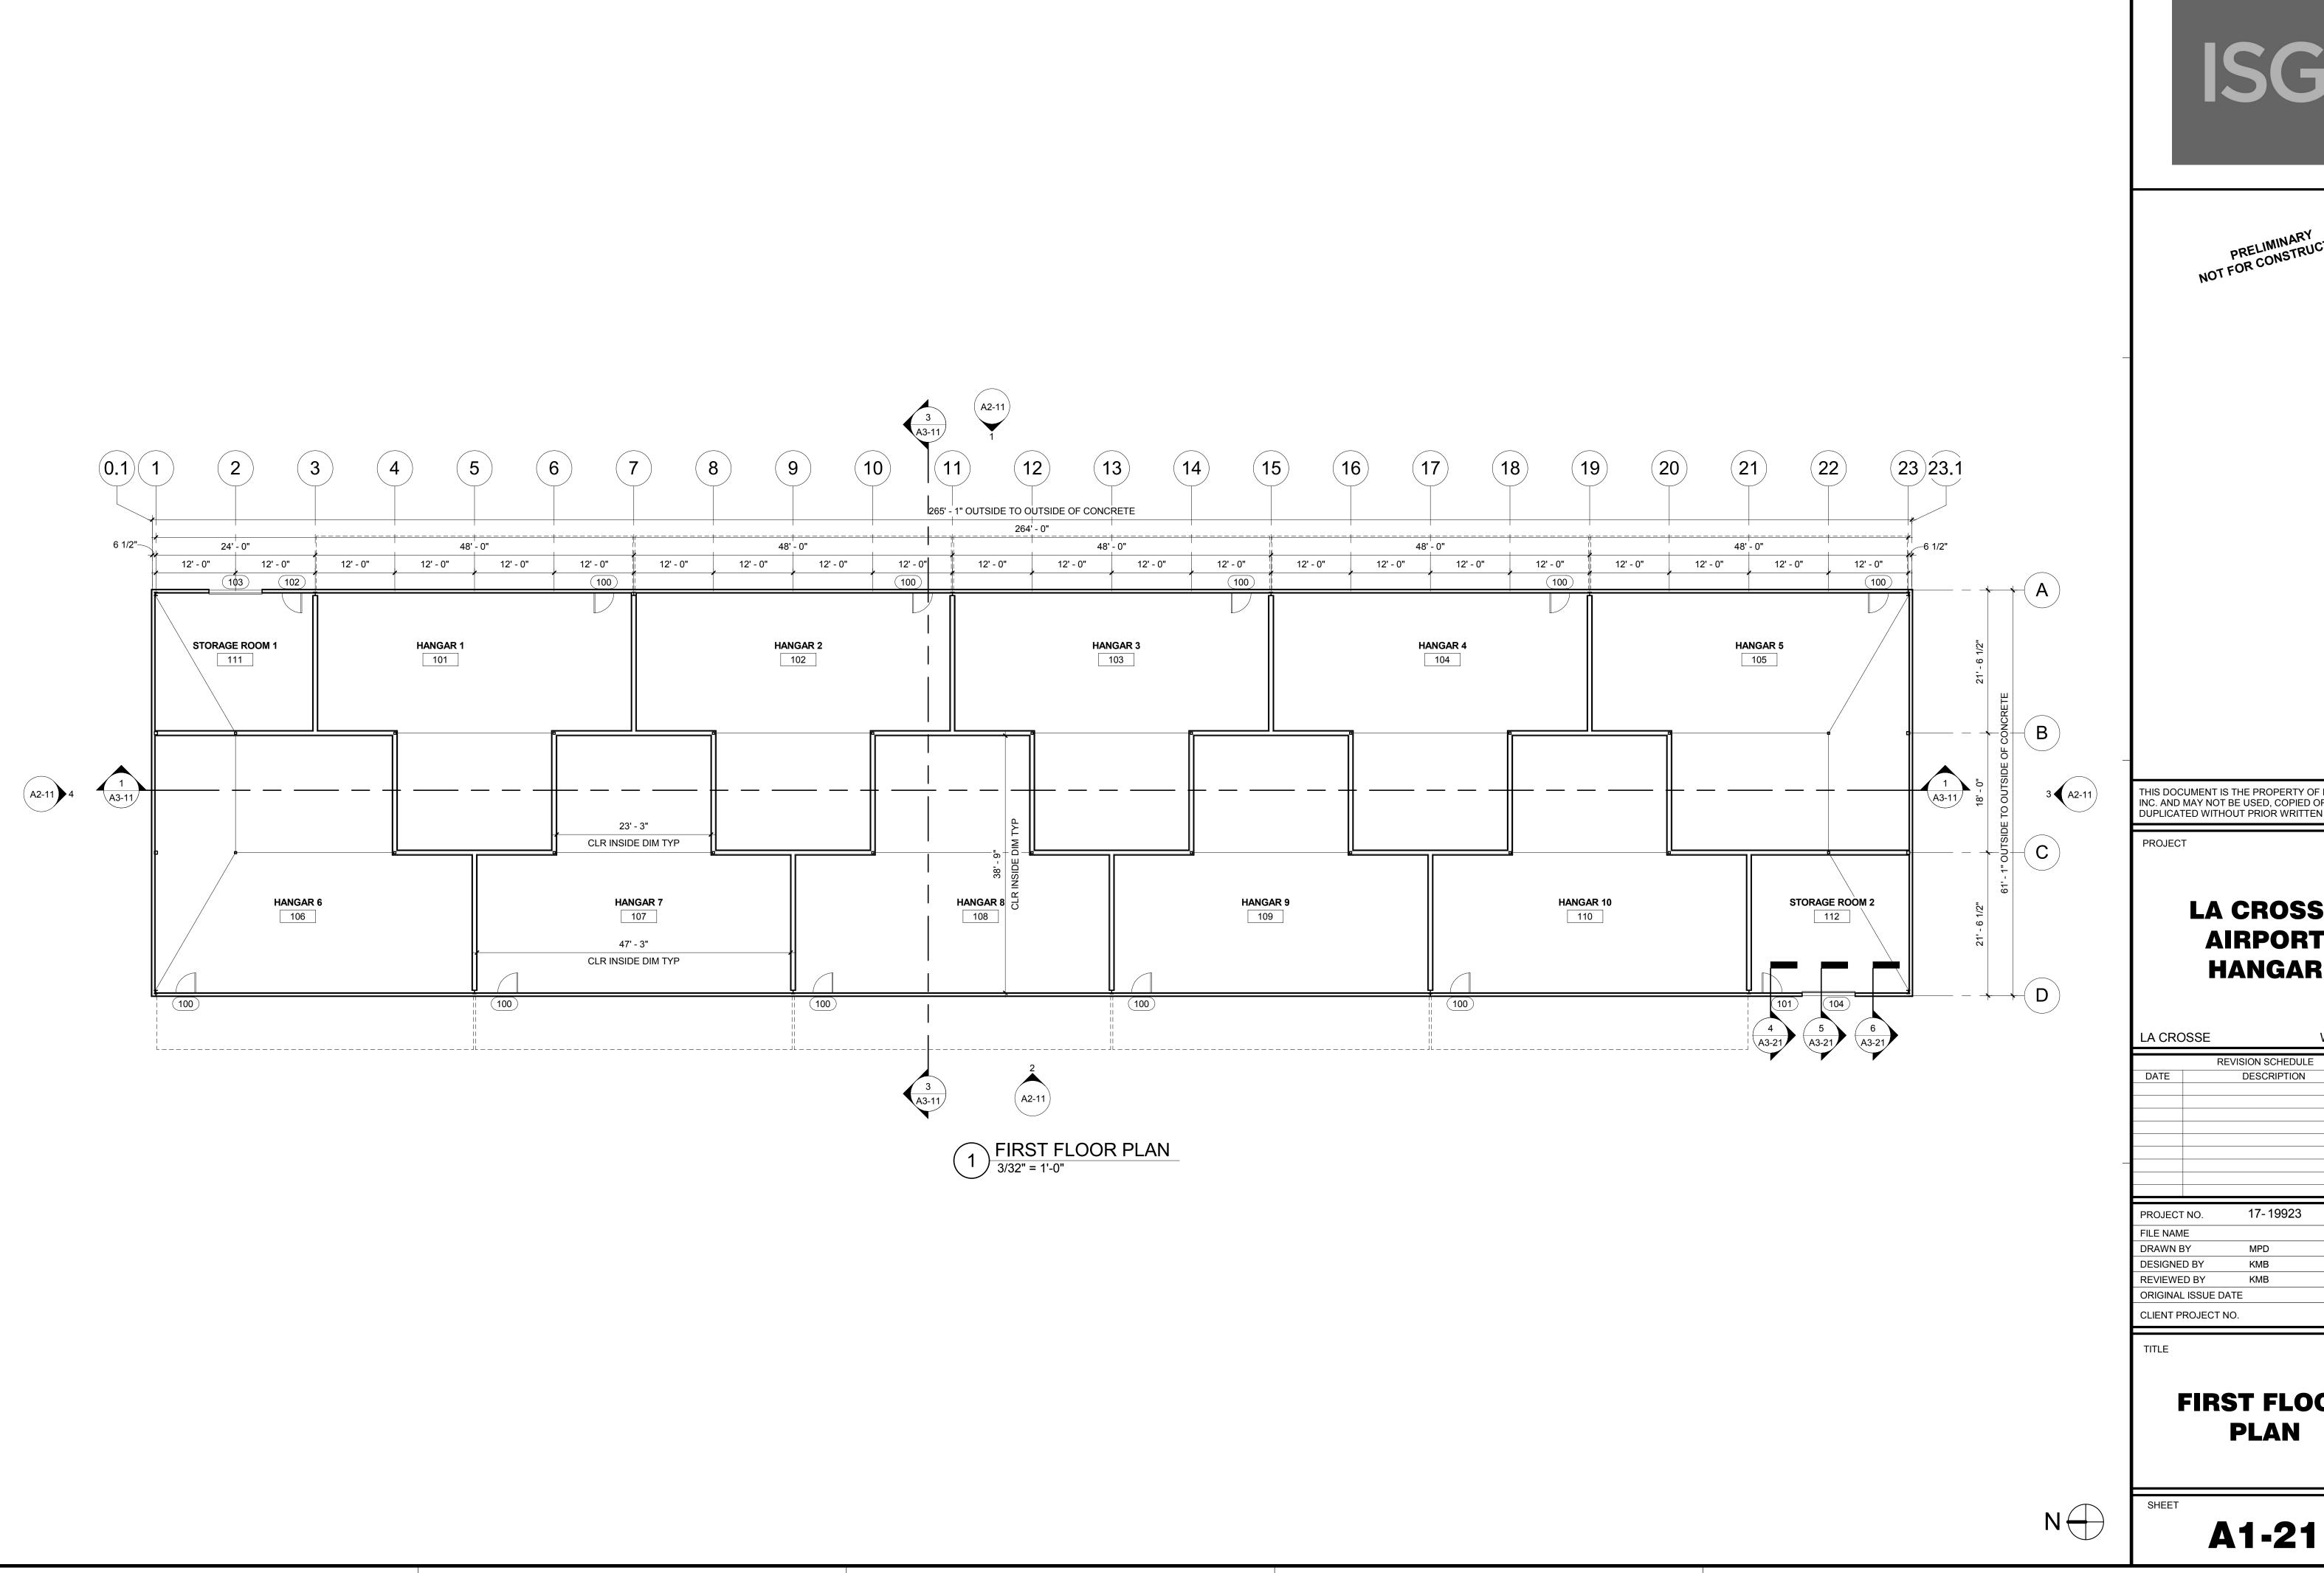

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> LA CROSSE **AIRPORT HANGAR**

WISCONSIN REVISION SCHEDULE DESCRIPTION

FIRST FLOOR


 EXTERIOR FINISH SCHEDULE

 MARK
 MATERIAL
 COLOR
 COMMENTS

 EF-1
 PREFINISHED METAL PANEL
 WHITE

ISG


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1 EAST ELEVATION
3/32" = 1'-0"

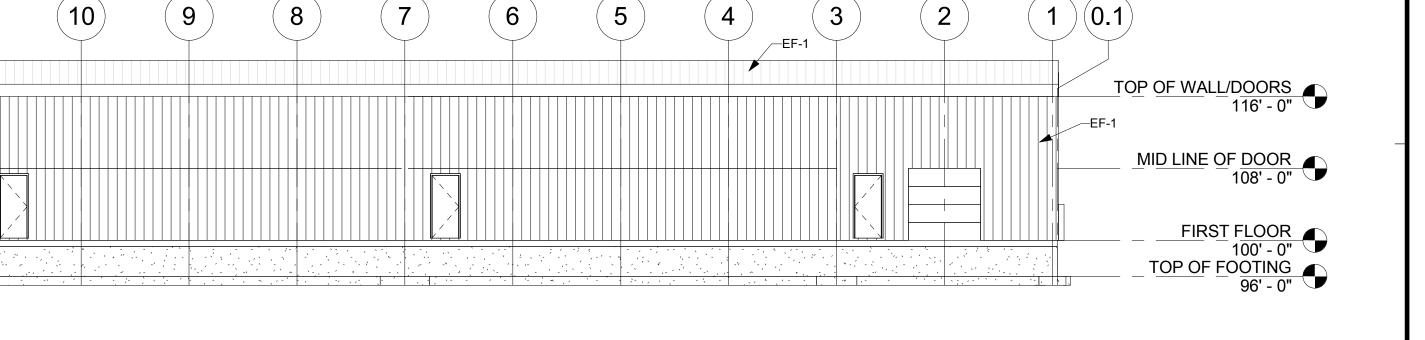(12)

(11)



2 WEST ELEVATION
3/32" = 1'-0"
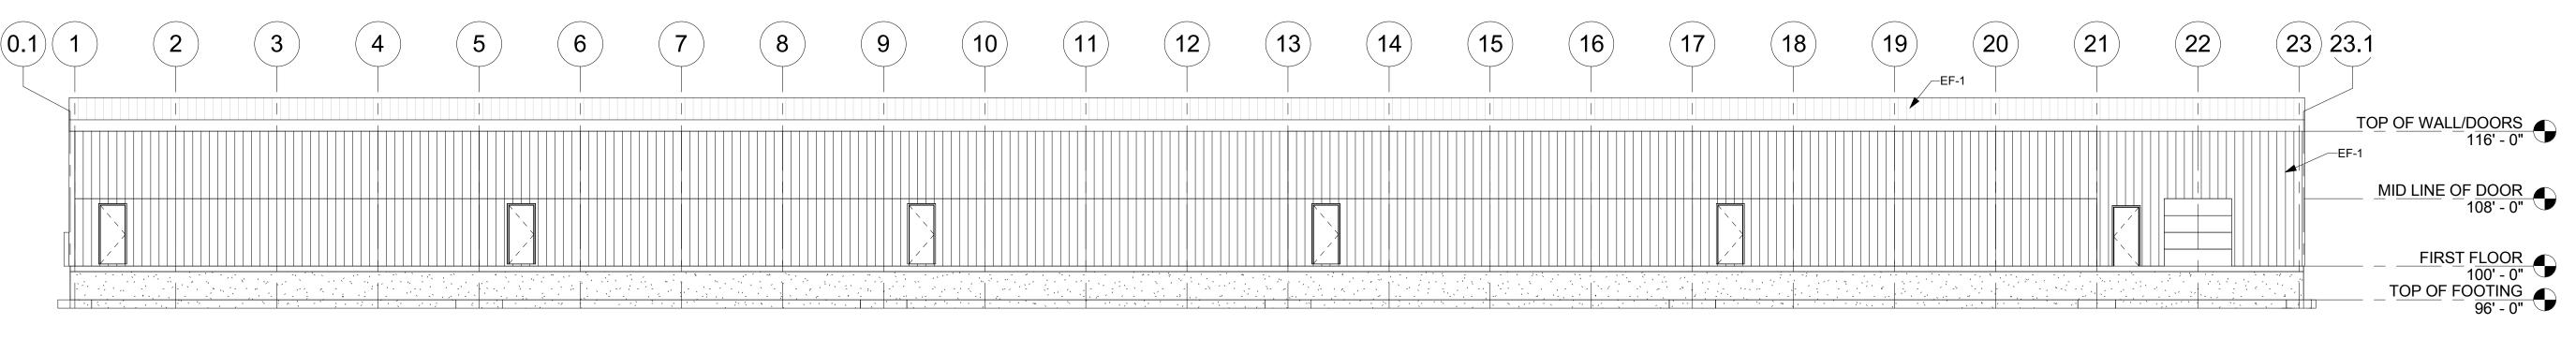
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PROJECT

LA CROSSE AIRPORT HANGAR

REVISION SCHEDULE


DATE DESCRIPTION BY

PROJECT NO.	17-19923
FILE NAME	
DRAWN BY	MPD
DESIGNED BY	KMB
REVIEWED BY	KMB
ORIGINAL ISSUE DATE	
CLIENT PROJECT NO.	

TITLE

EXTERIOR ELEVATIONS

A2-11

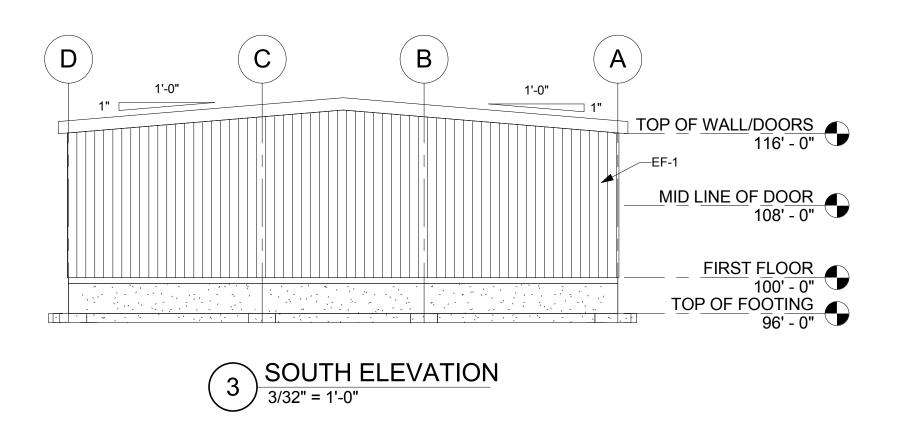

(21)

(20)

(18)

(15)

(14)

