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RING & DUCHATEAU CONSULTING ENGINEERS

COMMERCIAL DESIGN REVIEW MCHS SWWI

850 West Ave S. La Crosse WI 54601

KAHLER SLATER PROJECT: 224044.02 03/28/2025

SHEET NUMBER	SHEET NAME
C100	EXISTING CONDITIONS
C200	DEMO AND EROSION CONTROL PLAN
C300	SITE LAYOUT PLAN
C400	SITE GRADING PLAN
C500	SITE STORM SEWER UTILITY PLAN
C501	SITE SANITARY SEWER UTILITY PLAN
C900	CONSTRUCTION NOTES
C901	CONSTRUCTION DETAILS
C902	CONSTRUCTION DETAILS
C903	CONSTRUCTION DETAILS
SHEET NUMBER L100 L900	SHEET INDEX SHEET NAME LANDSCAPE PLAN LANDSCAPE NOTES AND DETAILS
	SHEET NAME LANDSCAPE PLAN
SHEET NUMBER L100 L900 L1200 L1900 ARCHITE	SHEET NAME LANDSCAPE PLAN LANDSCAPE NOTES AND DETAILS IRRIGATION PLAN IRRIGATION DETAILS CTURAL SHEET INDEX
SHEET NUMBER L100 L900 L1200 L1900 ARCHITE SHEET NUMBER	SHEET NAME LANDSCAPE PLAN LANDSCAPE NOTES AND DETAILS IRRIGATION PLAN IRRIGATION DETAILS CTURAL SHEET INDEX SHEET NAME
SHEET NUMBER L100 L900 L1200 L1900 ARCHITE SHEET NUMBER AS101	SHEET NAME LANDSCAPE PLAN LANDSCAPE NOTES AND DETAILS IRRIGATION PLAN IRRIGATION DETAILS CTURAL SHEET INDEX SHEET NAME ARCHITECTURAL SITE PLAN
SHEET NUMBER L100 L900 L1200 L1900 ARCHITE SHEET NUMBER AS101 AR110	SHEET NAME LANDSCAPE PLAN LANDSCAPE NOTES AND DETAILS IRRIGATION PLAN IRRIGATION DETAILS CTURAL SHEET INDEX SHEET NAME ARCHITECTURAL SITE PLAN LOWER LEVEL FLOOR PLAN
SHEET NUMBER L100 L900 L1200 L1900 ARCHITE SHEET NUMBER AS101 AR110 AR111	SHEET NAME LANDSCAPE PLAN LANDSCAPE NOTES AND DETAILS IRRIGATION PLAN IRRIGATION DETAILS CTURAL SHEET INDEX SHEET NAME ARCHITECTURAL SITE PLAN LOWER LEVEL FLOOR PLAN FIRST LEVEL FLOOR PLAN
SHEET NUMBER L100 L900 L1200 L1900 ARCHITE SHEET NUMBER AS101 AR110 AR111 AR112	SHEET NAME LANDSCAPE PLAN LANDSCAPE NOTES AND DETAILS IRRIGATION PLAN IRRIGATION DETAILS CTURAL SHEET INDEX SHEET NAME ARCHITECTURAL SITE PLAN LOWER LEVEL FLOOR PLAN FIRST LEVEL FLOOR PLAN THIRD LEVEL FLOOR PLAN
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LA CROSSE HOSPITAL EXPANSION

COMMERCIAL DESIGN REVIEW

SCOPE DOCUMENTS

03/28/2025

MCHS SWWI LA CROSSE HOSPITAL **EXPANSION**

MAYO CLINIC HEALTH SYSTEM

850 West Ave S. La Crosse WI 54601

224044.02 LALH24C001

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COVER SHEET

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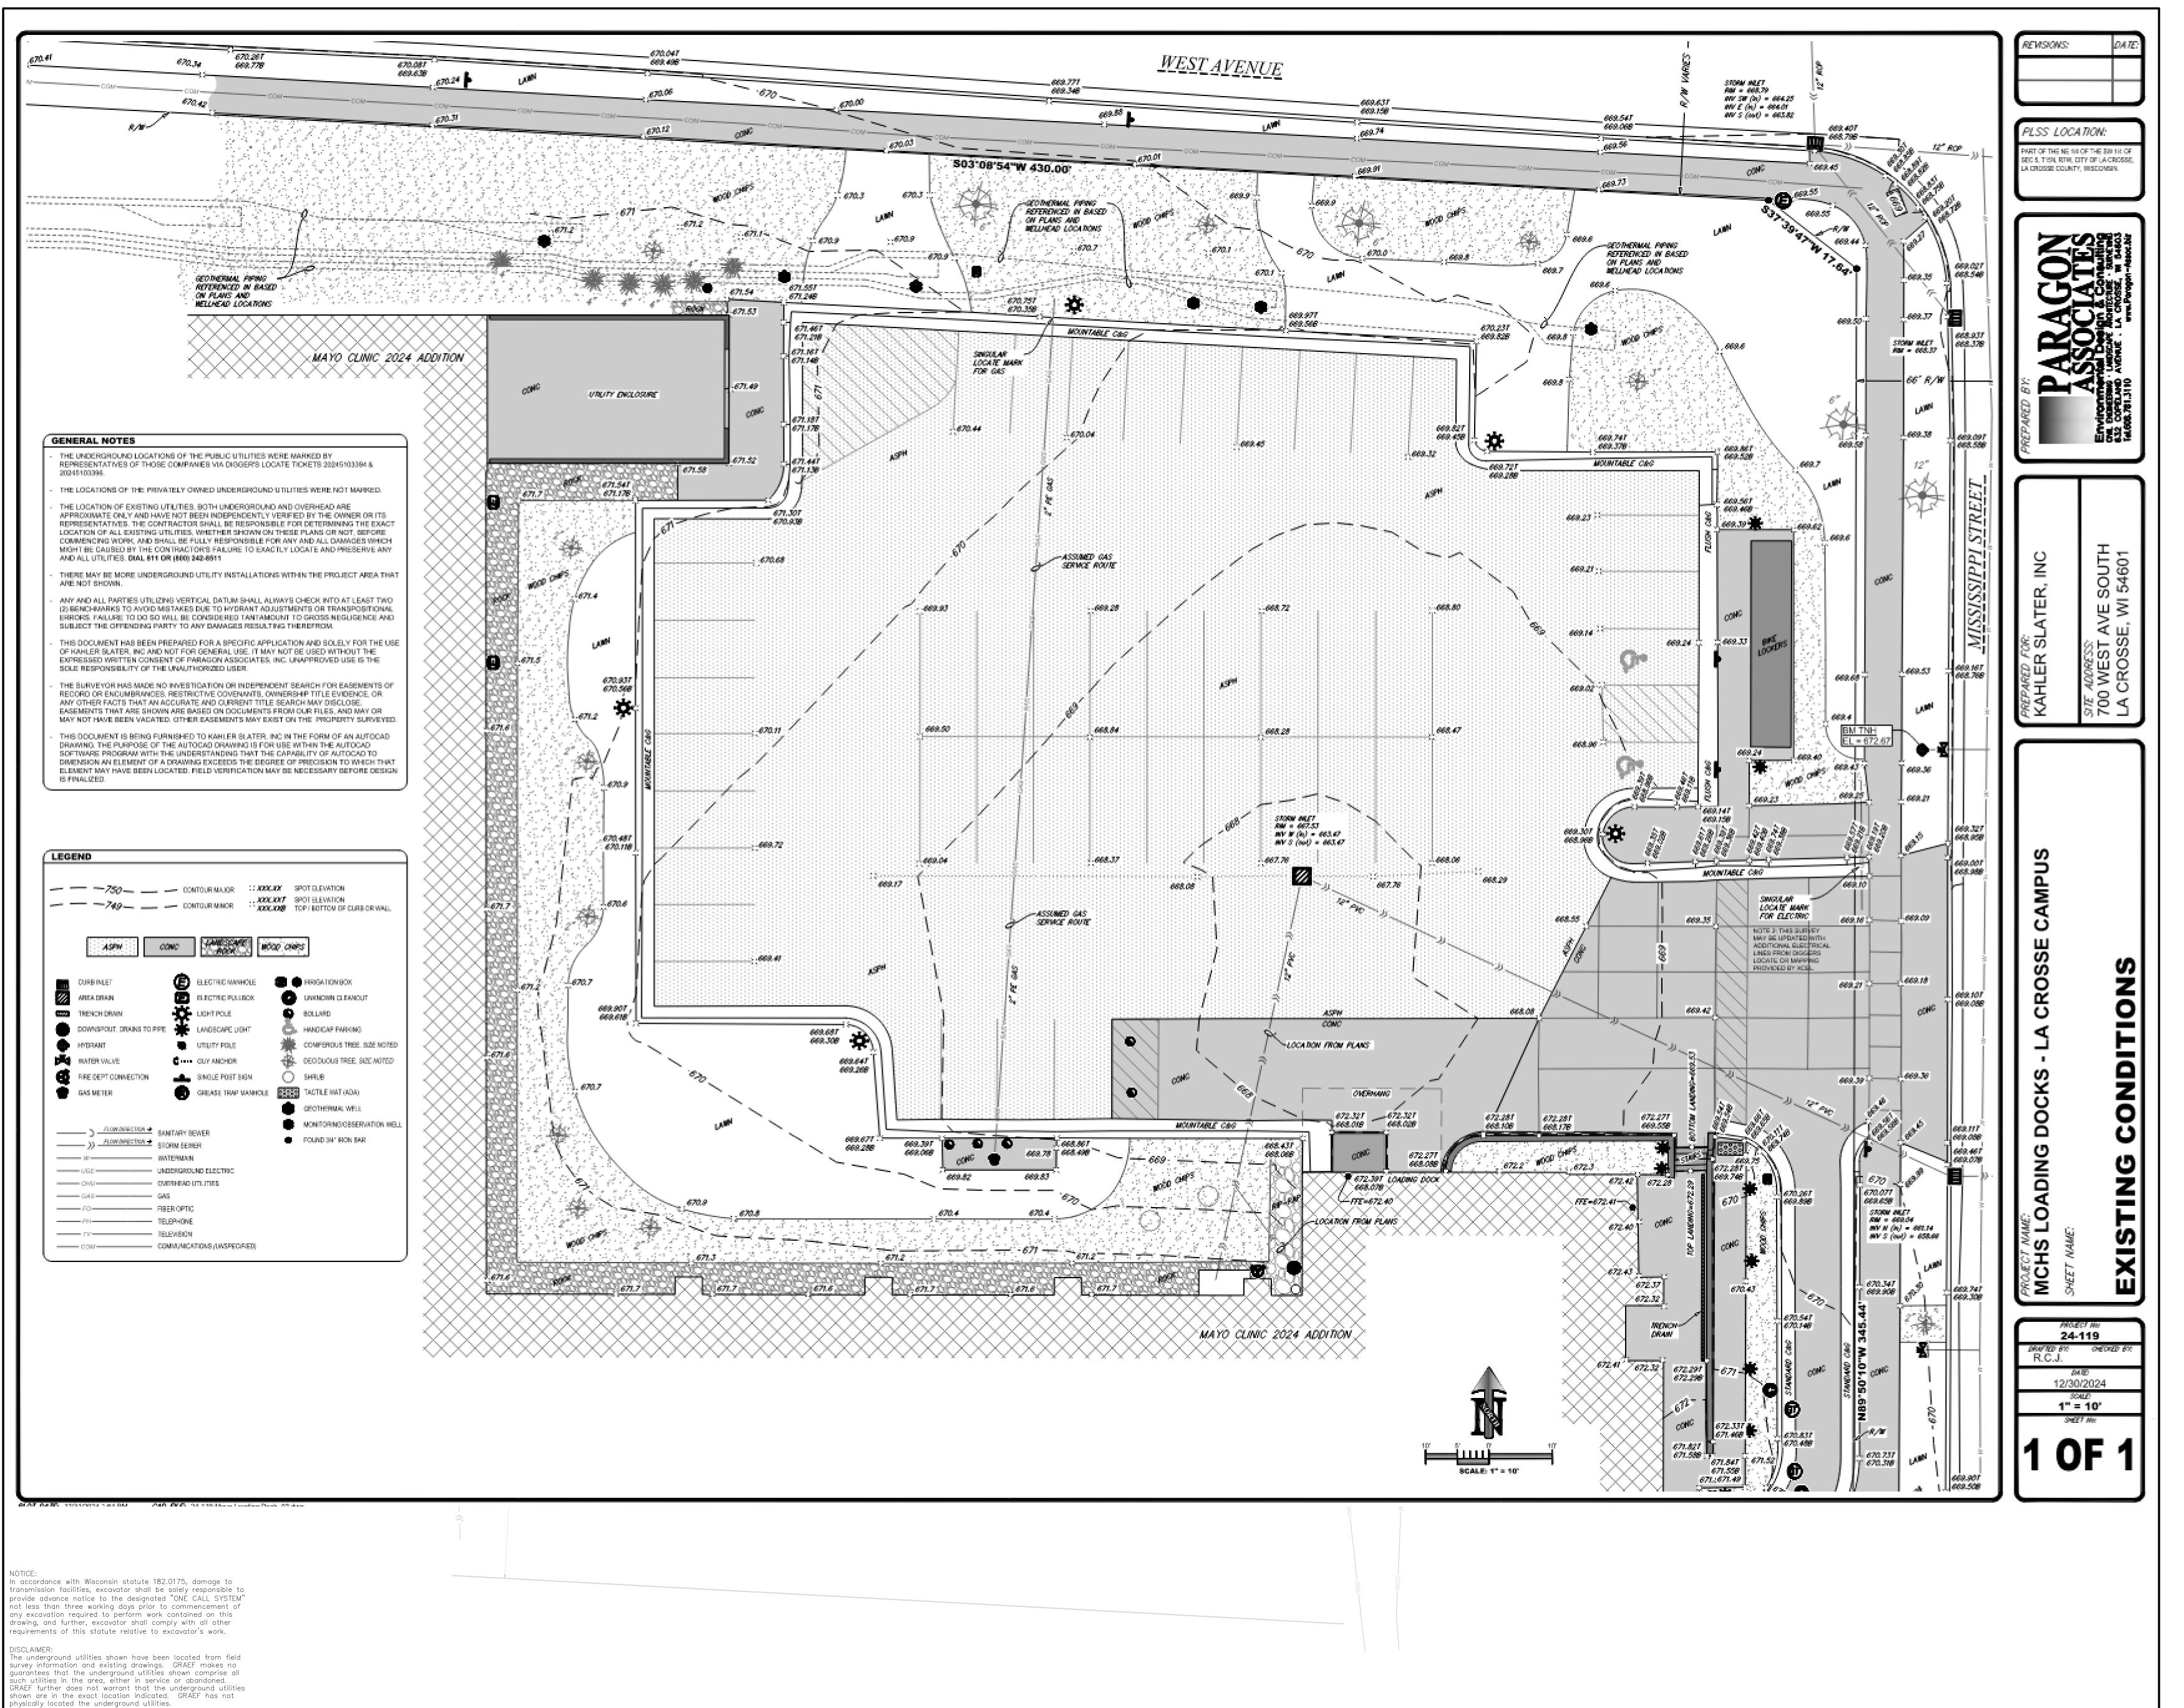
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DEMO AND EROSION CONTROL PLAN

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SITE LAYOUT PLAN

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SITE GRADING PLAN

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SITE STORM SEWER UTILITY PLAN

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SITE SANITARY SEWER UTILITY PLAN

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GENERAL NOTES

- 1. THE BASE SURVEY WAS PREPARED BY PARAGON ASSOCIATES IN 2024. ALL UNDERGROUND UTILITIES AND STRUCTURES HAVE BEEN SHOWN TO A REASONABLE DEGREE OF ACCURACY AND IT SHALL BE THE CONTRACTOR'S RESPONSIBILITY TO VERIFY THEIR EXACT LOCATION AND TO AVOID DAMAGE THERETO.
- REFER TO SHEET CXXX FOR BENCHMARKS, DATUM, AND TOPOGRAPHIC ELEMENTS.
- 3. CONTRACTOR SHALL VERIFY LOCATION OF WORK AND REPORT ANY DISCREPANCIES TO THE ENGINEER PRIOR TO COMMENCING WORK.

REMOVAL NOTES

- 1. EXISTING CONDITIONS SHALL BE VERIFIED BY THE CONTRACTOR AND DISCREPANCIES SHALL BE REPORTED TO THE ENGINEER PRIOR TO COMMENCING WORK.
- 2. CONTRACTOR SHALL VERIFY ALL EXISTING UTILITY LINES NOTED FOR ABANDONMENT OR REMOVAL. EXISTING UTILITIES THAT ARE TO BE ABANDONED OR REMOVED SHALL BE RESPECTIVELY ABANDONED OR REMOVED TO THE LOCATIONS INDICATED ON THIS PLAN. ALL UTILITY STRUCTURES LOCATED ALONG REMOVED UTILITY LINES SHALL BE REMOVED IN THEIR ENTIRETY.
- 3. ASPHALT PAVEMENT NOTED FOR REMOVAL SHALL BE SAW CUT TO FULL DEPTH PRIOR TO REMOVAL.
- 4. CONCRETE CURB AND GUTTER AND SIDEWALK NOTED FOR REMOVAL SHALL BE REMOVED AT THE NEAREST JOINT.

WITH ANY APPLICABLE REGULATIONS.

- 5. ITEMS SCHEDULED FOR REMOVAL AND EXCESS EXCAVATED MATERIALS SHALL BE DISPOSED OF OFF-SITE IN ACCORDANCE
- 6. CONTRACTOR IS RESPONSIBLE FOR SECURING THE JOB SITE TO PROTECT THE PUBLIC.
- 7. CONTRACTOR SHALL COMPLY WITH LOCAL, STATE, AND FEDERAL CODES, RULES AND REGULATIONS APPLICABLE TO DEMOLITION WORK INCLUDING BUT NOT LIMITED TO EROSION CONTROL, AIR POLLUTION, NOISE POLLUTION, AND WASTE DISPOSAL.
- 8. CONTRACTOR SHALL REPLACE PAVEMENT, CURB AND GUTTER, TREES, LAWN AREA, ANY ABOVE GROUND APPURTENCES, OR ANY OTHER ITEM THAT WAS DAMAGED AS A RESULT OF CONSTRUCTION RELATED ACTIVITIES AS DEEMED BY OWNERS REPRESENTATIVE THAT WAS NOT CALLED OUT FOR REMOVAL OR REPLACEMENT. CONTRACTOR SHALL REPLACE/REPAIR DAMAGED ITEM TO THE SATISFACTION OF OWNER'S REPRESENTATIVE AT NO ADDITIONAL COST TO THE OWNER.
- 9. TREE PROTECTION FENCING LOCATIONS SHOWN ARE APPROXIMATE. ALL EXISTING TREES OUTSIDE OF GRADING LIMITS ARE INTENDED TO REMAIN. FINAL LOCATIONS OF FENCING SHALL BE DETERMINED IN THE FIELD AND AS IDENTIFIED ON CONSTRUCTION DETAILS. ADDITIONAL FENCING MAY BE REQUIRED. COORDINATE WITH OWNER'S REPRESENTATIVE. TREE PROTECTION FENCE SHALL REMAIN IN PLACE THROUGHOUT CONSTRUCTION.

LAYOUT NOTES

- 1. THE BUILDING OUTLINES SHOWN ARE FOR REFERENCE PURPOSES ONLY AND SHALL NOT BE USED FOR STAKING PURPOSES. THE CONTRACTOR SHALL COORDINATE WITH THE ARCHITECT AND STRUCTURAL ENGINEER ON THE STAKING OF THE BUILDING.
- 2. SITE LIGHTS ARE SHOWN FOR REFERENCE PURPOSES ONLY AND THE CONTRACTOR SHALL REFER TO THE ELECTRICAL PLANS FOR DETAIL DESIGN INFORMATION. CONTRACTOR SHALL COORDINATE WITH THE ELECTRICAL ENGINEER ON STAKING OF THE SITE LIGHTS.
- 3. ALL DIMENSIONS SHOWN ARE TO THE EDGE OF PAVEMENT OR FACE OF CURB WHERE CONCRETE CURB IS SHOWN.
- 4. STANDARD CURB RADIUS IS 3' UNLESS INDICATED OTHERWISE.
- 5. ALL PAVEMENT STRIPING SHALL BE WHITE IN COLOR.
- 6. REFER TO LANDSCAPING PLANS FOR SITE RESTORATION INFORMATION AND DETAILS.
- 7. HANDICAP PARKING STALLS SHALL BE FURNISHED WITH A CONCRETE WHEEL STOP WHEN ADJACENT TO FLUSH CONCRETE CURB AND GUTTER.
- 8. CONTRACTOR SHALL SUBMIT A CONCRETE JOINTING PLAN TO THE ENGINEER FOR REVIEW AND APPROVAL PRIOR TO COMMENCING CONSTRUCTION. JOINTING PLAN SHALL INDICATE: POUR SEQUENCE, LOCATION OF CONSTRUCTION, ISOLATION, CONTRACTION JOINTS, AND TYPE OF REINFORCEMENT.

GRADING NOTES

- 1. ADA REGULATIONS FOR A NON-RAMP ACCESSIBLE REQUIRE A MAXIMUM SLOPE OF 1:20 (5%) ALONG THE LENGTH OF THE ROUTE AND A MAXIMUM CROSS SLOPE OF 1:48 (2.08%) ACROSS THE WIDTH OF THE ROUTE.
- ADA REGULATIONS FOR ACCESSIBLE PARKING, ACCESS AISLES, AND PASSENGER LOADING ZONES REQUIRES A MAXIMUM SLOPE OF 1:48 (2.08%) ALONG THE LENGTH OF ACCESSIBLE ZONE AND 1:48 (2.08%) ACROSS THE WIDTH OF THE ACCESSIBLE ZONE.
- 3. ACCESSIBLE AREAS DESCRIBED ABOVE SHALL BE MEASURED IN ACCORDANCE WITH THE US ACCESS BOARD REPORT 'DIMENSIONAL TOLERANCES IN CONSTRUCTION AND FOR SURFACE ACCESSIBILITY" PART II, SECTION 4, 1.1 MEASUREMENT PROTOCOLS.

EROSION CONTROL NOTES

- 1. CONSTRUCTION SITE EROSION CONTROL AND SEDIMENTATION CONTROL SHALL COMPLY WITH THE REQUIREMENTS OF THE CITY OF LA CROSSE, AND SHALL EMPLOY EROSION CONTROL METHODS AS SHOWN AND SPECIFIED IN THE WISCONSIN DEPARTMENT OF NATURAL RESOURCES (WDNR) "CONSTRUCTION SITE EROSION AND SEDIMENT CONTROL TECHNICAL STANDARDS".
- 2. ALL EROSION CONTROL MEASURES SHALL BE ADJUSTED TO MEET FIELD CONDITIONS AT THE TIME OF CONSTRUCTION AND SHALL BE INSTALLED PRIOR TO ANY GRADING OR DISTURBANCE OF EXISTING SURFACE MATERIAL ON THE SITE.
- 3. ALL EROSION AND SEDIMENT CONTROL MEASURES WILL BE CHECKED FOR STABILITY AND OPERATION AFTER A RAINFALL OF 0.5 INCHES OR MORE, BUT NO LESS THAN ONCE EVERY WEEK. MAINTENANCE OF ALL EROSION CONTROL STRUCTURES SHALL BE PROVIDED TO INSURE INTENDED PURPOSE IS ACCOMPLISHED. REPAIRS AND MAINTENANCE SHALL BE COMPLETED WITHIN 24 HOURS OF INSPECTION. CONTRACTOR SHALL BE RESPONSIBLE FOR CLEANUP AND REMOVAL OF ALL SEDIMENT WHEN LEAVING PROPERTY. EROSION CONTROL MEASURES MUST BE IN WORKING CONDITION AT END OF EACH WORK DAY.
- 4. SILT FENCE SHALL BE INSTALLED IN THE LOCATIONS SHOWN ON THE CONSTRUCTION PLANS. SEDIMENT DEPOSITS WILL BE REMOVED FROM BEHIND THE SILT FENCE WHEN DEPOSITS REACH A DEPTH OF 6 INCHES. THE SILT FENCE WILL BE REPAIRED OR REPLACED AS NECESSARY TO MAINTAIN A BARRIER.
- 5. FILTER FABRIC SHALL BE INSTALLED BENEATH INLET COVERS TO TRAP SEDIMENT AS PER INLET PROTECTION DETAIL IN THE LOCATIONS SHOWN ON THE CONSTRUCTION PLANS.
- 6. CRUSHED STONE ENTRANCE SHALL BE MAINTAINED BY TURNING OVER THE STONE OR BY PLACING NEW STONE ONCE THE SURFACE BECOMES CLOGGED WITH SEDIMENT.
- 7. EROSION CONTROL MEASURES SHALL BE MAINTAINED ON A CONTINUING BASIS UNTIL SITE IS FULLY STABILIZED.
- 8. PERIODIC STREET SWEEPING SHALL BE COMPLETED TO MAINTAIN THE PUBLIC STREET FREE OF DUST AND DIRT.
- 9. SILT FENCE SHALL BE INSTALLED IN HORSESHOE FASHION AROUND ALL TOPSOIL AND FILL STOCKPILES. NOTIFY CITY OF LA CROSSE OF ANY NEW STOCKPILE LOCATIONS.
- 10. CONSTRUCTION SEQUENCE FOR EROSION CONTROL INCLUDES:
 1. INSTALL STABILIZED CONSTRUCTION ENTRANCE.
 2. INSTALL SILT FENCE AND INLET PROTECTION.
- STRIP TOPSOIL FROM SITE.
 PERFORM ROUGH GRADING AND BUILDING EXCAVATION.
 INSTALL UTILITIES. INSTALL INLET PROTECTION ON NEW INLETS.
 CONSTRUCT BUILDING.
- 7. INSTALL PAVEMENTS.

 8. INSTALL LANDSCAPING ON COMPLETED SITE WITHIN 7 DAYS
 OF COMPLETING CONSTRUCTION
- OF COMPLETING CONSTRUCTION.

 9. REMOVE EROSION CONTROL MEASURES ONLY WHEN SITE IS FULLY STABILIZED.
- 11. SITE DEWATERING. WATER PUMPED FROM THE SITE SHALL BE TREATED BY SEDIMENT BASINS OR OTHER APPROPRIATE BEST MANAGEMENT PRACTICES SPECIFIED IN THE WDNR "CONSTRUCTION SITE EROSION AND SEDIMENT CONTROL TECHNICAL STANDARDS". WATER SHALL NOT BE DISCHARGED IN A MANNER THAT CAUSES EROSION OF THE SITE, ADJACENT SITES, OR RECEIVING CHANNELS.
- 12. WASTE AND MATERIAL DISPOSAL. ALL WASTE AND UNUSED BUILDING MATERIALS (INCLUDING GARBAGE, DEBRIS, CLEANING WASTES, WASTEWATER, TOXIC MATERIALS, OR HAZARDOUS MATERIALS) SHALL BE PROPERLY DISPOSED AND NOT ALLOWED TO BE CARRIED OFF—SITE BY RUNOFF OR WIND.
- 13. TRACKING. EACH SITE SHALL HAVE GRAVELED ROADS, ACCESS DRIVES AND PARKING AREAS OF SUFFICIENT WIDTH AND LENGTH TO PREVENT SEDIMENT FROM BEING TRACKED ONTO PUBLIC OR PRIVATE ROADWAYS. ANY SEDIMENT REACHING A PUBLIC OR PRIVATE ROAD SHALL BE REMOVED BY STREET CLEANING, TO THE SATISFACTION OF THE CITY, BEFORE THE END OF EACH WORKDAY. FLUSHING MAY NOT BE USED UNLESS SEDIMENT WILL BE CONTROLLED BY A SEDIMENT BASIN OR OTHER APPROPRIATE BEST MANAGEMENT PRACTICE SPECIFIED IN THE WDNR "CONSTRUCTION SITE EROSION AND SEDIMENT CONTROL TECHNICAL STANDARDS". NOTIFY CITY OF LA CROSSE FOR CHANGES IN STABILIZED CONSTRUCTION ENTRANCE LOCATION.
- 14. SEDIMENT CLEANUP. ALL OFF-SITE SEDIMENT DEPOSITS OCCURRING AS A RESULT OF A STORM EVENT SHALL BE CLEANED UP BY THE END OF THE NEXT WORK DAY. ALL OTHER OFF-SITE SEDIMENT DEPOSITS OCCURRING AS A RESULT OF CONSTRUCTION ACTIVITIES SHALL BE CLEANED UP BY THE END OF THE THE WORK DAY.
- 15. ALL DISTURBED GROUND LEFT INACTIVE FOR SEVEN OR MORE DAYS SHALL BE STABILIZED BY TEMPORARY OR PERMANENT SEEDING, AND MULCHING SODDING, COVERING WITH TARPS, OR EQUIVALENT BEST MANAGEMENT PRACTICES. IF TEMPORARY SEEDING IS USED, A PERMANENT COVER SHALL ALSO BE REQUIRED AS PART OF THE FINAL SITE STABILIZATION. SEEDING OR SODDING SHALL BE REQUIRED AS PART OF THE FINAL SITE STABILIZATION.
- 16. PERMANENT SEEDING SHALL BE ESTABLISHED NO LATER THAN SEPTEMBER 15TH. IF PERMANENT SEEDING IS NOT ESTABLISHED, TEMPORARY SEEDING SHALL BE ESTABLISHED NO LATER THAN OCTOBER 15TH. ALL SEEDED AREAS MUST BE MULCHED AT A RATE OF 1.5 TO 2 TONS PER ACRE AND ANCHORED BY EITHER CRIMPING OR BY APPLYING A TACKIFIER.
- 17. PERMANENT SEED MIX SHALL BE WISDOT SEED MIX NO. 40 AT 7 POUNDS PER 1000 SQUARE FEET.
- 18. USE ANNUAL RYE SEED MIX AT 100 POUNDS PER ACRE AS A TEMPORARY SEED MIX. PERMANENT SEEDING SHALL FOLLOW WITHIN ONE YEAR. IF TEMPORARY SEEDING IS NOT ESTABLISHED BY OCTOBER 15TH, USE CLASS I TYPE B MATTING ON ALL SLOPES 4:1 OR STEEPER.
- 19. SOIL OR DIRT STORAGE PILES SHALL BE LOCATED A MINIMUM OF TWENTY—FIVE FEET FROM ANY DOWNSLOPE ROAD, LAKE, STREAM, WETLAND, OR DRAINAGE CHANNEL. STRAW BALE OR FILTER FABRIC FENCES SHALL BE PLACED ON THE DOWN SLOPE SIDE OF THE PILE. IF REMAINING FOR MORE THAN THIRTY DAYS. PILES SHALL BE STABILIZED BY MULCHING, VEGETATIVE COVER, TARPS, OR OTHER MEANS.
- 20. WHEN THE DISTURBED AREA HAS BEEN STABILIZED BY PERMANENT VEGETATION OR OTHER MEANS, TEMPORARY BEST MANAGEMENT PRACTICES SUCH AS FILTER FABRIC FENCES, STRAW BALES, SEDIMENT AND SEDIMENT TRAPS SHALL BE REMOVED.
- 21. NOTIFY THE CITY WITHIN TWO WORKING DAYS OF COMMENCING ANY LAND DEVELOPMENT OR LAND DISTURBING ACTIVITY.
- 22. NOTIFY THE CITY OF COMPLETION OF ANY BEST MANAGEMENT PRACTICES WITHIN THE NEXT WORKING DAY AFTER THEIR INSTALLATION.
- 23. OBTAIN PERMISSION IN WRITING FROM THE CITY OF LA CROSSE ENGINEERING DEPARTMENT PRIOR TO MODIFYING THE EROSION CONTROL PLAN. NOTIFY WDNR AT LEAST FIVE WORKING DAYS PRIOR TO IMPLEMENTING CHANGES TO THE EROSION CONTROL
- 24. REPAIR ANY SILTATION OR EROSION DAMAGE TO ADJOINING SURFACES AND DRAINAGE WAYS RESULTING FROM LAND DEVELOPMENT OR LAND DISTURBING ACTIVITIES.
- 25. KEEP A COPY OF THE EROSION CONTROL PLAN ON SITE. INTERSECTING DIRECTIONS.

UTILITY NOTES

- 1. CONTRACTOR SHALL VERIFY ELEVATION OF EXISTING INVERTS PRIOR TO INSTALLATION OF PROPOSED UTILITIES.
- 2. BUILDING LATERALS SHALL BE CONSTRUCTED IN ACCORDANCE WITH LOCAL AND STATE PLUMBING CODES. SITE UTILITY CONTRACTOR SHALL STUB LATERAL TO 5 FEET OUTSIDE BUILDING. SEE INTERIOR PLUMBING PLANS FOR CONTINUATION OF PIPING INTO BUILDING BY BUILDING PLUMBING CONTRACTOR IN ACCORDANCE WITH STANDARD SPECIFICATIONS FOR SEWER AND WATER CONSTRUCTION IN WISCONSIN, LATEST EDITION.
- 3. CONTRACTOR SHALL CENTER ONE FULL LENGTH OF WATER PIPE ON SEWER AT WATER MAIN CROSSINGS, THAT BOTH JOINTS WILL BE AS FAR FROM SEWER AS POSSIBLE.
- 4. GENERAL CONTRACTOR SHALL COORDINATE WITH LOCAL GAS, TELEPHONE, AND ELECTRICAL UTILITIES FOR EXACT LOCATION, SIZE AND DEPTH OF NEW SERVICE.
- 5. SANITARY SEWER SHALL BE PVC, ASTM D3034, SDR 35

UNLESS INDICATED OTHERWISE.

- UNLESS INDICATED OTHERWISE.

 6. WATER MAIN SHALL BE AWWA C900, CLASS 150, DR-18 PVC
- 7. ALL SANITARY PRECAST MANHOLES SHALL CONFORM TO ASTM C-478 AND SHALL BE A MINIMUM OF 48-INCH DIAMETER WITH ECCENTRIC CONE TYPE PRECAST TOPS AND SHALL BE FITTED WITH AN EXTERNAL SEAL. FLAT TOP SLABS SHALL BE USED ONLY WITH APPROVAL OF THE VILLAGE ENGINEER.
- 8. CONTRACTOR SHALL PROVIDE DRAIN TILE AT ALL PROPOSED CATCH BASINS. SEE PLAN VIEW FOR DETAIL DESIGN INFORMATION.
- 9. BUILDING ROOF DRAINS SHALL BE SDR-35, ASTM D3034, PVC, UNLESS OTHERWISE NOTED.
- 10. RIM ELEVATIONS IN CURB AND GUTTER ARE FLANGE GRADES.
- 11. PIPE LENGTHS AND INVERTS ARE TO CENTER OF STRUCTURES.
- 12. CRUSHED STONE BACKFILL SHALL BE USED UNDER AND WITHIN 5' OF ALL PAVED AREAS.
- 13. UTILITY AND ROADWAY WORK IN THE CITY RIGHT—OF WAY SHALL BE CONSTRUCTED PER CITY SPECIFICATIONS.
- 14. UTILITIES AND WORK OUTSIDE OF CITY RIGHT—OF—WAY SHALL BE CONSTRUCTED PER THE OTHER DRAWING DETAILS AND SPECIFICATIONS.



NOT FOR CONSTRUCTION



Revisions

COMMERCIAL DESIGN REVIEW

SCOPE DOCUMENTS

MCHS LA CROSSE

03/28/2025

LOADING DOCK

Drawing Date

850 West Avenue S La Crosse, WI 54601

Project No. Mayo Clinic Health System 224044.02 LALH24C001

Sheet Title

CONSTRUCTION
NOTES
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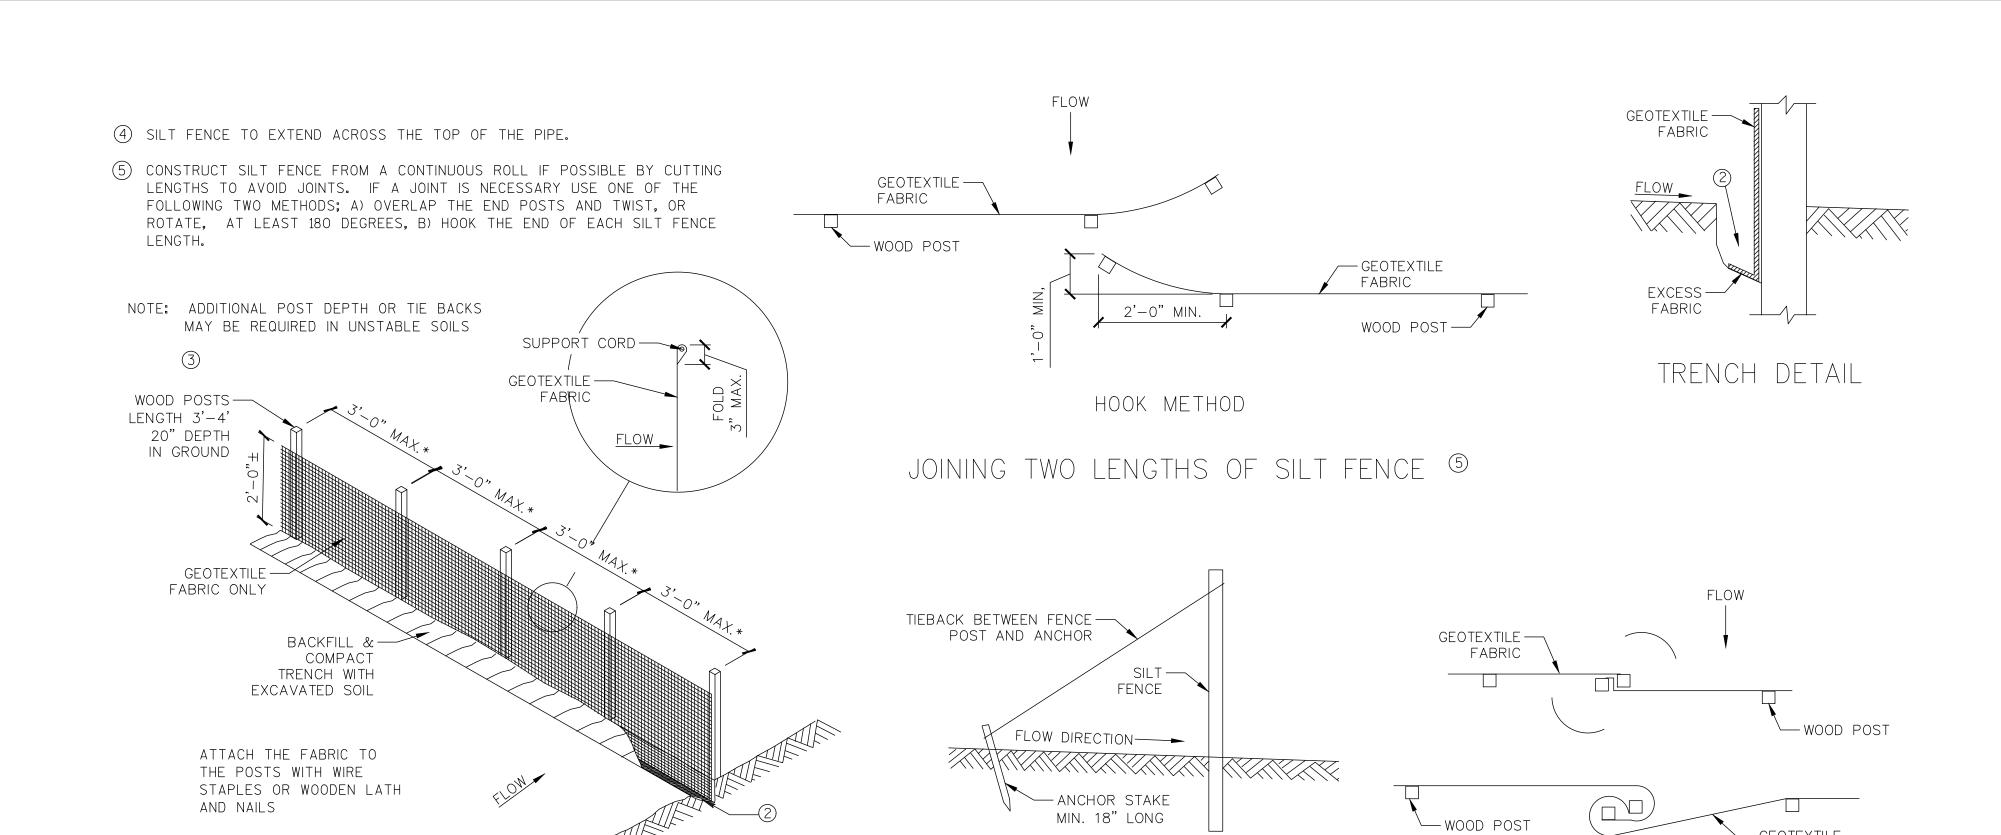
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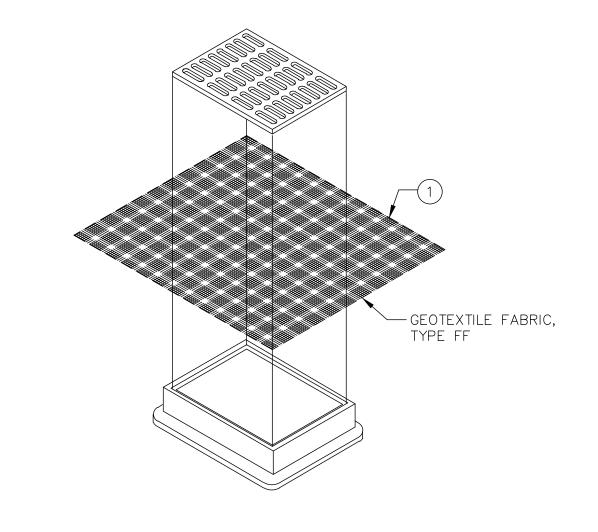
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SILT FENCE TIE BACK

N.T.S.

(WHEN ADDITIONAL SUPPORT REQUIRED)




N.T.S.

INLET PROTECTION, TYPE B
(WITHOUT CURB BOX)

SCALE

N.T.S.

SILT FENCE
SCALE

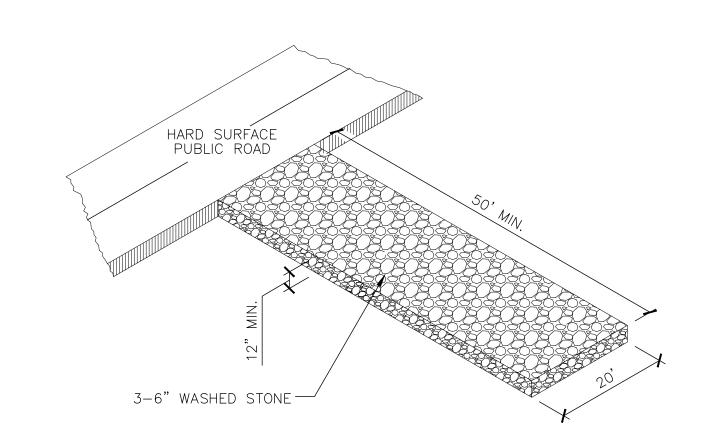

* NOTE: 8'-O" POST SPACING ALLOWED IF A WOVEN GEOTEXTILE FABRIC IS USED.

PAMEMENT OR IMPERVIOUS SURFACE

SEDIMENT LOG

CONCRETE BLOCKS OR SAND BAGS SIZED AS NEEDED (10' O.C.)

AREA TO BE PROTECTED

WORK AREA

WATER FLOW

WORK AREA

NOTE:

NOTE:

1. SEDIMENT LOGS SHALL BE FABRICATED FROM COMPACTED GEOTEXTILES, WOOD EXCELSIOR, COCONUT FIBERS, HARDWOOD MULCH, OR A MIXTURE OF THESE MATERIALS WITHIN FLEXIBLE TUBULAR NETTING.

TWIST METHOD

STONE CONSTRUCTION ENTRANCE

SEDIMENT LOG FOR SEDIMENT CONTROL ON PAVEMENT

N.T.S.



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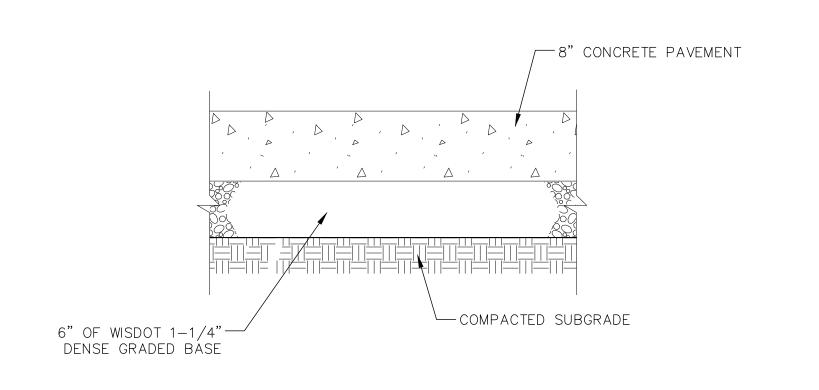
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5" CONCRETE PAVEMENT 6" OF WISDOT 1-1/4"-COMPACTED SUBGRADE DENSE GRADED BÁSE



--- PAVEMENT

1. CONTROL JOINTS SHALL CONFORM WITH WISDOT 601.3.6

— REINFORCEMENT (IF SPECIFIED BY ENGINEER)

2. THE BOTTOM OF THE CURB AND GUTTER MAY BE CONSTRUCTED FLAT OR PARALLEL TO THE SLOPE OF THE BASE COURSE PROVIDED A MINIMUM 6" GUTTER THICKNESS IS MAINTAINED.


36" CURB AND GUTTER SECTION - REVERSE SLOPE

CONCRETE PAVEMENT

---PAVEMENT

- 1. CONTROL JOINTS SHALL CONFORM WITH WISDOT 601.3.6
- 2. THE BOTTOM OF THE CURB AND GUTTER MAY BE CONSTRUCTED FLAT OR PARALLEL TO THE SLOPE OF THE BASE COURSE PROVIDED A MINIMUM 6" GUTTER THICKNESS IS MAINTAINED.

COMPACTED ON SITE SAND

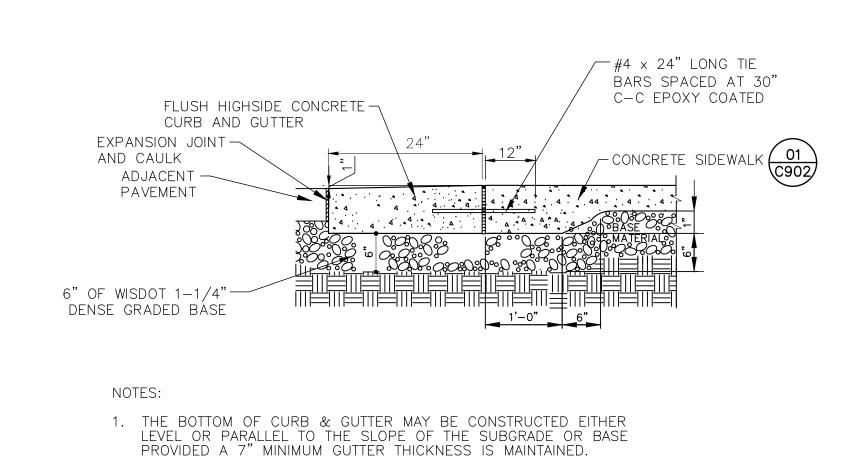

FLUSH HIGHSIDE CONCRETE CURB AND GUTTER




N.T.S.


DETAIL "A"

SEE DETAIL "A"-

36" CURB AND GUTTER SECTION

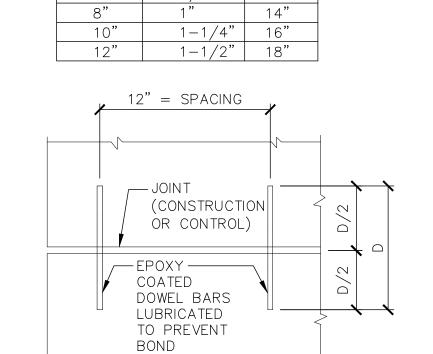




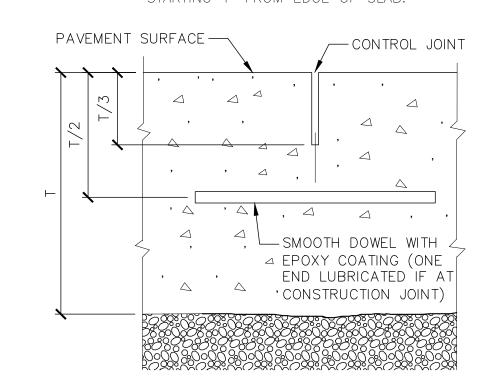

NOTE: INSTALL DOWELS AT ALL CONSTRUCTION JOINTS.

CONSTRUCTION JOINT WITH DOWEL BAR

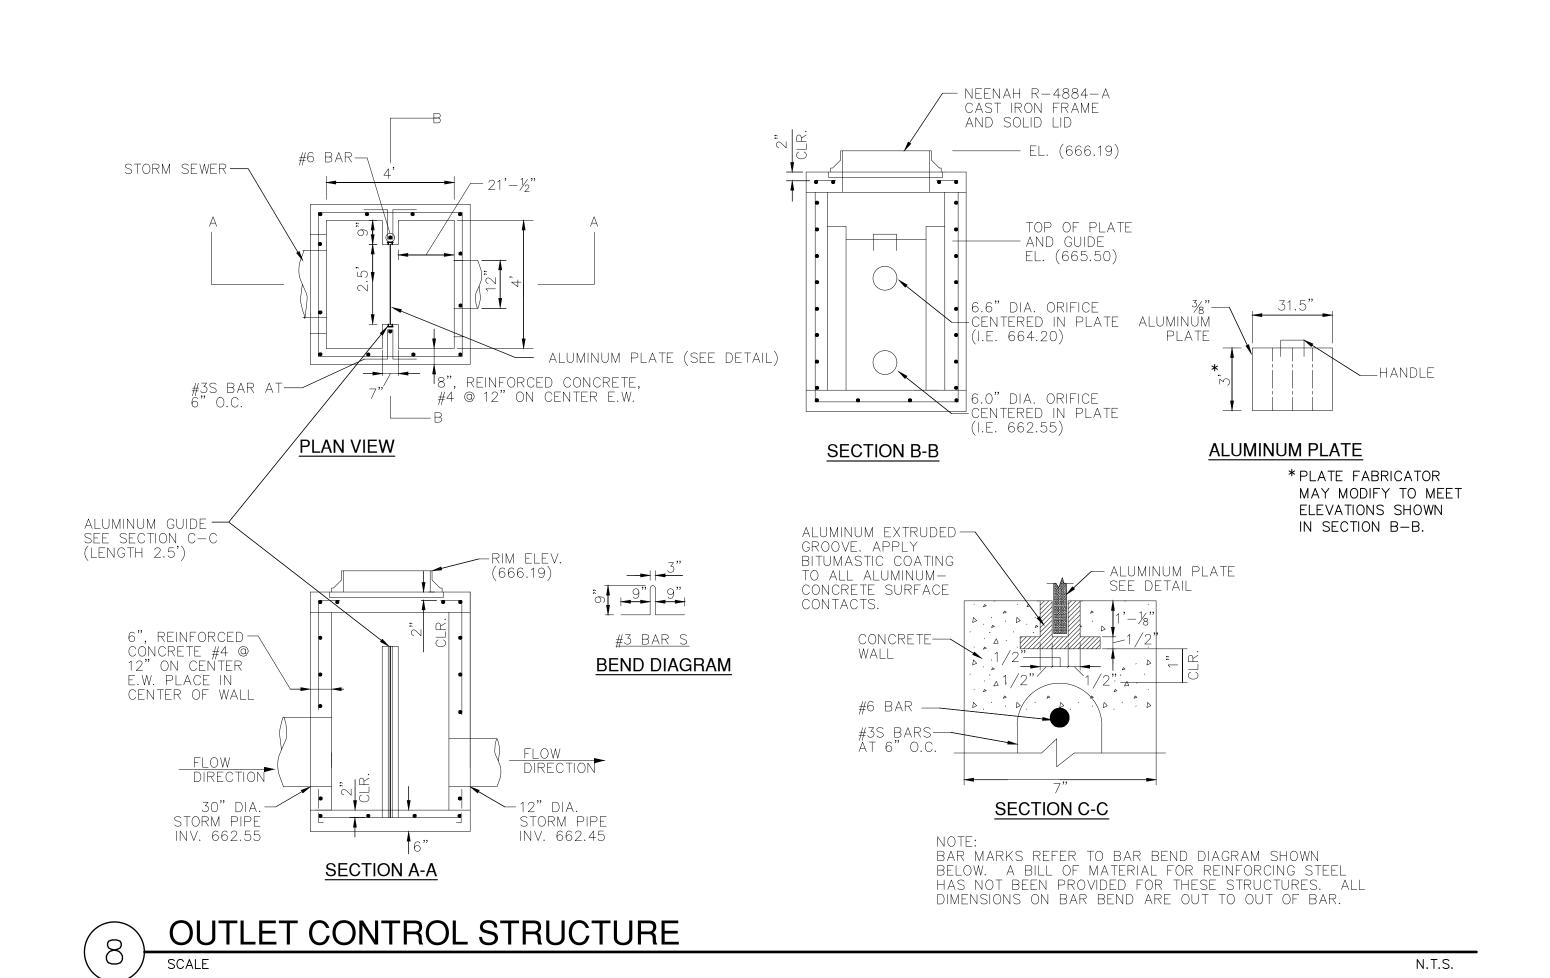

N.T.S.

CONCRETE SIDEWALK

N.T.S.

PAVEMENT THICKNESS DIAMETER

COMMERCIAL DESIGN REVIEW

Sheet Title


CONSTRUCTION **DETAILS**

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CLASS "C" BEDDING DETAIL FOR STORM SEWER

/--INLET/FRAME & GRATE NEENAH NO. R-3228-K

-5" PRECAST

CONCRETE

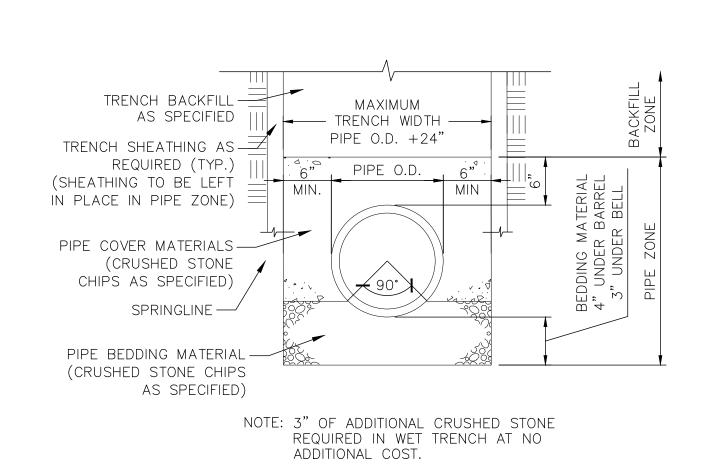STRUCTURE FOOTING TO


BE CLASS "D" CONCRETE

* FOR INLETS OVER 4' IN DEPTH INCREASE WIDTH AT BASE TO 4'


N.T.S.

OR EQUAL

LEAD

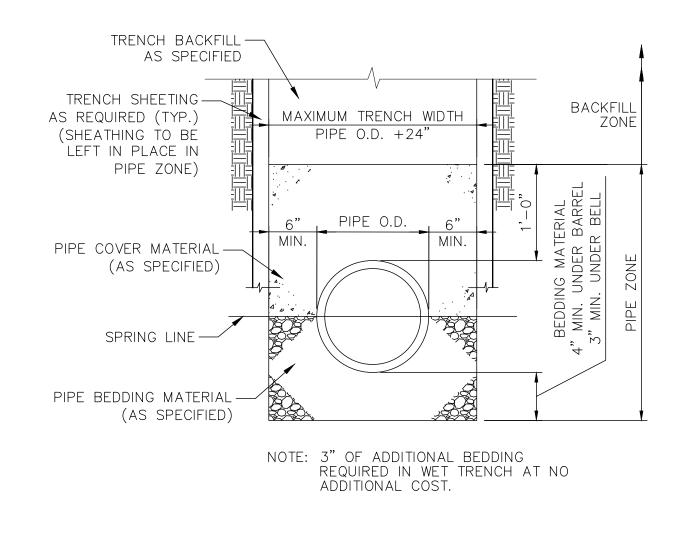


CLASS "B" BEDDING DETAIL FOR SANITARY SEWER
N.T.S.

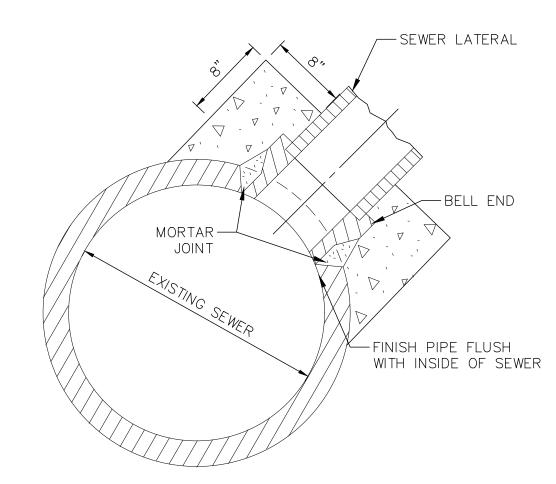

CORED SEWER CONNECTION

GENERAL NOTES:

- CORED CONNECTIONS CORING SHALL BE UNDERSTOOD TO MEAN CUTTING A CIRCULAR HOLE INTO THE MAIN SEWER USING A MECHANICALLY—POWERED HOLLOW CYLINDRICAL BIT. THE FITTING AND METHOD OF ATTACHMENT TO THE MAIN SEWER SHALL BE APPROVED BY THE CITY OF MILWAUKEE.
- 2. ALL ADHESIVES USED SHALL BE COMPATIBLE TO THE PIPE MATERIAL.
- 3. CORED CONNECTIONS SHALL BE CORED IN THE UPPER QUADRANT AT AN ANGLE 45 DEGREES WITH THE HORIZONTAL.

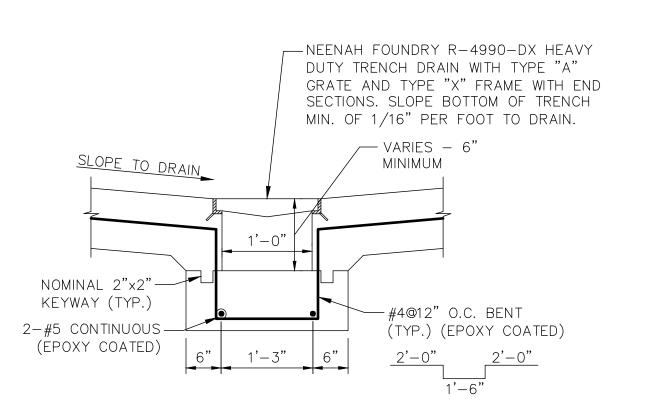

12" TRENCH DRAIN CROSS SECTION

N.T.S.

STANDARD CATCH BASIN

BRICK OR — PRECAST

CORED SEWER CONNECTION



NOT FOR CONSTRUCTION



Revision

COMMERCIAL DESIGN REVIEW

SCOPE DOCUMENTS

MCHS LA CROSSE LOADING DOCK

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224044.02 LALH24C001

Sheet Title

LANDSCAPE PLAN

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Sheet Title LANDSCAPE NOTES

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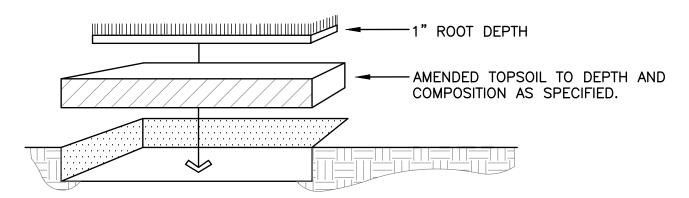
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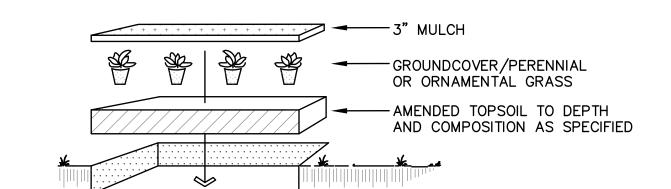
ADJACENT PLANTING → HOLD MULCH 1" MAX BELOW FINISH GRADE OF LAWN ✓ 4" ALUMINUM EDGING ✓ MULCH 3" MIN. DEPTH -AMENDED TOPSOIL TO DEPTH AND COMPOSITION AS SPECIFIED. -UNDISTURBED SUBGRADE





-TOPSOIL SHALL CONFORM TO PROPERTIES AS SPECIFIED. -CONTRACTOR TO PROVIDE FINISHED TURF GRADE PER DRAWINGS WITH UNIFORM, NATURAL SLOPES PRIOR TO LAYING SOD. SOD BLEND & APPLICATION PROCEDURES ARE DESCRIBED IN WRITTEN SPECIFICATION -LAY SOD IN 'RUNNING BOND' FASHION (W/ALTERNATE JOINTS), COMPRESS EACH BUTT JOINT TO REDUCE SHRINKAGE CRACKS. ANCHOR SOD APPLICATIONS ON SLOPES GREATER THAN 1:3 W/10" WOOD PEGS. -LANDSCAPE CONTRACTOR SHALL ESTABLISH VIGOROUS GROWTH AND MOW & MAINTAIN AS SPECIFIED.





-LAYOUT PLANT MATERIAL AS SHOWN ON LANDSCAPE PLAN -HAND BROADCAST UNIFORM 3" MULCH THROUGHOUT PLANTING BEDS -FLOOD IMMEDIATELY & WATER FREQUENTLY PER WRITTEN SPECIFICATIONS -PLANT SIZES SPECIFIED ARE MINIMUM ACCEPTABLE





TREE STAKE W/ORANGE -

PLASTIC RIBBONS (IF

CROWN/ROOT

FLARE

USED BY CONTRACTOR)


SET ROOT BALL ONTO-UNDISTURBED SOIL

> DIAMETER OF BALL & EQUAL IN DEPTH -LOOSEN SUBSOIL W/PICK TO ENSURE POROSITY -PLACE PLANTING SOIL IN PLANTING PIT & FOOT TAMP -SELECT BEST VIEWING ANGLE, LIFT STOCK BY BALL & PLACE IN PLANTING PIT -UNWRAP TOP HALF OF ROOT BALL -BACKFILL TO FINISHED GRADE WITH AMENDED TOPSOIL & TAMP -FORM 3" SAUCER TO ENCIRCLE STOCK & FILL WITH 3" MULCH

-WATER IMMEDIATELY & FREQUENTLY. -PLANT SIZES SPECIFIED ARE MINIMUM

ACCEPTABLE

-EXCAVATE PLANTING PIT TWICE THE

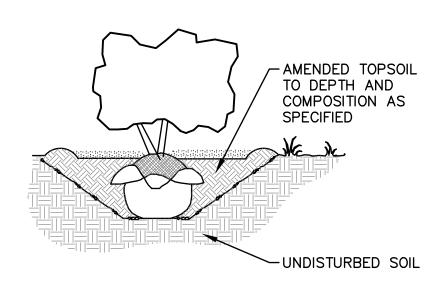

- EXCAVATE PLANTING PIT 3-TIMES THE DIA. & APROXIMATELY THE HEIGHT OF ROOT BALL DEPTH. ROOT FLARE SHALL BE AT OR SLIGHTLY HIGHER THAN ADJACENT F.G.

 LOOSEN SUBSOIL W/PICK TO ENSURE POROSITY. - SELECT BEST VIEWING ANGLE, LIFT STOCK BY

- CUT AND REMOVE ALL STRING AND WIRE AND UNWRAP TOP HALF OF ROOT BALL. BACKFILL

- PACK BACKFILL AROUND BASE OF ROOT BALL

- FORM 3" HT. SAUCER IN 6'-0" DIAMETER

AROUND TREE & FILL WITH 3" MULCH. - KEEP MULCH 1-2 INCHES AWAY FROM TRUNK.

WATER IMMEDIATELY & FREQUENTLY.

- PLANT SIZES SPECIFIED ARE MINIMUM

- BACKFILL REMAINDER OF PLANTING HOLE USING

WATER PERIODICALLY TO REDUCE AIR POCKETS.

PLANTING PIT WITH EXISTING SOIL UP TO BASE

BALL AND PLACE IN PLANTING PIT.

OF ROOT FLARE.

TO STABILIZE IT.

ACCEPTABLE.



SHRUB PLANTING DETAIL

LANDSCAPING NOTES:

- 1. PLANT NAMES ARE ABBREVIATED ON THE DRAWINGS. SEE PLANT LIST FOR SYMBOLS, ABBREVIATIONS, BOTANICAL/COMMON NAMES, SIZES, ESTIMATED QUANTITIES (IF GIVEN) AND OTHER REMARKS.
- 2. PLANT MATERIALS ARE TO BE FURNISHED FREE OF PESTS OR PLANT DISEASES. PLANTS ARE SUBJECT TO OWNER'S ACCEPTANCE PRIOR TO INSTALLATION.
- 3. PLANT BEDS AND TREE PLANTING PITS ARE TO RECEIVE 3" DEEP LAYER OF SHREDDED HARDWOOD BARK
- 4. FORM 72-INCH, OR AS OTHERWISE INDICATED, WATERING BASIN AROUND ALL TREES NOT INSTALLED IN PAVED AREAS.
- 5. MAINTAIN 72-INCH DIAMETER MINIMUM CLEAR SOIL AREA AROUND TREES IN MANICURED TURF AREAS. MULCH TREE RING WITH SPECIFIED DEPTH OF HARDWOOD BARK MULCH. SEE PLANTING DETAILS.
- 6. UNLESS OTHERWISE INDICATED, PLACE SHRUBS, PERENNIALS AND ORNAMENTAL GRASSES IN STRAIGHT ROWS, EQUALLY SPACED.
- 7. SEPARATE PLANTING BEDS FROM ADJACENT TURF AREAS WITH ALUMINUM EDGING
- 8. PLANT SUBSTITUTIONS WILL NOT BE PERMITTED UNLESS THE LANDSCAPE CONTRACTOR CAN DEMONSTRATE THE PLANTS ARE NOT AVAILABLE FROM NURSERY SOURCES LOCATED WITHIN 100 MILES FROM THE PROJECT SITE. ANY PROPOSED PLANT SUBSTITUTION WILL REQUIRE PRIOR REVIEW AND WRITTEN ACCEPTANCE BY THE LANDSCAPE ARCHITECT.

In accordance with Wisconsin statute 182.0175, damage to ransmission facilities, excavator shall be solely responsible to provide advance notice to the designated "ONE CALL SYSTEM" not less than three working days prior to commencement of any excavation required to perform work contained on this drawing, and further, excavator shall comply with all other

The underground utilities shown have been located from field survey information and existing drawings. GRAEF makes no quarantees that the underground utilities shown comprise all such utilities in the area, either in service or abandoned. GRAEF further does not warrant that the underground utilities shown are in the exact location indicated. GRAEF has not physically located the underground utilities.

requirements of this statute relative to excavator's work.

ONSTRUCTION



Revisions

COMMERCIAL DESIGN REVIEW

SCOPE DOCUMENTS

Drawing Date

MCHS LA CROSSE LOADING DOCK

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Project No. Mayo Clinic Health System

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Sheet Title

IRRIGATION PLAN

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150 N Wacker Drive, Suite 1700, Chicago, Illinois 60606 Telephone 312.789.4516



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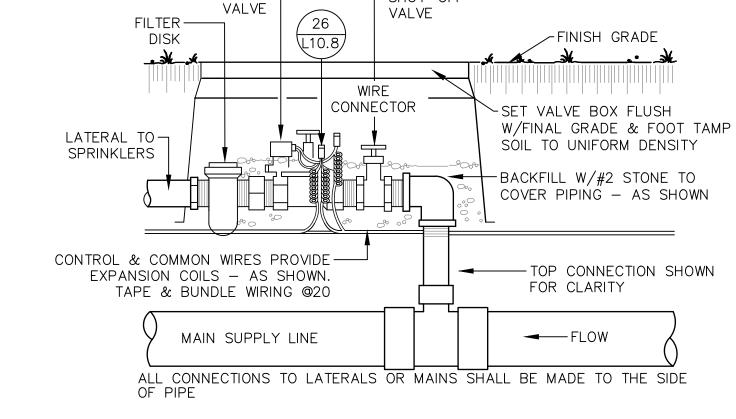
ransmission facilities, excavator shall be solely responsible to


provide advance notice to the designated "ONE CALL SYSTEM"


ot less than three working days prior to commencement of


any excavation required to perform work contained on this





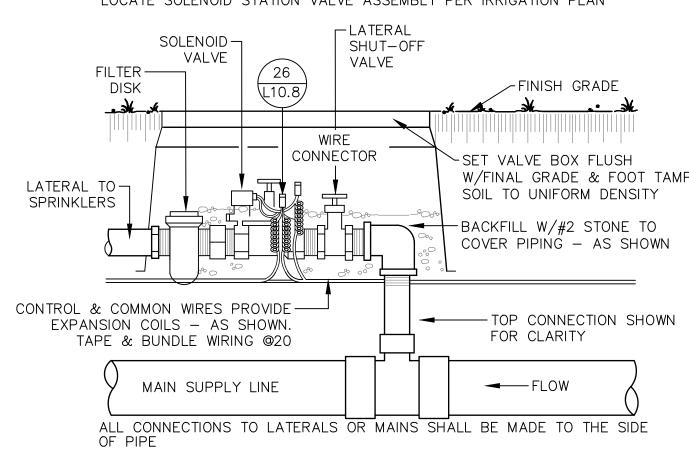

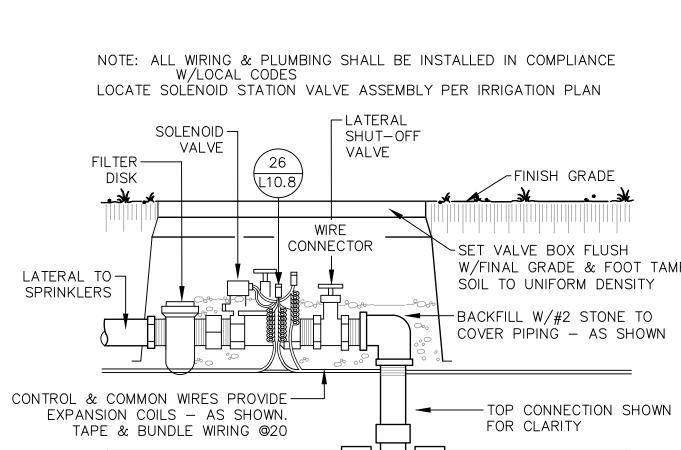

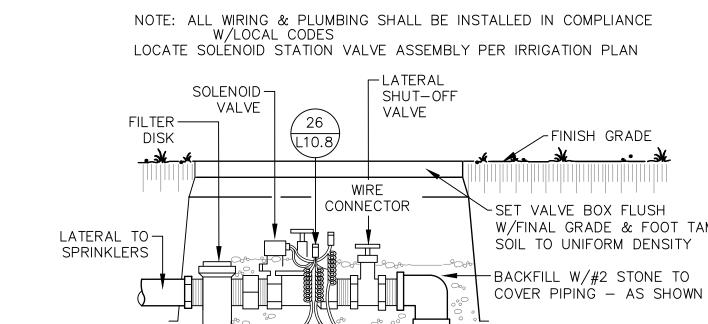

COMPLETE ONE END CONNECTION PRIOR TO STARTING SECOND WELD

SOLVENT WELD CONNECTION @PVC

JSE PVC PIPE FOR MAINS & ALL PIPING GREATER THAN 1 1/4" DIA

COMPLETE FIRST CLAMP CONNECTION PRIOR TO STARTING SECOND CONNECTION PIPE MAY BE PLACED UNDER WATER PRESSURE

CLAMP & SCREW

CLAMP CONNECTION @ PE LATERAL

THIS DIRECT BURY SPLICE SYSTEM IS 'UNDERWRITERS LAB' APPROVED

NO CURE TIME IS REQUIRED -- WIRING MAY BE PLACED ON-LINE

LOW-VOLTAGE WIRING SPLICE

PAST LOCKING FINGERS

USE PE PIPE FOR LATERALS & ALL PIPING UP TO 1 1/4" DIA.

USE 2 CLAMPS FOR 1 1/4" PIPE @ EACH END

ALLOW SOLVENT WELD TO CURE FOR 1 HOUR BEFORE USE OR MOVEMENT
 WAIT 24 HOURS BEFORE PLACING WELD JOING UNDER WATER PRESSURE

SQUARE/DEBURR & CLEAN

INSERT FITTING /COUPLING OR

3 SEPARATE WIRES INTO

SLOTS PROVIDED &

CLOSE COVER TO SEAL

AUTOMATIC LATÉRAL DRAIN

SOLVENT

PIPE PRIOR TO APPLICATION OF

CONNECTION

POLYVINYL —

SLIP OR NESTED-

IMMEDIATELY AFTER CLAMPING

POLYETHYLENE —

LATERAL


UP TO 30VDC


STRIP WIRES & TWIST


INTO SPRING CONNECTOR


COUPLING


CHLORIDE MAIN

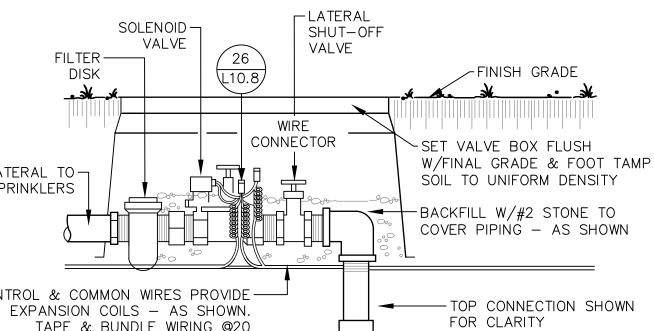


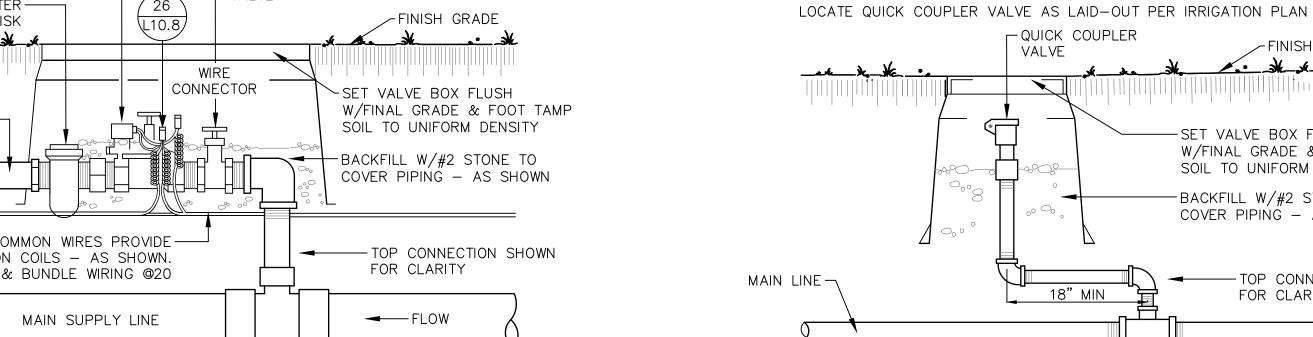


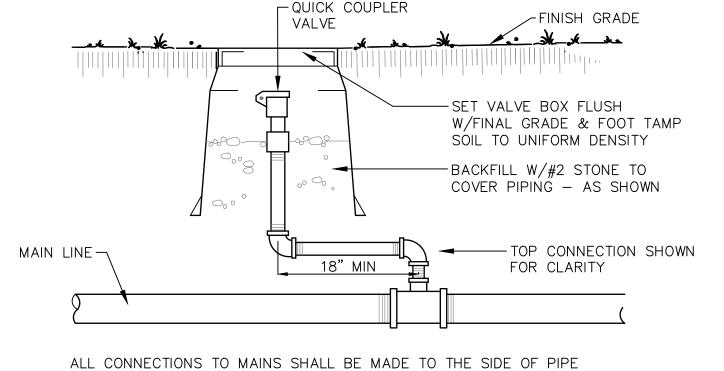


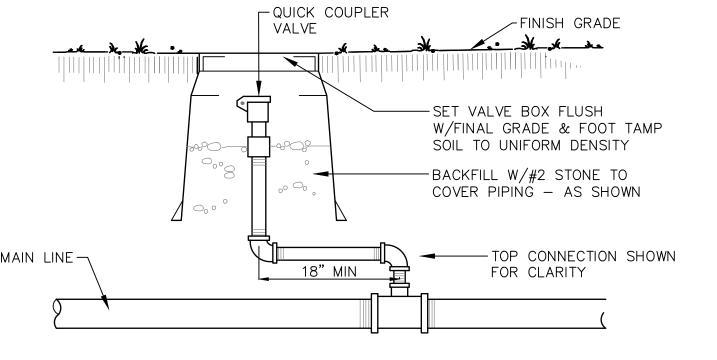

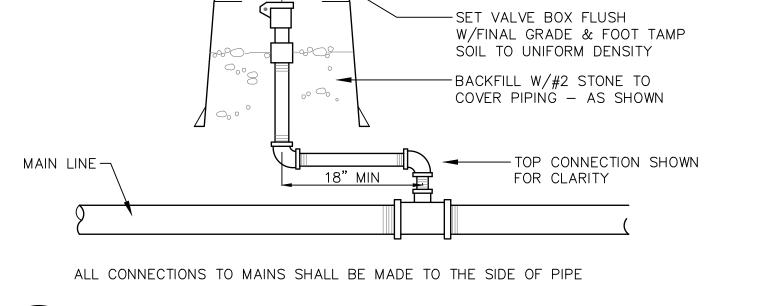


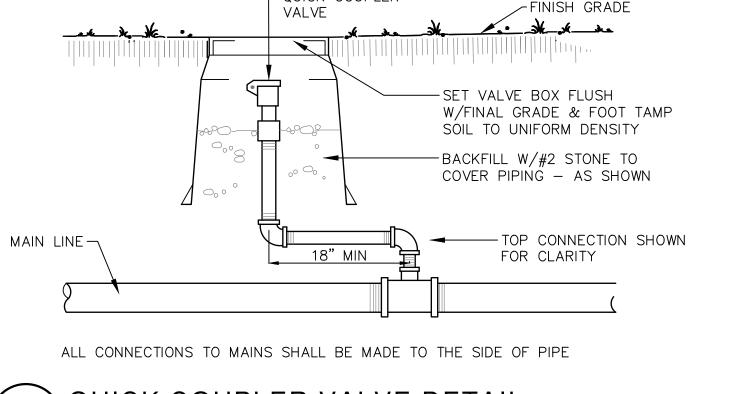

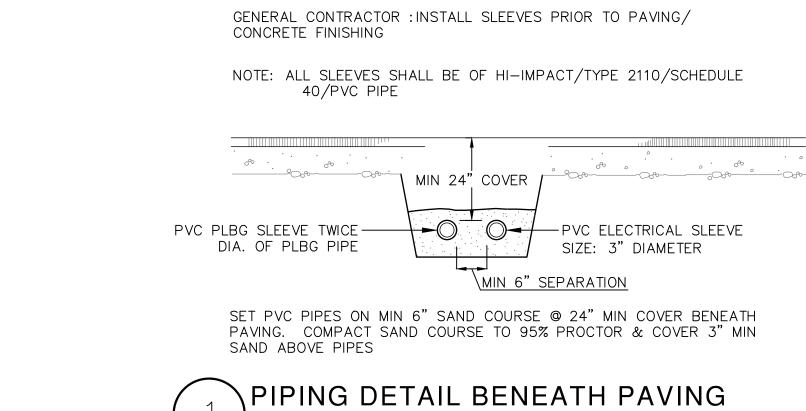

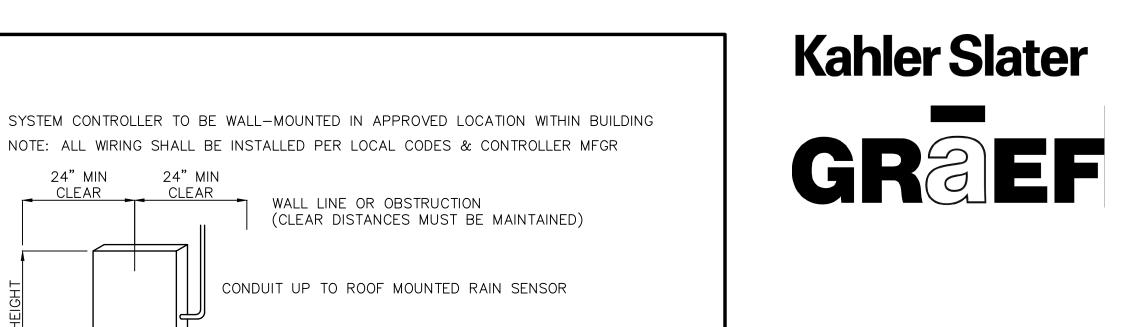

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COMMERCIAL DESIGN REVIEW

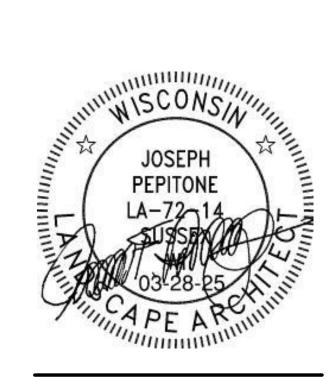SCOPE DOCUMENTS Drawing Date

MCHS LA CROSSE LOADING DOCK

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03/28/2025


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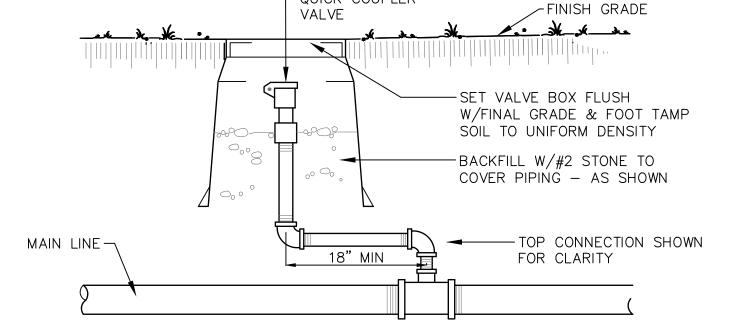
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IRRIGATION DETAILS

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QUICK COUPLER VALVE DETAIL

SPRINKLER SETBACK DETAIL

LOCATE ISOLATION VALVES AS LAID-OUT PER IRRIGATION PLAN

SHUT-OFF VALVE

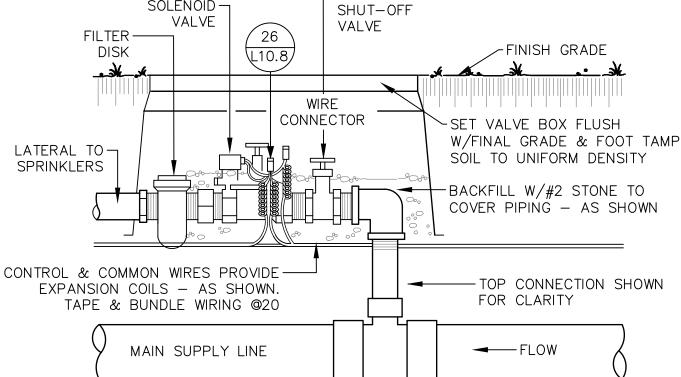VALVE

LOCATE SOLENOID STATION VALVE ASSEMBLY PER IRRIGATION PLAN NOTE: ALL WIRING & PLUMBING SHALL BE INSTALLED IN COMPLIANCE

> WIRE CONNECTOR

ALL CONNECTIONS TO LATERALS OR MAINS SHALL BE MADE TO THE SIDE

\TYPICAL SOLENOID STATION VALVES

-IRRIGATION

ROTOR HEADS

AS SPECIFIED

LOCATE LATERAL

WITHIN 18" OF

YPICAL SPRAY/ROTOR DETAIL

SPRINKLER

LOCATE LATERAL

WITHIN 24"

BEYOND SETBACK

LOCATE SPRINKLER HEADS AS LAID-OUT PER IRRIGATION PLAN

ISOLATION VALVE

W/LOCAL CODES

CONTROL & COMMON WIRES — PROVIDE EXPANSION COILS-

WIRING @20

AS SHOWN. TAPE & BUNDLE

MAIN SUPPLY LINE

SET SPRINKLER HEAD FLUSH W/ FINAL GRADE & FOOT TAMP SOIL TO UNIFORM

DENSITY

SWING PIPE -

CONNECTION TO

LATERAL - P.E.

ESTABLISH THIS PROCEDURE TO ----SETBACK SPRINKLER HEAD FROM CURB/CONCRETE WALK PARCEL

LINE OR FIXED FEATURE

SET TOP OF

SPRINKLER

© EXISTING

GRADE

SOLENOID _ LATERAL -VALVE | SHUT-OFF

MAIN TO -

LATERAL TO-

SPRINKLERS

SPRINKLERS

FINISHED GRADE

24" MIN

24" MIN

CONTROLLER MOUNTING DETAIL

IRRIG. CONTRACTOR SHALL LOCATE BURIED UTILITIES PRIOR TO TRENCHING

CO**V**ER .

MINIMUM TRENCHING STANDARDS

THRUST BLOCKS ARE REQUIRED AT ALL FIELD CONDITIONS AS LAID-OUT ABOVE THRU-OUT THE ENTIRE MAINLINE & ALL PVC PIPING

• PROVIDE PIPE TWICE THE DIAMETER AS SHOWN FOR PLUMBING SYSTEMS PROVIDE ADDITIONAL PIPE OF 3" DIAMETER FOR LOW VOLTAGE WIRING

EXTEND 6" ABOVE TOP/CURB & SOLVENT WELD CAP

MIN 24" COVER

IRRIGATION CONTRACTOR SHALL REMOVE TEMPORARY ELL/RISER/CAP

PRIOR TO CONTINUATION OF PLUMBING & ELECTRICAL SERVICES

REFER TO GRADING & IRRIGATION PLAN FOR ELEVATION OF LINE

AT CROSSING. NOT ALL CROSSINGS ARE WITHIN 24" OF SURFACE.

CROSSING @ PAVED SURFACES

NOTE: ALL SLEEVES SHALL BE OF HI-IMPACT/TYPE 2110/SCHEDULE

IRRIGATION CONTRACTOR : LOCATE BURIED UTILITY SERVICES

THRUST BLOCK STANDARDS

GENERAL CONTRACTOR: INSTALL SLEEVES PRIOR TO PAVING

40/PVC PIPE

LATERAL

MIN 18"

•TAPE BUNDLE @ ALL BENDS

• COLLECT & TAPE @ 20' INTERVALS • SNAKE WIRE HARNESS WITHIN TRENCH

SEE ALSO: TYPICAL THRUST BLOCK/CROSSING DETAILS/PIPE &

CONTROLLER SHALL BE RAINBIRD ESP-4MI

WIRE DETAILS

THRUST BLOCK

@ CHANGE OF

PRIOR TO TRENCHING

DIRECTION

SUPPLY

— FINAL RISER & CONTROLLER BY IRRIGATION CONTRACTOR

(COMMON & CONTROL WIRING TO SOLENOID VALVES)

CONTRACTOR TO EXTEND CONDUIT BEYOND BUILDING WALLS IN SLEEVE AS LAID-OUT PER IRRIGATION PLAN

LOW VOLTAGE

WIRING

--- 120VAC POWER & GROUND TO CONTROLLER CONDUIT CONNECTION & WIRES-BY ELECTRICIAN

TEMPORARY CAP 6" ABOVE FINISHED FLOOR

- BOTTOM OF TRENCH

FINISHED GRADE

SET VALVE BOX FLUSH

TOP CONNECTION

W/FINAL GRADE & FOOT TAMP

-BACKFILL W/#2 STONE TO

COVER PIPING-AS SHOWN

SOIL TO UNIFORM DENSITY

SHOWN FOR CLARITY

FINISHED GRADE

POLYETHYLENE CONNECTION

——LOCATE SPRINKLER HEADS

MIN 12" COVER

@ UNIFORM SETBACK

GRADE VARIES

MIN 12" COVER

SET VALVE BOX FLUSH W/

FINAL GRADE & FOTT TAMP SOIL TO UNIFORM DENSITY

BACKFILL W/#2 STONE TO

COVER PIPING-AS SHOWN

— EXTEND 6" PVC PIPE TO WITHIN 6"
OF FINISHED LAWN GRADE

DELIVERY PARKING

ARCHITECTURAL SITE PLAN
1/8" = 1'-0"

COMMERCIAL DESIGN REVIEW

SCOPE DOCUMENTS

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ARCHITECTURAL SITE PLAN

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Kahler Slater GRAEF

RING & DUCHATEAU CONSULTING ENGINEERS

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MCHS SWWI LA CROSSE HOSPITAL **EXPANSION**

 $\frac{\text{MAYO CLINIC}}{\text{HEALTH SYSTEM}}$

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Sheet Title LOWER LEVEL FLOOR PLAN

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Kahler Slater
GRÄEF

RING & DUCHATEAU CONSULTING ENGINEERS

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Drawing Date 03/28/2025

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Sheet Title

FIRST LEVEL FLOOR PLAN

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AR111

Kahler Slater GRAEF

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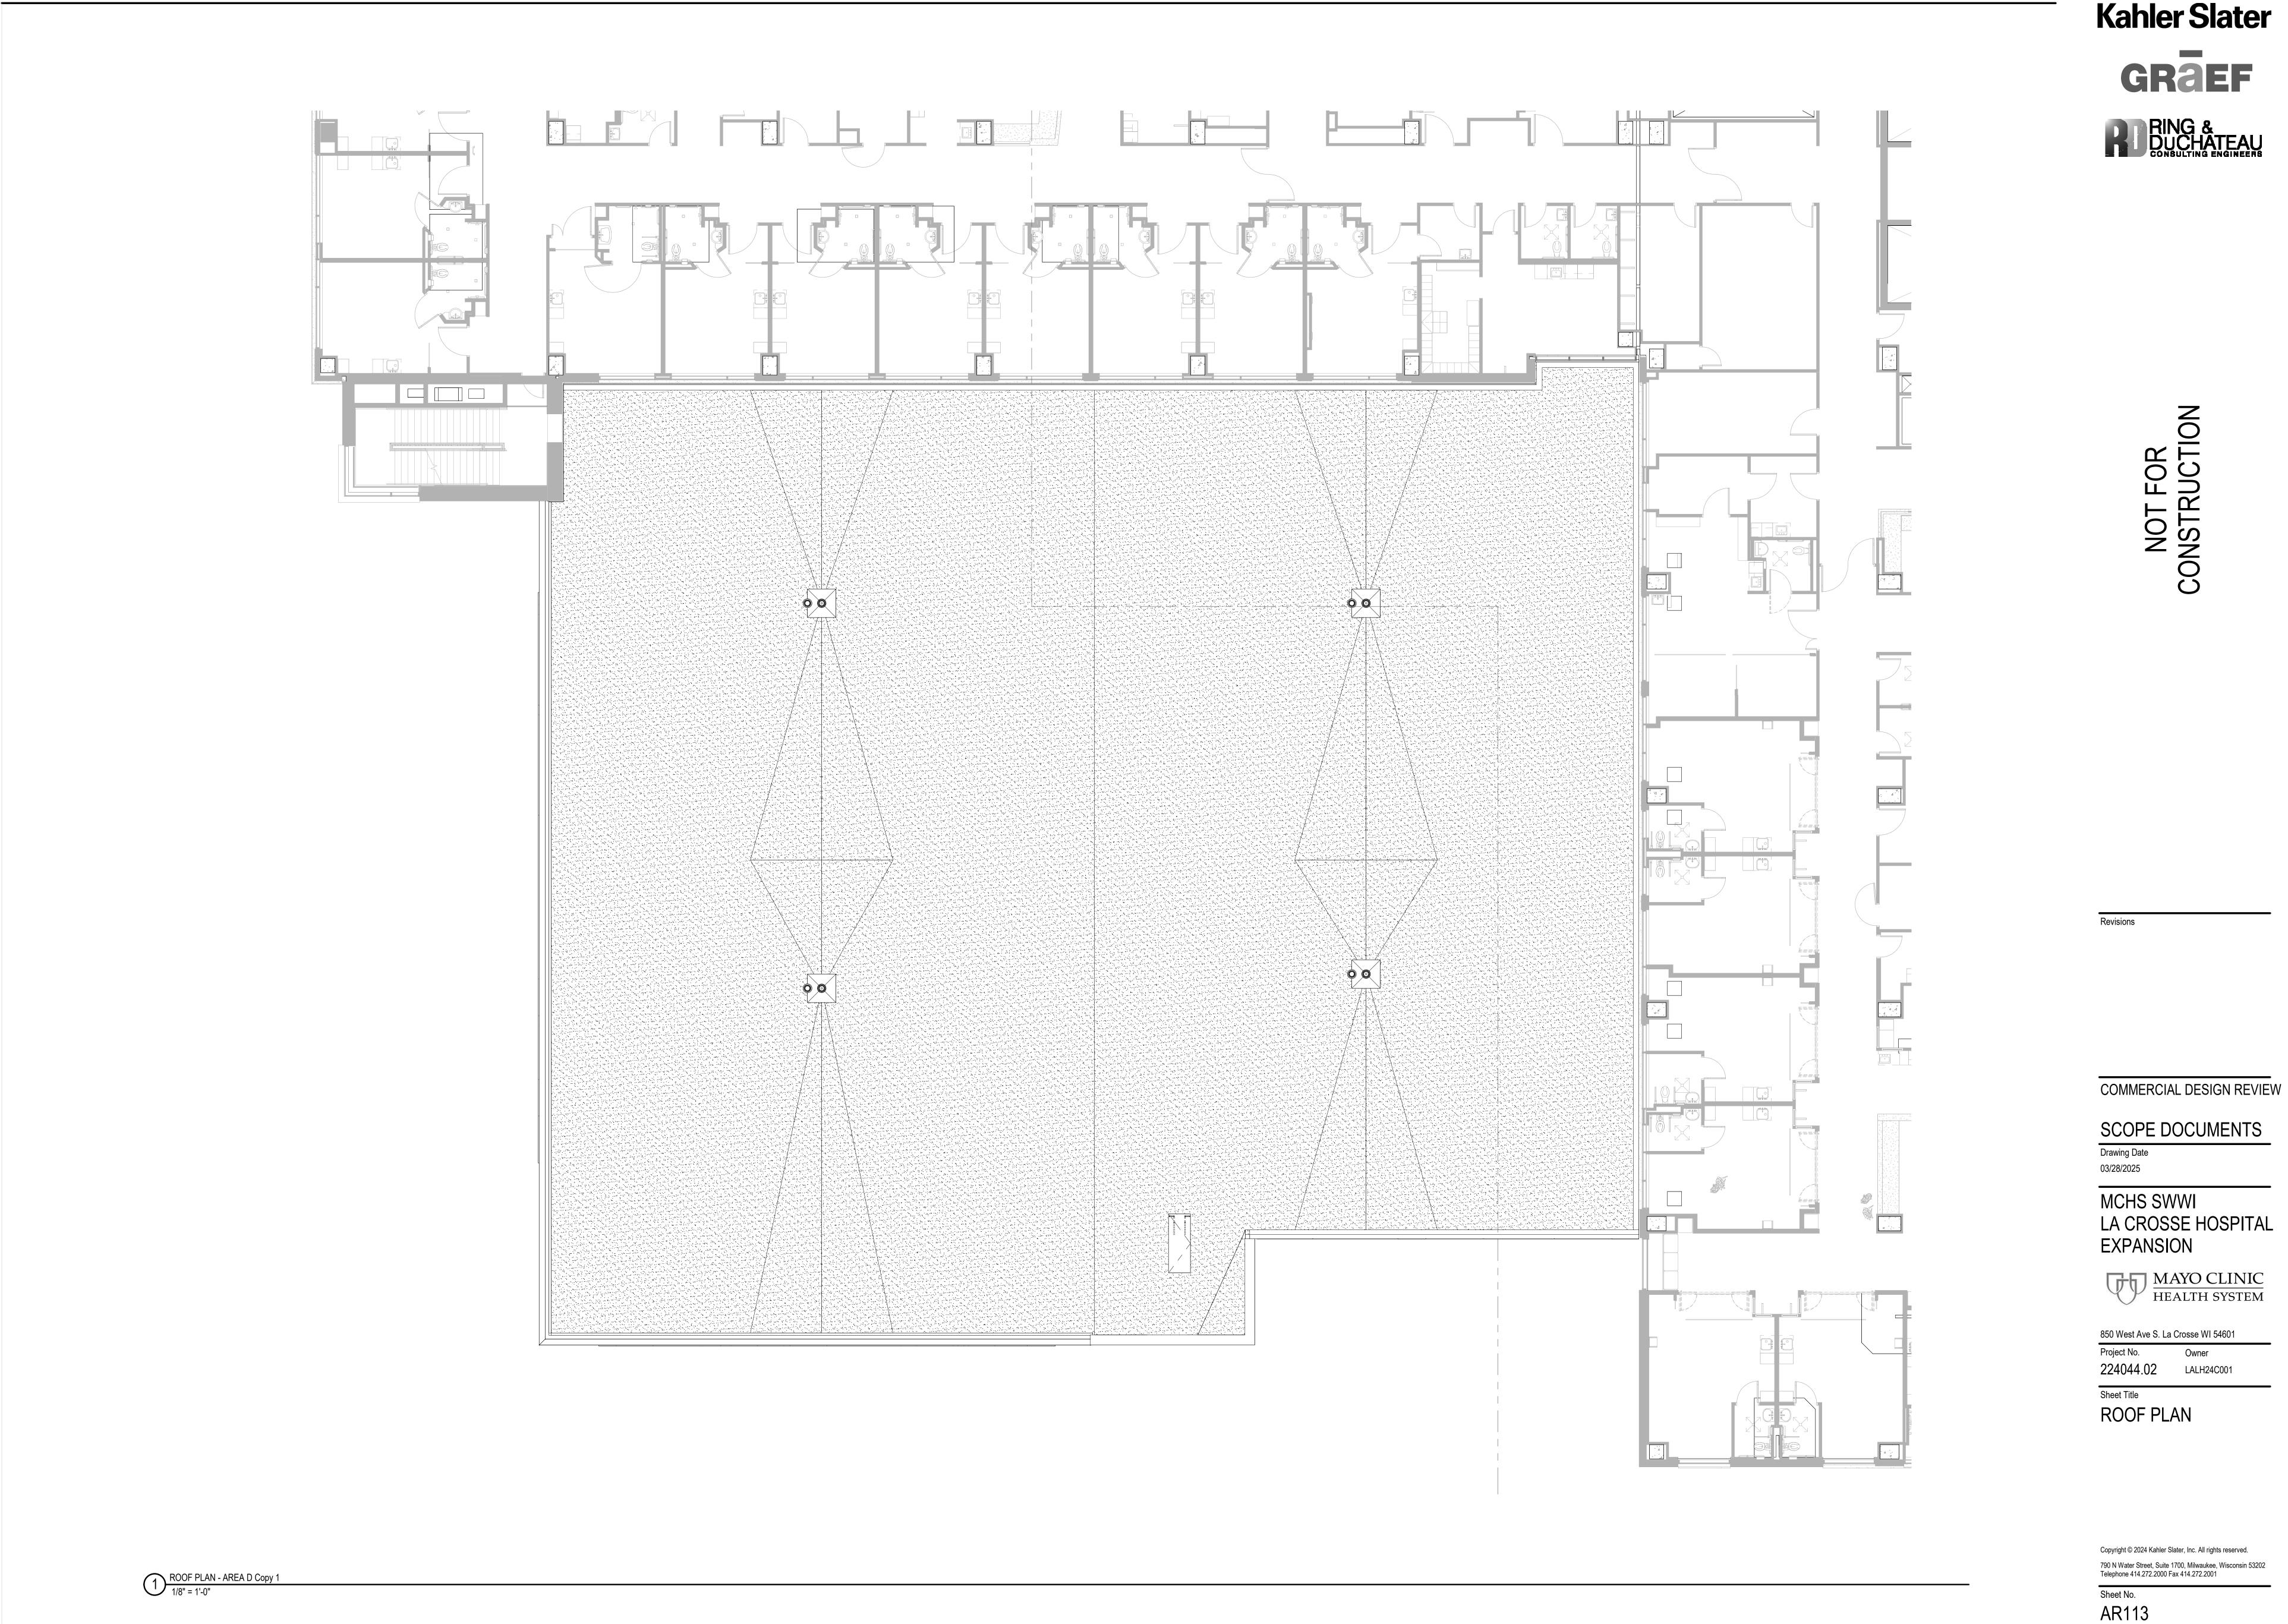
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THIRD LEVEL FLOOR

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EXTERIOR ELEVATION GENERAL NOTES

- ALL METAL SURFACES EXPOSED TO VIEW (INCLUDING MISCELLANEOUS METALS, PIPING, MECHANICAL EQUIPMENT, LADDERS, STAIRS, RAILING, COLUMNS, PLATFORMS, ETC.) SHALL BE PAINTED, U.N.O.
- 2. WINDOWS ARE ALUMINUM STOREFRONT U.N.O.
- 3. CONTROL JOINTS IN CMU BACKUP TO BE OFFSET FROM CONTROL JOINTS IN MASONRY/STONE VENEER. CONTROL JOINTS AT CMU BACKUP MAXIMUM 25' SPACING.
- 4. PROVIDE CONTROL JOINTS AT INSIDE CORNERS OF BRICK AND STONE VENEERS.



COMMERCIAL DESIGN REVIEW

SCOPE DOCUMENTS Drawing Date 03/28/2025

MCHS SWWI LA CROSSE HOSPITAL **EXPANSION**

 $\frac{\text{MAYO CLINIC}}{\text{HEALTH SYSTEM}}$


850 West Ave S. La Crosse WI 54601


224044.02 LALH24C001

Sheet Title **EXTERIOR ELEVATIONS**

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AR200



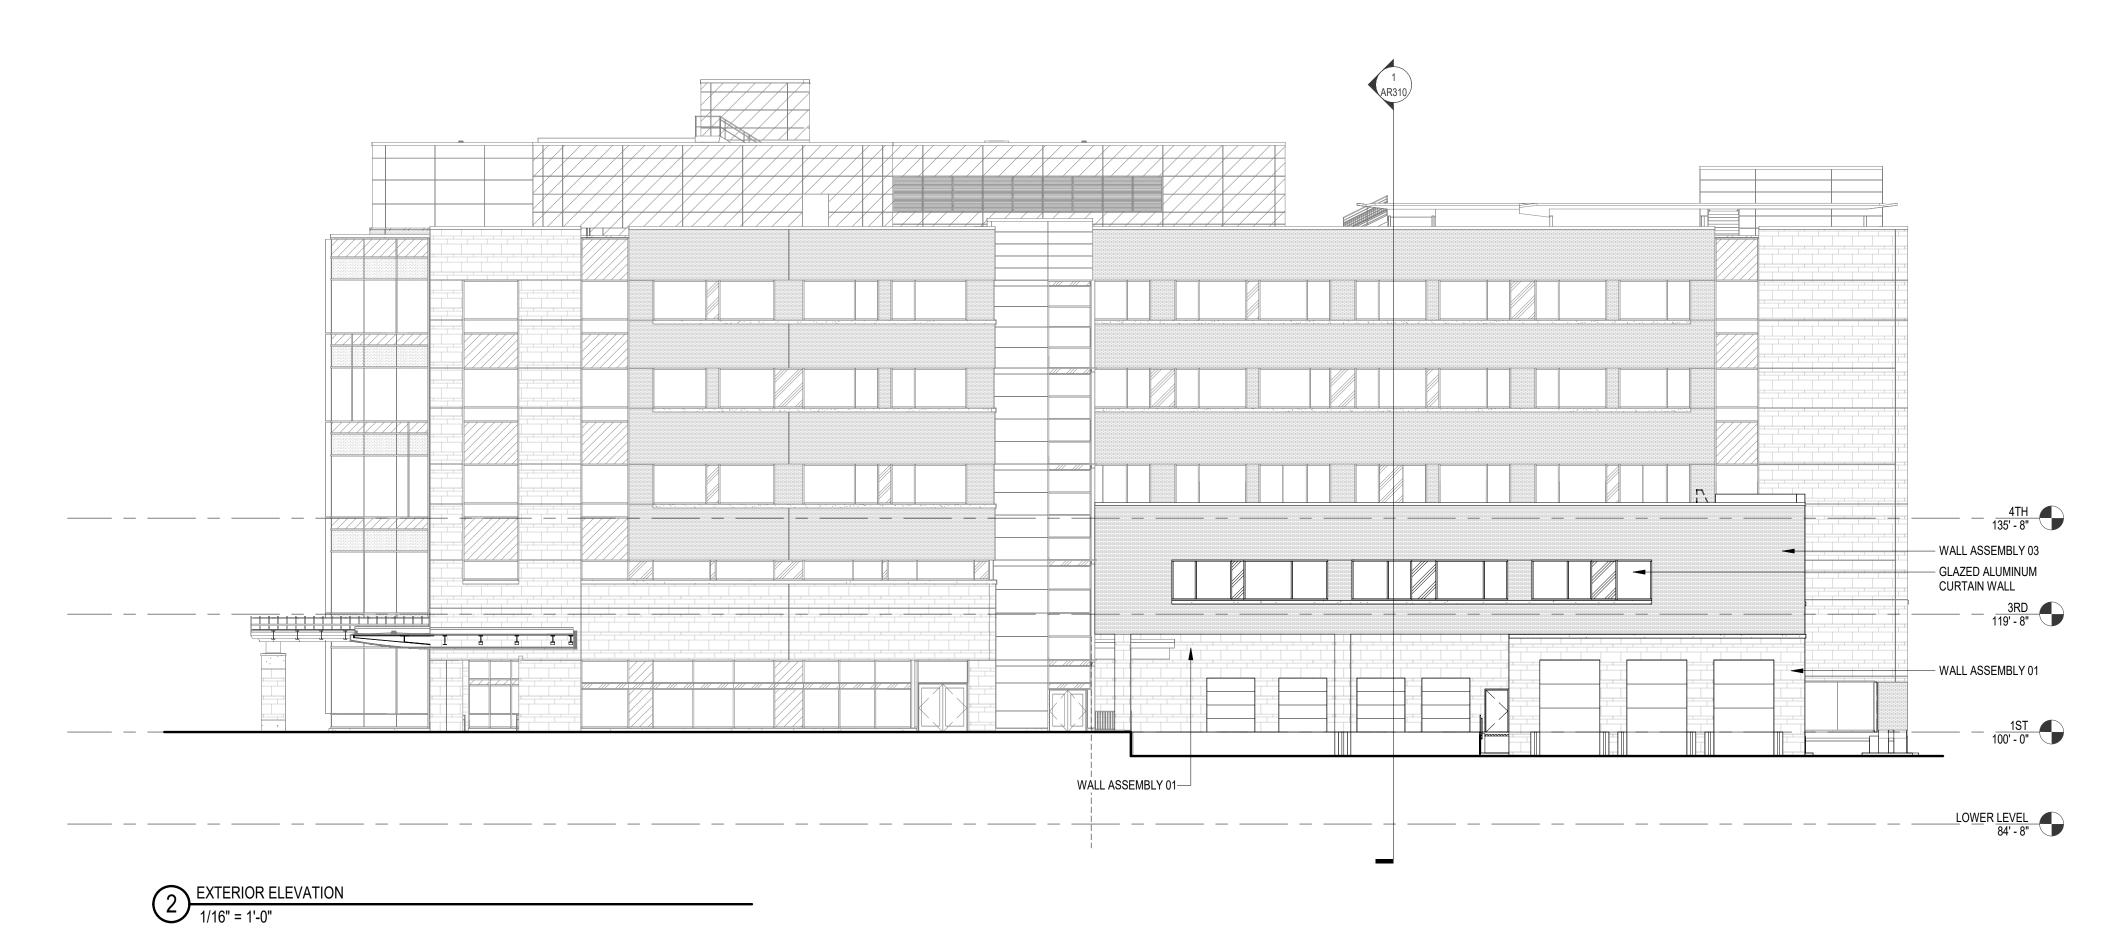

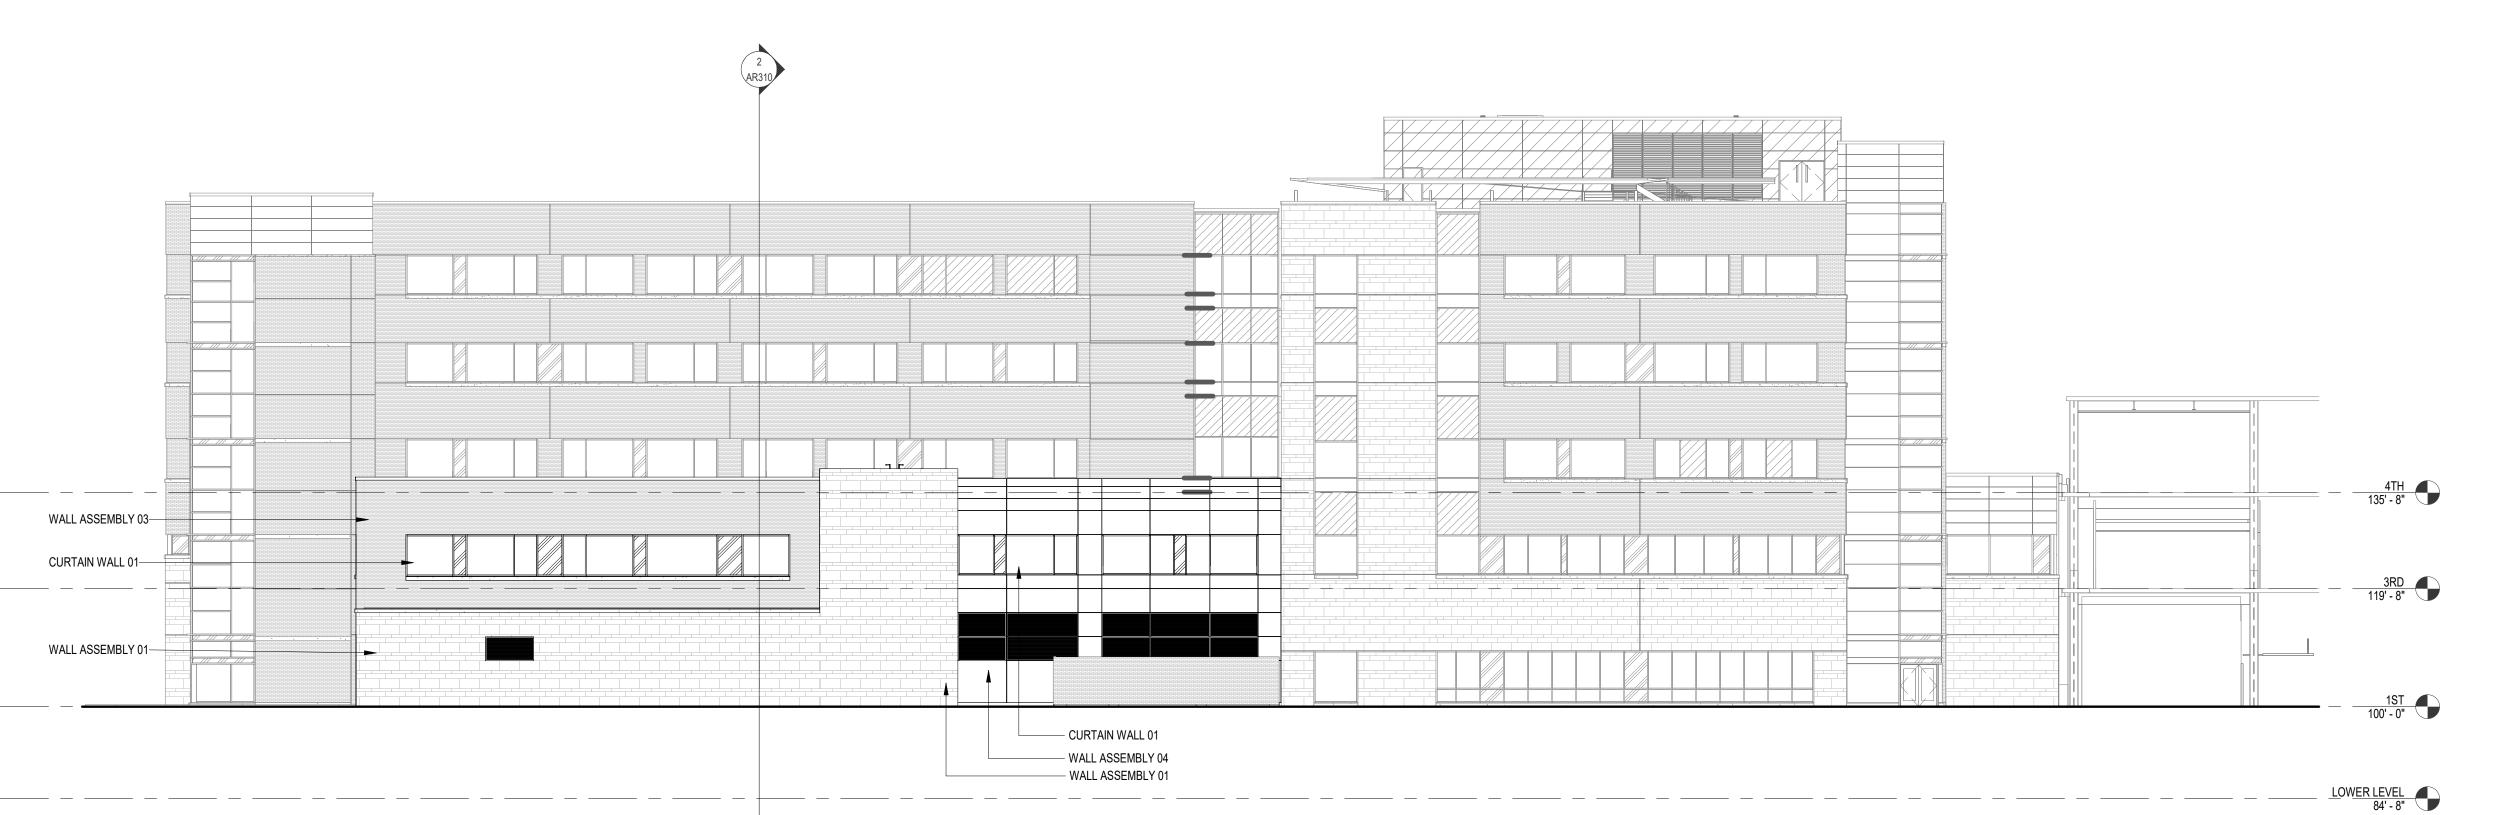EXTERIOR ELEVATION

1/16" = 1'-0"





3RD 119' - 8"

1ST 100' - 0"

TORAGE (BODY HOL 1-616

Drawing Date 03/28/2025 Sheet Title

2 BUILDING SECTION

1/16" = 1'-0"

1) BUILDING SECTION
1/16" = 1'-0"

COMMERCIAL DESIGN REVIEW

SCOPE DOCUMENTS

MCHS SWWI LA CROSSE HOSPITAL **EXPANSION**




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Sheet No. AR310



WDGE4 LED P1 70CRI RFT 40K WDGE4 LED P1 70CRI RFT 40K

CalcType
Illuminance

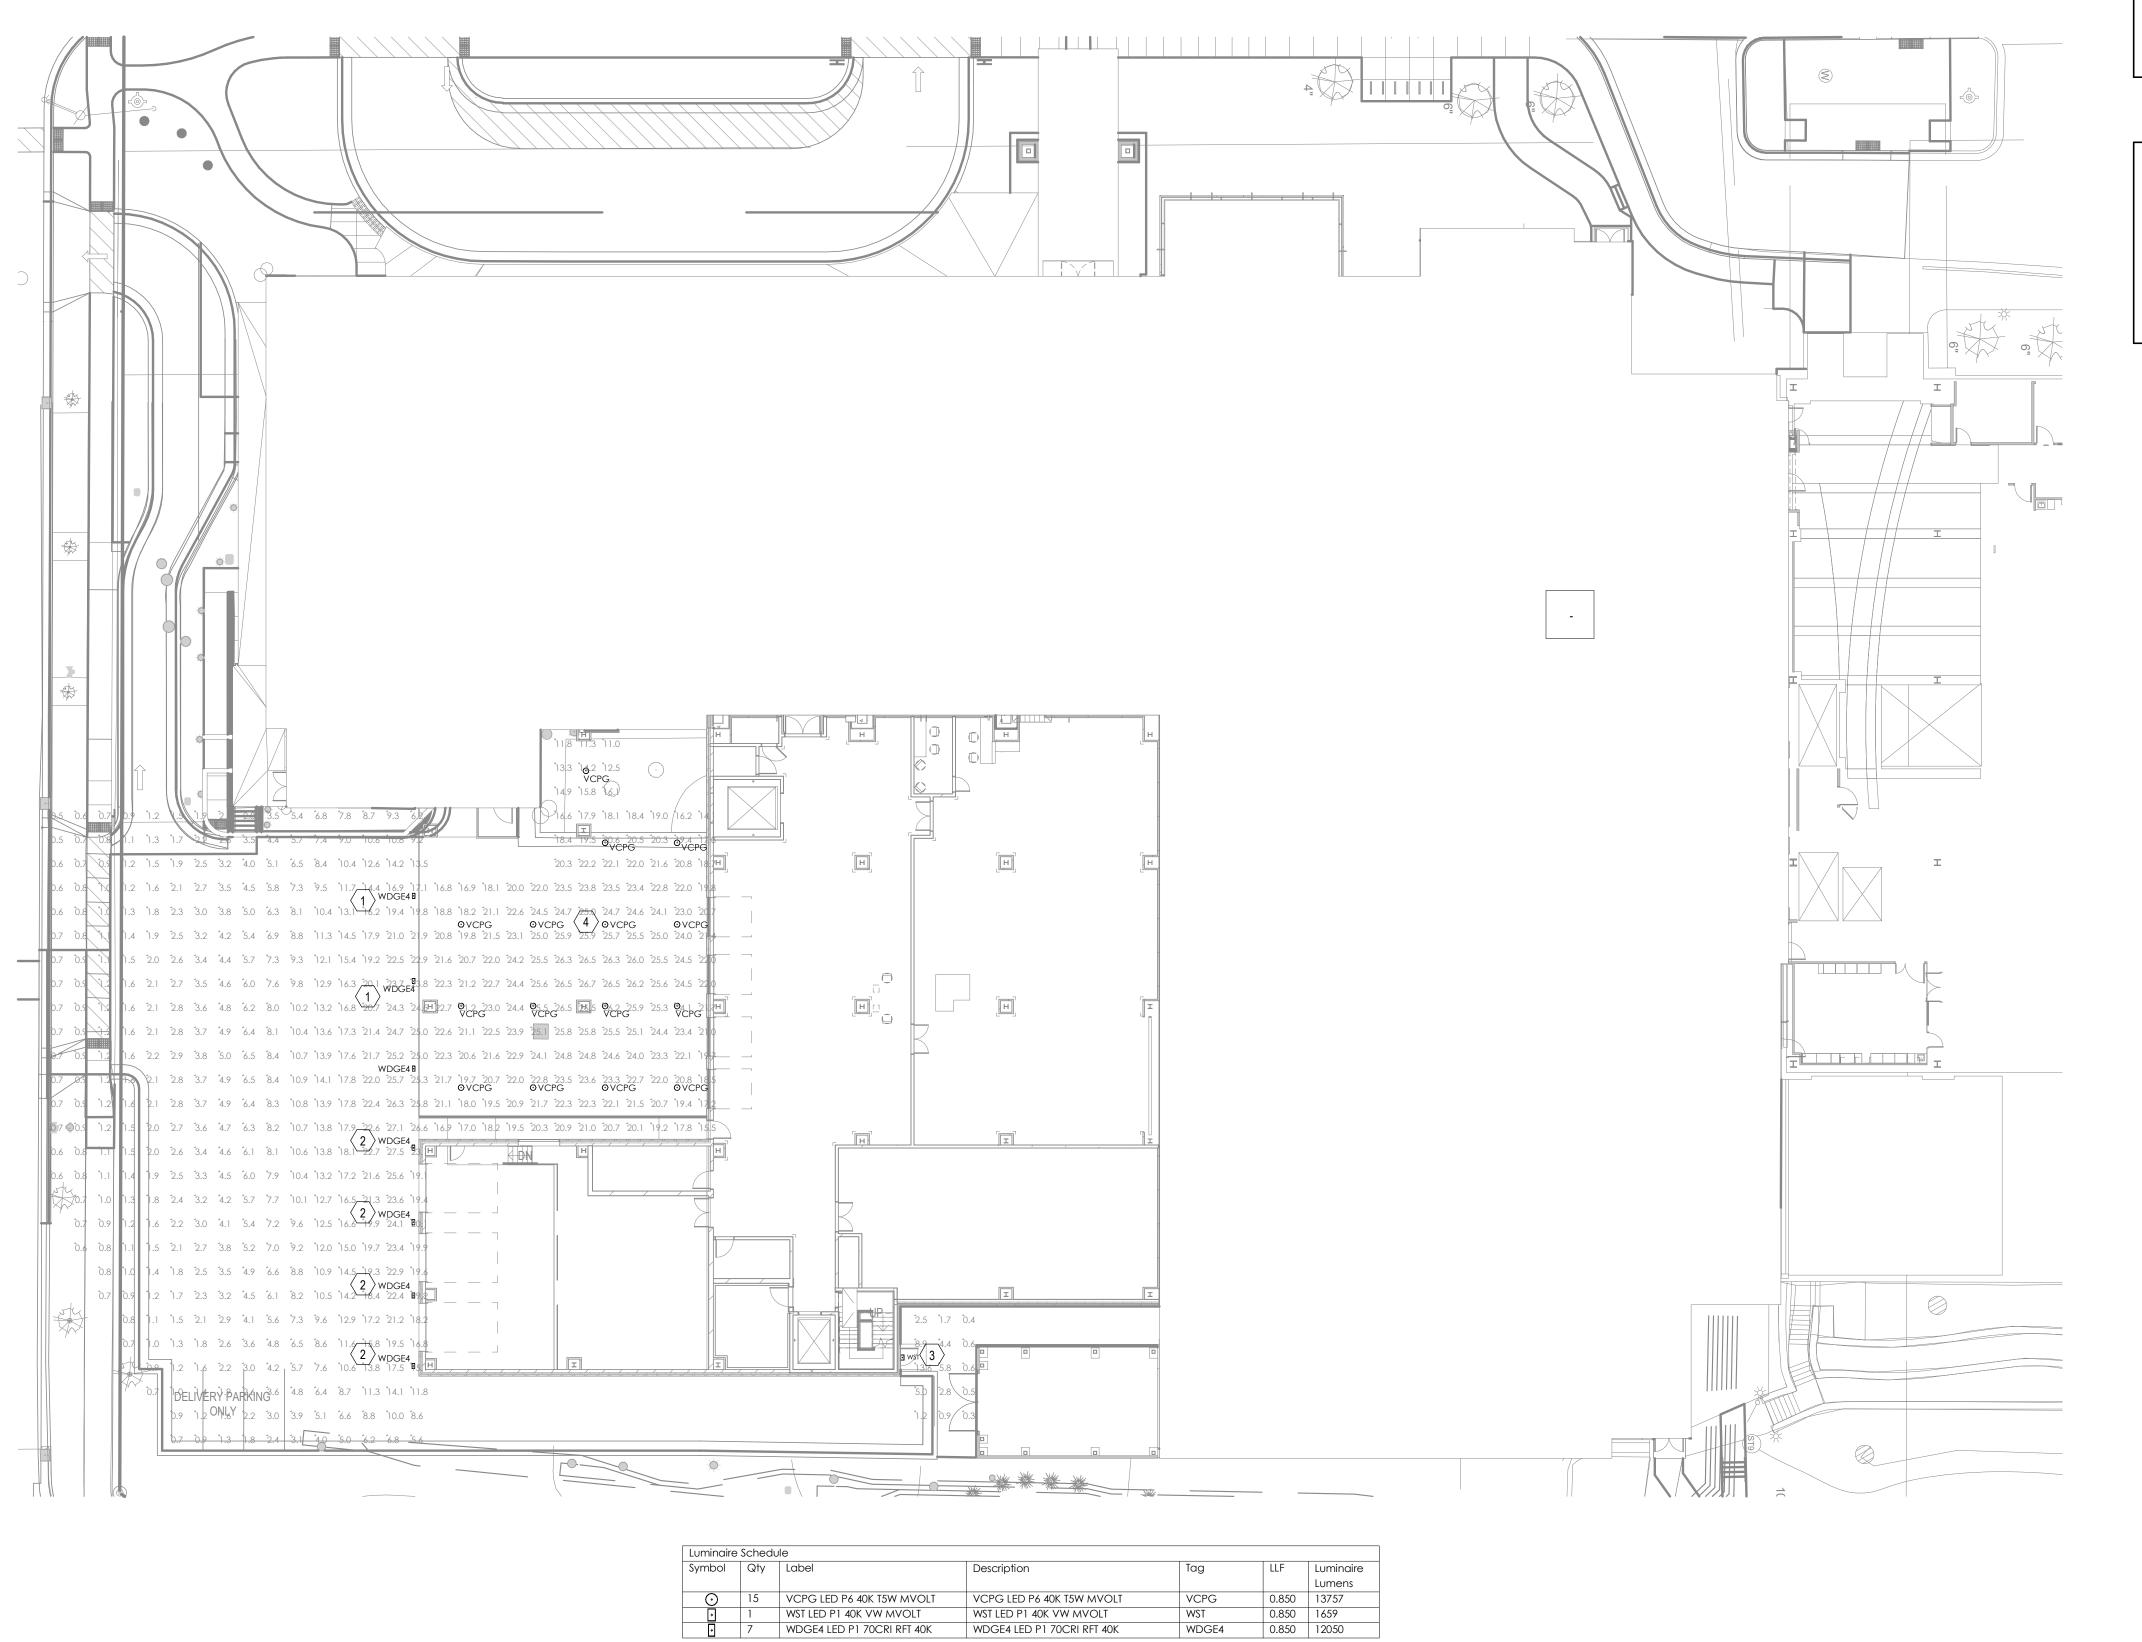 Units
 Avg
 Max
 Min
 Avg/Min
 Max/Min

 Fc
 11.43
 27.5
 0.3
 38.10
 91.67

Calculation Summary
Label
GROUND_GROUND

1 SITE LIGHTING PHOTOMETRICS PLAN
1" = 20'-0"

SHEET NOTES

A. LIGHTING WAS DESIGNED TO IES RECOMMENDED LIGHT LEVELS FOR LOADING DOCK AREAS.

KEYNOTES

- . BOTTOM OF FIXTURE MOUNTED 20'-6" ABOVE FINISHED GROUND.
- . BOTTOM OF FIXTURE MOUNTED 15'-0" ABOVE FINISHED GROUND.
- . BOTTOM OF FIXUTRE MOUTNED 7'-6" ABOVE FINISHED GROUND.
- 4. FIXTURE MOUNTED TO UNDERSIDE OF BUILDING OVERHANG, TYPICAL.

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PHOTOMETRICS PLAN

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COMMERCIAL DESIGN REVIEW

SCOPE DOCUMENTS

Drawing Date 03/28/2025

EXPANSION

850 West Ave S. La Crosse WI 54601

Project No. 224044.02 LALH24C001

SITE LIGHTING

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